

COMMONWEALTH OF PENNSYLVANIA

DEPARTMENT OF GENERAL SERVICES

HARRISBURG, PENNSYLVANIA

TOM WOLF, GOVERNOR

JOSEPH H. LEE, ACTING SECRETARY
DEPARTMENT OF GENERAL SERVICES

PROJECT NO. D.G.S. C-114-0006 PHASE 1

LATRINE IMPROVEMENTS

HICKORY RUN STATE PARK

WHITE HAVEN, CARBON COUNTY, PENNSYLVANIA

PROFESSIONAL / ARCHITECT
SMP ARCHITECTS
1600 WALNUT STREET, 2ND FLOOR
PHILADELPHIA, PA
PHONE (215) 985-4410

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MEP ENGINEERING CONSULTANT
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1407 SCALP AVENUE
JOHNSTOWN, PA

SHEET INDEX PAGE 1 OF 2

GENERAL CONSTRUCTION
CONTRACT NO. DGS C-114-0006.1 PHASE 1

COMMON DRAWINGS

- CS-1 COVER SHEET
- CS-2 COVER SHEET
- G-1 GENERAL NOTES, ABBREVIATIONS, MATERIALS, REFERENCE SYMBOLS
- G-2 LAND TITLE LEASE SITE PLAN
- G-3 BUILDING CODE INFORMATION
- TB-0 TEST BORING LOCATION PLAN AND SCHEDULE - SHEET 1
- TB-1 TEST BORING LOCATION PLAN AND SCHEDULE - SHEET 2
- TB-2 TEST BORING LOCATION PLAN AND SCHEDULE - SHEET 3
- TB-3 TEST BORING LOCATION PLAN AND SCHEDULE - SHEET 4
- TB-4 TEST BORING LOCATION PLAN AND SCHEDULE - SHEET 5
- TB-5 BORING LOGS
- TB-6 TEST PIT LOGS

CIVIL DRAWINGS

- C-0 GENERAL NOTES
- C-1 EXISTING CONDITIONS PLAN- CAMP LOOP C
- C-2 SEQUENCE OF CONSTRUCTION - CAMP LOOP C
- C-3 EROSION AND SEDIMENT CONTROL PLAN- CAMP LOOP C
- C-4 DEMOLITION PLAN- CAMP LOOP C
- C-5 STORMWATER AND GRADING PLAN- CAMP LOOP C
- C-6 SITE PLAN- CAMP LOOP C
- CPE-7 UTILITY PLAN - CAMP LOOP C
- CPE-8 UTILITY PROFILES - CAMP LOOP C
- C-9 EXISTING CONDITIONS PLAN- OGTC
- C-10 SEQUENCE OF CONSTRUCTION - OGTC
- C-11 EROSION AND SEDIMENT CONTROL PLAN- OGTC
- C-12 DEMOLITION PLAN- OGTC
- C-13 STORMWATER AND GRADING PLAN- OGTC
- C-14 SITE PLAN - OGTC
- CPE-15 UTILITY PLAN- OGTC
- CPE-16 UTILITY PROFILES - CAMP OGTC
- C-17 EXISTING CONDITIONS PLAN- CAMP DADDY ALLEN
- C-18 SEQUENCE OF CONSTRUCTION - CAMP DADDY ALLEN
- C-19 EROSION AND SEDIMENT CONTROL PLAN- CAMP DADDY ALLEN
- C-20 DEMOLITION PLAN- CAMP DADDY ALLEN
- C-21 STORMWATER AND GRADING PLAN- CAMP DADDY ALLEN
- C-22 SITE PLAN - CAMP DADDY ALLEN
- CPE-23 UTILITY PLAN- CAMP DADDY ALLEN

- CPE-24 UTILITY PROFILES - CAMP DADDY ALLEN
- C-25 EXISTING CONDITIONS PLAN- CAMP SHEHAQUA
- C-26 SEQUENCE OF CONSTRUCTION - CAMP SHEHAQUA
- C-27 EROSION AND SEDIMENT CONTROL PLAN- CAMP SHEHAQUA
- C-28 DEMOLITION PLAN- CAMP SHEHAQUA
- C-29 STORMWATER AND GRADING PLAN- CAMP SHEHAQUA
- C-30 SITE PLAN - CAMP SHEHAQUA
- CPE-31 UTILITY PLAN - CAMP SHEHAQUA
- CPE-32 UTILITY PROFILES - CAMP SHEHAQUA
- C-33 EROSION AND SEDIMENT CONTROL NOTES
- C-34 EROSION AND SEDIMENT CONTROL DETAILS- SHEET 1
- C-35 EROSION AND SEDIMENT CONTROL DETAILS- SHEET 2
- C-36 SITE DETAILS
- C-37 STORMWATER DETAILS - SHEET 1
- C-38 STORMWATER DETAILS - SHEET 2
- CPE-39 UTILITY DETAILS - SHEET 1
- CPE-40 UTILITY DETAILS - SHEET 2
- C-41 STORMWATER PROFILES

ARCHITECTURAL DRAWINGS

- A-1 LOOP C- PLANS
- A-2 LOOP C- EXTERIOR ELEVATIONS
- A-3 LOOP C- BUILDING SECTIONS
- A-4 LOOP C- INTERIOR ELEVATIONS
- A-5 LOOP C- REFLECTED CEILING PLAN
- A-6 LOOP C- WALL SECTIONS
- A-7 LOOP C- DETAILS
- A-8 LOOP C- SCHEDULES AND TYPES
- A-9 ORGANIZED GROUP TENT CAMPING- PLANS
- A-10 ORGANIZED GROUP TENT CAMPING- EXTERIOR ELEVATIONS
- A-11 ORGANIZED GROUP TENT CAMPING- BUILDING SECTIONS
- A-12 ORGANIZED GROUP TENT CAMPING- INTERIOR ELEVATIONS
- A-13 ORGANIZED GROUP TENT CAMPING- REFLECTED CEILING PLAN
- A-14 ORGANIZED GROUP TENT CAMPING- SECTIONS AND DETAILS
- A-15 ORGANIZED GROUP TENT CAMPING- SCHEDULES AND TYPES
- A-16 ORGANIZED GROUP CAMPING- TYPICAL PLANS
- A-17 ORGANIZED GROUP CAMPING- TYPICAL EXTERIOR ELEVATIONS
- A-18 ORGANIZED GROUP CAMPING- TYPICAL BUILDING SECTIONS
- A-19 ORGANIZED GROUP CAMPING- TYPICAL INTERIOR ELEVATIONS
- A-20 ORGANIZED GROUP CAMPING- REFLECTED CEILING PLAN
- A-21 ORGANIZED GROUP CAMPING- WALL SECTIONS
- A-22 ORGANIZED GROUP CAMPING- SCHEDULES AND TYPES
- A-23 TYPICAL WALL SECTIONS

- A-24 TYPICAL DOOR, WINDOW, AND MISC DETAILS
- A-25 TYPICAL EXTERIOR DETAILS
- A-26 TYPICAL INTERIOR DETAILS
- A-27 SIGNAGE

STRUCTURAL DRAWINGS


- S-1 PRIMARY CODES, SYMBOLS, AND ABBREVIATIONS
- S-2 GENERAL NOTES
- S-3 LOOP C FOOTING PLAN
- S-4 LOOP C FOUNDATION WALL PLAN
- S-5 LOOP C SLAB AND WALL PLAN
- S-6 LOOP C ROOF PLAN
- S-7 LOOP C SECTIONS - SHEET 1
- S-8 LOOP C SECTIONS - SHEET 2
- S-9 LOOP C SECTIONS - SHEET 3
- S-10 LOOP C DETAILS - SHEET 1
- S-11 LOOP C DETAILS - SHEET 2
- S-12 TENT CAMP FOOTING PLAN
- S-13 TENT CAMP FOUNDATION WALL PLAN
- S-14 TENT CAMP SLAB AND WALL PLAN
- S-15 TENT CAMP ROOF PLAN
- S-16 TENT CAMP SECTIONS - SHEET 1
- S-17 TENT CAMP SECTIONS - SHEET 2
- S-18 TENT CAMP SECTIONS - SHEET 3
- S-19 TENT CAMP DETAILS - SHEET 1
- S-20 TENT CAMP DETAILS - SHEET 2
- S-21 GROUP CAMP FOOTING PLAN
- S-22 GROUP CAMP FOUNDATION WALL PLAN
- S-23 GROUP CAMP SLAB AND WALL PLAN
- S-24 GROUP CAMP ROOF PLAN
- S-25 GROUP CAMP SECTIONS - SHEET 1
- S-26 GROUP CAMP SECTIONS - SHEET 2
- S-27 GROUP CAMP SECTIONS - SHEET 3
- S-28 GROUP CAMP DETAILS - SHEET 1
- S-29 GROUP CAMP DETAILS - SHEET 2
- S-30 FOUNDATION DETAILS - SHEET 1
- S-31 FOUNDATION DETAILS - SHEET 2
- S-32 FOUNDATION DETAILS - SHEET 3
- S-33 COUNTER SUPPORTS
- S-34 SINK SUPPORTS
- S-35 COMMON DETAILS - SHEET 1
- S-36 COMMON DETAILS - SHEET 2

CODE APPROVALS


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KIDDER TOWNSHIP LAND DEVELOPMENT - 10/17/2022
NPDES - 8/16/2022
CARBON COUNTY E & S CONTROL - 8/16/2022
CARBON COUNTY PCSM - 8/16/2022
PNDI - 11/10/2022
DEP - 5/24/2022
PHMC ARCHEOLOGICAL APPROVAL - 7/6/2020
PHMC HISTORICAL BUILDING APPROVAL - 7/6/2020

NOTES

PROJECT LOCATION MAP

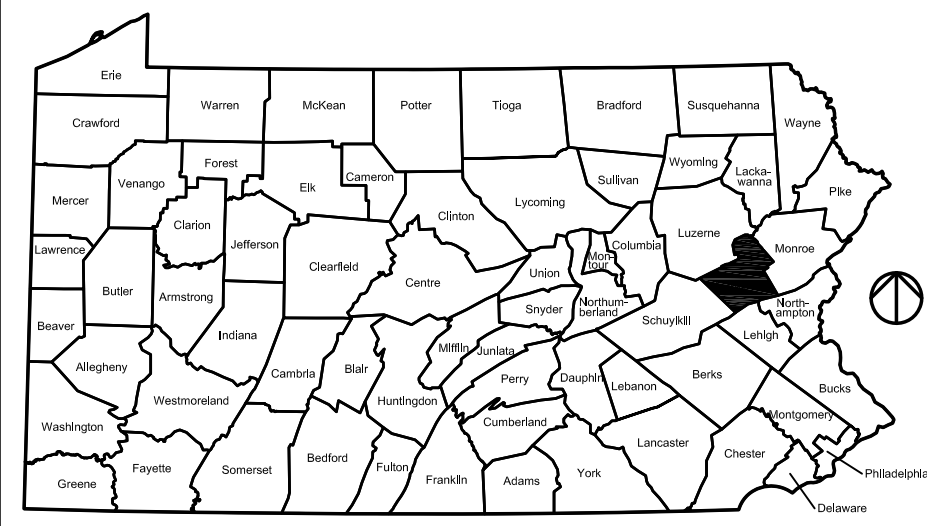

VICINITY MAP

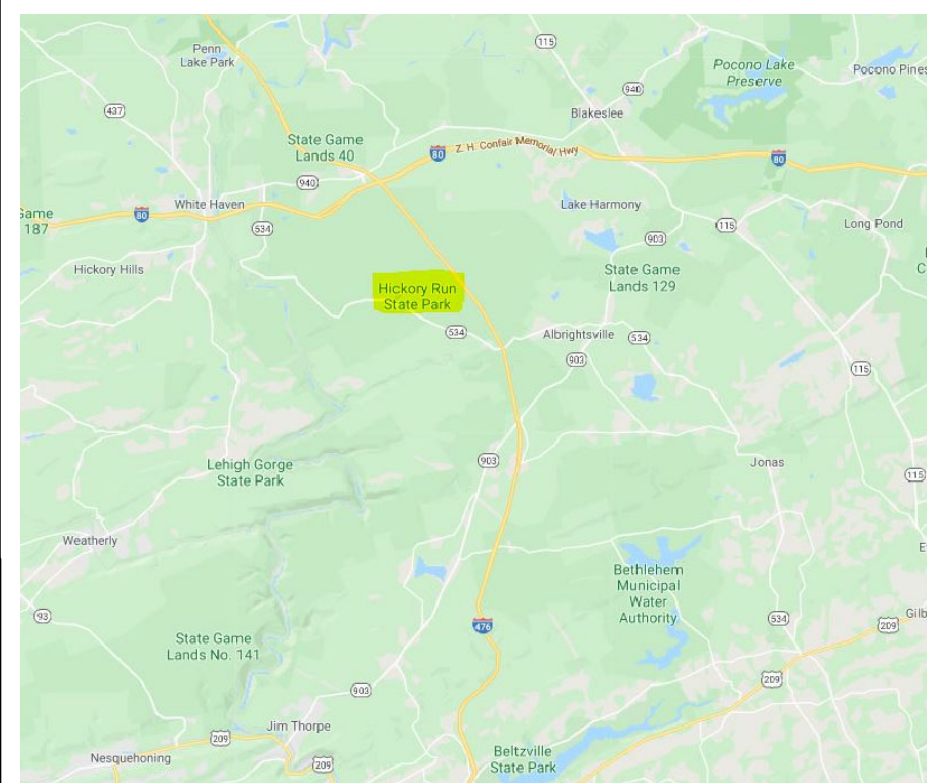

PROFESSIONAL'S SIGNATURE

SMP ARCHITECTS
1600 WALNUT STREET, SECOND FLOOR
PHILADELPHIA, PENNSYLVANIA

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HICKORY RUN STATE PARK
LATRINE IMPROVEMENTS
DEPT of CONSERVATION AND NATURAL RESOURCES
WHITE HAVEN, CARBON COUNTY, PA

COVER SHEET

DRAWN BY M STRENSKI	DATE 06/17/2022	SHEET No. CS-1
CHECKED BY T WOODWARD	SCALE AS NOTED	

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PLOTTER: 2022.11.15 05:56 PM
PLOTTER DR: Megan M. Strenski

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SHEET INDEX PAGE 2 OF 2

CONTRACT NO. DGS C-114-0006.2 PHASE 1
HVAC DRAWINGS

- M-1 SYMBOLS, ABBREVIATIONS AND GENERAL NOTES
- M-2 LOOP-C FLOOR PLAN- MECHANICAL
- M-3 OGTC FLOOR PLAN - MECHANICAL
- M-4 CAMP DADDY ALLEN FLOOR PLAN- MECHANICAL
- M-5 CAMP SHEHAQUA FLOOR PLAN- MECHANICAL
- M-6 LOOP-C FLOOR PLAN - MECHANICAL PIPING
- M-7 OGTC FLOOR PLAN - MECHANICAL PIPING
- M-8 HOT WATER SCHEMATIC FLOW DIAGRAM
- M-9 MECHANICAL DETAILS
- M-10 MECHANICAL DETAILS
- M-11 MECHANICAL SCHEDULES

CONTRACT NO. DGS C-114-0006.3 PHASE 1
PLUMBING DRAWINGS

- P-1 SYMBOLS, ABBREVIATIONS AND GENERAL NOTES
- P-2 LOOP-C FLOOR PLAN- PLUMBING
- P-3 OGTC FLOOR PLAN - PLUMBING
- P-4 CAMP DADDY ALLEN FLOOR PLAN- PLUMBING
- P-5 CAMP SHEHAQUA FLOOR PLAN- PLUMBING
- P-6 DETAILS- PLUMBING
- P-7 PLUMBING SCHEDULES

CONTRACT NO. DGS C-114-0006.4 PHASE 1
ELECTRICAL DRAWINGS


- E-1 SYMBOLS, ABBREVIATIONS AND GENERAL NOTES
- E-2 LOOP-C FLOOR PLAN - ELECTRICAL
- E-3 OGTC FLOOR PLAN - ELECTRICAL
- E-4 CAMP DADDY ALLEN FLOOR PLAN- ELECTRICAL
- E-5 CAMP SHEHAQUA FLOOR PLAN- ELECTRICAL
- E-6 DIAGRAMS ELECTRICAL
- E-7 ELECTRICAL SCHEDULES
- E-8 ELECTRICAL SCHEDULES
- E-9 ELECTRICAL SCHEDULES

CODE APPROVALS


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C-114-0006 PHASE 1

HICKORY RUN STATE PARK
LATRINE IMPROVEMENTS
DEPT of CONSERVATION AND NATURAL RESOURCES
WHITE HAVEN, CARBON COUNTY, PA

COVER SHEET

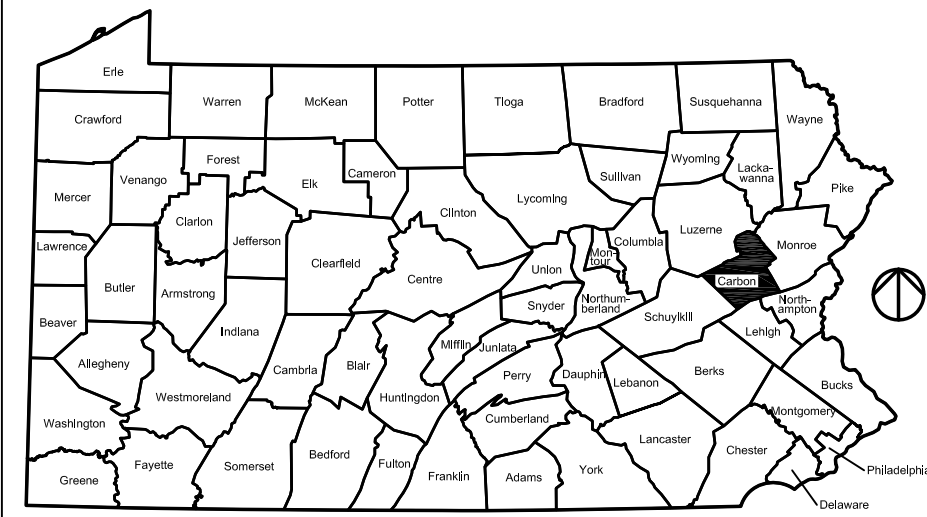DRAWN BY M STRENSKI	DATE 06/17/2022	SHEET No. CS-2
CHECKED BY T WOODWARD	SCALE AS NOTED	

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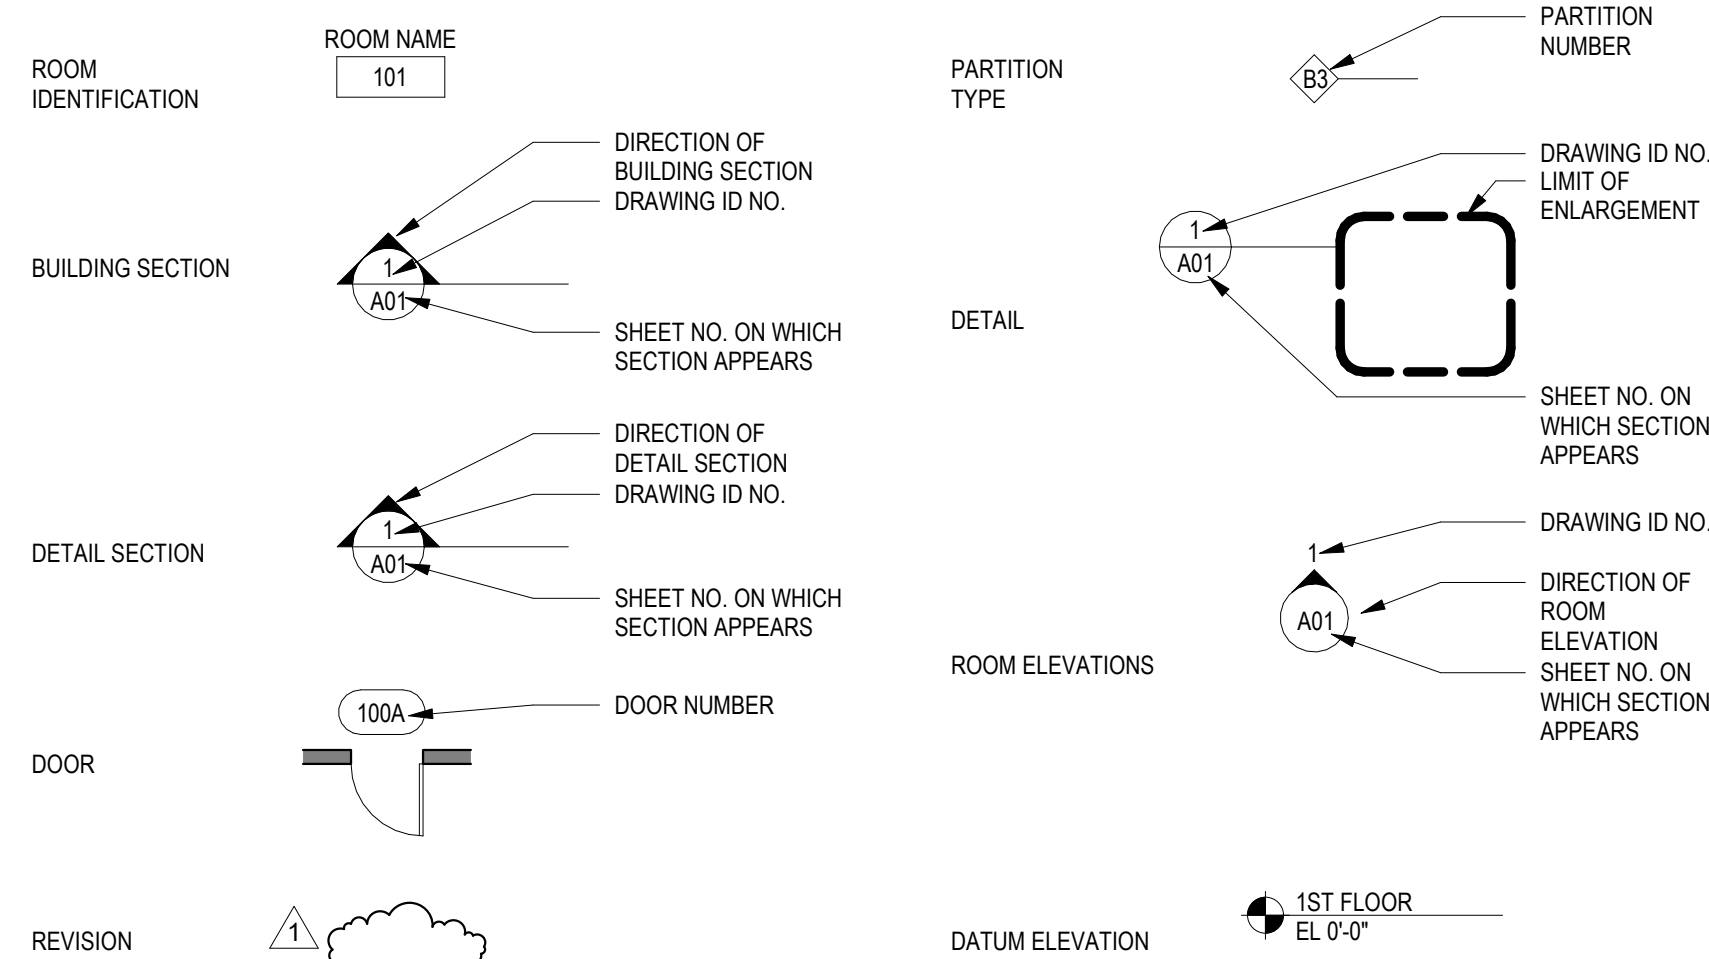
GENERAL NOTES:

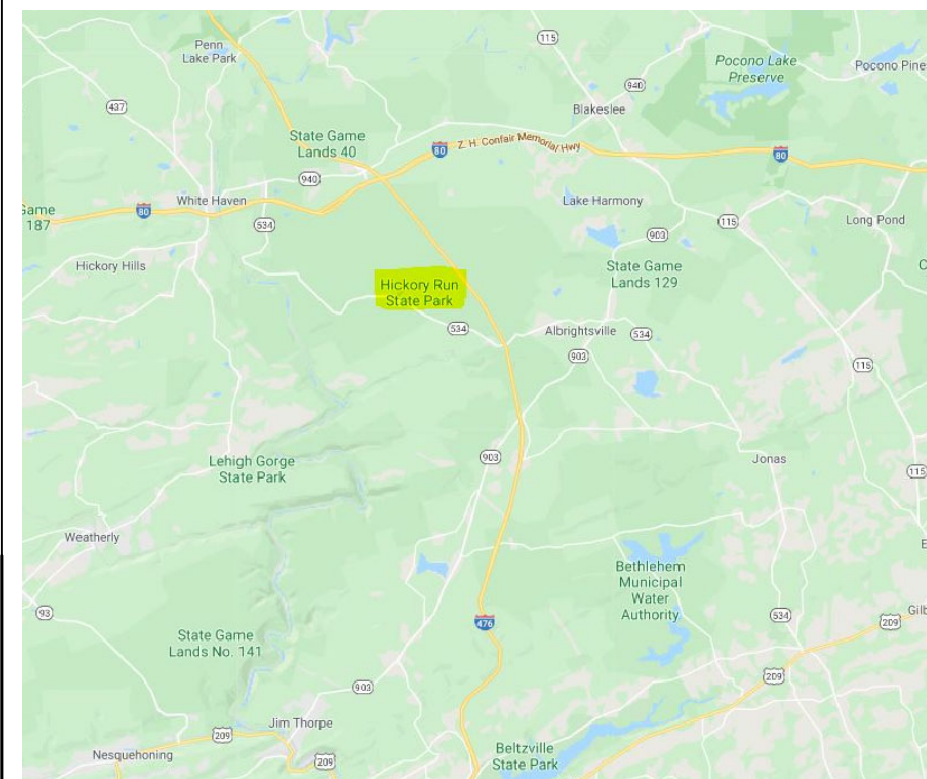- DO NOT SCALE DRAWINGS.
- PRIME CONTRACTORS SHALL OBTAIN ALL REQUIRED PERMITS PRIOR TO THE START OF CONSTRUCTION.
- PRIME CONTRACTORS SHALL COMPLY WITH ALL FEDERAL, STATE AND LOCAL REGULATIONS, CODES AND ORDINANCES.
- PRIME CONTRACTORS SHALL CONFIRM, LOCATE AND COORDINATE WORK WITH HIDDEN MECHANICAL, PLUMBING AND ELECTRICAL CONDITIONS.
- PRIME CONTRACTORS SHALL BE RESPONSIBLE FOR ANY DAMAGE TO THE SITE AND EQUIPMENT DURING CONSTRUCTION, INCLUDING DAMAGE FROM THE ELEMENTS. PRIME CONTRACTORS SHALL REPAIR ANY DAMAGE IMMEDIATELY AND TO THE SATISFACTION OF THE DEPARTMENT.
- PRIME CONTRACTORS SHALL VERIFY EXISTING CONDITIONS AND DIMENSIONS ON THE JOB SITE. IF EXISTING CONDITIONS DO NOT PERMIT INSTALLATION OF WORK IN ACCORDANCE WITH THE DRAWINGS AND SPECIFICATIONS, NOTIFY THE ARCHITECT AND PROVIDE A SKETCH OF THE CONDITION.
- DIMENSIONS ARE TO FINISH FACE OF WALL UNLESS NOTED OTHERWISE.
- THE PRIME CONTRACTORS SHALL COORDINATE LOCATION AND SIZE OF ALL OPENINGS WITH EACH OTHER PRIOR TO INSTALLATION.
- DETAILS SHOWN ARE INTENDED FOR SPECIFIC LOCATIONS AND CONDITIONS. MINOR MODIFICATIONS MAY BE REQUIRED TO SUIT SIMILAR CONDITIONS AND SHALL BE CONSIDERED PART OF THE WORK.
- UNLESS OTHERWISE INDICATED ON THE DRAWINGS OR IN THE SPECIFICATIONS AS BEING NIC, ALL ITEMS, MATERIALS, ETC. AND INSTALLATION OF SAME ARE A PART OF THE CONTRACT WORK.
- THE PRIME CONTRACTORS SHALL COORDINATE ALL SLEEVING WORK, UNO. COORDINATE LOCATION AND SIZE OF ALL OPENINGS, INTERIOR AND/OR EXTERIOR WITH EACH OTHER PRIOR TO INSTALLATION.
- THE TERM PROFESSIONAL REFERS TO THE ARCHITECTURAL OR ENGINEERING FIRM RETAINED BY THE DEPARTMENT TO DESIGN AND DOCUMENT THE WORK OF THE PROJECT, OR THE PROFESSIONAL'S AUTHORIZED REPRESENTATIVE. THE TERM PROFESSIONAL MAY ALSO REFER TO THE CLIENT AGENCY IF THE PROJECT DESIGN WAS DELEGATED TO THE CLIENT AGENCY. THROUGHOUT THE SPECIFICATIONS AND DRAWINGS WHEREVER THE TERMS 'A/E', 'ARCHITECT' OR 'ENGINEER' ARE USED IT SHALL MEAN PROFESSIONAL.


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
A A/E AB ABV ACT ADJ AFF AGG ALCW ALU(UM) ALSF ALW ANOD AP APPROX ARCH	ARCHITECT/ENGINEER ANCHOR BOLT ABOVE ACOUSTIC CEILING TILE ADJACENT/ADJUSTABLE ABOVE FINISH FLOOR AGGREGATE ALUMINUM CURTAINWALL ALUMINUM ALUMINUM STOREFRONT ALUMINUM WINDOW ANODIZED ACCESS PANEL APPROXIMATE ARCHITECTURAL	F FA FCB FCU FD FEC FF FFE FIN FLG FLR FND F.O. FP FT FTG FTR	FIRE ALARM FIBER CEMENT BOARD FAN COIL UNIT FLOOR DRAIN FIRE EXTINGUISHER CABINET FACTORY FINISH FINISHED FLOOR ELEVATION FINISHED FLASHING FLOOR(ING) FOUNDATION FACE OF FILLER PANEL FOOT (FEET) FOOTING FIN TUBE RADIATOR	P PAC PERF PFM PLAS PNL PNLG PNT POL PROJ P.T. PT PTN PWD PV	PRECAST ARCHITECTURAL CONCRETE PERFORATED PLASTIC LAMINATE PLASTER PANEL PANELING PAINT(ED) POLISHED PROJECTION PRESSURE TREATED PORCELAIN TILE PARTITION PLYWOOD PIPE VENT
B B&B BCAB BD BLDG BLKG BLW B.O. BC BM BRK BTW	BOARD AND BATTEN BASE CABINET BOARD BUILDING BLOCKING BELOW BOTTOM OF BROADCAST CARPET BEAM BRICK BETWEEN	G GA GALV GF GLAZ GRG GWB	GAUGE GALVANIZED GROUND FACE GLAZED, GLAZING, GLASS GLASS REINFORCED GYPSUM GYPSUM WALLBOARD	R RA RAD RB RBT RCP RD REF REQD REV RSF RT RM R.O. RTF RWC	RETURN AIR RADIUS RUBBER BASE RUBBER STAIR TREAD REFLECTED CEILING PLAN ROOF DRAIN REFER, REFERENCE REQUIRED REVISION, REVISE(D) RESILIENT FLOORING RESILIENT TILE FLOORING ROOM ROUGH OPENING RESILIENT RUBBER TILE FLOORING RAINWATER CONDUCTOR
C CAB CB CERT CFMF CJ CL CLG CLR CMU COL COMP CONC CONT COORD COR CPT CT CUH CW	CABINET CEMENTBOARD CERTIFIED COLD FORMED METAL FRAMING CONSTRUCTION/CONTROL JOINT CENTERLINE CEILING CLEAR/ CLEARANCE CONCRETE MASONRY UNIT COLUMN COMPOSITE CONCRETE CONTINUOUS COORDINATE CORRUGATED CARPET TILE CERAMIC TILE CABINET UNIT HEATER CURTAINWALL	H HDPE HM HOR HR HRWD HSS HT HVAC HWH	HIGH DENSITY POLYETHYLENE HOLLOW METAL HORIZONTAL HOUR HARDWOOD HOLLOW STEEL SECTION HEIGHT HEATING/VENTILATION/AIR CONDITIONING HOT WATER HEATER	S S SA SBC SBO SFI SGT SIM SIP SL SOG SSTL STD STL STN STRUC SUSP	SOUTH SUPPLY AIR SINK BASE CABINET SUPPLIED BY OTHERS SPRAY FOAM INSULATION STRUCTURAL GLAZED TILE SIMILAR STRUCTURAL INSULATED PANEL SLOPED/SLOPE SLAB ON GRADE STAINLESS STEEL STANDARD STEEL STAINED STRUCTURAL SUSPENDED
D DEMO DIA DIM DN DR DS DTL DWG(S)	DEMOLISH/DEMOLITION DIAMETER DIMENSION DOWN DOOR DOWNSPOUT DETAIL DRAWING(S)	I IGU INCL INFO INSUL INT	INSULATED GLAZING UNIT INCLUDING/INCLUDED INFORMATION INSULATED, INSULATION INTERIOR	T TER TF THK TLT TPTN T.O. TYP T&G	TERRAZZO TRANSPARENT FINISH THICKNESS TOILET TOILET PARTITION TOP OF TYPICAL TONGUE AND GROOVE
E E EA EJ EL ELEC ELEV EMER EP EPX EQ EQPM ES ETR EWC EXP EXG EXT	EAST EACH EXPANSION JOINT ELEVATION ELECTRICAL ELEVATOR EMERGENCY ELECTRICAL PANEL EPOXY EQUAL EQUIPMENT EXPOSED STRUCTURE EXISTING TO REMAIN ELECTRIC WATER COOLER EXPOSED EXISTING EXTERIOR	J JT	JOINT	U UNO	UNLESS NOTED OTHERWISE
L LAM LF LG LIN LLV LTL LT LOUV	LAMINATED LINEAR FEET LONG LINOLEUM LONG LEG VERTICAL LINTEL LIGHT LOUVER	M MAS MAS DIM MATL MAX MDF MECH MFR MIN M.O. MR MTD MTL MULL	MASONRY MASONRY DIMENSION MATERIAL MAXIMUM MEDIUM DENSITY FIBERBOARD MECHANICAL MANUFACTURER MINIMUM MASONRY OPENING MOISTURE RESISTANT MOUNTED METAL MULLION	V VAR VERT VEST VIF VTR	VARIES/VARIOUS VERTICAL VESTIBULE VERIFY IN FIELD VENT THROUGH ROOF
N N NA NAT NIC NOM NTS	NORTH NOT APPLICABLE NATURAL NOT IN CONTRACT NOMINAL NOT TO SCALE	O OC OFE OH OPP OPG OSB OTLN	ON CENTER OWNER FURNISHED EQUIPMENT OPPOSITE HAND OPPOSITE OPENING ORIENTED STRAND BOARD OUTLINE	W W W/O WB WC WCAB WD WDP WF WIN WOM WSCOT	WEST WITH WITHOUT WALL BASE WATER CLOSET WALL CABINET WOOD WOOD PANEL WIDE FLANGE WINDOW WALK OFF MAT WAINSCOT
X XPS	EXTRUDED POLYSTYRENE				

REFERENCE SYMBOLS:





MATERIAL SYMBOLS:

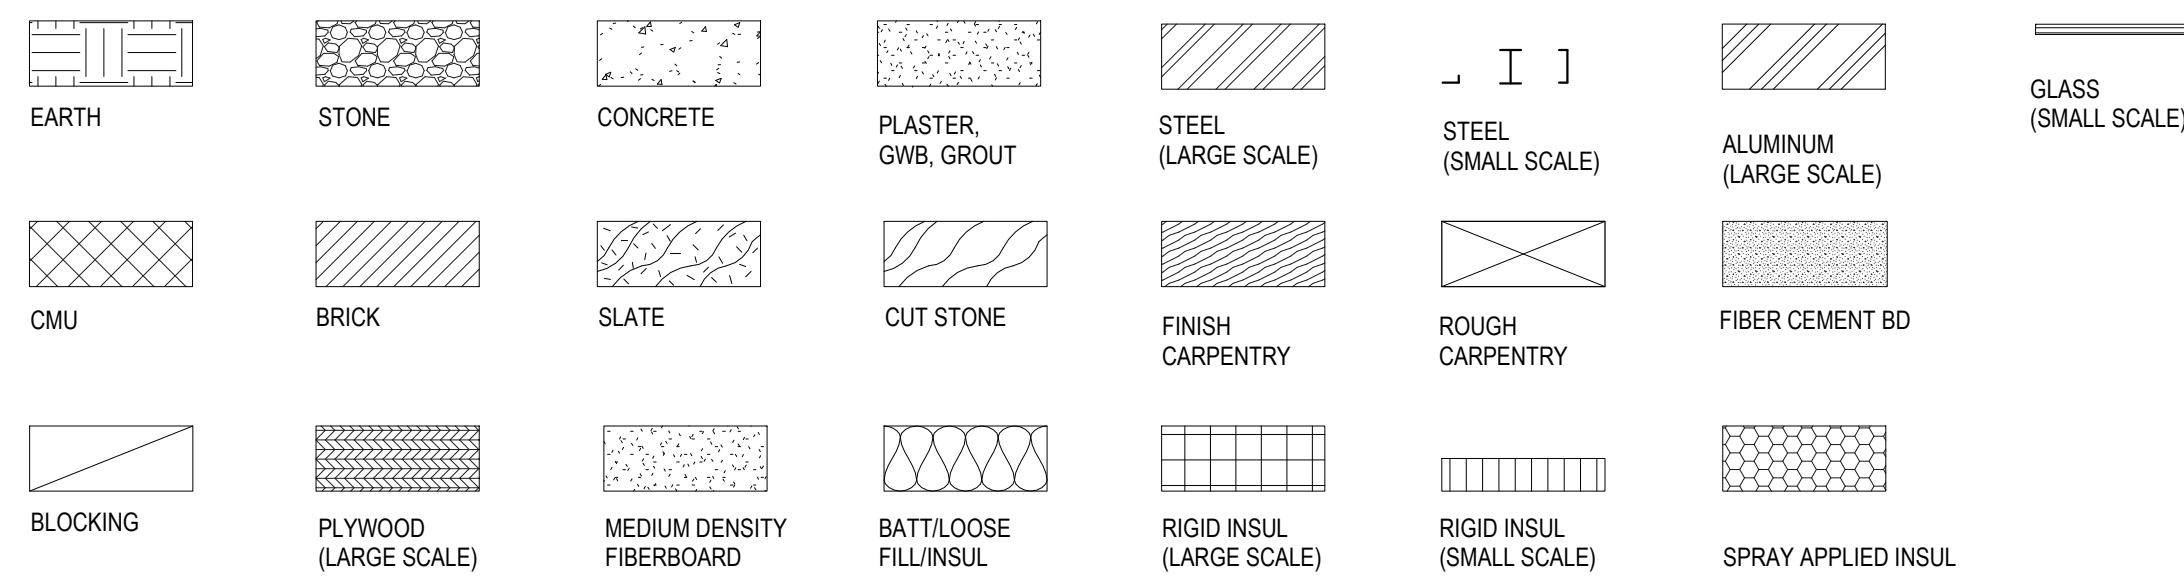

CONSTRUCTION DOCUMENTS		
RECORD REVISIONS		
 <p style="text-align: right; margin-right: 50px;">SIGNATURE _____ DATE 03/05/2021</p>		
SMP ARCHITECTS 1600 WALNUT STREET, SECOND FLOOR PHILADELPHIA, PENNSYLVANIA		
COMMONWEALTH OF PENNSYLVANIA DEPARTMENT OF GENERAL SERVICES HARRISBURG, PENNSYLVANIA		
D.G.S. PROJECT No. C-114-0006 PHASE 1		
HICKORY RUN STATE PARK LATRINE IMPROVEMENTS DEPT. OF CONSERVATION AND NATURAL RESOURCES WHITE HAVEN, CARBON COUNTY, PA		
GENERAL NOTES, ABBREVIATIONS, MATERIALS, REFERENCE SYMBOLS		
VERIFY SCALE BAR IS ONE (1) INCH LONG ON ORIGINAL DRAWING: 0 1 IF BAR IS NOT ONE (1) INCH LONG, ADJUST SCALE ACCORDINGLY	DRAWN BY M STRENSKI 06/17/2022	DATE DRAWING No. G-1
CONTRACTOR SHALL FIELD VERIFY ALL DIMENSIONS. VARIANCE FROM CONTRACT DOCUMENTS NOT PERMITTED WITHOUT PROFESSIONAL & BUREAU OF CONSTRUCTION APPROVAL.	CHECKED BY T WOODWARD SCALE AS NOTED	3 OF 144

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CONSTRUCTION DOCUMENTS	
RECORD REVISIONS	

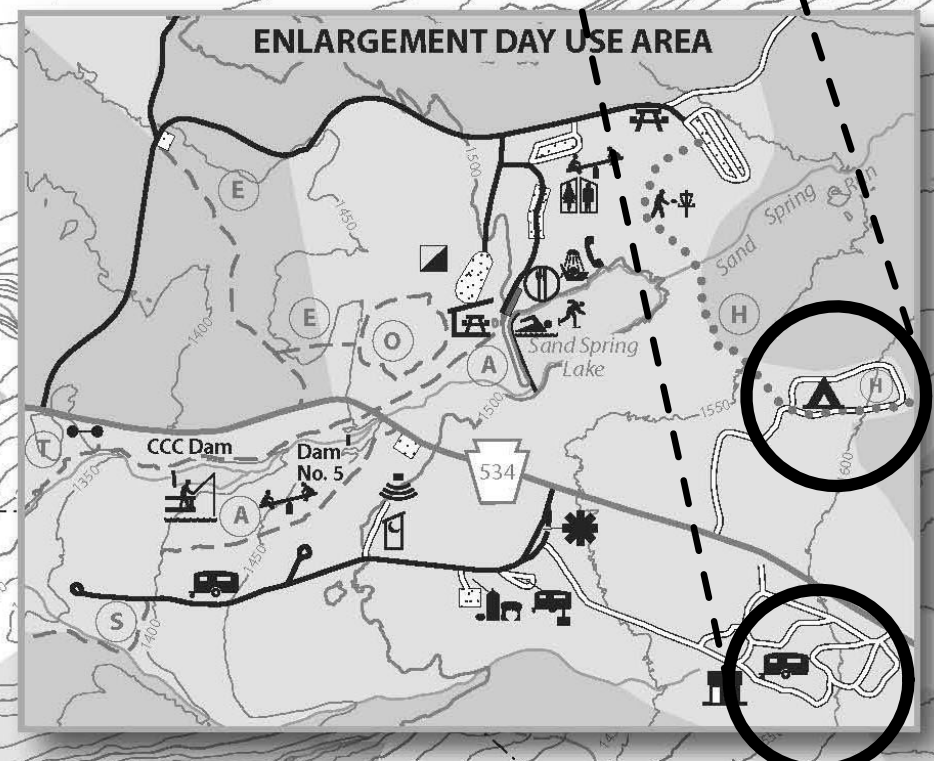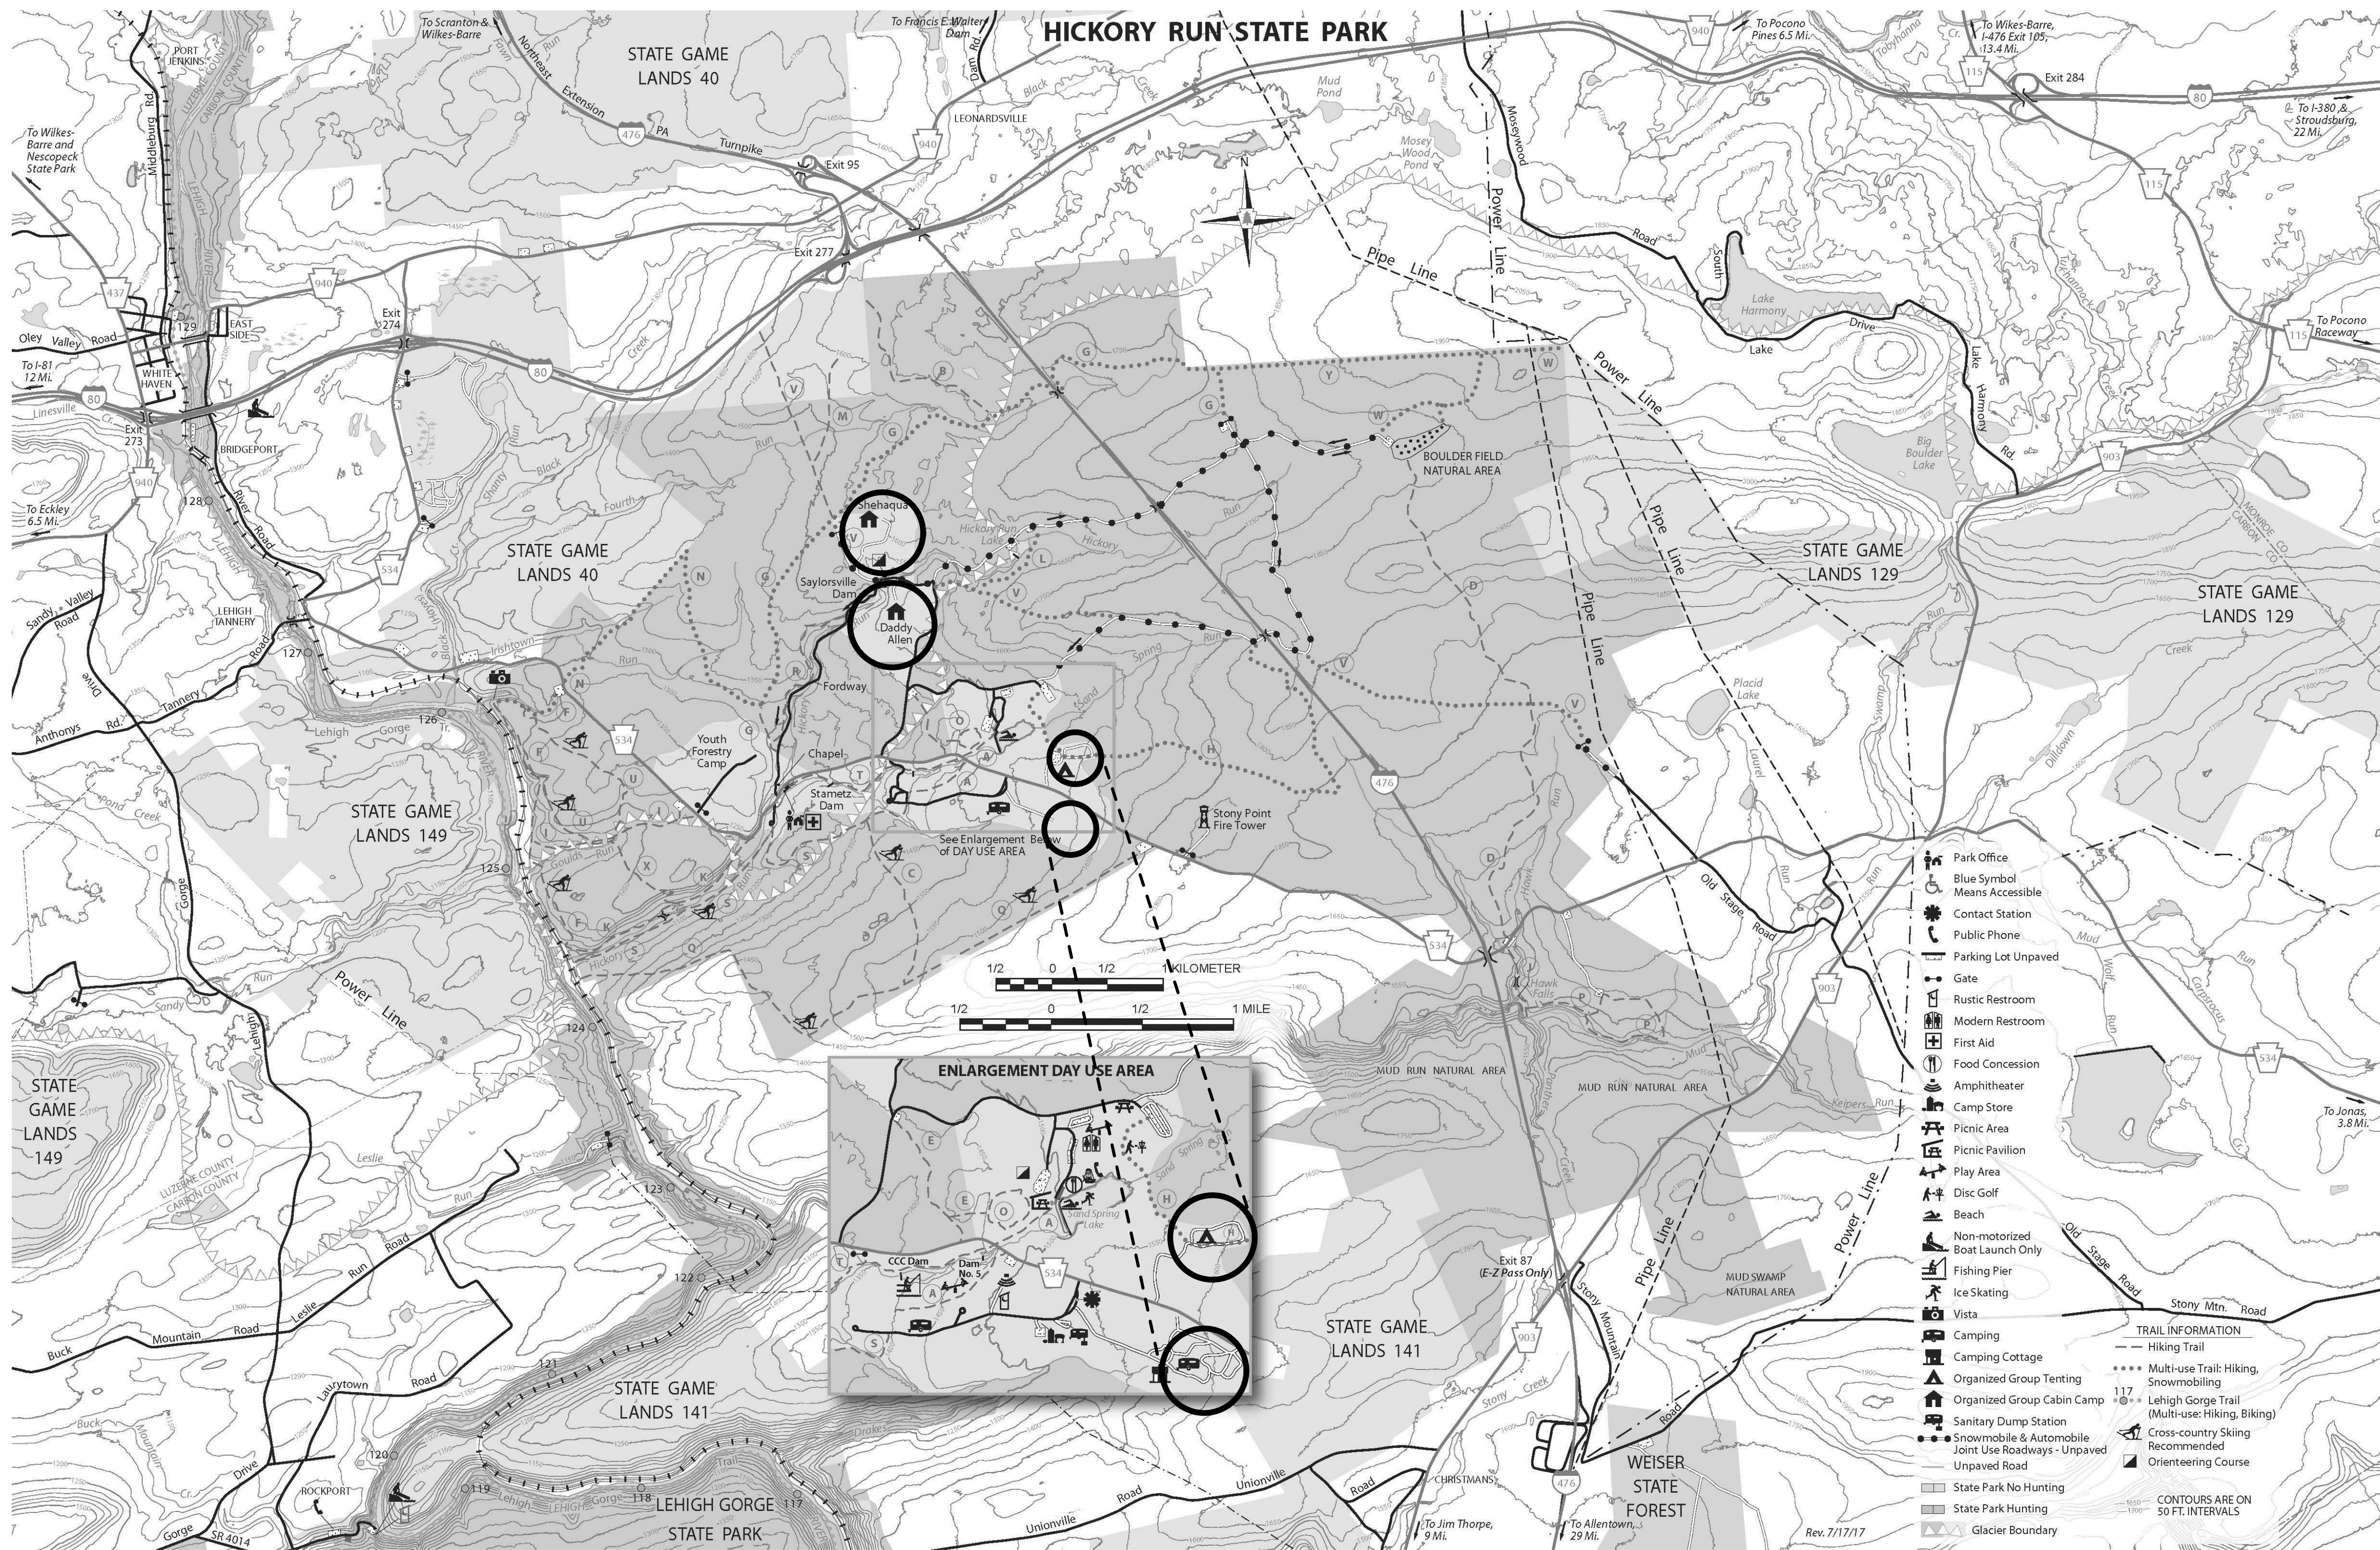

SMP ARCHITECTS
 1600 WALNUT STREET, SECOND FLOOR
 PHILADELPHIA, PENNSYLVANIA

COMMONWEALTH OF PENNSYLVANIA
 DEPARTMENT OF GENERAL SERVICES
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LATRINE IMPROVEMENTS
 DEPT of CONSERVATION AND NATURAL RESOURCES
 WHITE HAVEN, CARBON COUNTY, PA
 LAND TITLE LEASE SITE PLAN

VERIFY SCALE

BAR IS ONE (1) INCH LONG
 ON ORIGINAL DRAWING: 0 1

IF BAR IS NOT ONE (1) INCH LONG, ADJUST SCALE ACCORDINGLY

CONTRACTOR SHALL FIELD VERIFY ALL DIMENSIONS. VARIANCE FROM CONTRACT DOCUMENTS NOT PERMITTED WITHOUT PROFESSIONAL & BUREAU OF CONSTRUCTION APPROVAL.

DRAWN BY: M STRENSKI
 CHECKED BY: T WOODWARD

DATE: 06/17/2022
 SCALE: AS NOTED

DRAWING No. **G-2**

1 LAND TITLE LEASE SITE PLAN
 G-1

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HICKORY RUN - LATRINE IMPROVEMENTS

GOVERNING CODES
 PENNSYLVANIA UNIFORM CONSTRUCTION CODE (UCC)
 INTERNATIONAL BUILDING CODE 2015 (IBC)
 INTERNATIONAL ENERGY CONSERVATION CODE 2015 (IECC)
 INTERNATIONAL FIRE, MECHANICAL, ELECTRICAL, PLUMBING CODE 2015 (IFMPC)
 ICC/ANSI 117.1, 2015 and CHAPTER 11 AND APPENDIX E OF INTERNATIONAL BUILDING CODE 2018
 PENNSYLVANIA DEPARTMENT OF HEALTH CODE (CHAPTER 19)

CODE CHAPTER
 CHAPTER HEADING

3 USE AND OCCUPANCY CLASSIFICATION

303.1 GROUP B
 303.1.1. A BUILDING OR TENANT SPACE USED FOR ASSEMBLY PURPOSES WITH AN OCCUPANT LOAD OF LESS THAN 50 PERSONS SHALL BE CLASSIFIED AS A GROUP B OCCUPANCY.

5 GENERAL BUILDING HEIGHTS AND AREAS

TABLE 504.3.4. CONSTRUCTION TYPE VB
 ALLOWABLE HEIGHT ABOVE GRADE PLANE FOR GROUP B / NON-SPRINKLERED: 2 STORIES 40 FEET
 ACTUAL HEIGHT ABOVE GRADE PLANE: LOOP C = 1 STORY / 17'-9"
 OCTC CAMP = 1 STORY / 17'-5"
 OGC = 1 STORY / 17'-11"

TABLE 506.2 ALLOWABLE BUILDING AREA PER STORY FOR GROUP B / NON-SPRINKLERED: 9,000 SF
 LOOP C = 2,151 SF
 OCTC CAMP = 1,031 SF
 OGC = 1,184 SF

6 TYPES OF CONSTRUCTION

CONSTRUCTION TYPE VB IN WHICH THE STRUCTURAL ELEMENTS, EXTERIOR WALLS, AND INTERIOR WALLS ARE OF ANY MATERIALS PERMITTED BY THIS CODE.
 TABLE 601 FIRE-RESISTANCE RATING REQUIREMENTS FOR BUILDING ELEMENTS:
 PRIMARY STRUCTURAL FRAME: 0-HOUR
 EXTERIOR BEARING WALLS: 0-HOUR
 INTERIOR BEARING WALLS: 0-HOUR
 EXTERIOR NONBEARING WALLS AND PARTITIONS: 0-HOUR
 INTERIOR NONBEARING WALLS AND PARTITIONS: 0-HOUR
 FLOOR CONSTRUCTION: 0-HOUR
 ROOF CONSTRUCTION: 0-HOUR

7 FIRE AND SMOKE PROTECTION FEATURES

N/A

8 INTERIOR FINISHES

TABLE 803.11. INTERIOR WALL AND CEILING FINISH REQUIREMENTS BY OCCUPANCY CLASSIFICATION

LOCATION	GROUP B (NON-SPRINKLERED)
INTERIOR EXIT PASSAGEWAYS	CLASS A
CORRIDORS	CLASS B
ROOMS AND ENCLOSED SPACES	CLASS C

9 FIRE PROTECTION SYSTEMS

906.1 PORTABLE FIRE EXTINGUISHERS ARE REQUIRED THROUGHOUT THE BUILDING IN GROUP B OCCUPANCY
 TABLE 906.3 FIRE EXTINGUISHERS FOR CLASS A FIRE HAZARDS, LOW HAZARD OCCUPANCY
 MINIMUM RATED SINGLE EXTINGUISHER FOR = 2-A
 MAXIMUM FLOOR AREA PER UNIT OF A = 3,000 SF
 MAXIMUM FLOOR AREA FOR EXTINGUISHER = 11,250 SF
 MAXIMUM DISTANCE OF TRAVEL TO AN EXTINGUISHER = 75 FEET

10 MEANS OF EGRESS

TABLE 1004.1.2 MAXIMUM FLOOR AREA PER OCCUPANT
 ACCESSORY STORAGE / MECHANICAL EQUIPMENT ROOM = 300 GROSS SF/OCCUPANT
 LOCKER ROOMS = 50 GROSS SF/OCCUPANT

1005.3 THE TOTAL WIDTH OF THE MEANS OF EGRESS IN INCHES SHALL NOT BE LESS THAN THE TOTAL OCCUPANT LOAD SERVED BY THE MEANS OF EGRESS MULTIPLIED BY 0.2 INCHES PER OCCUPANT FOR OTHER EGRESS COMPONENTS

TABLE 1006.2.1 OCCUPANCY B, MAXIMUM OCCUPANT LOAD OF SPACE WITH ONE EXIT = 49 OCCUPANTS
 MAXIMUM COMMON PATH OF EGRESS TRAVEL DISTANCE = 75 FEET WHEN OCCUPANT LOAD IS GREATER THAN 30 AND 100 FEET WHEN OCCUPANT LOAD IS LESS THAN 30

1006.3.2 A SINGLE EXIT SHALL BE PERMITTED FROM ANY STORY OR OCCUPIED ROOF WHERE ONE OF THE FOLLOWING CONDITIONS EXISTS:
 1. THE OCCUPANT LOAD, NUMBER OF DWELLING UNITS AND COMMON PATH OR EGRESS TRAVEL DISTANCE DOES NOT EXCEED THE VALUES IN TABLE 1006.3.2(2).
 MAXIMUM OCCUPANT LOAD PER STORY = 49 OCCUPANTS AND MAXIMUM COMMON PATH OF EGRESS TRAVEL DISTANCE = 75 FEET.
 2. ROOMS, AREAS, AND SPACES COMPLYING WITH SECTION 1006.2.1 WITH EXITS THAT DISCHARGE DIRECTLY TO THE EXTERIOR AT THE LEVEL OF EXIT DISCHARGE, ARE PERMITTED TO HAVE ONE EXIT.

1008.1 MEANS OF EGRESS ILLUMINATION: ILLUMINATION SHALL BE PROVIDED IN THE MEANS OF EGRESS IN ACCORDANCE WITH SECTION 1008.2. UNDER EMERGENCY POWER, MEANS OF EGRESS ILLUMINATION SHALL COMPLY WITH SECTION 1008.3.
 1008.2 ILLUMINATION REQUIRED: THE MEANS OF EGRESS SERVING A ROOM OR SPACE SHALL BE ILLUMINATED AT ALL TIMES THAT THE ROOM OR SPACE IS OCCUPIED.
 1008.3 ILLUMINATION LEVEL UNDER NORMAL POWER: THE POWER SUPPLY FOR MEANS OF EGRESS ILLUMINATION SHALL NORMALLY BE PROVIDED BY THE PREMISES ELECTRICAL SUPPLY.
 1009.1 ACCESSIBLE MEANS OF EGRESS REQUIRED: ACCESSIBLE SPACES SHALL BE PROVIDED WITH NOT LESS THAN ONE ACCESSIBLE MEANS OF EGRESS.
 1010.1.1 SIZE OF DOORS: THE MINIMUM WIDTH OF EACH DOOR OPENING SHALL BE SUFFICIENT FOR THE OCCUPANT LOAD THEREOF AND SHALL PROVIDE A MINIMUM CLEAR WIDTH OF 32 INCHES.
 1010.1.2 DIRECTION OF SWING: PIVOT OR SIDE-HINGED SWINGING DOORS SHALL SWING IN THE DIRECTION OF EGRESS TRAVEL WHERE SERVING A ROOM OR AREA CONTAINING AN OCCUPANT LOAD OF 50 OR MORE PERSONS.
 1010.1.3 DOOR OPENING FORCE: THE FORCE FOR PUSHING OR PULLING OPEN INTERIOR SWINGING EGRESS DOORS SHALL NOT EXCEED 5 POUNDS (22 N). THESE FORCES DO NOT APPLY TO THE FORCE REQUIRED TO RETRACT LATCH BOLTS OR DISENGAGE OTHER DEVICES THAT HOLD THE DOOR IN A CLOSED POSITION; THE DOOR LATCH SHALL RELEASE WHEN SUBJECTED TO A 15-POUND (67 N) FORCE.
 1013.1 EXCEPTION 1: EXIT SIGNS ARE NOT REQUIRED IN ROOMS OR AREAS THAT REQUIRE ONLY ONE EXIT OR EXIT ACCESS.
 TABLE 1017.2. IN GROUP B OCCUPANCY WITHOUT AN AUTOMATIC SPRINKLER SYSTEM, THE MAXIMUM EXIT ACCESS TRAVEL DISTANCE IS 200 FT.

11 ACCESSIBILITY

1103.1 WHERE REQUIRED: SITES, BUILDINGS, STRUCTURES, FACILITIES, ELEMENTS AND SPACES, TEMPORARY OR PERMANENT, SHALL BE ACCESSIBLE TO INDIVIDUALS WITH DISABILITIES.
 1104.1 SITE ARRIVAL POINTS: AT LEAST ONE ACCESSIBLE ROUTE WITHIN THE SITE SHALL BE PROVIDED FROM ACCESSIBLE PARKING AND SIDEWALKS TO THE ACCESSIBLE BUILDING ENTRANCE SERVED.
 1105.1 PUBLIC ENTRANCES: AT LEAST 60 PERCENT OF ALL PUBLIC ENTRANCES SHALL BE ACCESSIBLE.
 EXCEPTION: AN ACCESSIBLE ENTRANCE IS NOT REQUIRED TO AREAS NOT REQUIRED TO BE ACCESSIBLE.
 1106.1 PARKING AND PASSENGER LOADING FACILITIES: WHERE PARKING IS PROVIDED, ACCESSIBLE PARKING SPACES SHALL BE PROVIDED IN COMPLIANCE WITH TABLE 1106.1.
 TABLE 1106.1: TOTAL PARKING SPACES PROVIDED = 1-25, REQUIRED MINIMUM NUMBER OF ACCESSIBLE SPACES = 1.
 1109.2 TOILET AND BATHING FACILITIES: EACH TOILET AND BATHING ROOM SHALL BE ACCESSIBLE, EXCEPT AS PROVIDED FOR IN SECTIONS 1109.2.2 AND 1109.2.3, AT LEAST ONE OF EACH TYPE OF FIXTURE, ELEMENT, CONTROL OR DISPENSER IN EACH ACCESSIBLE TOILET ROOM SHALL BE ACCESSIBLE.
 1109.2.1 FAMILY OR ASSISTED-USE TOILET AND BATHING ROOMS: IN RECREATIONAL FACILITIES WHERE SEPARATE-SEX BATHING ROOMS ARE PROVIDED, AN ACCESSIBLE FAMILY OR ASSISTED-USE BATHING ROOM SHALL BE PROVIDED.
 1109.2.1.6 CLEAR FLOOR SPACE: WHERE DOORS SWING INTO A FAMILY OR ASSISTED-USE TOILET OR BATHING ROOM, A CLEAR FLOOR SPACE NOT LESS THAN 30 INCHES BY 48 INCHES SHALL BE PROVIDED, WITHIN THE ROOM, BEYOND THE AREA OF THE DOOR SWING.
 1109.2.1.7 PRIVACY: DOORS TO FAMILY OR ASSISTED-USE TOILET AND BATHING ROOMS SHALL BE SECURABLE FROM WITHIN THE ROOM.
 1109.2.2 WATER CLOSET COMPARTMENT: WHERE WATER CLOSET COMPARTMENTS ARE PROVIDED IN A TOILET ROOM OR BATHING ROOM, AT LEAST 5 PERCENT OF THE TOTAL NUMBER OF COMPARTMENTS SHALL BE WHEELCHAIR ACCESSIBLE. WHERE THE COMBINED TOTAL WATER CLOSET COMPARTMENTS AND URINALS PROVIDED IN A TOILET ROOM OR BATHING ROOM IS SIX OR MORE, AT LEAST 5 PERCENT OF THE TOTAL NUMBER OF COMPARTMENTS SHALL BE AMBULATORY ACCESSIBLE, PROVIDED IN ADDITION TO THE WHEELCHAIR-ACCESSIBLE COMPARTMENT.
 1109.2.3 LAVATORIES: WHERE LAVATORIES ARE PROVIDED, AT LEAST 5 PERCENT, BUT NOT LESS THAN ONE, SHALL BE ACCESSIBLE.
 1109.5 DRINKING FOUNTAINS: WHERE DRINKING FOUNTAINS ARE PROVIDED ON AN EXTERIOR SITE, THE DRINKING FOUNTAINS SHALL BE PROVIDED IN ACCORDANCE WITH SECTIONS 1109.5.1 AND 1109.5.2.
 1109.5.1 MINIMUM NUMBER: NOT FEWER THAN TWO DRINKING FOUNTAINS SHALL BE PROVIDED. ONE DRINKING FOUNTAIN SHALL COMPLY WITH THE REQUIREMENTS FOR PEOPLE WHO USE A WHEELCHAIR AND ONE DRINKING FOUNTAIN SHALL COMPLY WITH THE REQUIREMENTS FOR STANDING PERSONS.
 EXCEPTION 1: A SINGLE DRINKING FOUNTAIN WITH TWO SEPARATE SPOUTS THAT COMPLIES WITH THE REQUIREMENTS FOR PEOPLE WHO USE A WHEELCHAIR AND STANDING PERSONS SHALL BE PERMITTED TO BE SUBSTITUTED FOR TWO SEPARATE DRINKING FOUNTAINS.
 1111.1 SIGNS: REQUIRED ACCESSIBLE ELEMENTS SHALL BE IDENTIFIED BY THE INTERNATIONAL SYMBOL OF ACCESSIBILITY AT THESE LOCATIONS: (1) ACCESSIBLE PARKING SPACES REQUIRED BY SECTION 1106.1, EXCEPTION: WHERE THE TOTAL NUMBER OF PARKING SPACES PROVIDED IS FOUR OR LESS, IDENTIFICATION OF ACCESSIBLE PARKING SPACES IS NOT REQUIRED. (7) FAMILY OR ASSISTED-USE TOILET AND BATHING ROOMS.

DEPARTMENT OF HEALTH - PENNSYLVANIA CODE

CHAPTER 19
 19.26 CAMPGROUNDS: TOILET FACILITIES IN CAMPGROUNDS SHALL BE PROVIDED BASED ON TABLE 19.26:
 81-100 CAMPSITES: TOILET SEATS- MALE (3), FEMALE (4), LAVATORIES- MALE (4), FEMALE (4), URINALS- MALE (2)
 FOR EACH ADDITIONAL 1-100 SPACES, ADD 1 FIXTURE FOR EACH TYPE


LOOP C- 108 CAMPSITES
 TOILET SEATS- MALE (4), FEMALE (5)
 LAVATORIES- MALE (5), FEMALE (5)
 URINALS- MALE (3)

OGTC - N/A


OGC - N/A
 RESTROOMS FOR CAMPSITES LOCATED ELSEWHERE

CODE PLAN KEY

DOOR CAPACITY		CORRIDOR CAPACITY		SYMBOLS	
EXIT WIDTH	EXIT DOOR EW 36" FC 0.2 ALLOW 180 ACTUAL 16	CLEAR CORRIDOR WIDTH	CORRIDOR CW 72" FC 0.2 ALLOW 180 ACTUAL 16	FIRE EXTINGUISHER FE	OCCUPANT LOAD PER SPACE #
ALLOWABLE CAPACITY		EGRESS WIDTH PER OCCUPANT			
RATED WALLS		MAXIMUM TRAVEL DISTANCE			
1 HOUR FIRE PARTITION (FIRE BARRIER WHERE NOTED)		PATH OF EXIT ACCESS TRAVEL (WHERE APPLICABLE)			
2 HOUR FIRE BARRIER					

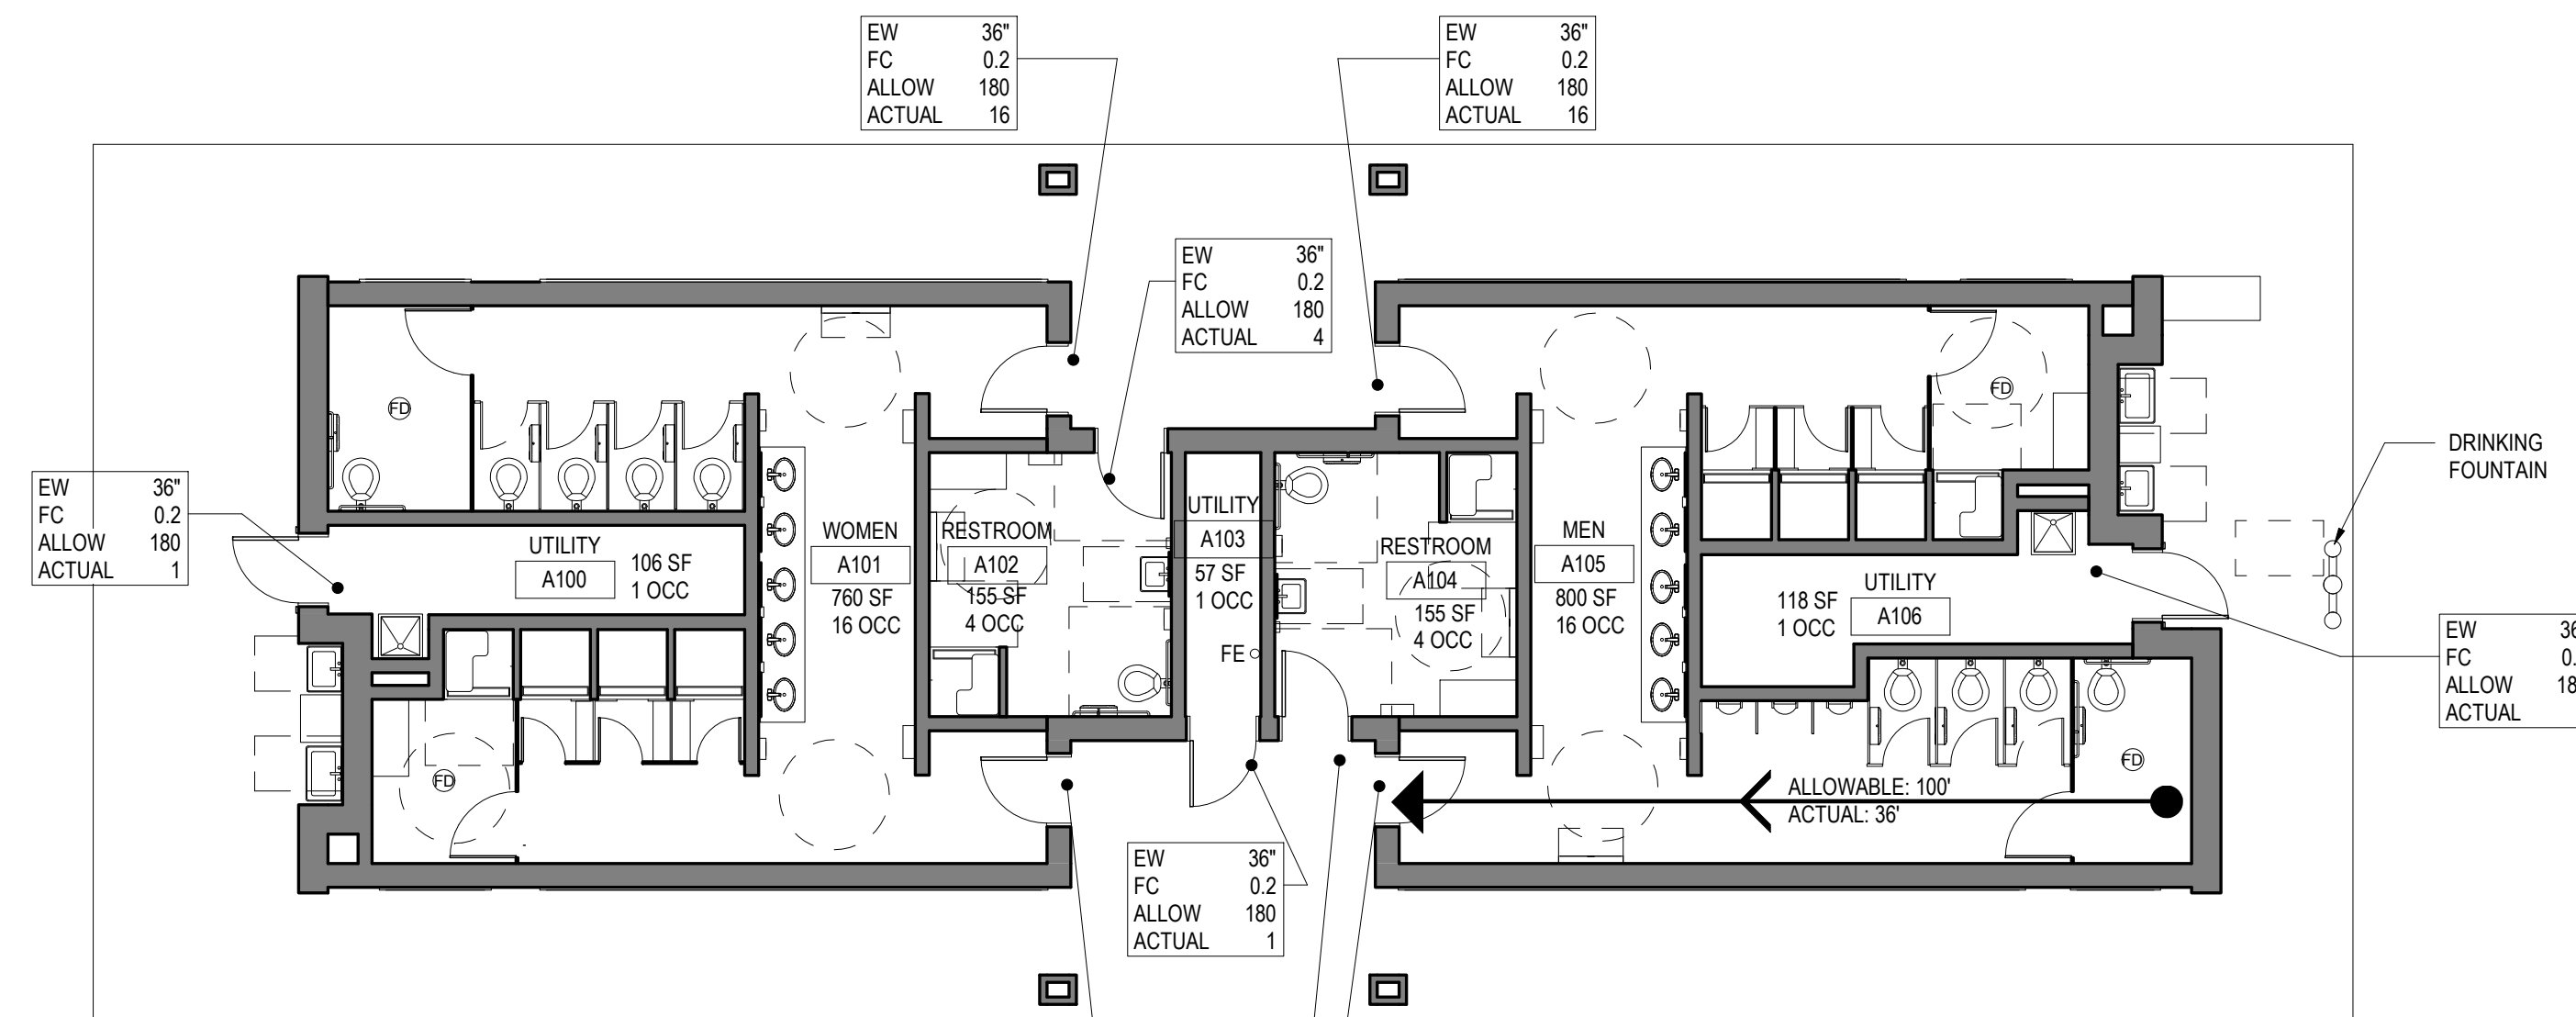

3 CODE PLAN- LOOP C
 1/8" = 1'-0"

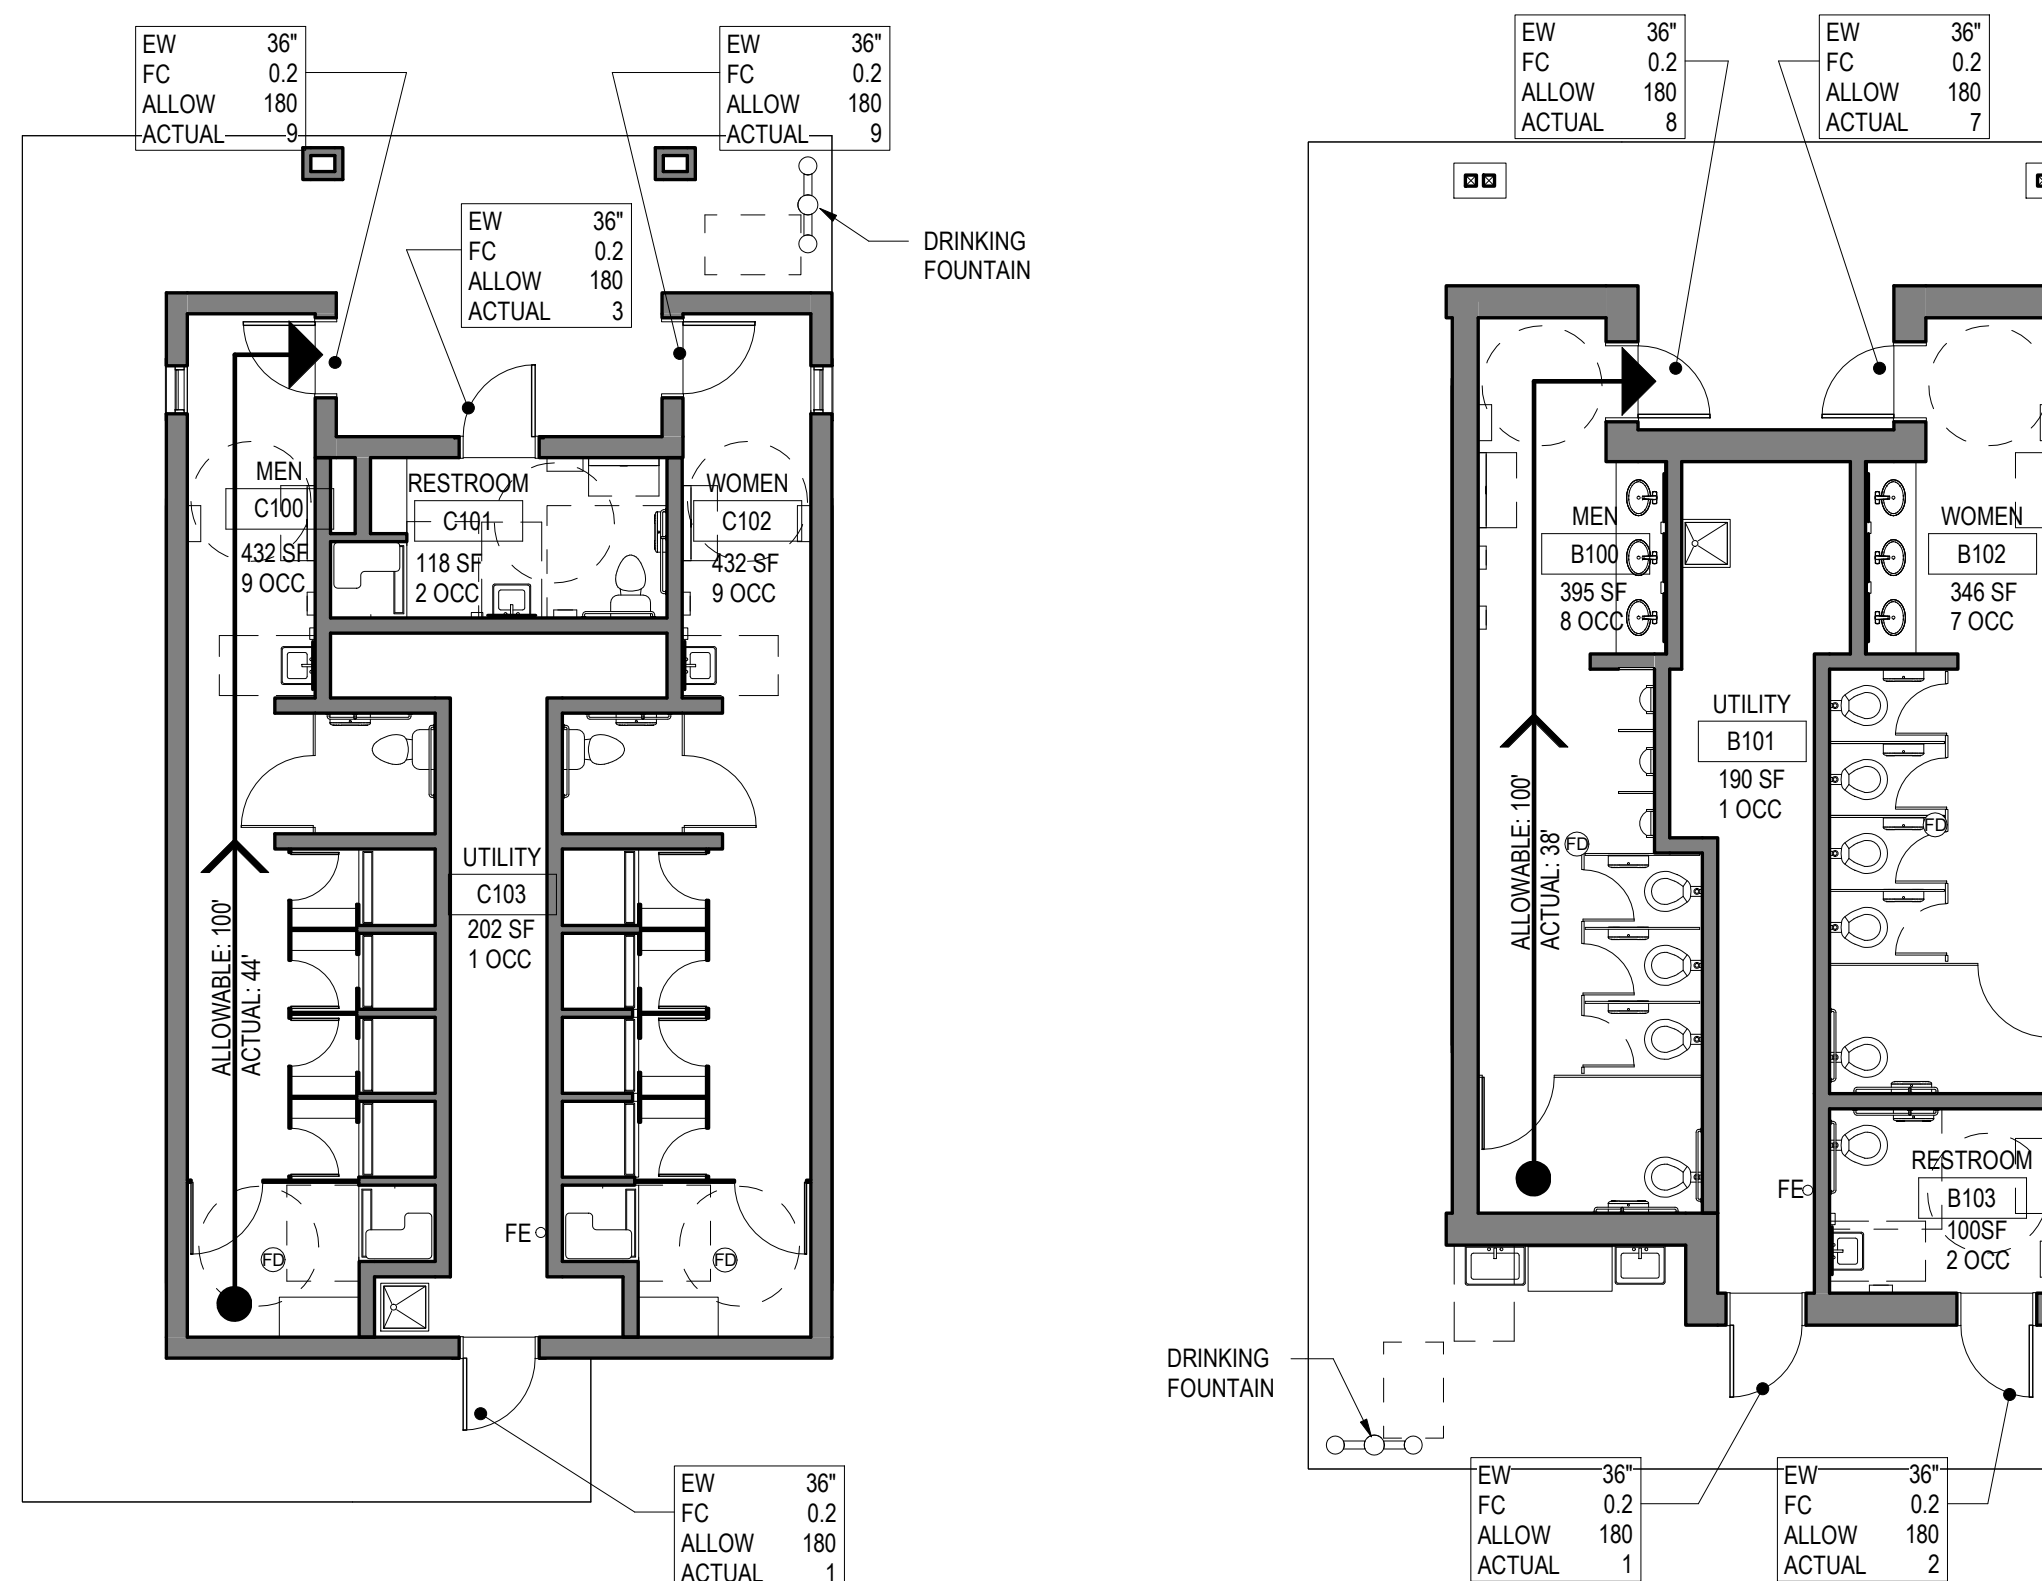

2 CODE PLAN OGC- DADDY ALLEN AND SHEHAQUA
 1/8" = 1'-0"

1 CODE PLAN - OGTC CAMP
 1/8" = 1'-0"

CONSTRUCTION DOCUMENTS

NO.	DESCRIPTION	DATE

RECORD REVISIONS

03/05/2021 SIGNATURE _____ DATE _____	

SMP ARCHITECTS
 1600 WALNUT STREET, SECOND FLOOR
 PHILADELPHIA, PENNSYLVANIA

**COMMONWEALTH OF PENNSYLVANIA
 DEPARTMENT OF GENERAL SERVICES**
 HARRISBURG, PENNSYLVANIA

D.G.S. PROJECT No.
C-114-0006 PHASE 1

**HICKORY RUN STATE PARK
 LATRINE IMPROVEMENTS**

DEPT. OF CONSERVATION AND NATURAL RESOURCES
 WHITE HAVEN, CARBON COUNTY, PA

BUILDING CODE INFORMATION


VERIFY SCALE

BAR IS ONE (1) INCH LONG
 ON ORIGINAL DRAWING:
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IF BAR IS NOT ONE (1) INCH LONG,
 ADJUST SCALE ACCORDINGLY

CONTRACTOR SHALL FIELD VERIFY ALL DIMENSIONS
 VARIANCE FROM CONTRACT DOCUMENTS NOT PERMITTED WITHOUT PROFESSIONAL & BUREAU OF CONSTRUCTION APPROVAL.


DRAWN BY M STRENSKI	DATE 06/17/2022	DRAWING No. G-3
CHECKED BY T WOODWARD	SCALE AS NOTED	5 OF 144

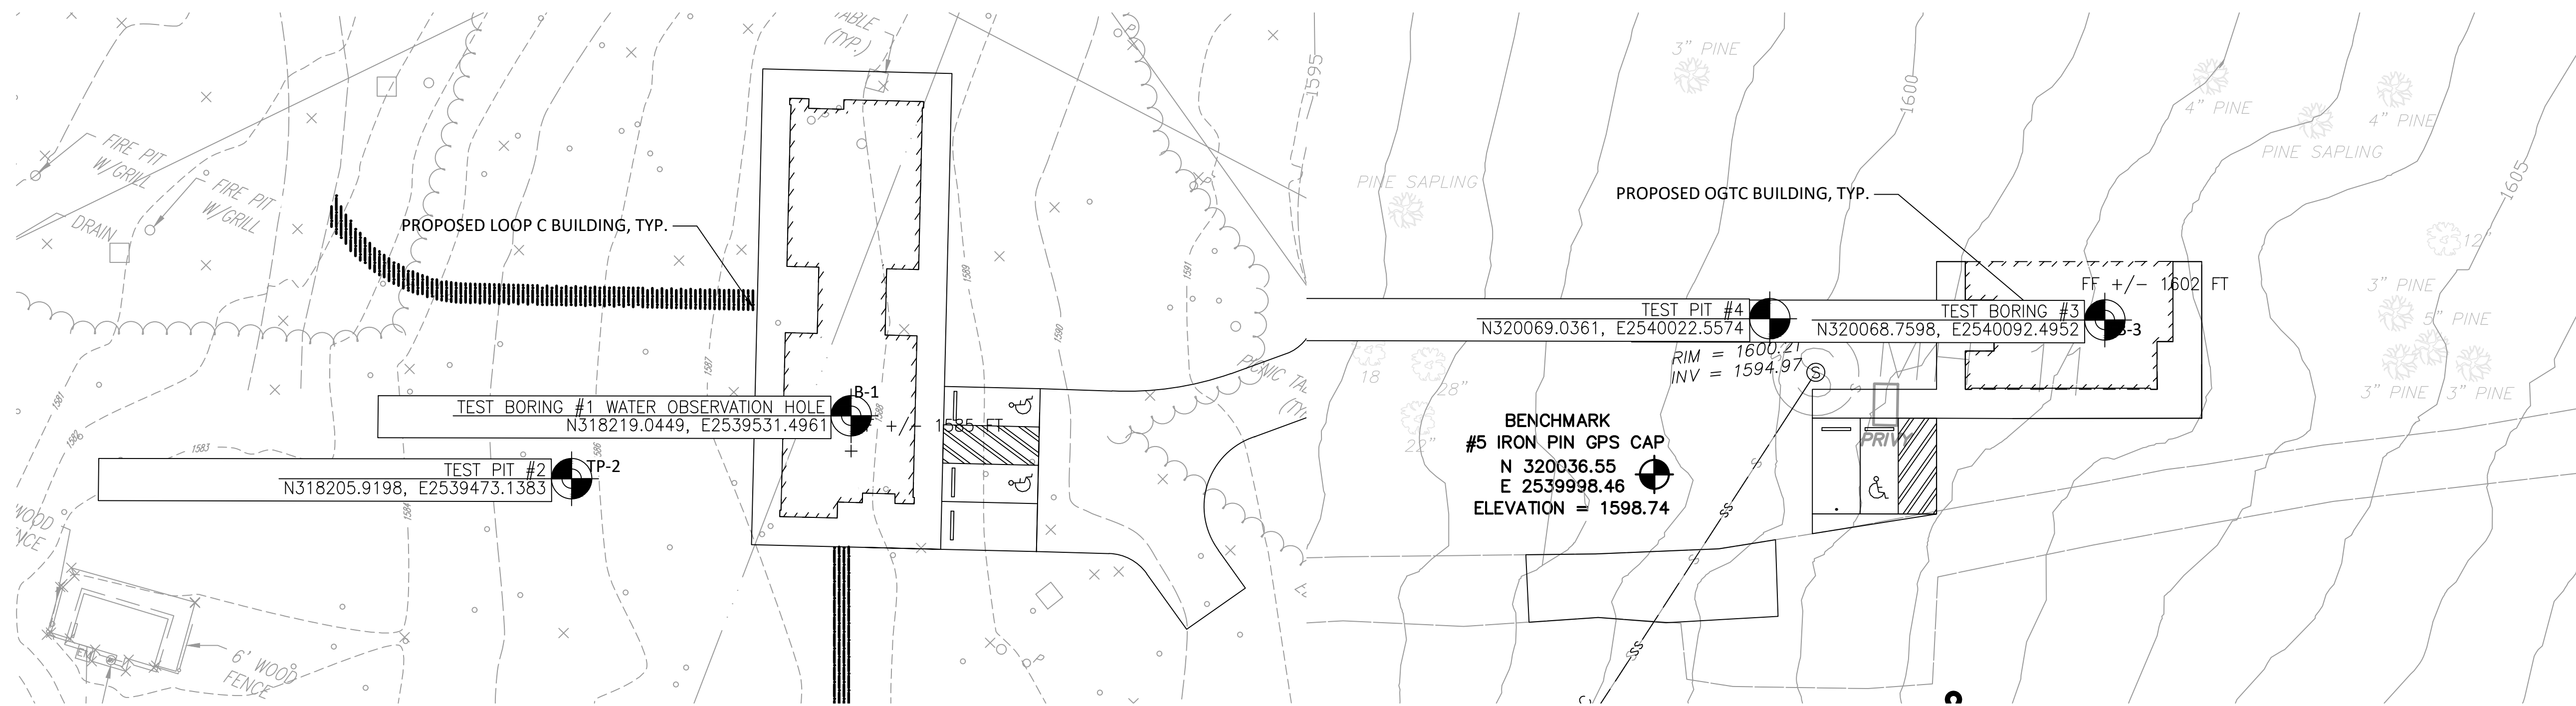


1 TB-1 GEOTECHNICAL TESTING PLAN
 TB-0 LOOP C 1"=20'

2 TB-2 GEOTECHNICAL TESTING PLAN
 TB-0 OGTC 1"=20'


- NOTES:
1. ALL TEST BORINGS SHALL BE CARRIED TO THE DEPTHS LISTED IN THE SCHEDULE, EXCEPT WHERE ROCK IS ENCOUNTERED PRIOR THERETO, IN WHICH CASE, CORING SHALL EXTEND (5) FEET INTO THE ROCK, WHETHER OR NOT THE FINAL DEPTH IS MORE OR LESS THAN THE DEPTH LISTED IN THE SCHEDULE, EXCEPT THAT CERTAIN BORINGS SHALL BE CARRIED TO THE CONTRACT DEPTH REGARDLESS OF THE MATERIALS ENCOUNTERED.
 2. ALL INFILTRATION TESTS SHALL BE DOUBLE-RING INFILTRMETER TESTS AND PERFORMED TO THE DEPTHS SPECIFIED IN THE SCHEDULE. TESTING REQUIREMENTS SHALL FOLLOW PA STORMWATER BMP MANUAL AND KIDDER TOWNSHIP CODE CHAPTER 148.

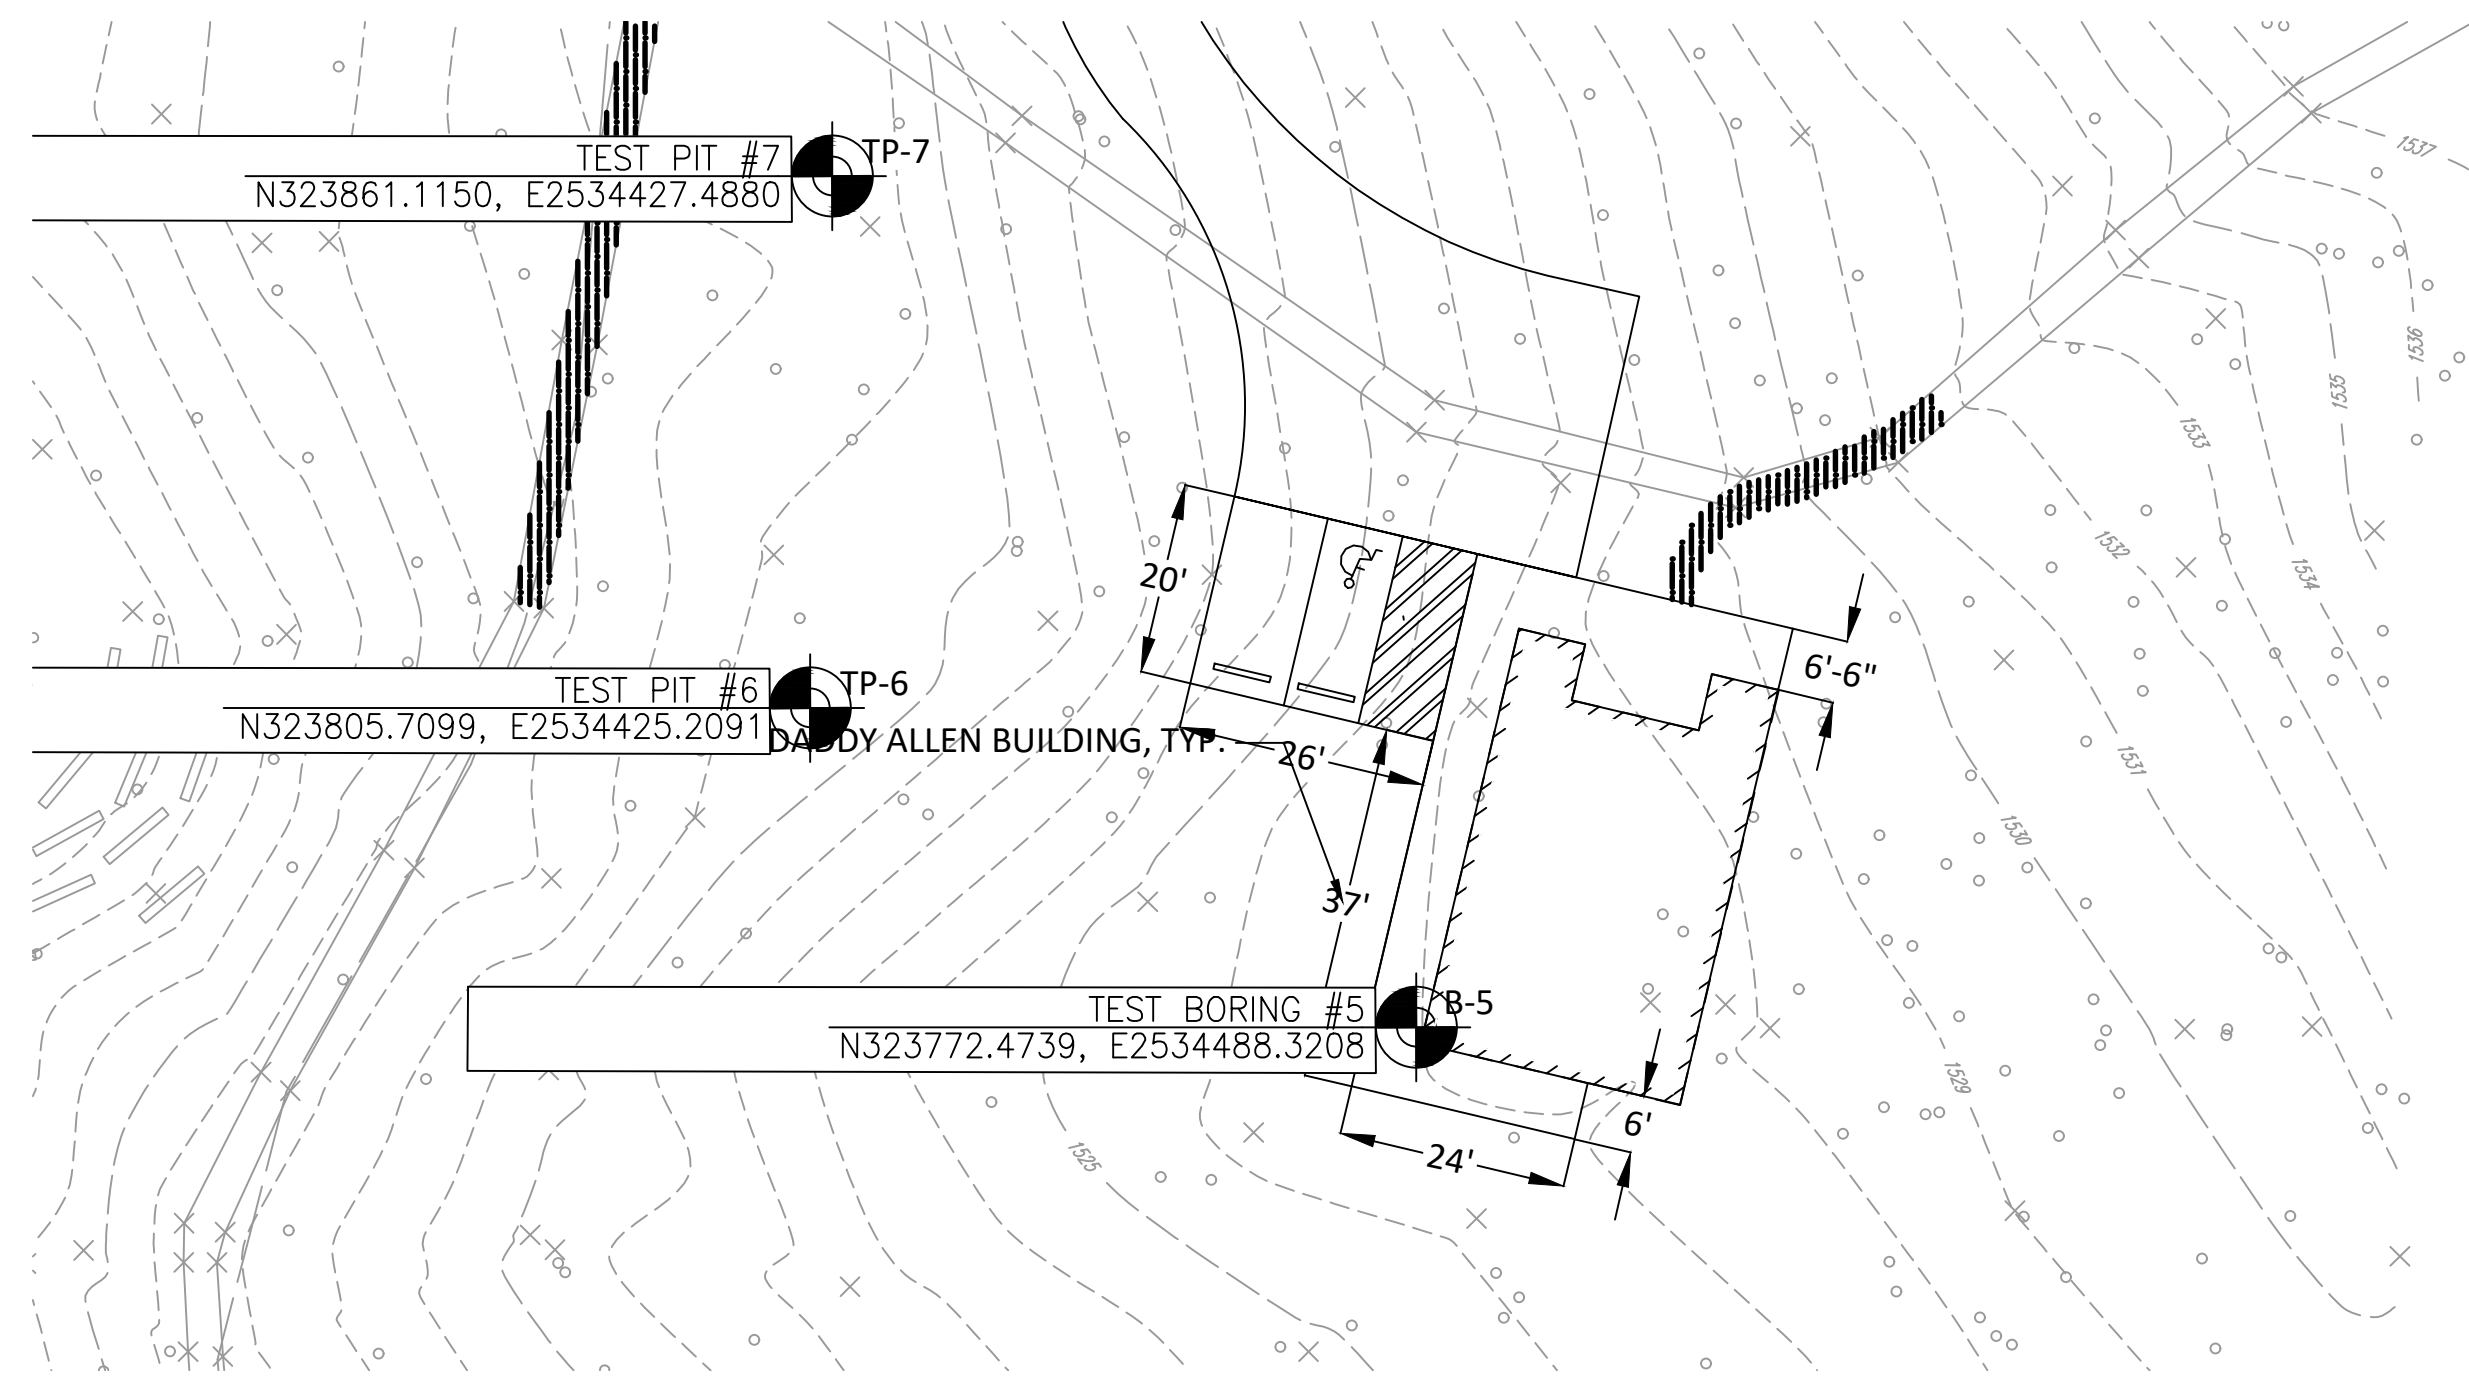

3 TB-3 GEOTECHNICAL TESTING PLAN
 TB-0 DADDY ALLEN 1"=20'

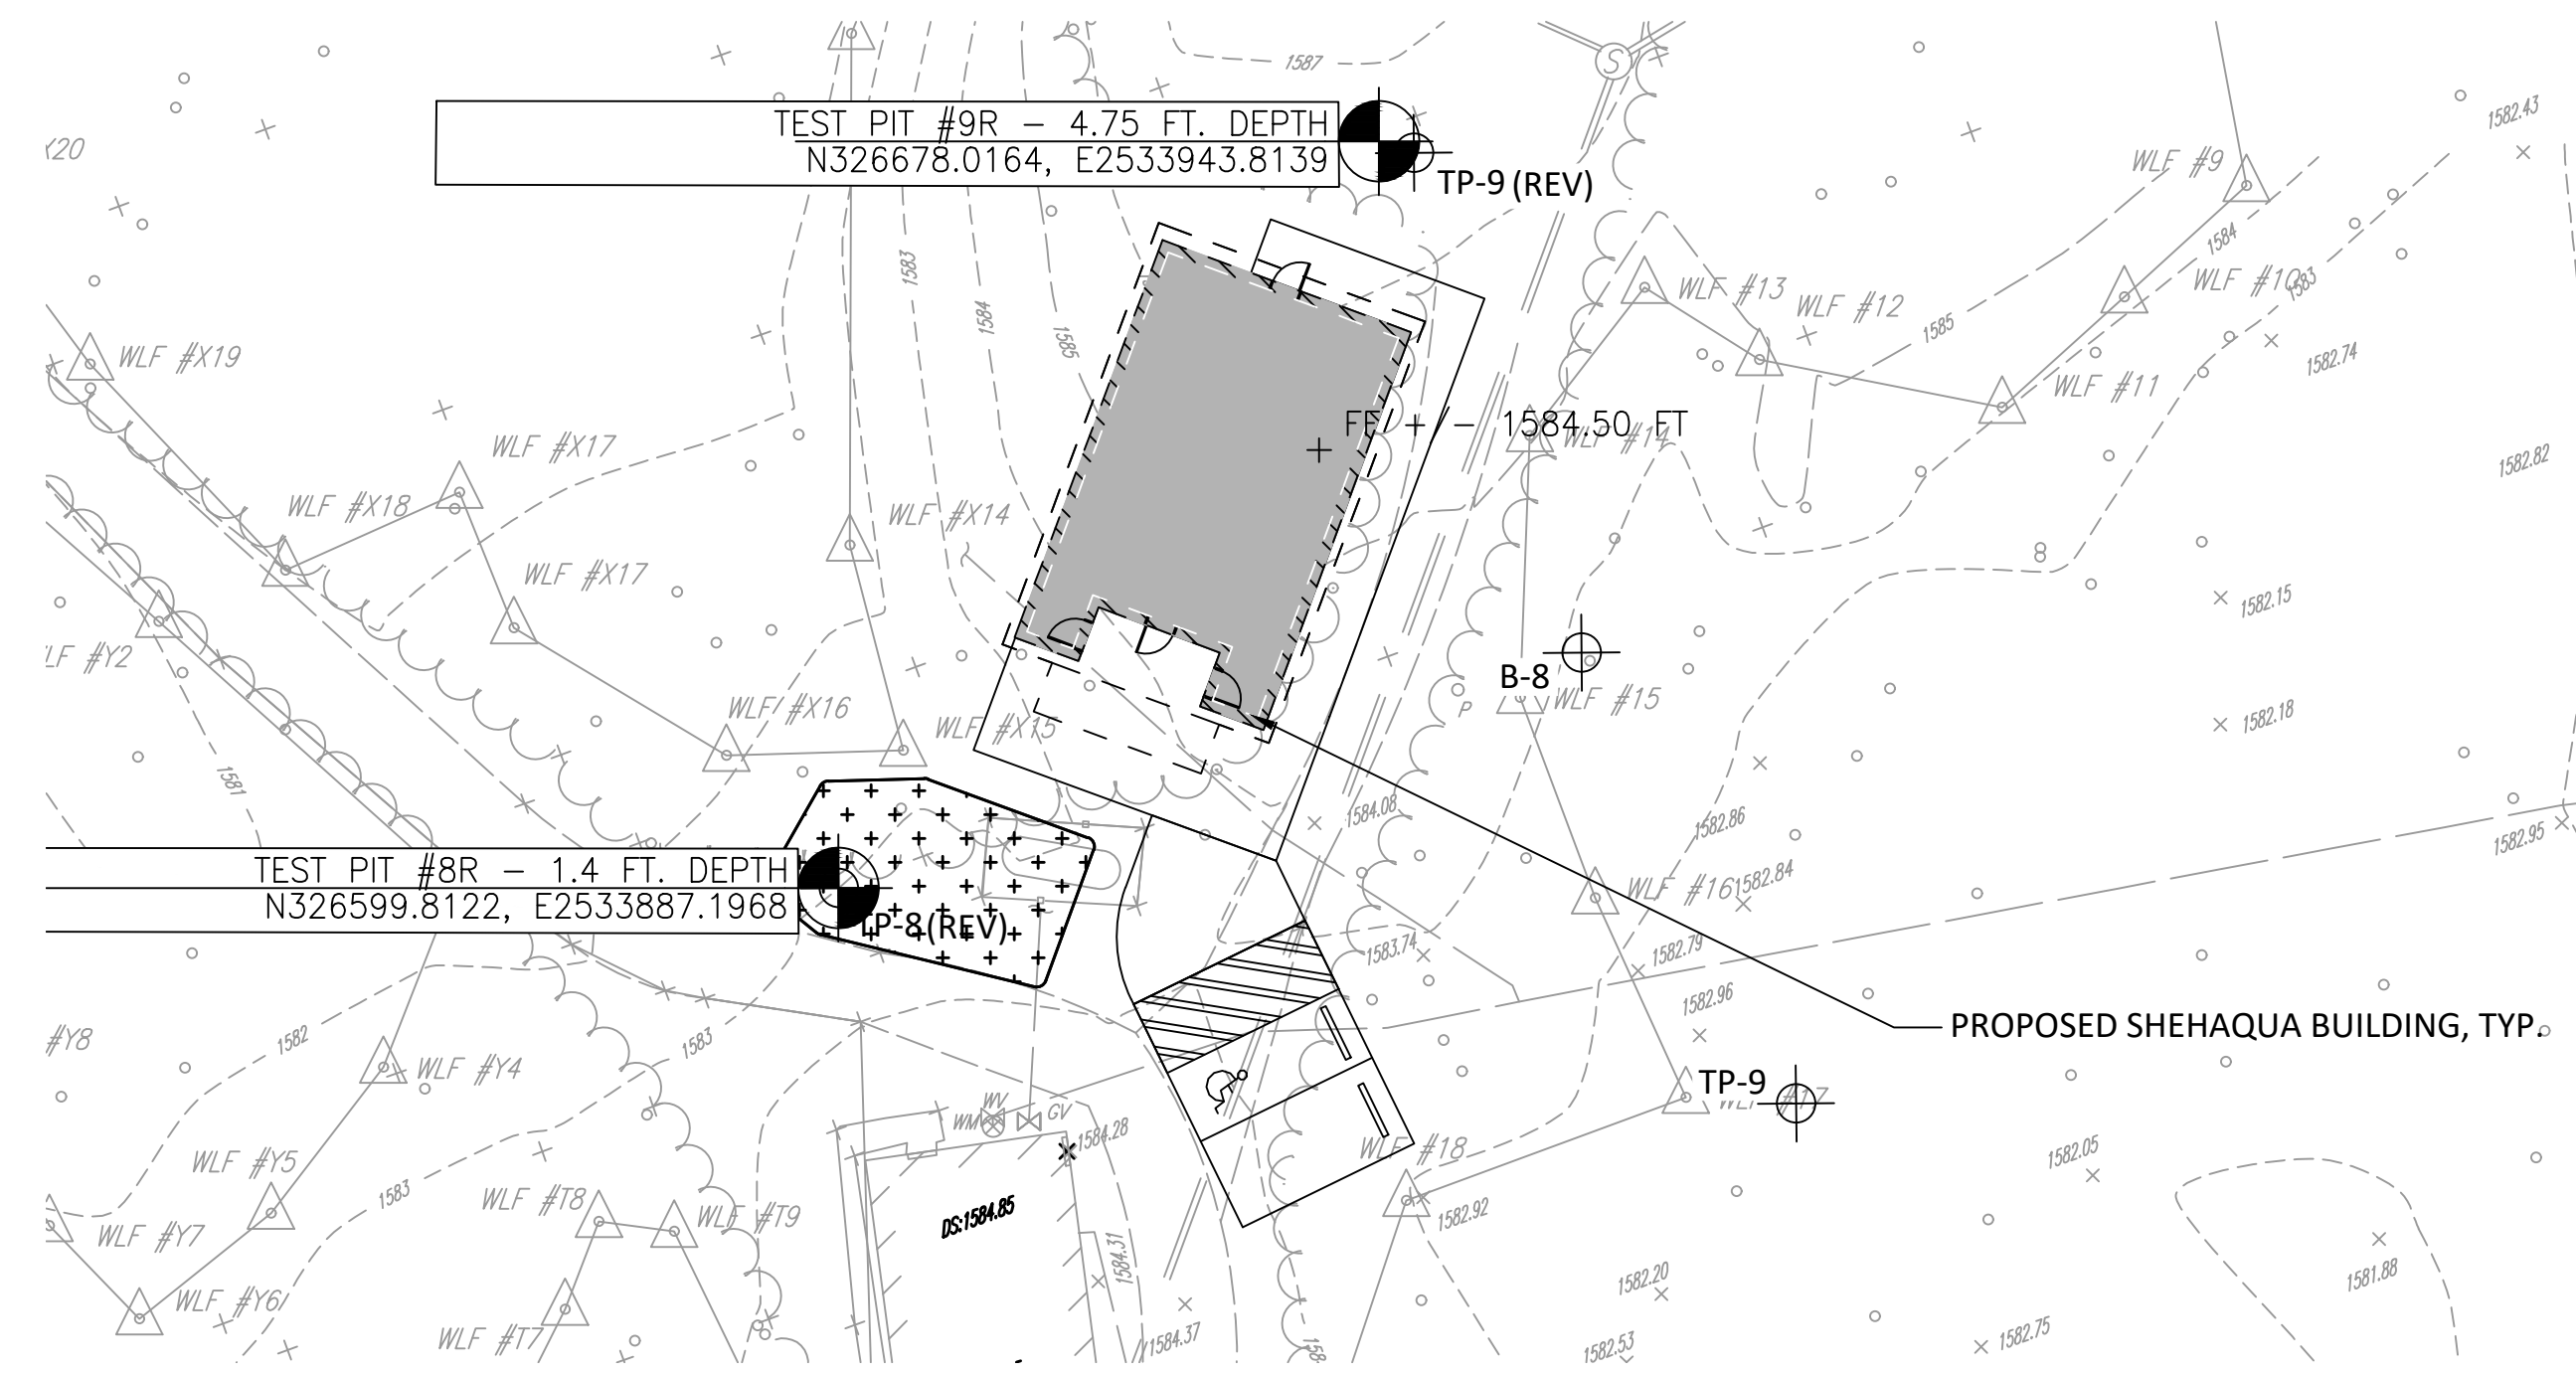

4 TB-4 GEOTECHNICAL TESTING PLAN
 TB-0 SHEHAQUA 1"=20'

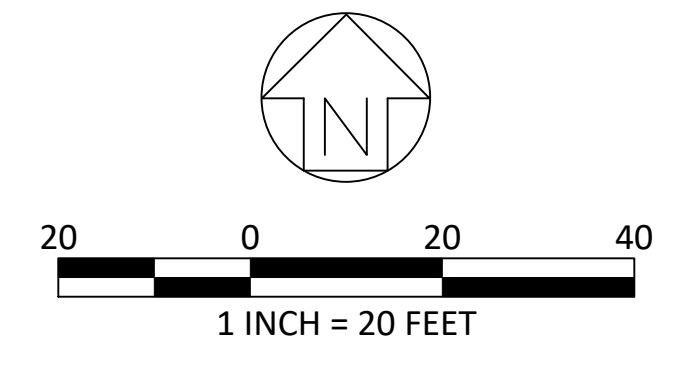

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 1600 WALNUT STREET, SECOND FLOOR
 PHILADELPHIA, PENNSYLVANIA

COMMONWEALTH OF PENNSYLVANIA
 DEPARTMENT OF GENERAL SERVICES
 HARRISBURG, PENNSYLVANIA

D.G.S. PROJECT No.
C-114-0006 PHASE 1

HICKORY RUN STATE PARK
 LATRINE IMPROVEMENTS
 DEPT of CONSERVATION AND NATURAL RESOURCES
 WHITE HAVEN, CARBON COUNTY, PA

TEST BORING LOCATION PLAN AND SCHEDULE - SHEET 1

TEST NUMBER	TEST	TEST SCHEDULE	SURFACE ELEVATION	CONTRACT DEPTHS	ACTUAL DEPTHS
1	STANDARD BORING			25.00 Ft	
2	TEST PIT			7.00 Ft	
3	STANDARD BORING			25.00 Ft	
4	TEST PIT			7.00 Ft	
5	STANDARD BORING			25.00 Ft	
6	TEST PIT			7.00 Ft	
7	TEST PIT			7.00 Ft	
8	STANDARD BORING			25.00 Ft	
9	TEST PIT			7.00 Ft	

SCHEDULE OF CONTRACT QUANTITIES

No. Holes	Earth Drilling	Rock Coring	Total Footage
4 Std. Borings	100 Lin. Ft.	0 Lin. Ft.	100 Lin. Ft.

No of Soil Test Pits: 5 each
 No of Soil Infiltration Tests: 10 each

VERIFY SCALE

BAR IS ONE (1) INCH LONG ON ORIGINAL DRAWING:


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IF BAR IS NOT ONE (1) INCH LONG, ADJUST SCALE ACCORDINGLY


CONTRACTOR SHALL FIELD VERIFY ALL DIMENSIONS. VARIANCE FROM CONTRACT DOCUMENTS NOT PERMITTED WITHOUT PROFESSIONAL & BUREAU OF CONSTRUCTION APPROVAL.

DRAWN BY M DIMONTE	DATE 06/07/2022	DRAWING No. TB-0
CHECKED BY J ADAMS	SCALE AS NOTED	

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 PLOTTED BY: James Adams
 PLOTTED: 2022.06.17 10:07 AM
 6 OF 144

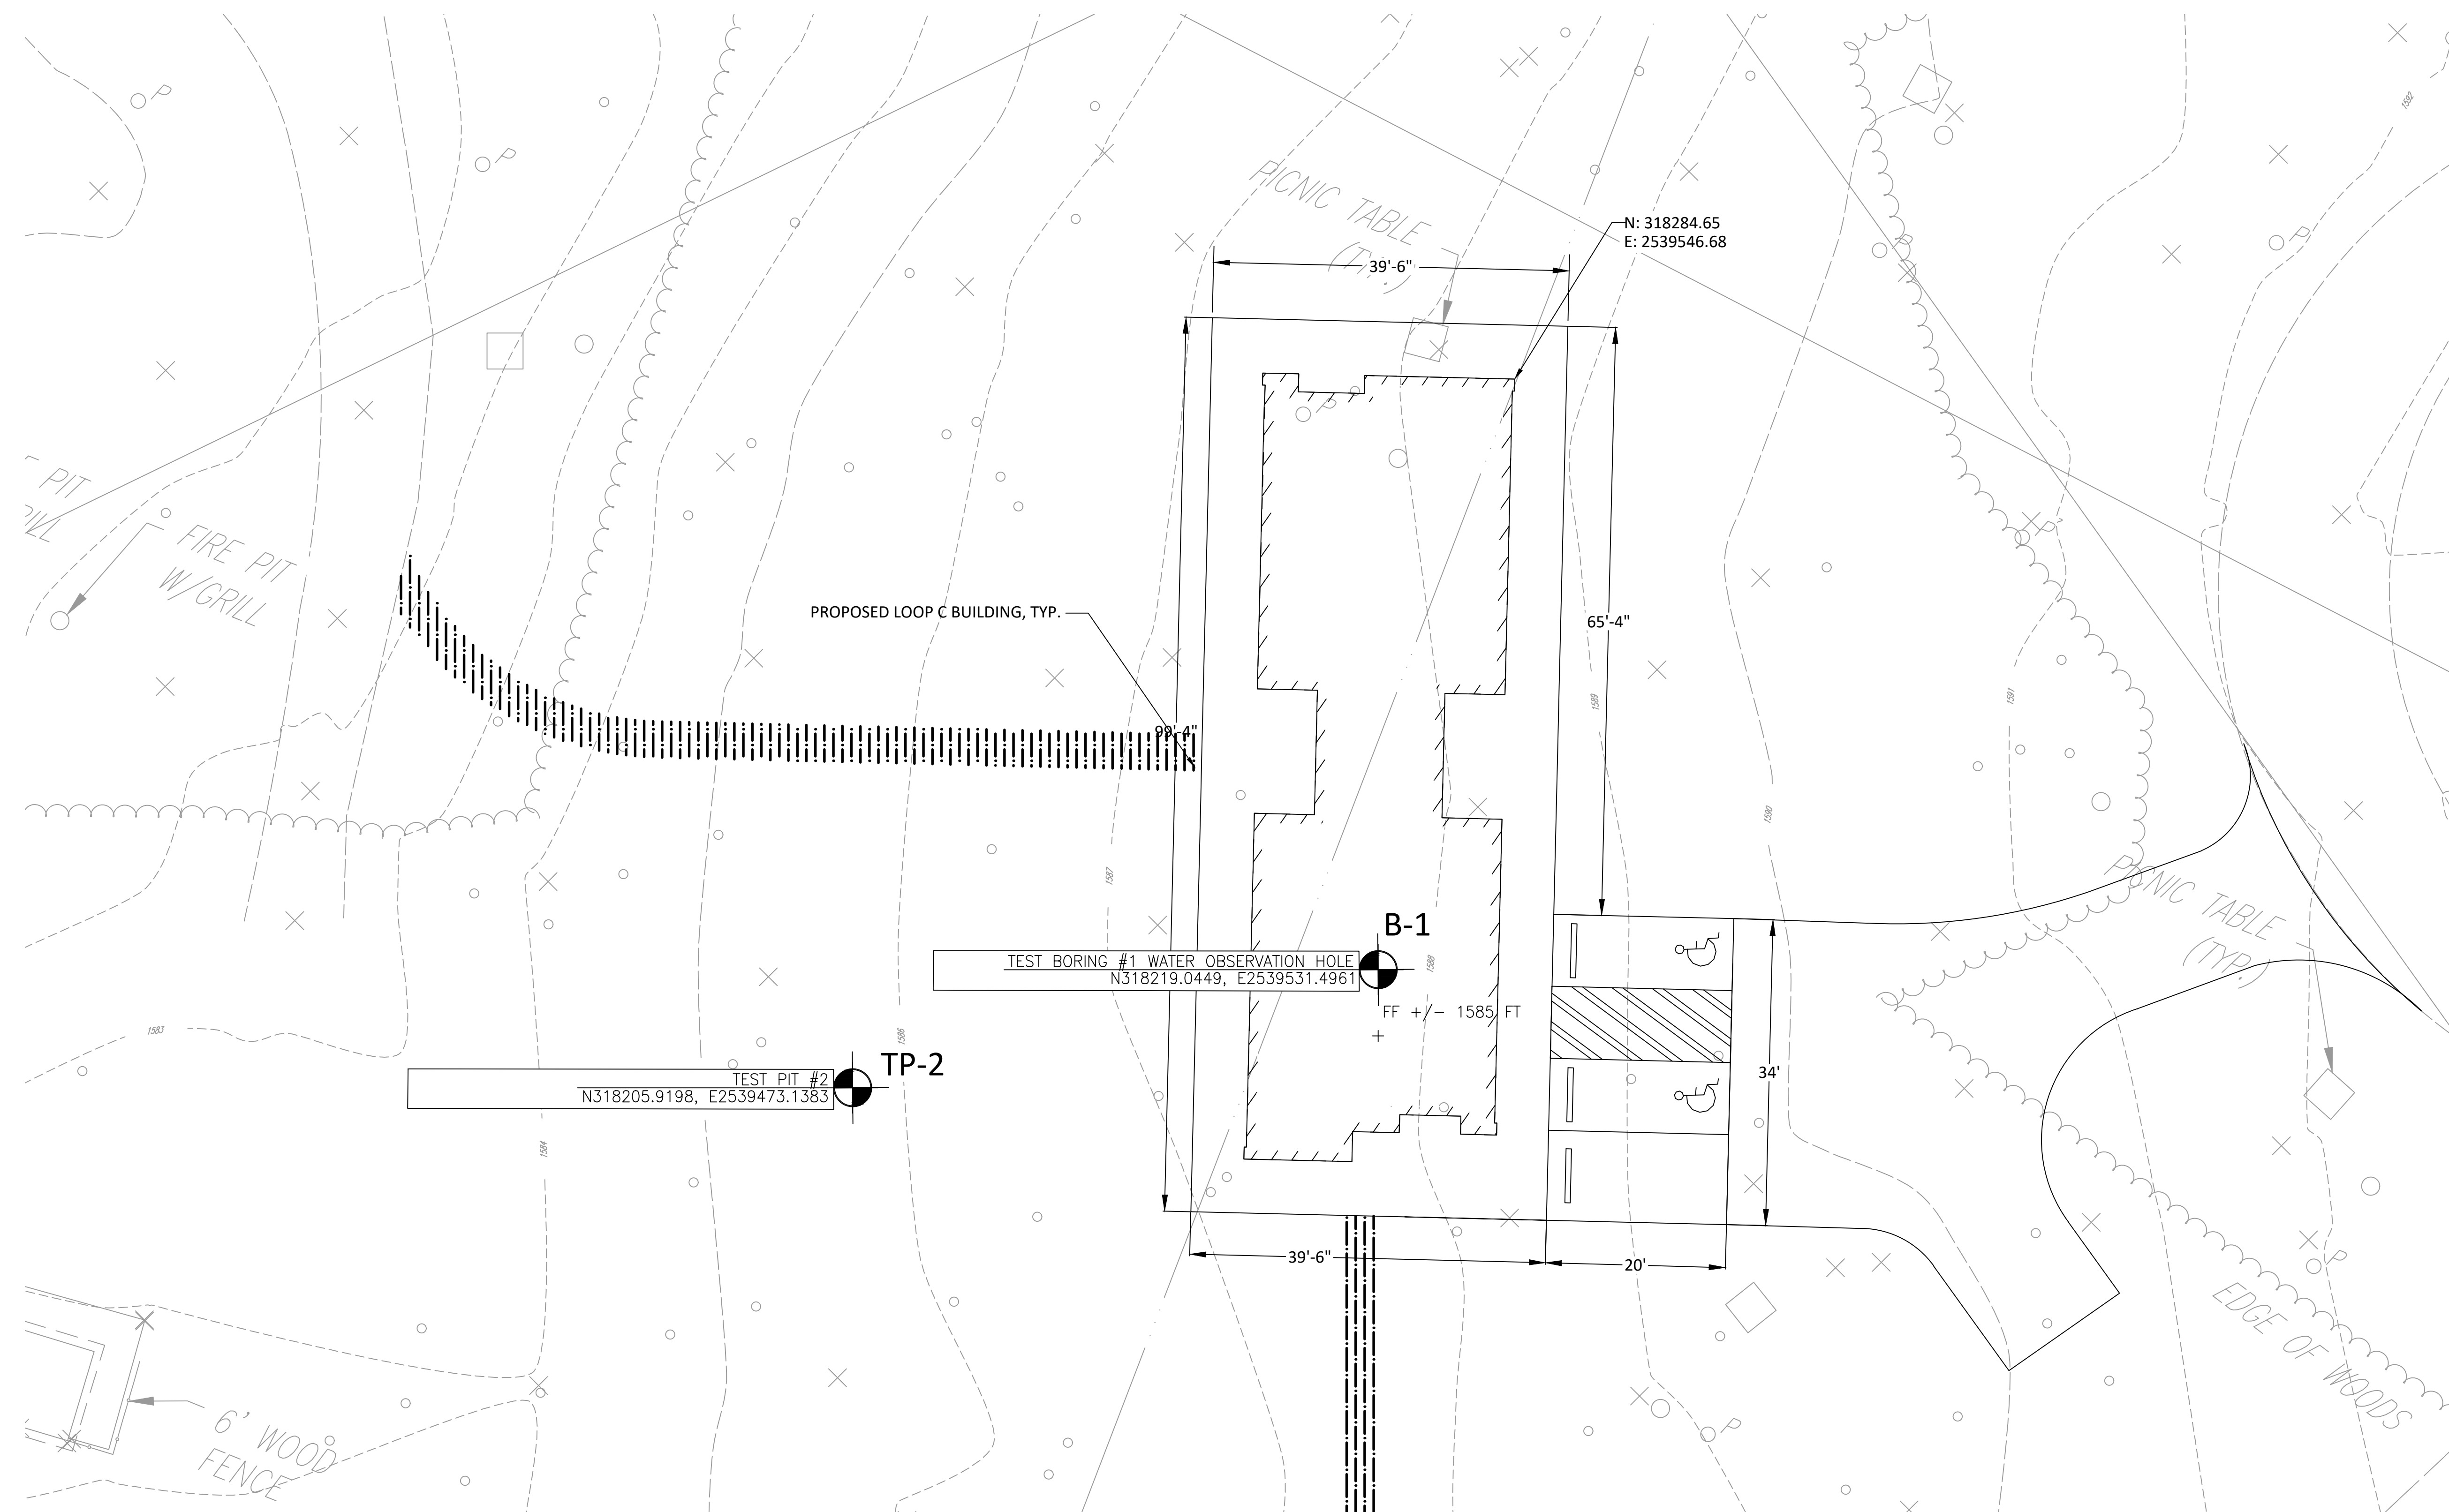

- NOTES:
1. ALL TEST BORINGS SHALL BE CARRIED TO THE DEPTHS LISTED IN THE SCHEDULE, EXCEPT WHERE ROCK IS ENCOUNTERED PRIOR THERETO, IN WHICH CASE, CORING SHALL EXTEND (5) FEET INTO THE ROCK, WHETHER OR NOT THE FINAL DEPTH IS MORE OR LESS THAN THE DEPTH LISTED IN THE SCHEDULE, EXCEPT THAT CERTAIN BORINGS SHALL BE CARRIED TO THE CONTRACT DEPTH REGARDLESS OF THE MATERIALS ENCOUNTERED.
 2. ALL INFILTRATION TESTS SHALL BE DOUBLE-RING INFILTRMETER TESTS AND PERFORMED TO THE DEPTHS SPECIFIED IN THE SCHEDULE. TESTING REQUIREMENTS SHALL FOLLOW PA STORMWATER BMP MANUAL AND KIDDER TOWNSHIP CODE CHAPTER 148.

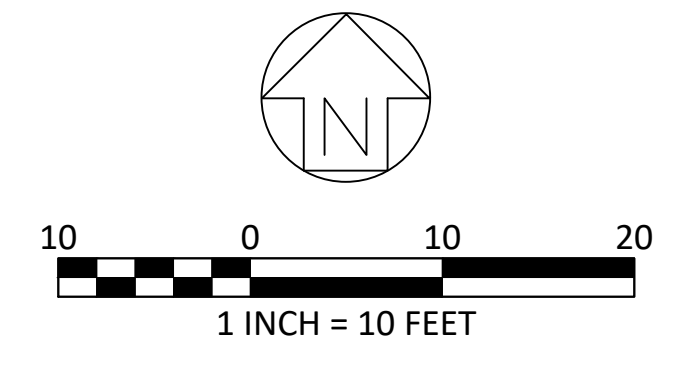

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PHILADELPHIA, PENNSYLVANIA

COMMONWEALTH OF PENNSYLVANIA
DEPARTMENT OF GENERAL SERVICES
HARRISBURG, PENNSYLVANIA

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C-114-0006 PHASE 1

HICKORY RUN STATE PARK
LATRINE IMPROVEMENTS
DEPT of CONSERVATION AND NATURAL RESOURCES
WHITE HAVEN, CARBON COUNTY, PA

TEST BORING LOCATION PLAN AND SCHEDULE - SHEET 2

VERIFY SCALE

BAR IS ONE (1) INCH LONG ON ORIGINAL DRAWING:

0 1

IF BAR IS NOT ONE (1) INCH LONG, ADJUST SCALE ACCORDINGLY

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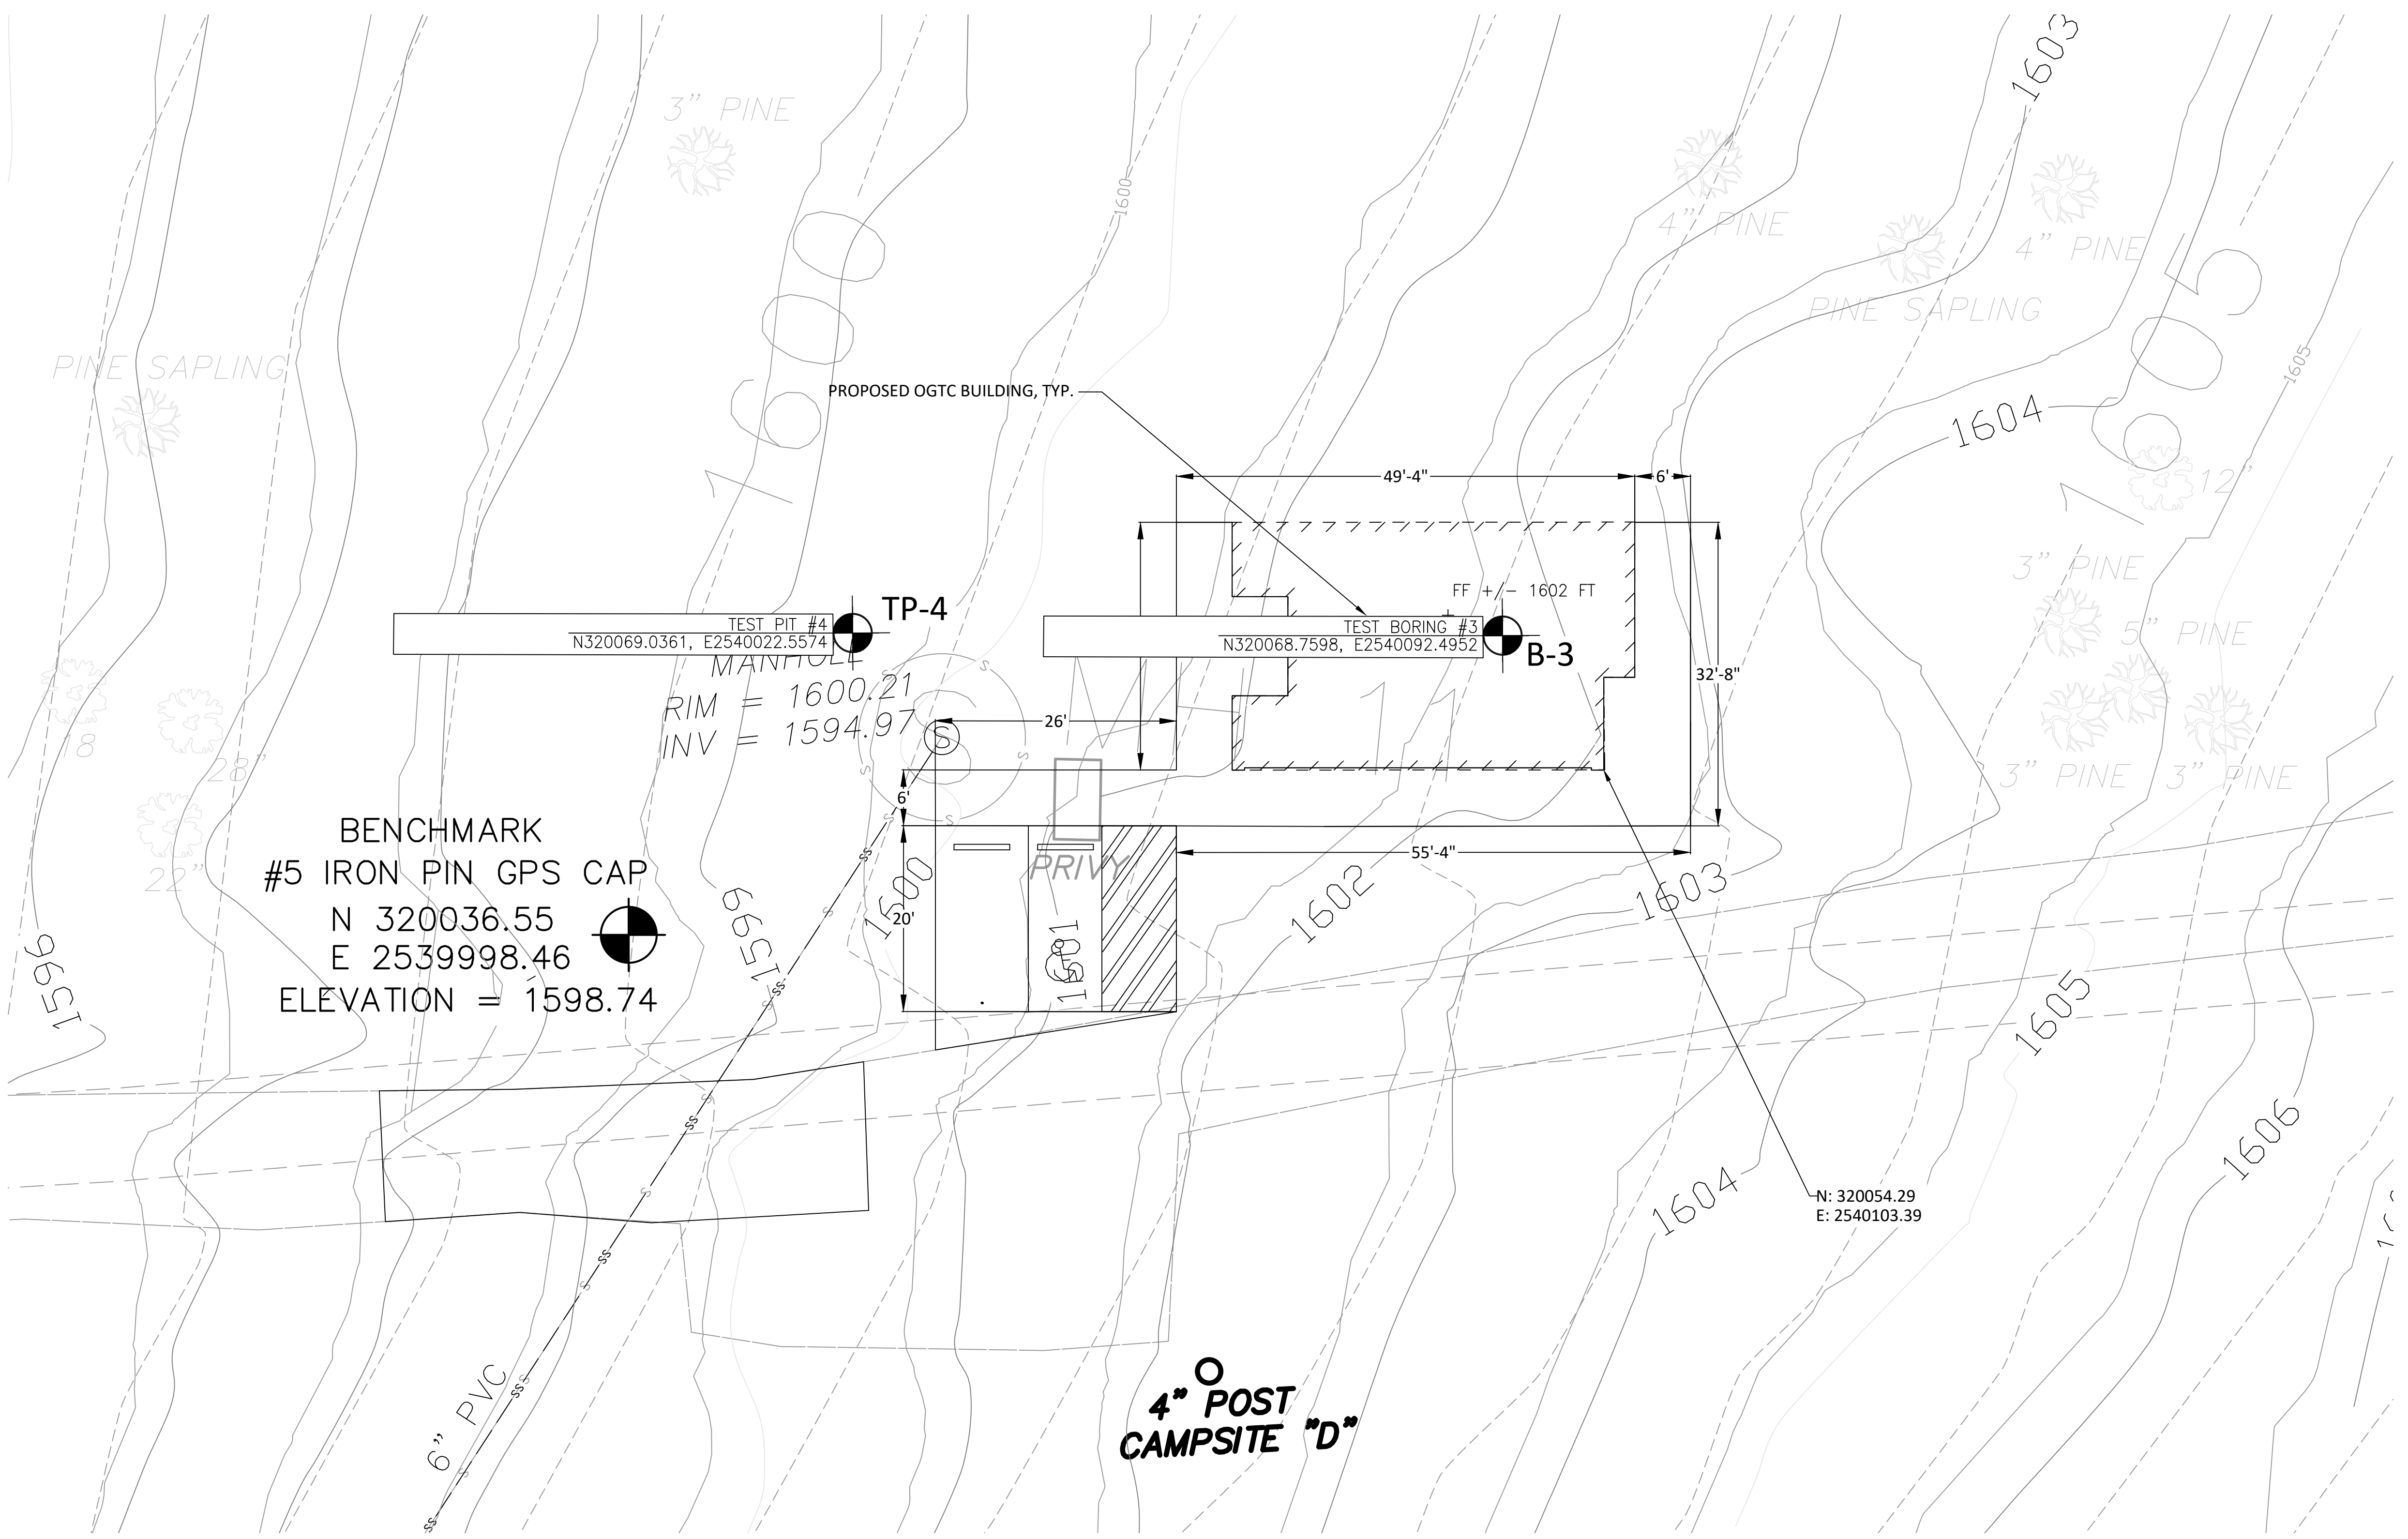
DRAWN BY M DIMONTE	DATE 06/07/2022	DRAWING No. TB-1
CHECKED BY J ADAMS	SCALE AS NOTED	

TEST NUMBER	TEST	TEST SCHEDULE	CONTRACT DEPTHS	ACTUAL DEPTHS
1*	STANDARD BORING	SURFACE ELEVATION	25.00 Ft	
2*	INFILTRATION		5.00 Ft	


*NOTE: BORINGS 1 AND 2 MAY MOVE TO A NEARBY LOCATION. FINAL LOCATIONS WILL BE GIVEN PRIOR TO DRILLING.

TB-1 GEOTECHNICAL TESTING PLAN
LOOP C 1' = 20'

FILE PATH: I:\2020\09077 - Hickory Run State Park\CAD Sheets\Plan\2022 - GEOTECHNICAL TESTING PLAN.dwg
LAST SAVED: 2022.06.17 10:09 AM PLOTTED BY: James Adams



- NOTES:
- ALL TEST BORINGS SHALL BE CARRIED TO THE DEPTHS LISTED IN THE SCHEDULE, EXCEPT WHERE ROCK IS ENCOUNTERED PRIOR THERETO, IN WHICH CASE, CORING SHALL EXTEND (5) FEET INTO THE ROCK, WHETHER OR NOT THE FINAL DEPTH IS MORE OR LESS THAN THE DEPTH LISTED IN THE SCHEDULE, EXCEPT THAT CERTAIN BORINGS SHALL BE CARRIED TO THE CONTRACT DEPTH REGARDLESS OF THE MATERIALS ENCOUNTERED.
 - ALL INFILTRATION TESTS SHALL BE DOUBLE-RING INFILTRMETER TESTS AND PERFORMED TO THE DEPTHS SPECIFIED IN THE SCHEDULE. TESTING REQUIREMENTS SHALL FOLLOW PA STORMWATER BMP MANUAL AND KIDDER TOWNSHIP CODE CHAPTER 148.

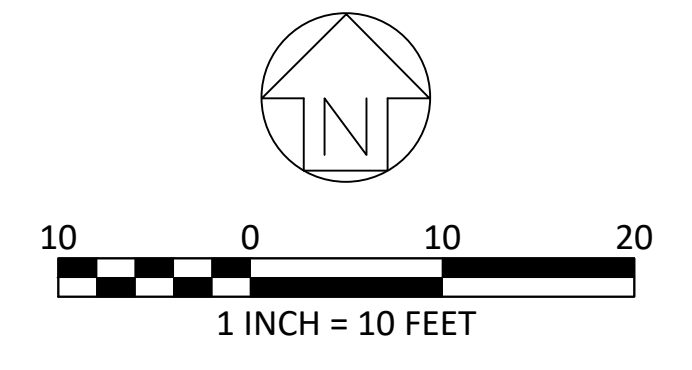

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D.G.S. PROJECT No.
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HICKORY RUN STATE PARK
LATRINE IMPROVEMENTS
DEPT of CONSERVATION AND NATURAL RESOURCES
WHITE HAVEN, CARBON COUNTY, PA

TEST BORING LOCATION PLAN AND SCHEDULE - SHEET 3

CONTRACTOR SHALL FIELD VERIFY ALL DIMENSIONS. VARIANCE FROM CONTRACT DOCUMENTS NOT PERMITTED WITHOUT PROFESSIONAL & BUREAU OF CONSTRUCTION APPROVAL.

DRAWN BY: **M DIMONTE** DATE: **06/07/2022**

CHECKED BY: **J ADAMS** SCALE: **AS NOTED**


DRAWING No.
TB-2

8 OF 144


TEST NUMBER	TEST	TEST SCHEDULE	CONTRACT DEPTHS	ACTUAL DEPTHS
3	STANDARD BORING	SURFACE ELEVATION	25.00 Ft	
4	INFILTRATION		5.00 Ft	

2 TB-0 TB-2 GEOTECHNICAL TESTING PLAN 1'=20'

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LAST SAVED: 2022.06.17 10:53 AM PLOTTED BY: James Adams

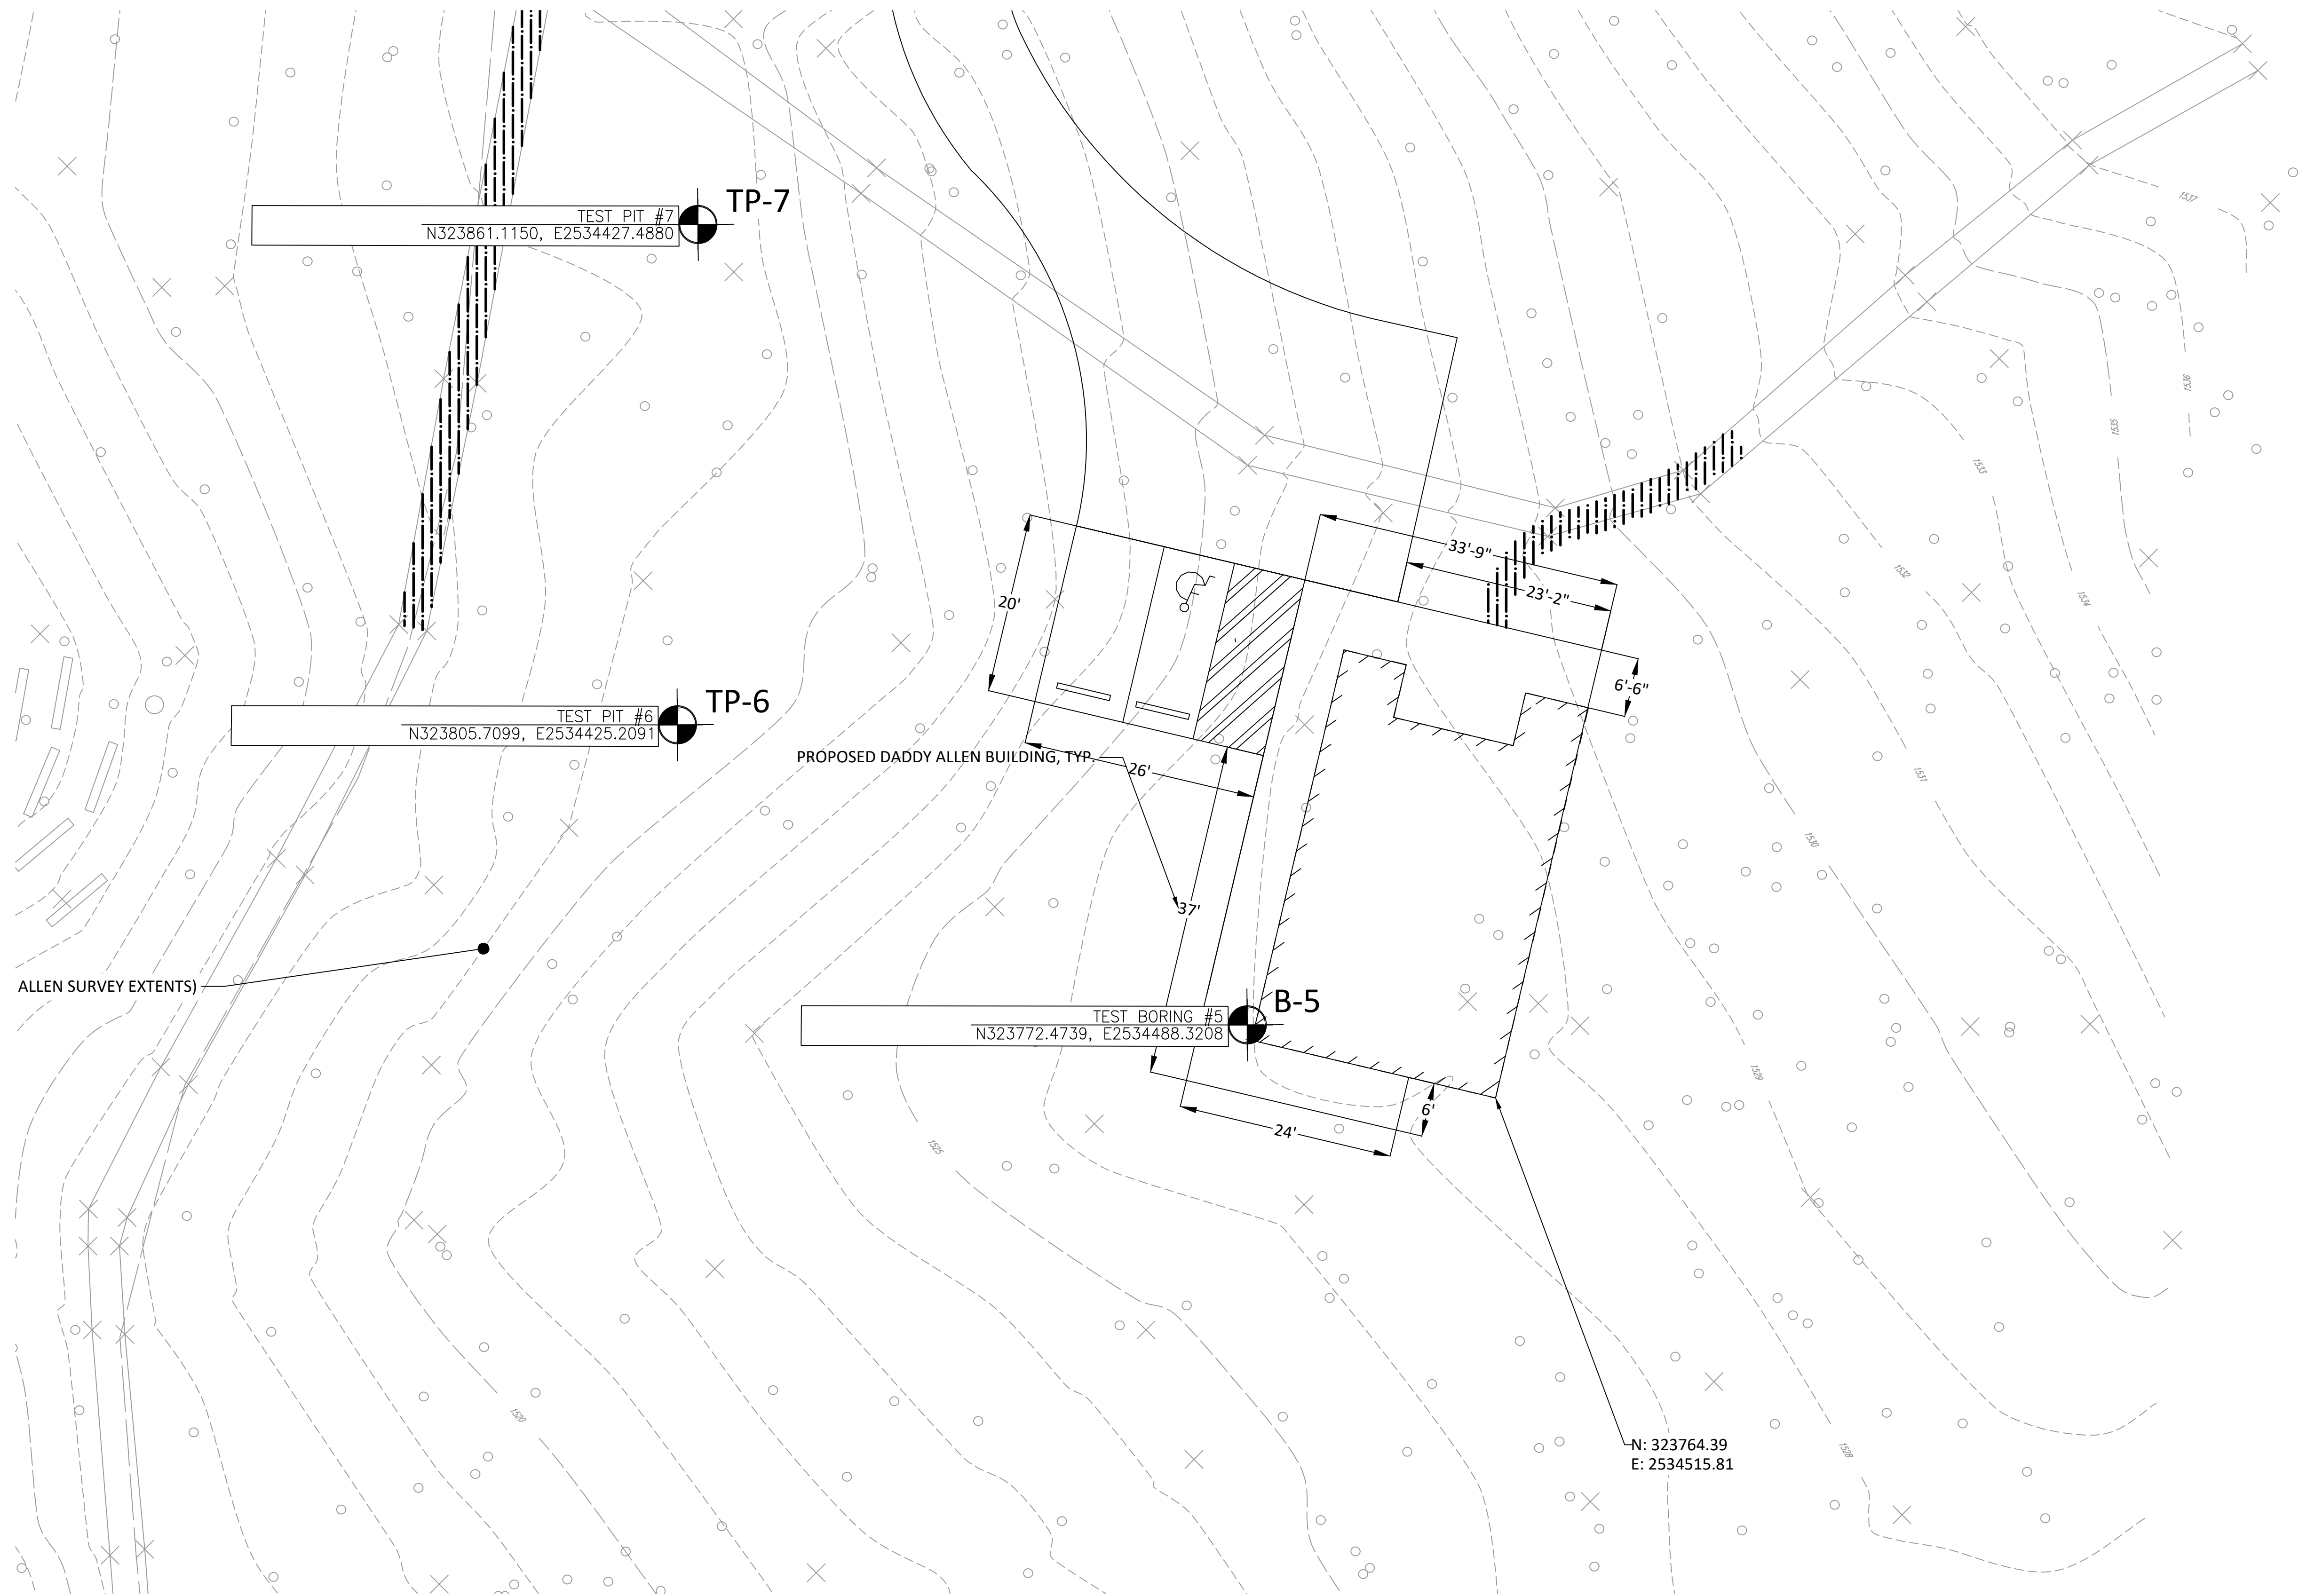

- NOTES:
- ALL TEST BORINGS SHALL BE CARRIED TO THE DEPTHS LISTED IN THE SCHEDULE, EXCEPT WHERE ROCK IS ENCOUNTERED PRIOR THERETO, IN WHICH CASE, CORING SHALL EXTEND (5) FEET INTO THE ROCK, WHETHER OR NOT THE FINAL DEPTH IS MORE OR LESS THAN THE DEPTH LISTED IN THE SCHEDULE, EXCEPT THAT CERTAIN BORINGS SHALL BE CARRIED TO THE CONTRACT DEPTH REGARDLESS OF THE MATERIALS ENCOUNTERED.
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WHITE HAVEN, CARBON COUNTY, PA

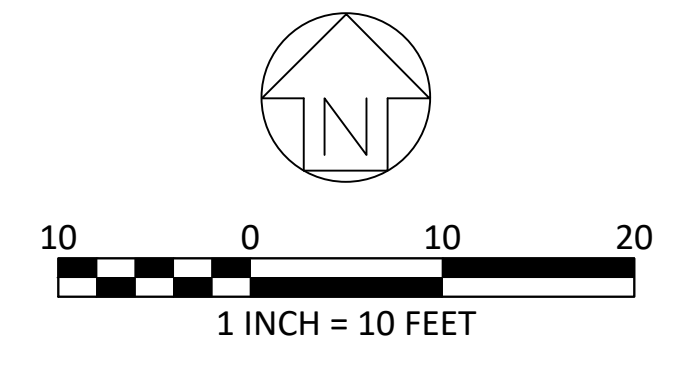TEST BORING LOCATION PLAN AND SCHEDULE - SHEET 4

VERIFY SCALE

BAR IS ONE (1) INCH LONG ON ORIGINAL DRAWING:
0 1

IF BAR IS NOT ONE (1) INCH LONG, ADJUST SCALE ACCORDINGLY


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DRAWN BY M DIMONTE	DATE 06/07/2022	DRAWING No. TB-3
CHECKED BY J ADAMS	SCALE AS NOTED	9 OF 144

TEST NUMBER	TEST	TEST SCHEDULE	SURFACE ELEVATION	CONTRACT DEPTHS	ACTUAL DEPTHS
5	STANDARD BORING			25.00 Ft	
6	INFILTRATION			5.00 Ft	
7	INFILTRATION			5.00 Ft	

TB-3 GEOTECHNICAL TESTING PLAN
DADDY ALLEN 1"=20'

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- NOTES:
- ALL TEST BORINGS SHALL BE CARRIED TO THE DEPTHS LISTED IN THE SCHEDULE, EXCEPT WHERE ROCK IS ENCOUNTERED PRIOR THERETO, IN WHICH CASE, CORING SHALL EXTEND (5) FEET INTO THE ROCK, WHETHER OR NOT THE FINAL DEPTH IS MORE OR LESS THAN THE DEPTH LISTED IN THE SCHEDULE, EXCEPT THAT CERTAIN BORINGS SHALL BE CARRIED TO THE CONTRACT DEPTH REGARDLESS OF THE MATERIALS ENCOUNTERED.
 - ALL INFILTRATION TESTS SHALL BE DOUBLE-RING INFILTROMETER TESTS AND PERFORMED TO THE DEPTHS SPECIFIED IN THE SCHEDULE. TESTING REQUIREMENTS SHALL FOLLOW PA STORMWATER BMP MANUAL AND KIDDER TOWNSHIP CODE CHAPTER 148.

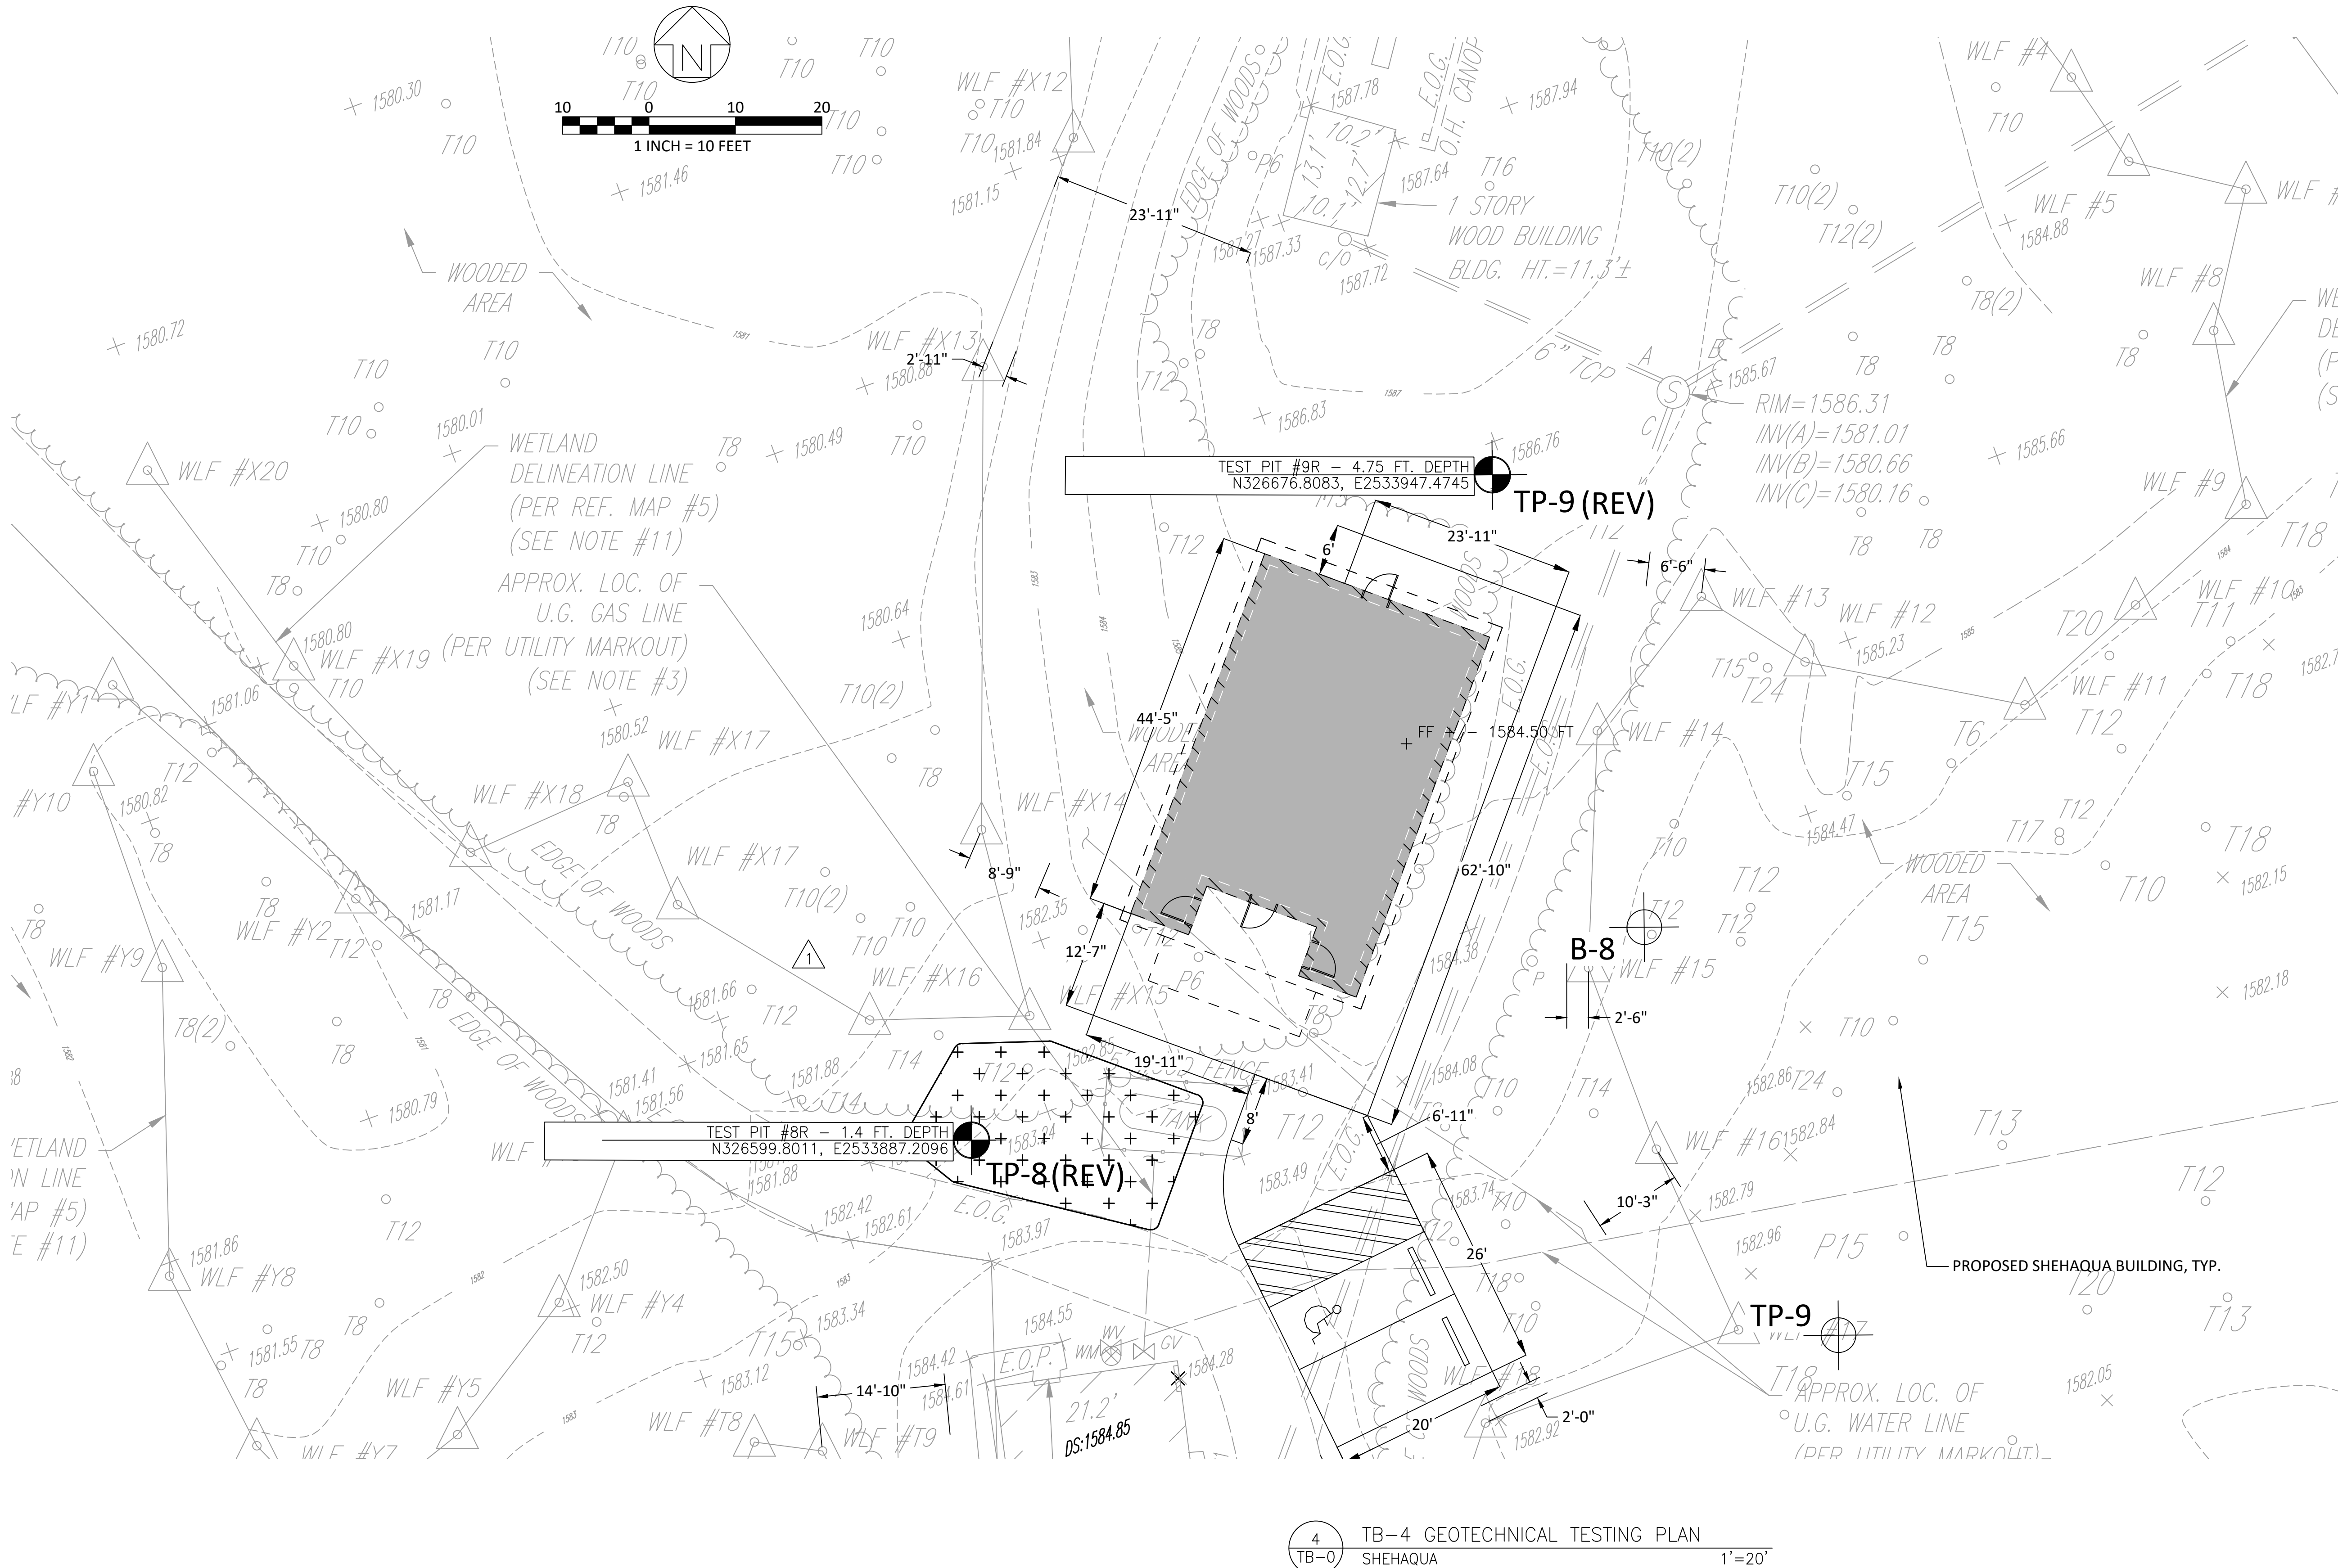

1	ADDED LOCATIONS

RECORD REVISIONS

SEAL

SIGNATURE _____ DATE _____

SMP ARCHITECTS
1600 WALNUT STREET, SECOND FLOOR
PHILADELPHIA, PENNSYLVANIA

COMMONWEALTH OF PENNSYLVANIA
DEPARTMENT OF GENERAL SERVICES
HARRISBURG, PENNSYLVANIA

D.G.S. PROJECT No.
C-114-0006 PHASE 1

HICKORY RUN STATE PARK
LATRINE IMPROVEMENTS
DEPT OF CONSERVATION AND NATURAL RESOURCES
WHITE HAVEN, CARBON COUNTY, PA

VERIFY SCALE

BAR IS ONE (1) INCH LONG ON ORIGINAL DRAWING:








0 1

IF BAR IS NOT ONE (1) INCH LONG, ADJUST SCALE ACCORDINGLY

CONTRACTOR SHALL FIELD VERIFY ALL DIMENSIONS. VARIANCE FROM CONTRACT DOCUMENTS NOT PERMITTED WITHOUT PROFESSIONAL & BUREAU OF CONSTRUCTION APPROVAL.	DRAWN BY M DIMONTE	DATE 06/07/2022	DRAWING No. TB-4
	CHECKED BY M DIMONTE	SCALE AS NOTED	

4 TB-4 GEOTECHNICAL TESTING PLAN
TB-0 SHEHAQUA 1"=20'

FILE PATH: I:\2020\0907 - Hickory Run State Park\CAD Sheets\Final\2022\ TB-4.dwg PLOTTED: 2022.06.17 10:59 AM
 PLOTTED BY: James Adams

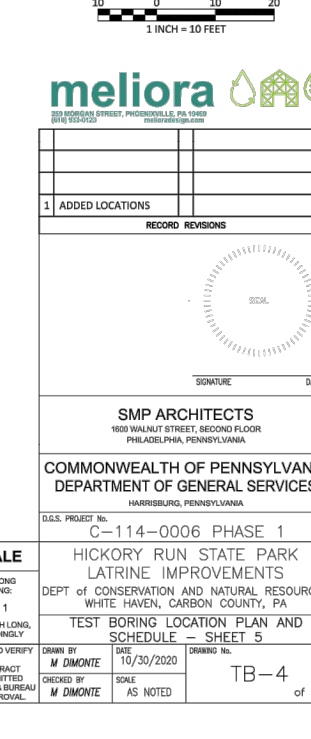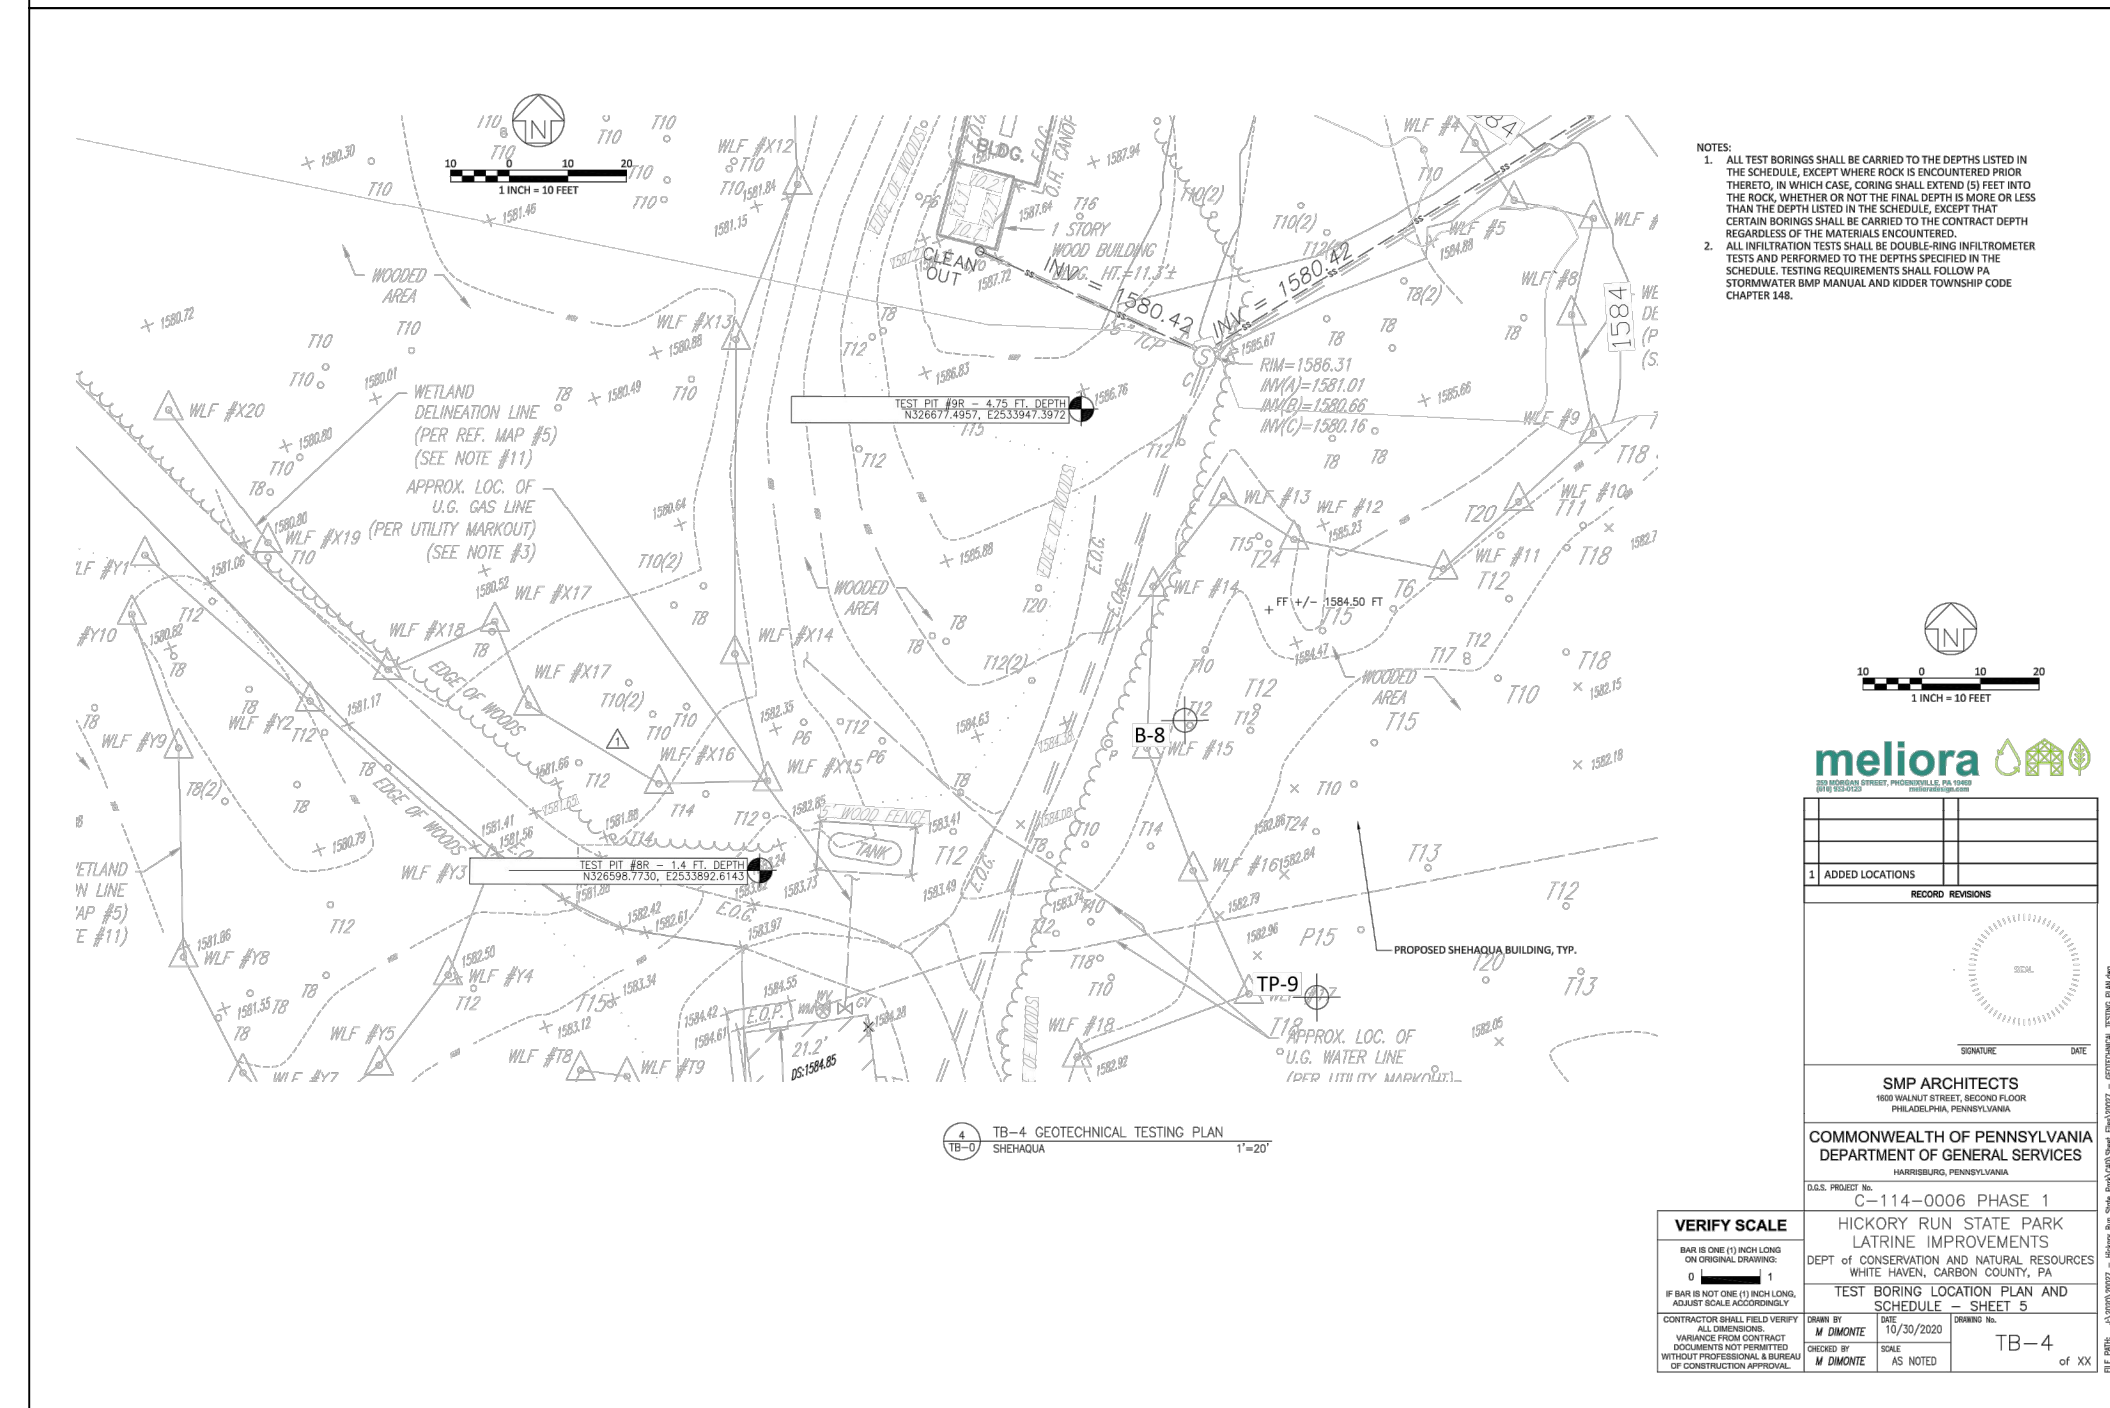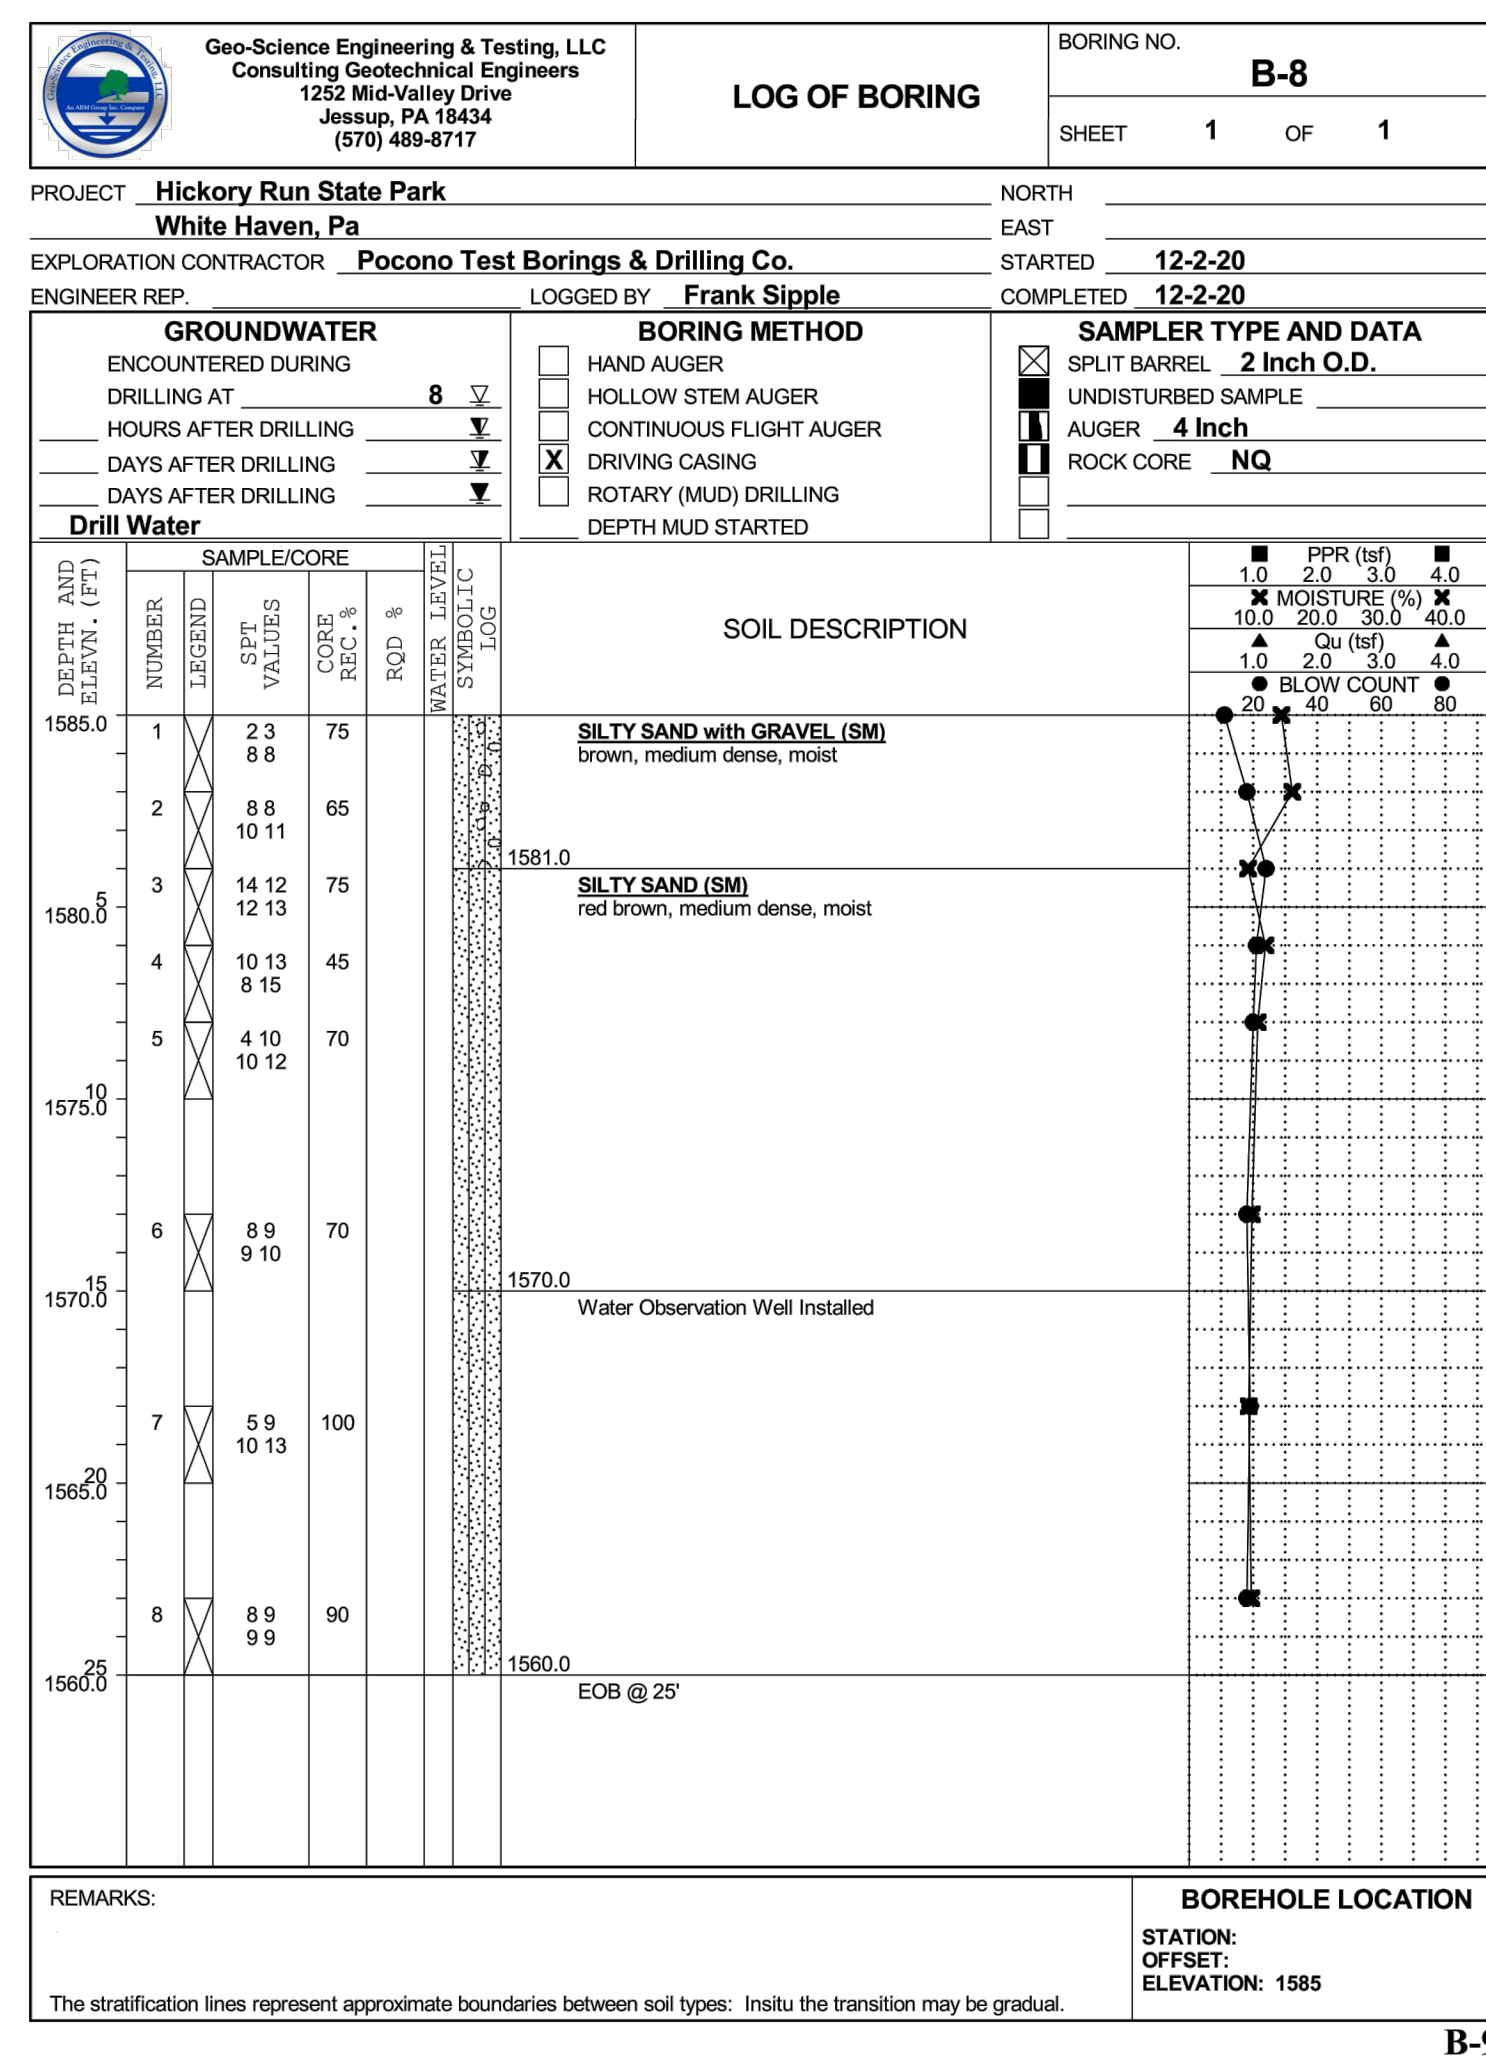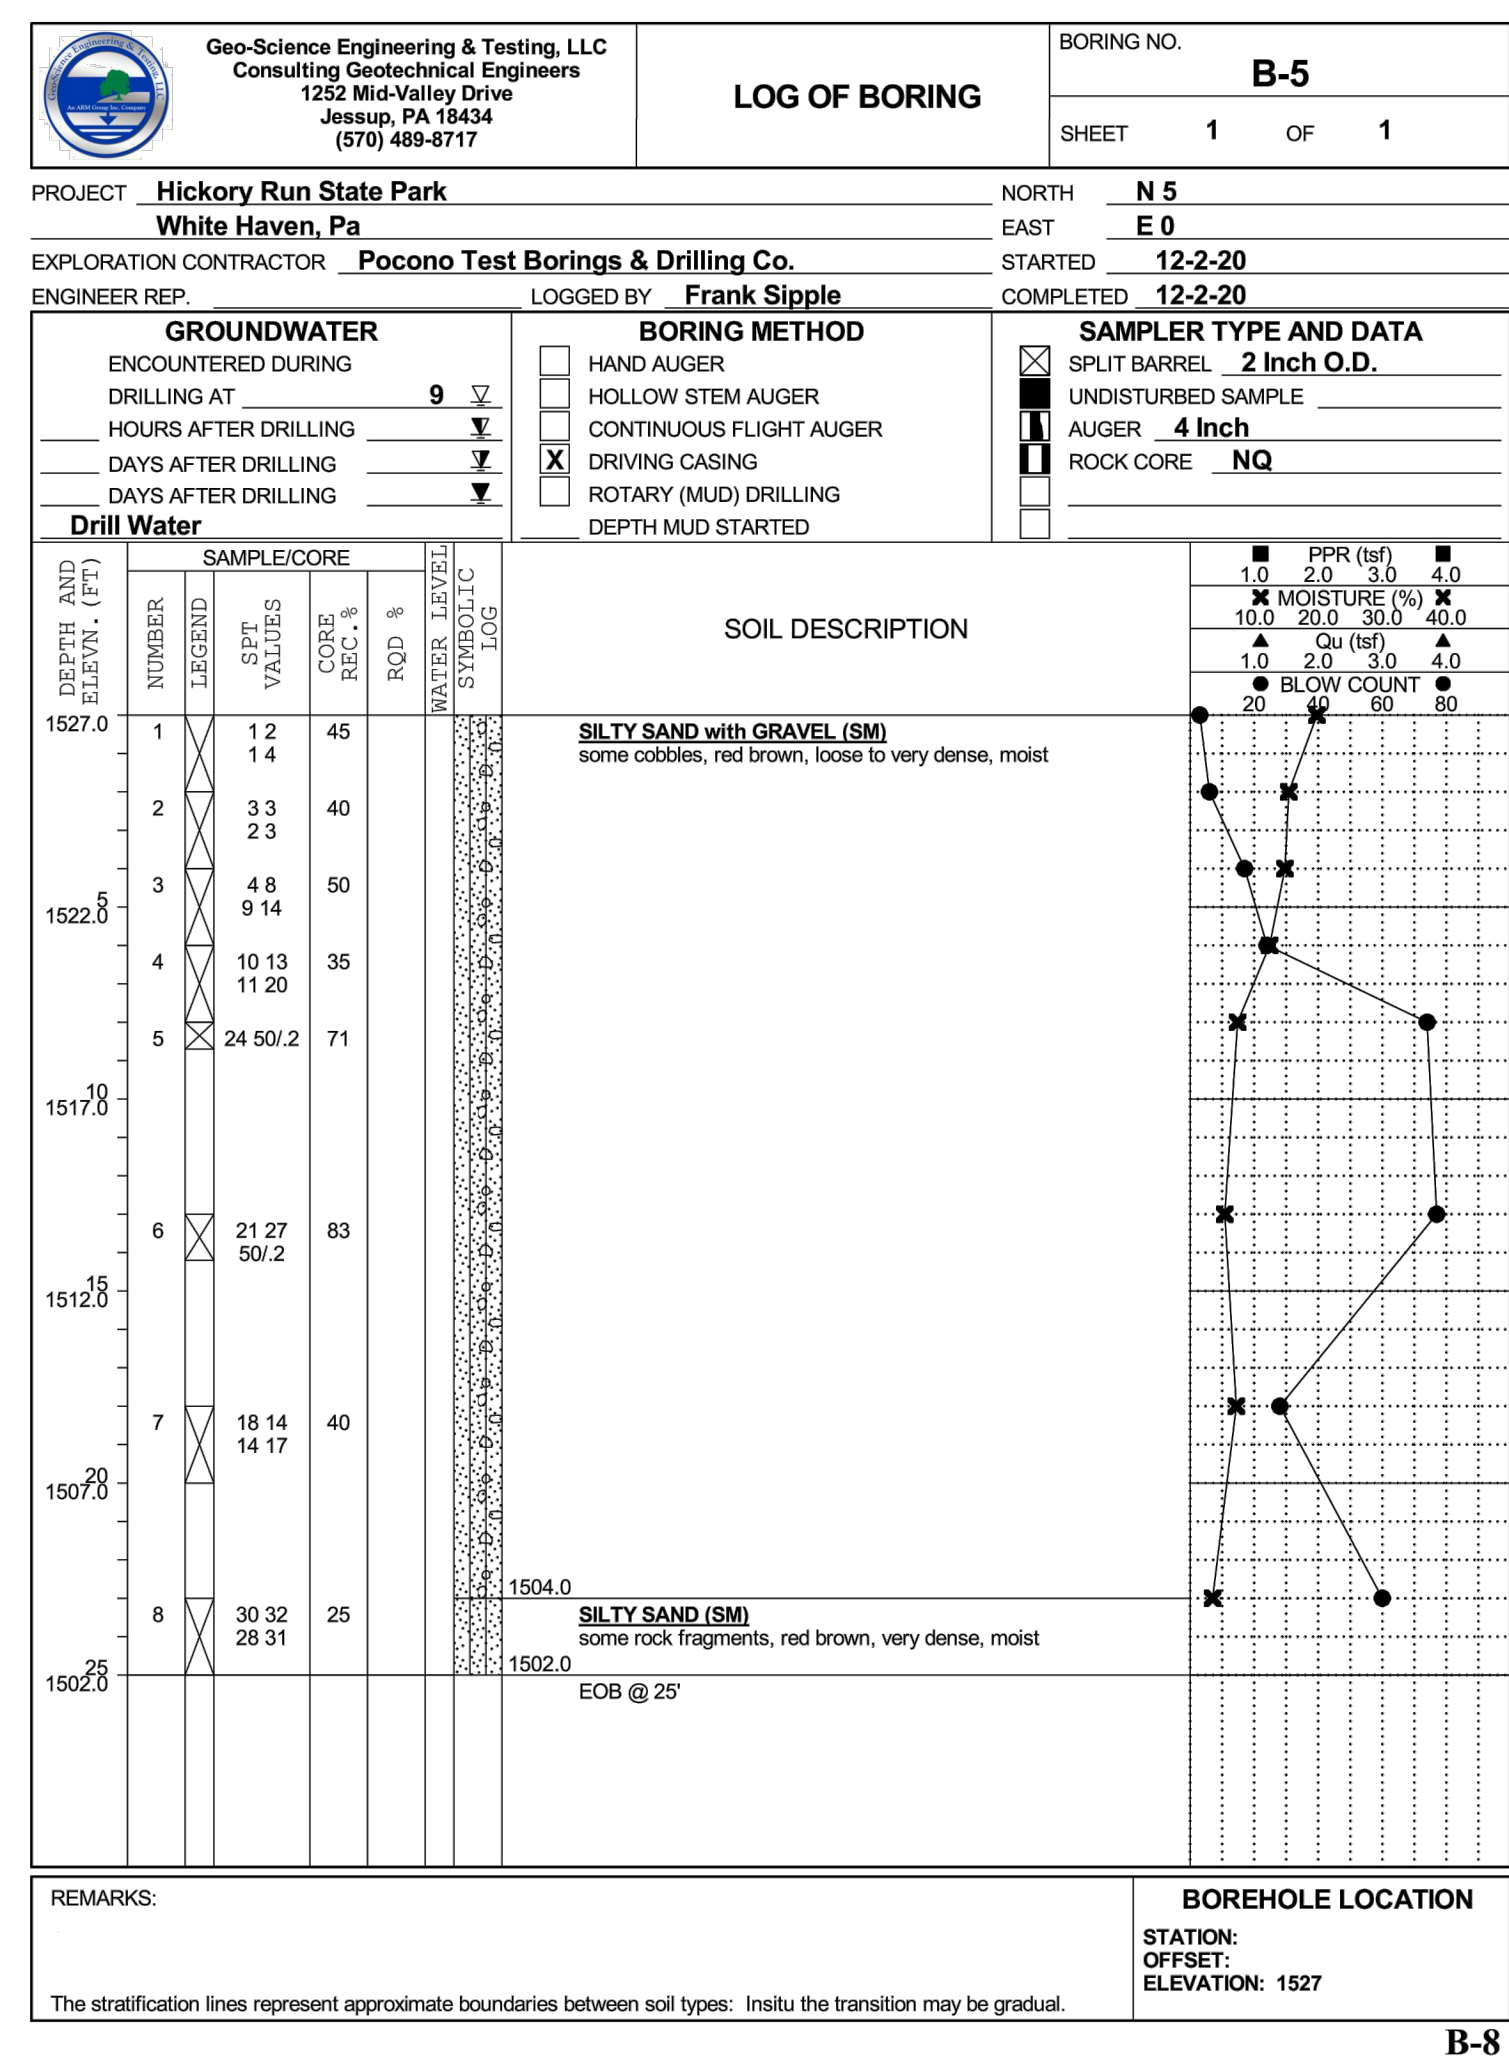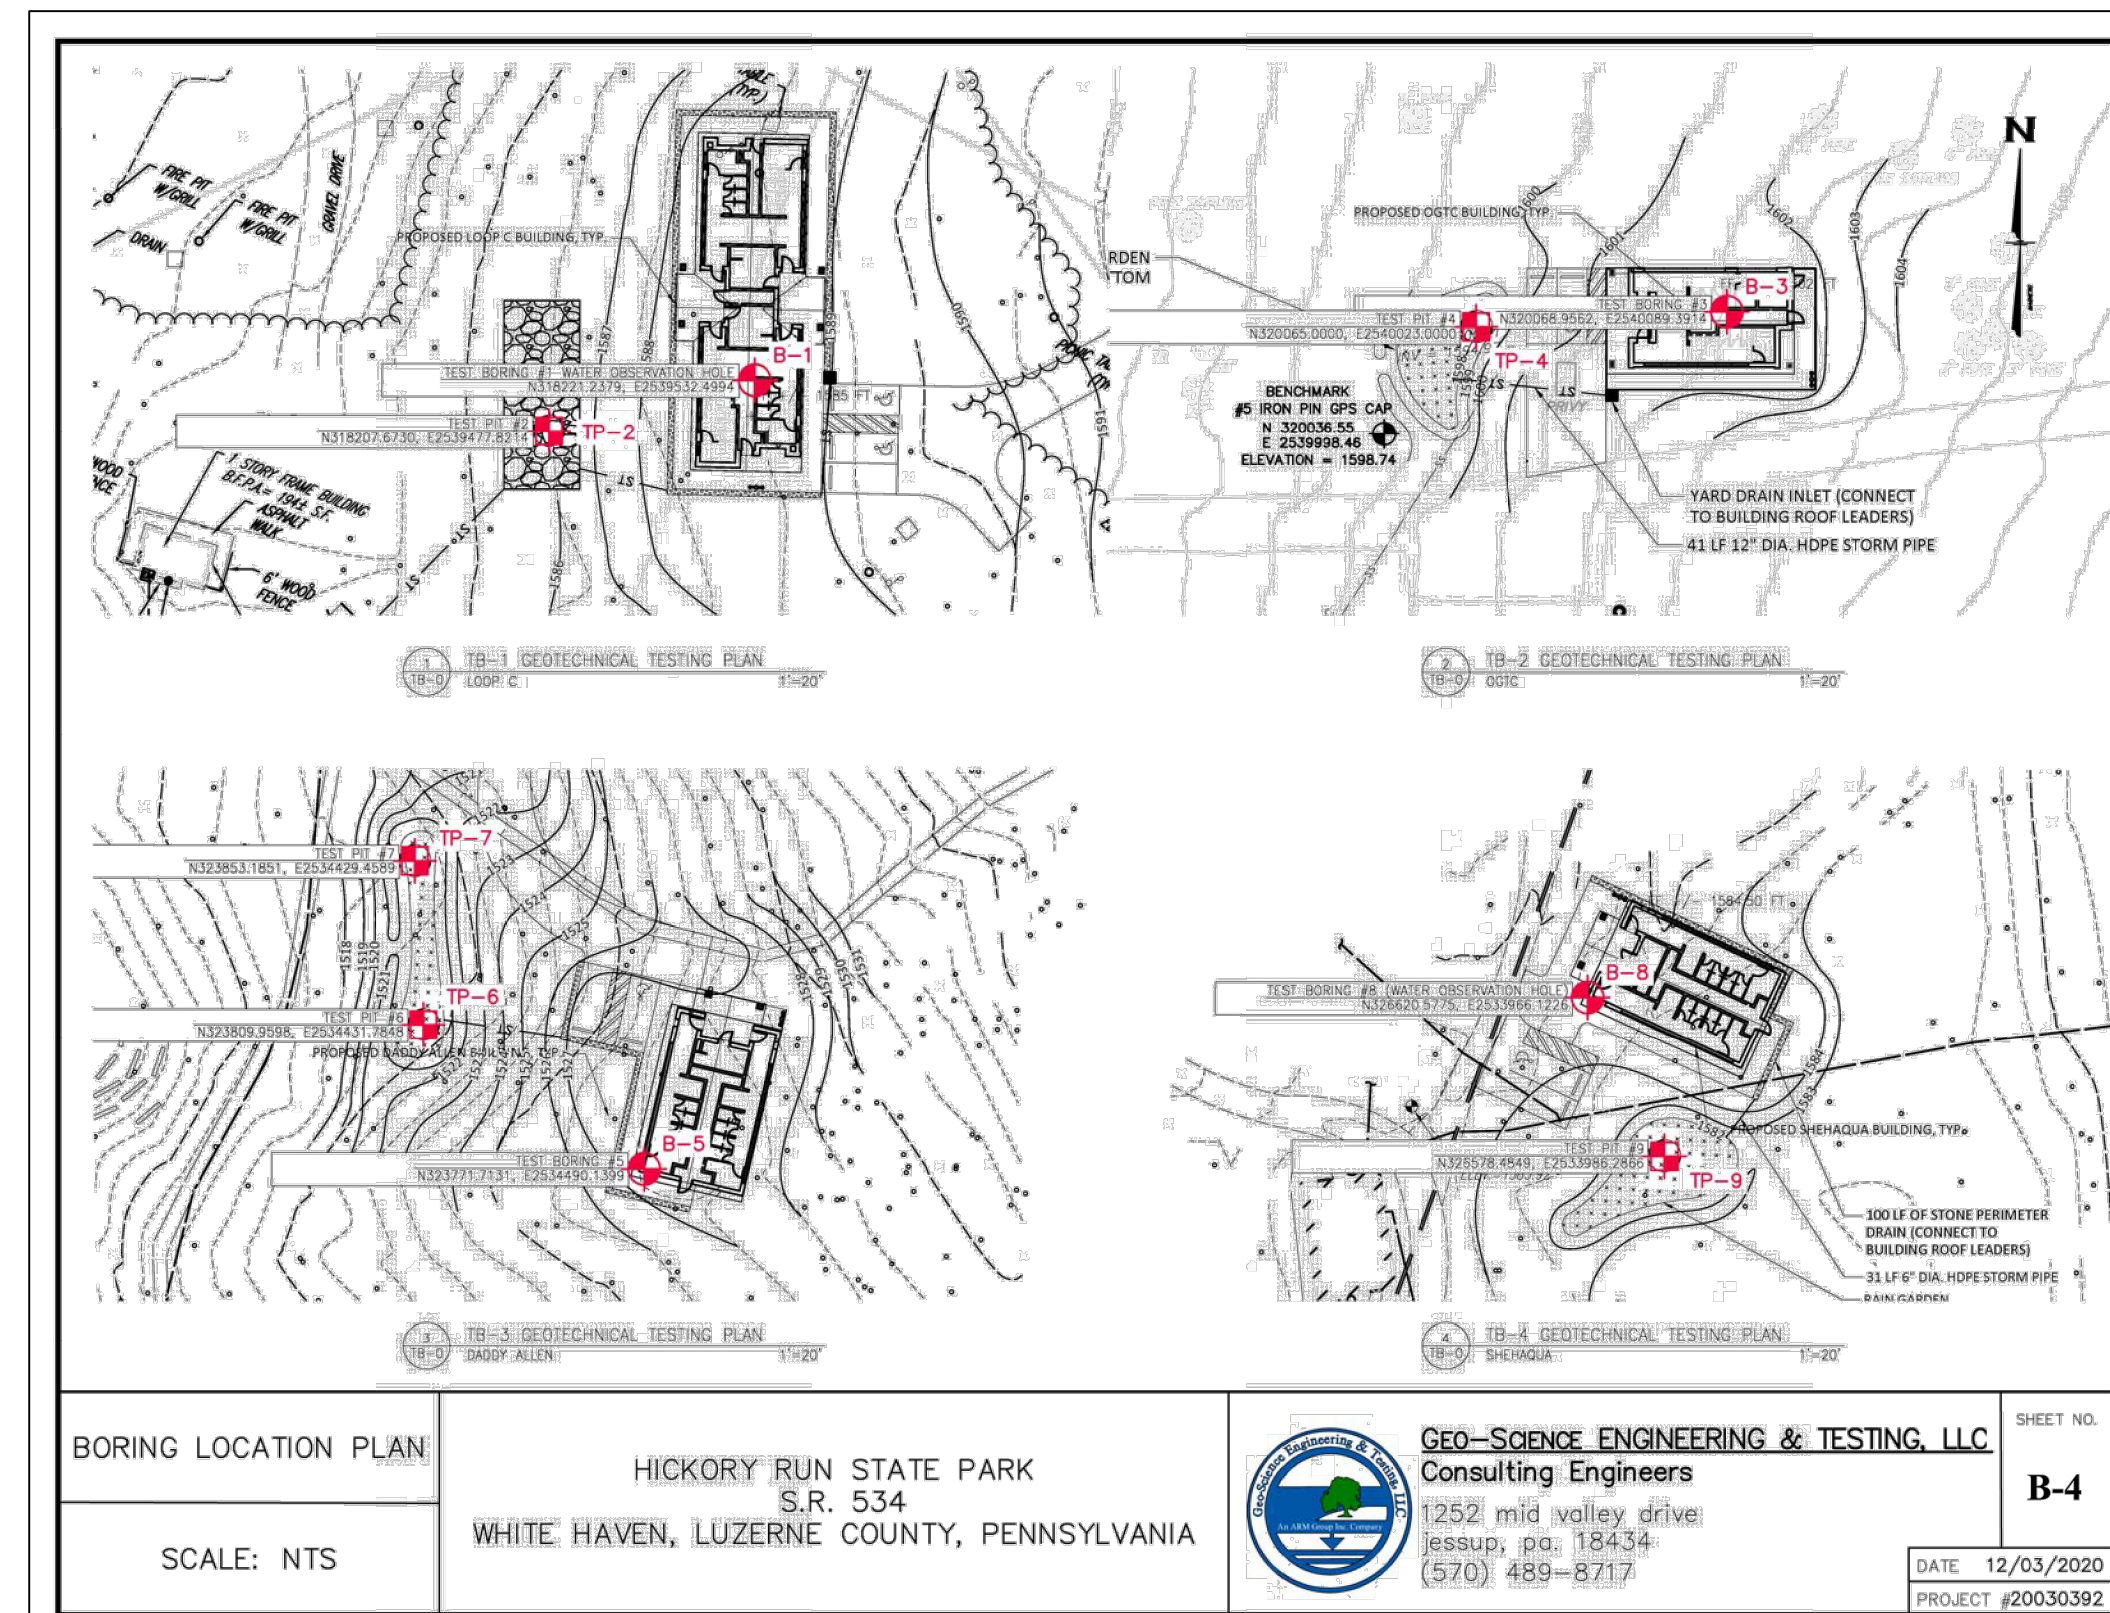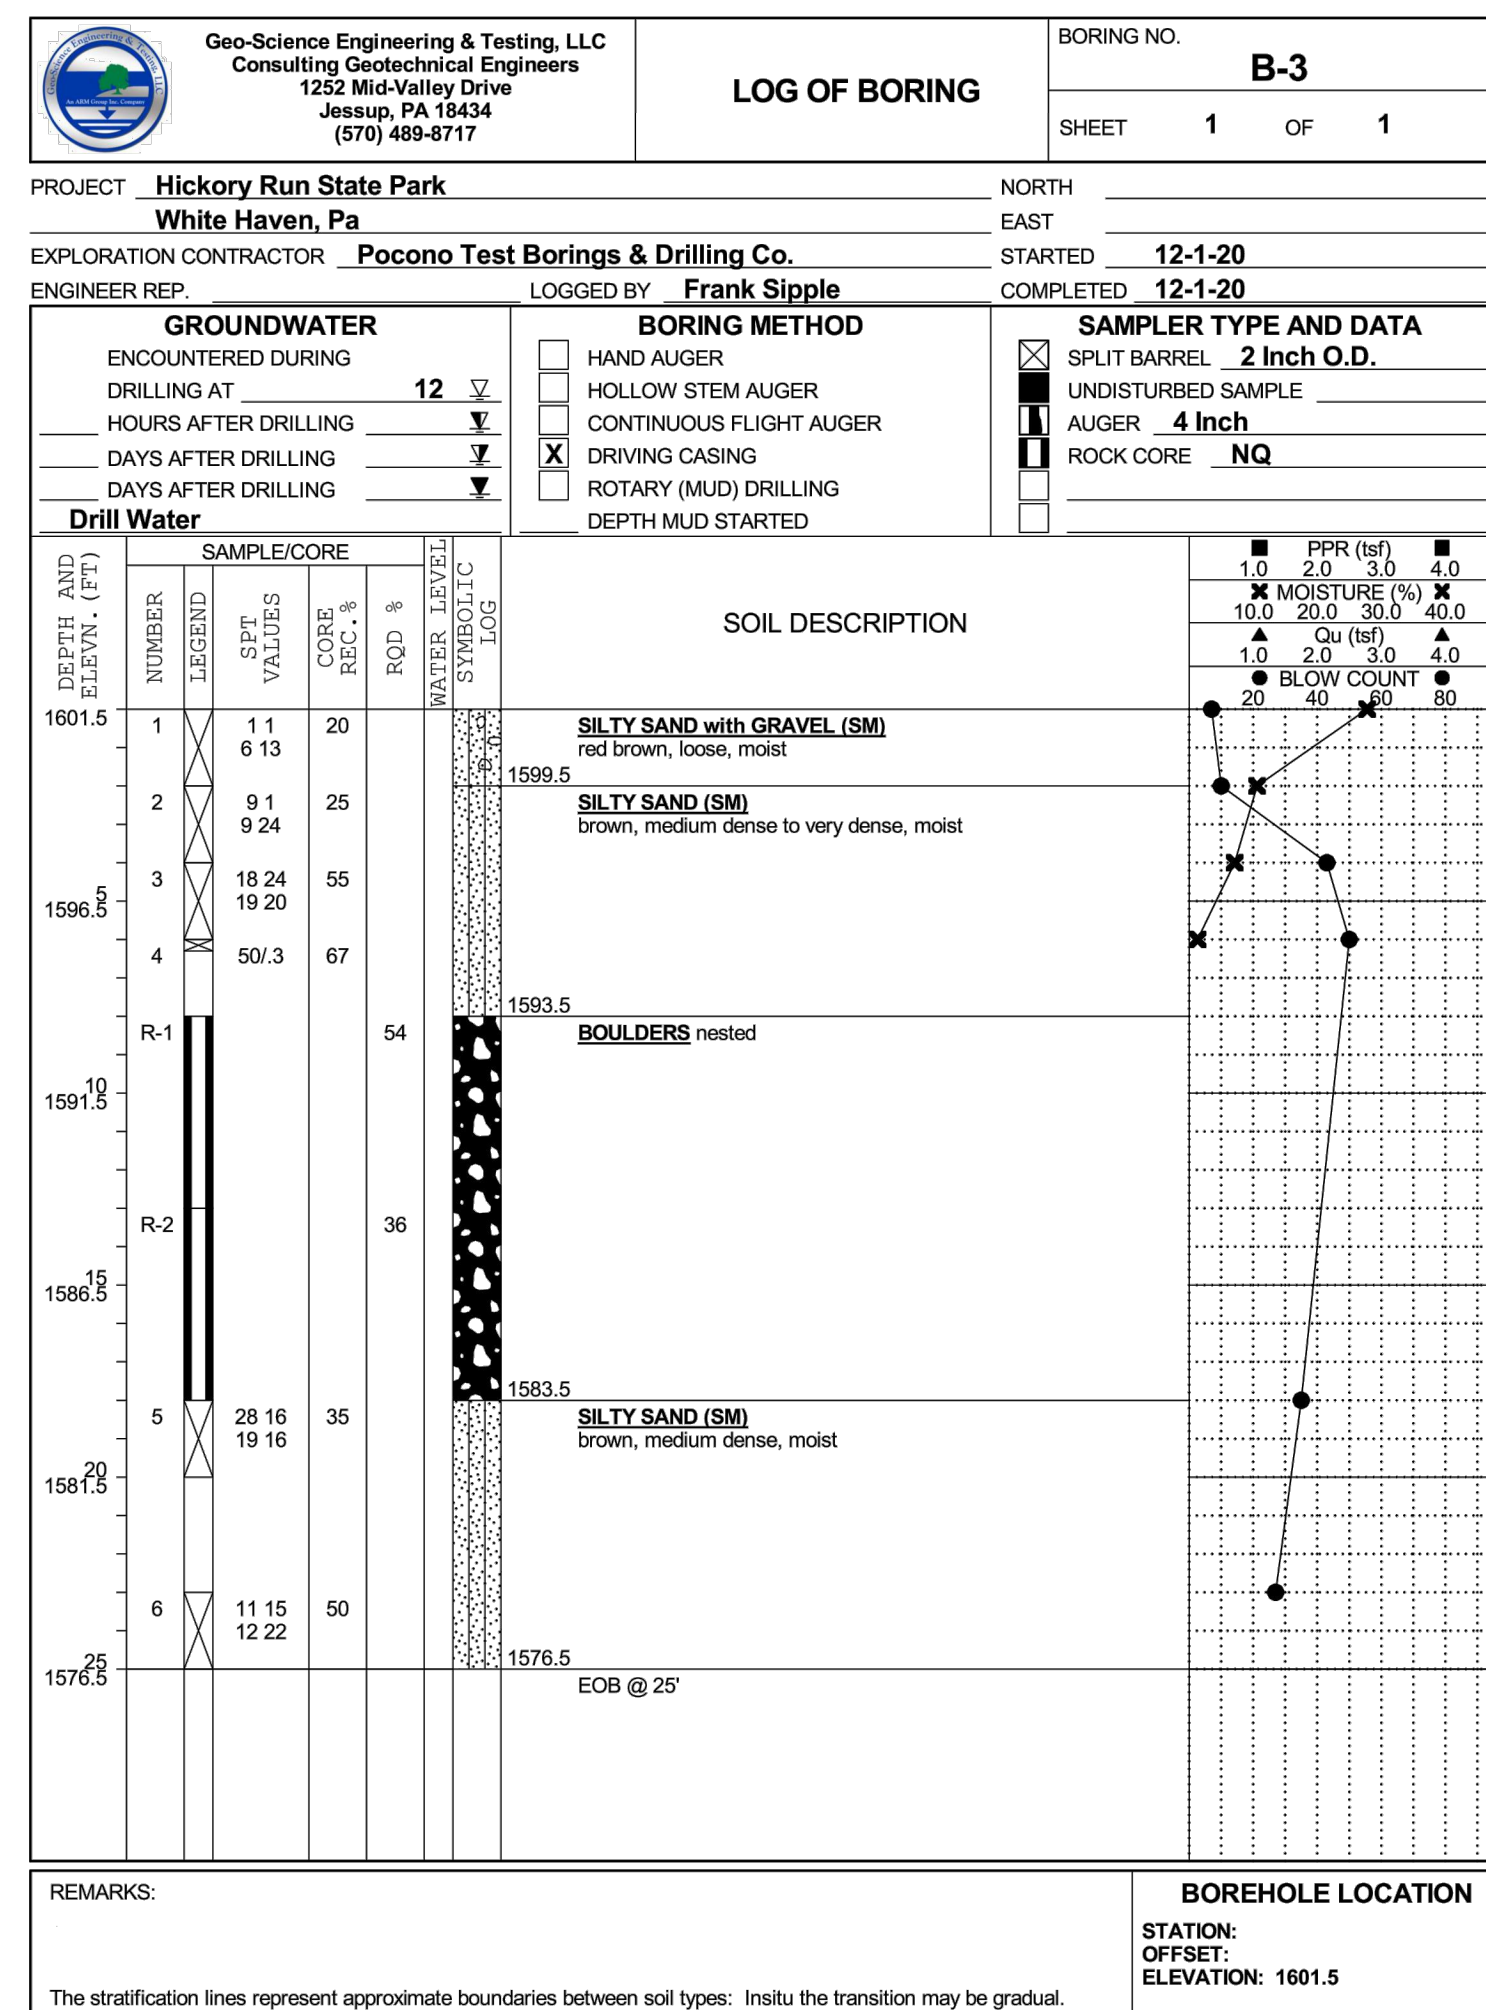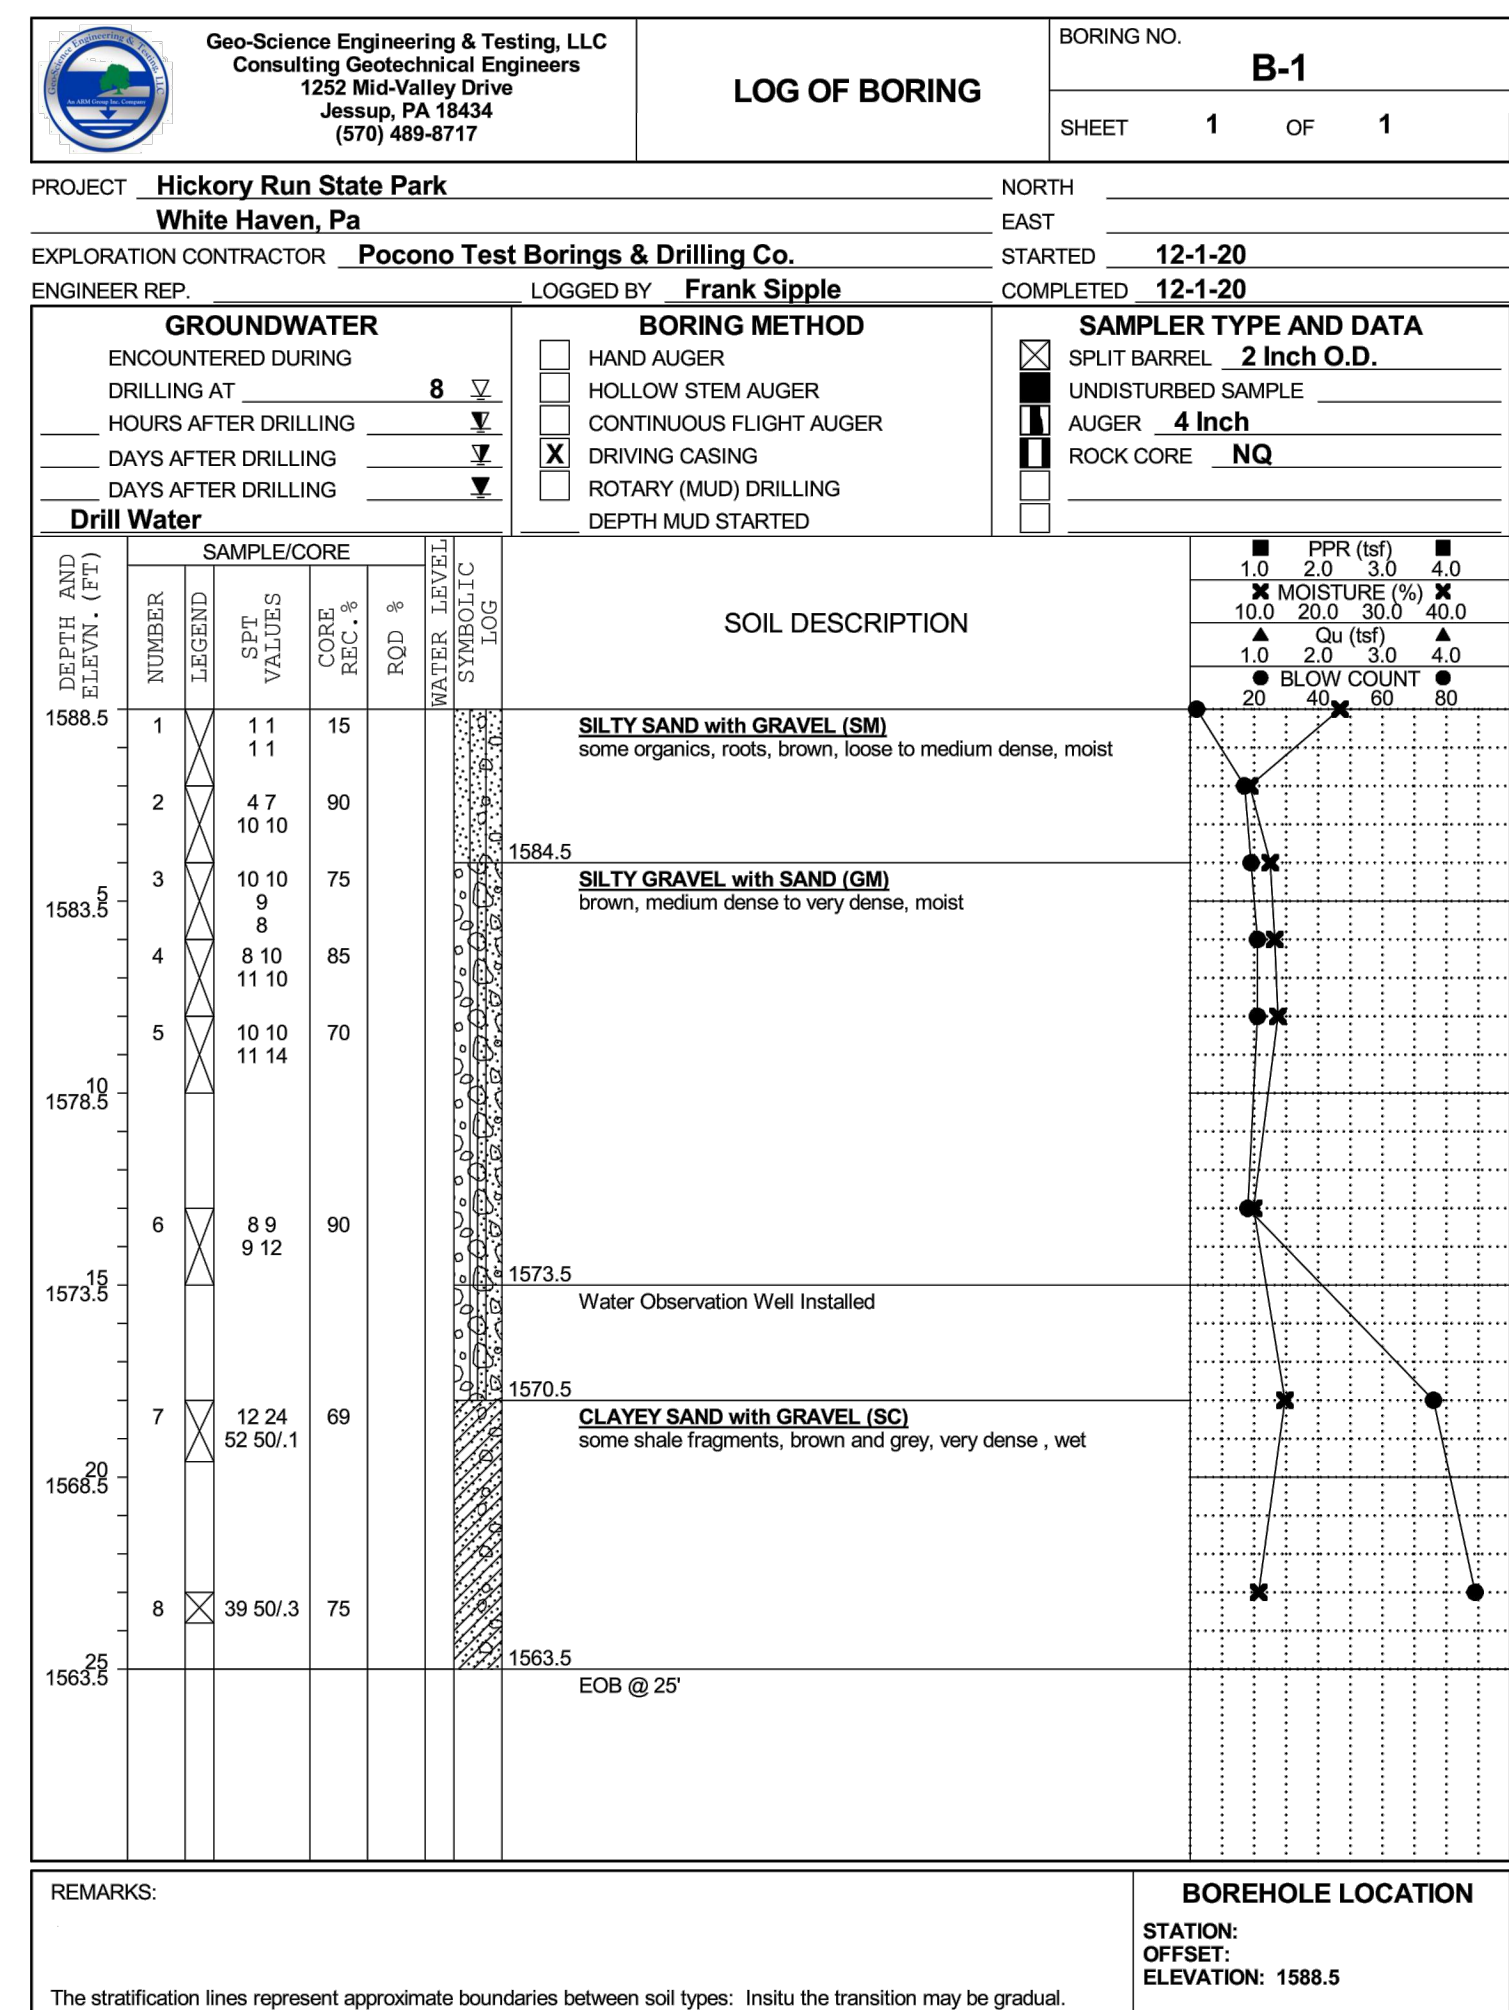

CONSTRUCTION DOCUMENTS

meliora
259 MORGAN STREET, PHOENIXVILLE, PA 19460
(610) 932-0123
melioradesign.com

NO.	REVISION	DATE

SMP ARCHITECTS
1600 WALNUT STREET, SECOND FLOOR
PHILADELPHIA, PENNSYLVANIA

COMMONWEALTH OF PENNSYLVANIA
DEPARTMENT OF GENERAL SERVICES
HARRISBURG, PENNSYLVANIA

D.G.S. PROJECT No. **C-114-0006 PHASE 1**
HICKORY RUN STATE PARK LATRINE IMPROVEMENTS
DEPT of CONSERVATION AND NATURAL RESOURCES
WHITE HAVEN, CARBON COUNTY, PA


BORING LOGS

CONTRACTOR SHALL FIELD VERIFY ALL DIMENSIONS. VARIANCE FROM CONTRACT DOCUMENTS NOT PERMITTED WITHOUT PROFESSIONAL & BUREAU OF CONSTRUCTION APPROVAL.

DRAWN BY: **L GILL**
DATE: **06/17/2022**

CHECKED BY: **M HENDERSON**
SCALE: **AS NOTED**

DRAWING No. **TB-5**

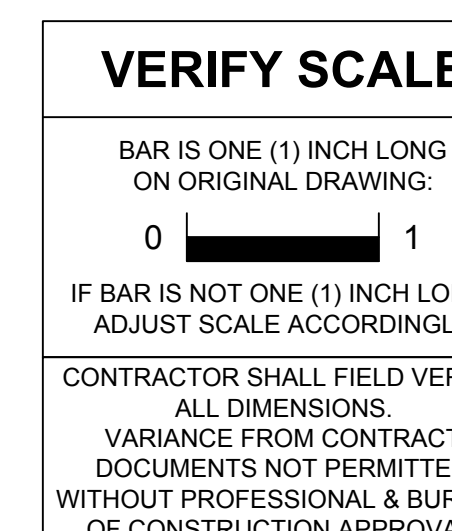

FILE PATH: U:\2020\09077 - Hickory Run State Park\CAD\Sheet_Plan_2022 - EROSION AND SEDIMENT CONTROL NOTES.dwg PLOTTED BY: Laura L. Gill
LAST SAVED: 2022.06.22 09:00 AM PLOTTED: 2022.06.22 09:06 AM LAYOUT TAB: BORING LOGS

LOG OF TEST PIT TP-2									
Date Excavated:		11/23/20		Logged by:		MA			
Equipment:		Bobcat Mini Excavator		Surface Elevation(ft):		1586.0			
DEPTH (feet)	GRAPHIC LOG	MATERIAL DESCRIPTION	SAMPLE	HAND PEN. (sf)	MOISTURE (%)	DRY UNIT WT. (pcf)	LAB TESTS		
5		Root mat - O - Black Silty Sand							
		SILTY SAND with GRAVEL (SM) brown - loose, moist							
		SILTY GRAVEL with SAND (GM) - brown, medium dense to dense, moist							
		Infiltration Test Elevation							
		EOP @ 7'							
Geo-Science Engineering & Testing, LLC 1252 Mid Valley Drive Jessup, PA 18434 Phone: 570-489-8717 Fax:			Hickory Run State Park White Haven, PA						

C-4

LOG OF TEST PIT TP-4									
Date Excavated:		11/23/20		Logged by:		MA			
Equipment:		Bobcat Mini Excavator		Surface Elevation(ft):		1598.0			
DEPTH (feet)	GRAPHIC LOG	MATERIAL DESCRIPTION	SAMPLE	HAND PEN. (sf)	MOISTURE (%)	DRY UNIT WT. (pcf)	LAB TESTS		
5		Root mat - O - Black Silty Sand							
		SILTY SAND - brown -medium dense, moist							
		SILTY GRAVEL with SAND (GM) - red brown, dense, moist							
		Infiltration Test Elevation							
		EOP @ 7'							
Geo-Science Engineering & Testing, LLC 1252 Mid Valley Drive Jessup, PA 18434 Phone: 570-489-8717 Fax:			Hickory Run State Park White Haven, PA						

C-7

LOG OF TEST PIT TP-6									
Date Excavated:		11/24/20		Logged by:		MA			
Equipment:		Bobcat Mini Excavator		Surface Elevation(ft):		1521.0			
DEPTH (feet)	GRAPHIC LOG	MATERIAL DESCRIPTION	SAMPLE	HAND PEN. (sf)	MOISTURE (%)	DRY UNIT WT. (pcf)	LAB TESTS		
5		Root mat - O - Black Silty Sand							
		SILTY SAND with GRAVEL (SM) - brown, medium dense, moist							
		SILTY GRAVEL with SAND (GM) brown, dense, moist							
		Infiltration Test Elevation							
		EOP @ 7'							
Geo-Science Engineering & Testing, LLC 1252 Mid Valley Drive Jessup, PA 18434 Phone: 570-489-8717 Fax:			Hickory Run State Park White Haven, PA						

C-10

LOG OF TEST PIT TP-7									
Date Excavated:		11/24/20		Logged by:		MA			
Equipment:		Bobcat Mini Excavator		Surface Elevation(ft):		1521.0			
DEPTH (feet)	GRAPHIC LOG	MATERIAL DESCRIPTION	SAMPLE	HAND PEN. (sf)	MOISTURE (%)	DRY UNIT WT. (pcf)	LAB TESTS		
5		Root mat - O - Black Silty Sand							
		SILTY SAND (SM) - brown, medium dense, moist							
		SILTY GRAVEL with SAND (GM) - red brown, medium dense to dense, moist							
		Infiltration Test Elevation							
		EOP @ 7'							
Geo-Science Engineering & Testing, LLC 1252 Mid Valley Drive Jessup, PA 18434 Phone: 570-489-8717 Fax:			Hickory Run State Park White Haven, PA						

C-13

LOG OF TEST PIT TP-9									
Date Excavated:		11/24/20		Logged by:		MA			
Equipment:		Bobcat Mini Excavator		Surface Elevation(ft):		1582.0			
DEPTH (feet)	GRAPHIC LOG	MATERIAL DESCRIPTION	SAMPLE	HAND PEN. (sf)	MOISTURE (%)	DRY UNIT WT. (pcf)	LAB TESTS		
5		Root mat - O - Black Silty Sand							
		SILTY SAND (SM) - grey (gleyed)							
		Water EOP @ 3'							
Geo-Science Engineering & Testing, LLC 1252 Mid Valley Drive Jessup, PA 18434 Phone: 570-489-8717 Fax:			Hickory Run State Park White Haven, PA						

C-16

LOG OF TEST PIT TP-8R									
Date Excavated:		11/9/21		Logged by:		JW			
Equipment:		Bobcat Mini Excavator		Surface Elevation(ft):		1583.0			
DEPTH (feet)	GRAPHIC LOG	MATERIAL DESCRIPTION	SAMPLE	HAND PEN. (sf)	MOISTURE (%)	DRY UNIT WT. (pcf)	LAB TESTS		
5		Root mat - O - Silty Sand - Brown w/root mat							
		SILTY SAND with GRAVEL (SM) brown - medium dense, moist							
		Infiltration Test Elevation SILTY SAND with GRAVEL (SM) - red brown, dense, moist							
		EOP @ 3.4'							
Geo-Science Engineering & Testing, LLC 1252 Mid Valley Drive Jessup, PA 18434 Phone: 570-489-8717 Fax:			Hickory Run State Park White Haven, PA						

Hickory Run State Park
White Haven, PA

LOG OF TEST PIT TP-9R									
Date Excavated:		11/9/21		Logged by:		JW			
Equipment:		Bobcat Mini Excavator		Surface Elevation(ft):		1586.0			
DEPTH (feet)	GRAPHIC LOG	MATERIAL DESCRIPTION	SAMPLE	HAND PEN. (sf)	MOISTURE (%)	DRY UNIT WT. (pcf)	LAB TESTS		
5		Root mat - O - Silty Sand - Brown w/root mat							
		SILTY SAND with GRAVEL (SM) brown - medium dense, moist							
		SILTY SAND with GRAVEL (SM) red brown, medium dense to dense, moist							
		Infiltration Test Elevation							
		EOP @ 7'							
Geo-Science Engineering & Testing, LLC 1252 Mid Valley Drive Jessup, PA 18434 Phone: 570-489-8717 Fax:			Hickory Run State Park White Haven, PA						

Hickory Run State Park
White Haven, PA

CONSTRUCTION DOCUMENTS



259 MORGAN STREET, PHOENIXVILLE, PA 19460 (610) 933-0123 melioradesign.com
--

RECORD REVISIONS	
	06/15/22
SIGNATURE	DATE

SMP ARCHITECTS
1600 WALNUT STREET, SECOND FLOOR
PHILADELPHIA, PENNSYLVANIA

COMMONWEALTH OF PENNSYLVANIA
DEPARTMENT OF GENERAL SERVICES
HARRISBURG, PENNSYLVANIA

D.G.S. PROJECT No.
C-114-0006 PHASE 1



HICKORY RUN STATE PARK
LATRINE IMPROVEMENTS
DEPT of CONSERVATION AND NATURAL RESOURCES
WHITE HAVEN, CARBON COUNTY, PA

VERIFY SCALE	BAR IS ONE (1) INCH LONG ON ORIGINAL DRAWING: 0 1
IF BAR IS NOT ONE (1) INCH LONG, ADJUST SCALE ACCORDINGLY.	
CONTRACTOR SHALL FIELD VERIFY ALL DIMENSIONS. VARIANCE FROM CONTRACT DOCUMENTS NOT PERMITTED WITHOUT PROFESSIONAL & BUREAU OF CONSTRUCTION APPROVAL.	


DRAWN BY L GILL	DATE 06/17/2022	DRAWING No. TB-6
CHECKED BY M HENDERSON	SCALE AS NOTED	

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LAST SAVED: 2022.06.22 09:00 AM PLOTTED: 2022.06.22 09:06 AM

- LEGEND**
- S ——— EXISTING 6" PVC GRAVITY SEWER
 - W ——— EXISTING WATER MAIN
 - ——— EXISTING UTILITY POLE
 - P ——— EXISTING POWER LINE
 - ——— EXISTING TREE
 - - - - - EXISTING CONTOUR
 - - - - - LEGAL RIGHT-OF-WAY LINE
 - - - - - EXISTING EDGE OF PAVEMENT
 - Abcde TEXT FOR EXISTING ITEMS
 - ABCDE TEXT FOR EXISTING ITEMS
 - ~~~~~ WOODS LINE
 - ⊕ (S) EXISTING STORM SEWER
 - ⊕ EXISTING SANITARY MANHOLE
 - ⊕ TP/B-9 SOIL TEST PIT (TP) OR BORING (B) LOCATION

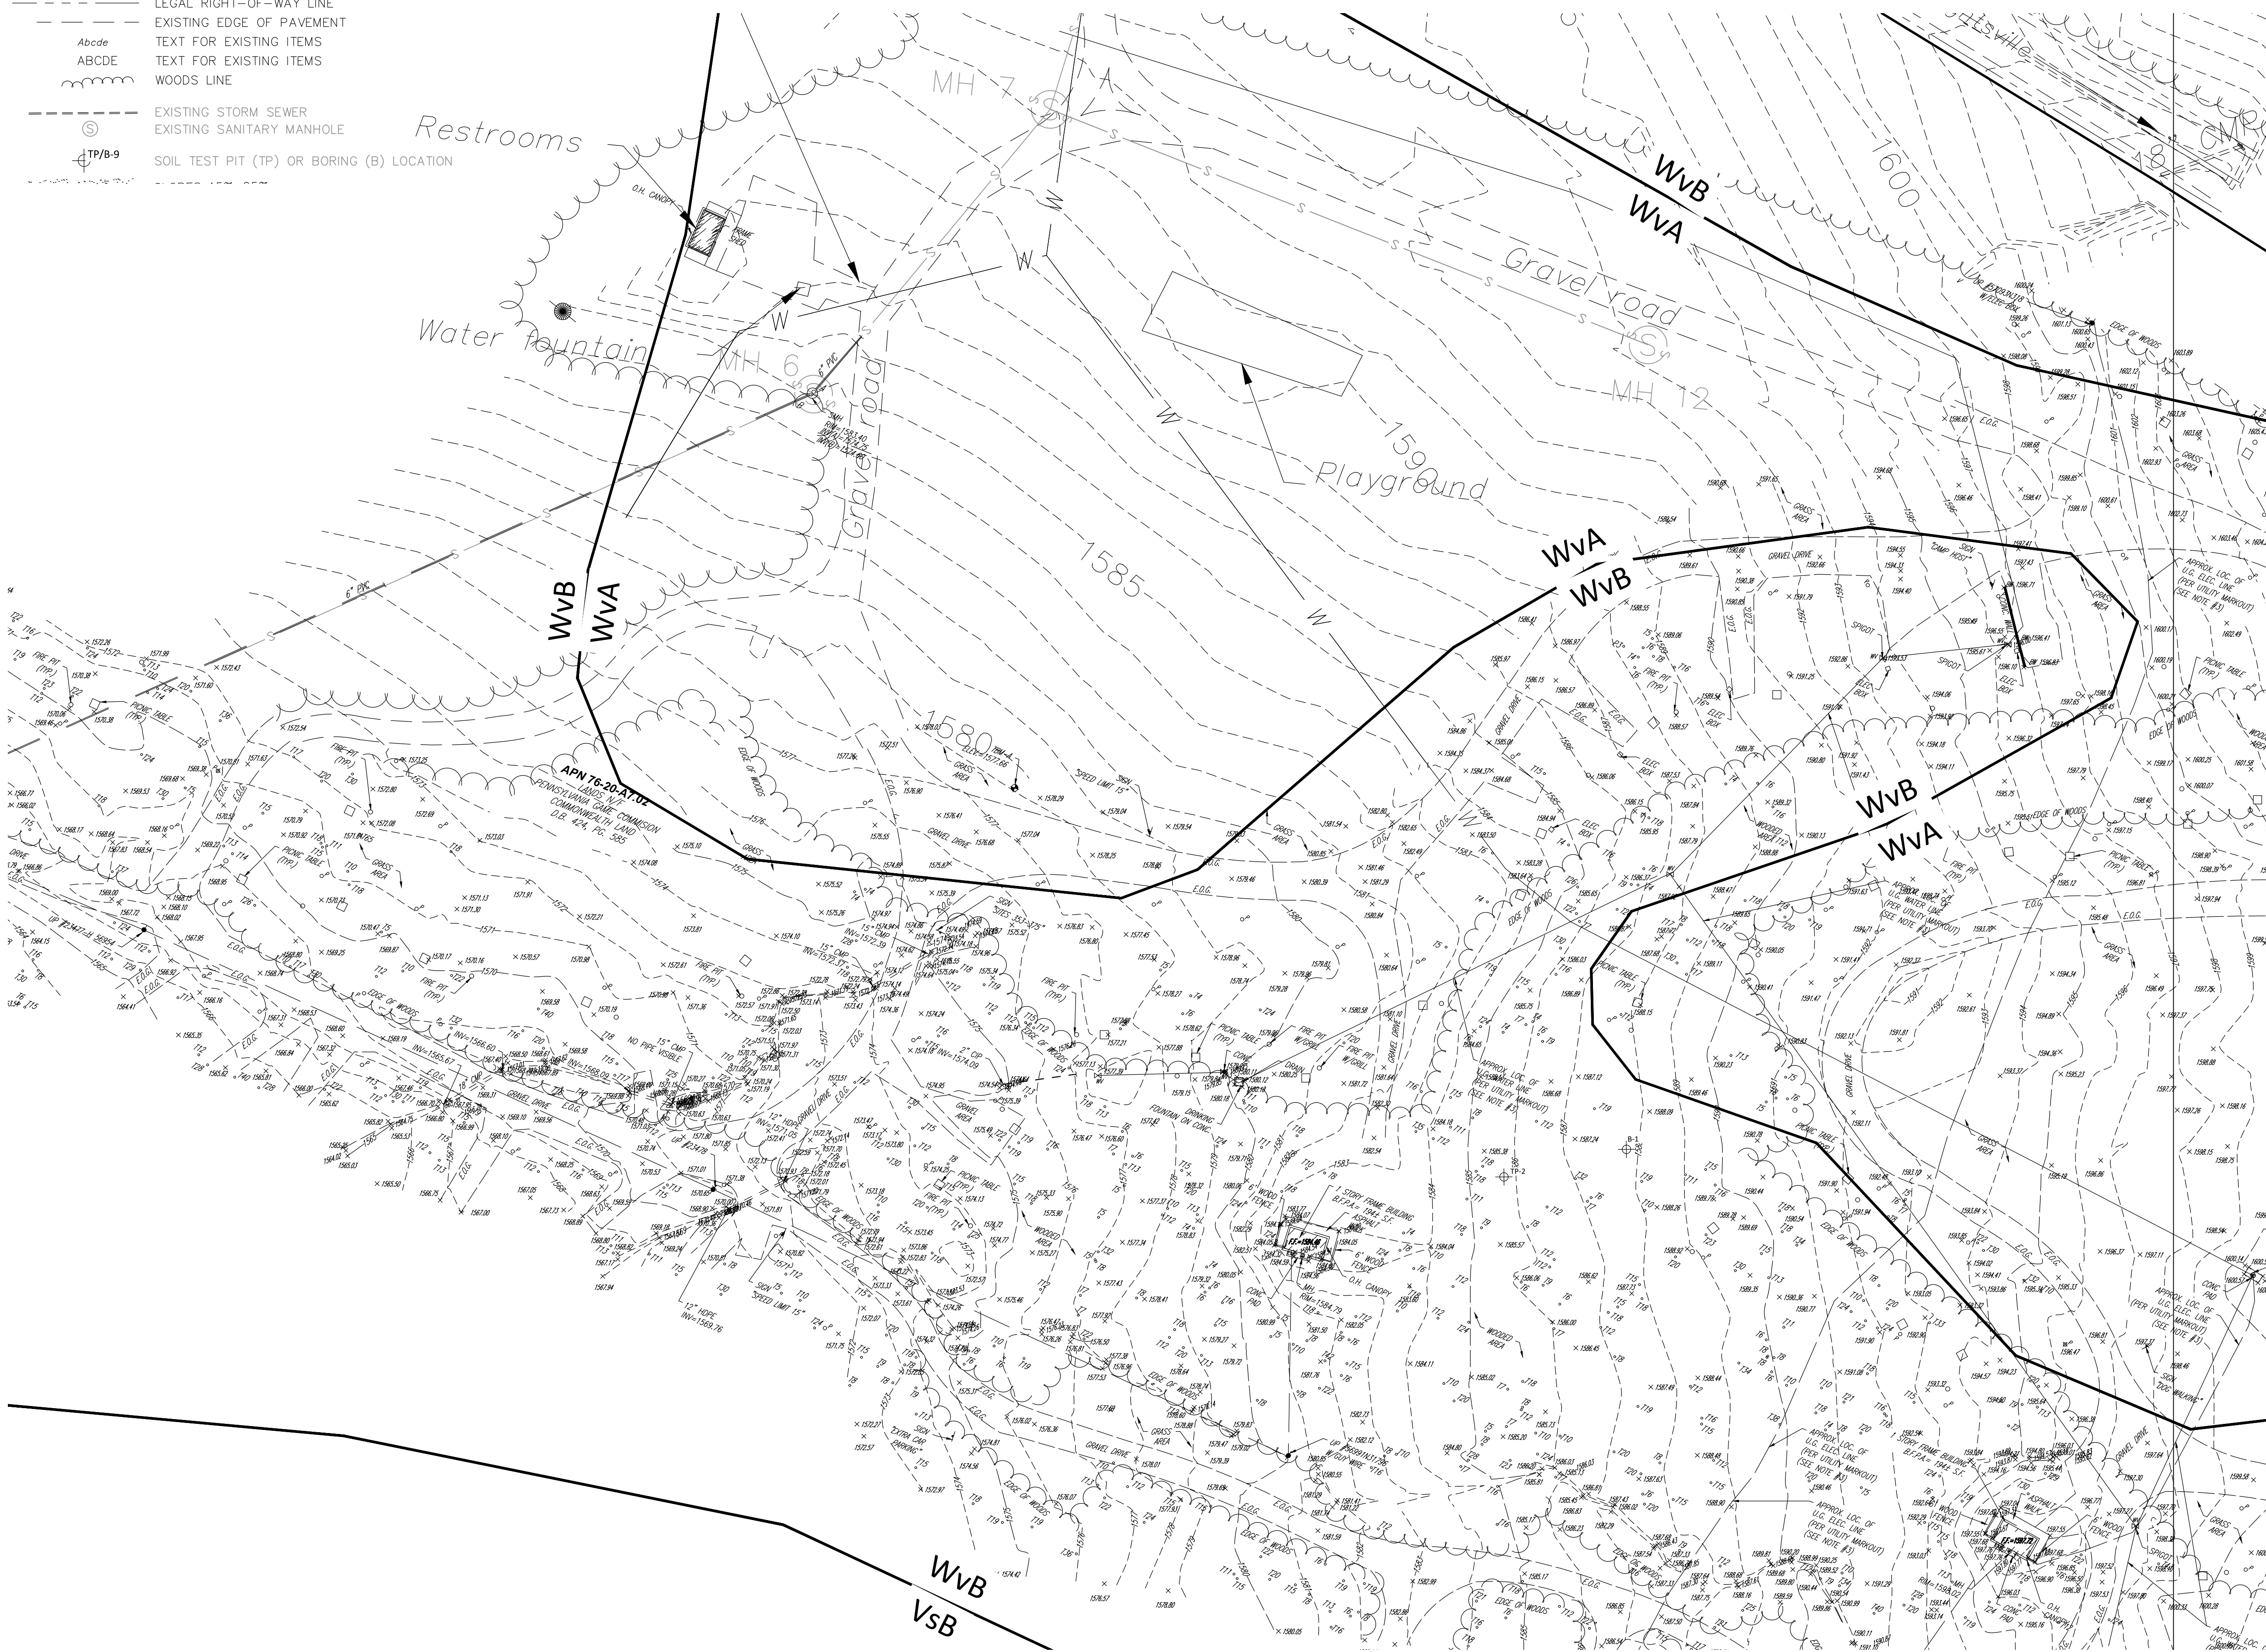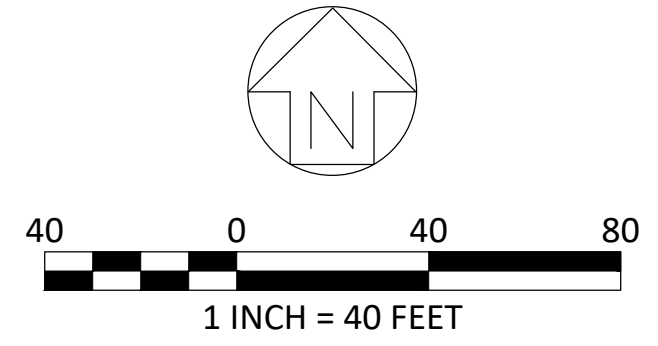

SITE LOCATION

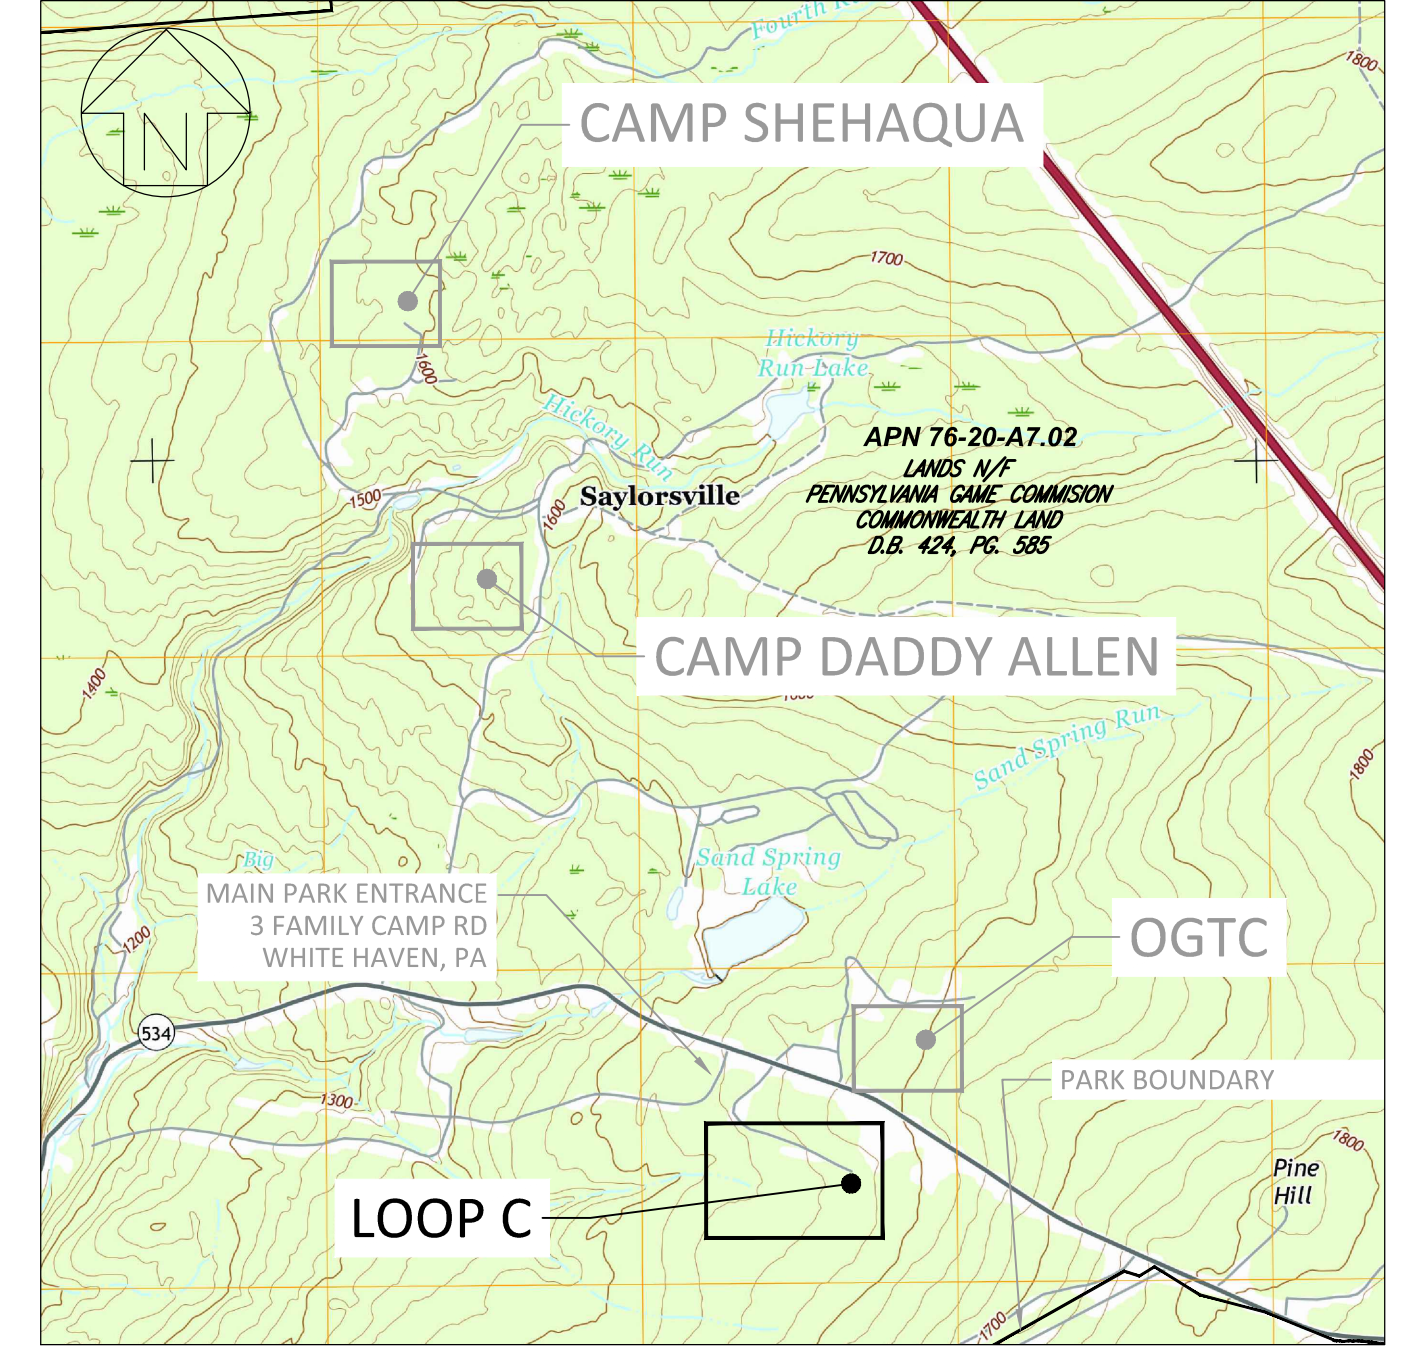

CONSTRUCTION DOCUMENTS



RECORD REVISIONS

06/15/22
SIGNATURE DATE

SMP ARCHITECTS
1600 WALNUT STREET, SECOND FLOOR
PHILADELPHIA, PENNSYLVANIA

COMMONWEALTH OF PENNSYLVANIA
DEPARTMENT OF GENERAL SERVICES
HARRISBURG, PENNSYLVANIA

D.G.S. PROJECT No. C-114-0006 PHASE 1
HICKORY RUN STATE PARK
LATRINE IMPROVEMENTS
DEPT of CONSERVATION AND NATURAL RESOURCES
WHITE HAVEN, CARBON COUNTY, PA
EXISTING CONDITIONS PLAN -
CAMP LOOP C


CONTRACTOR SHALL FIELD VERIFY ALL DIMENSIONS. VARIANCE FROM CONTRACT DOCUMENTS NOT PERMITTED WITHOUT PROFESSIONAL & BUREAU OF CONSTRUCTION APPROVAL.	DRAWN BY	DATE	DRAWING No.
		06/17/2022	C-1
	CHECKED BY	SCALE	AS NOTED

14 OF 144

VERIFY SCALE
BAR IS ONE (1) INCH LONG ON ORIGINAL DRAWING:
0 1
IF BAR IS NOT ONE (1) INCH LONG, ADJUST SCALE ACCORDINGLY




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LAST SAVED: 2022.06.15 04:17 PM PLOTTED BY: Laura L. Gill

SITE LOCATION

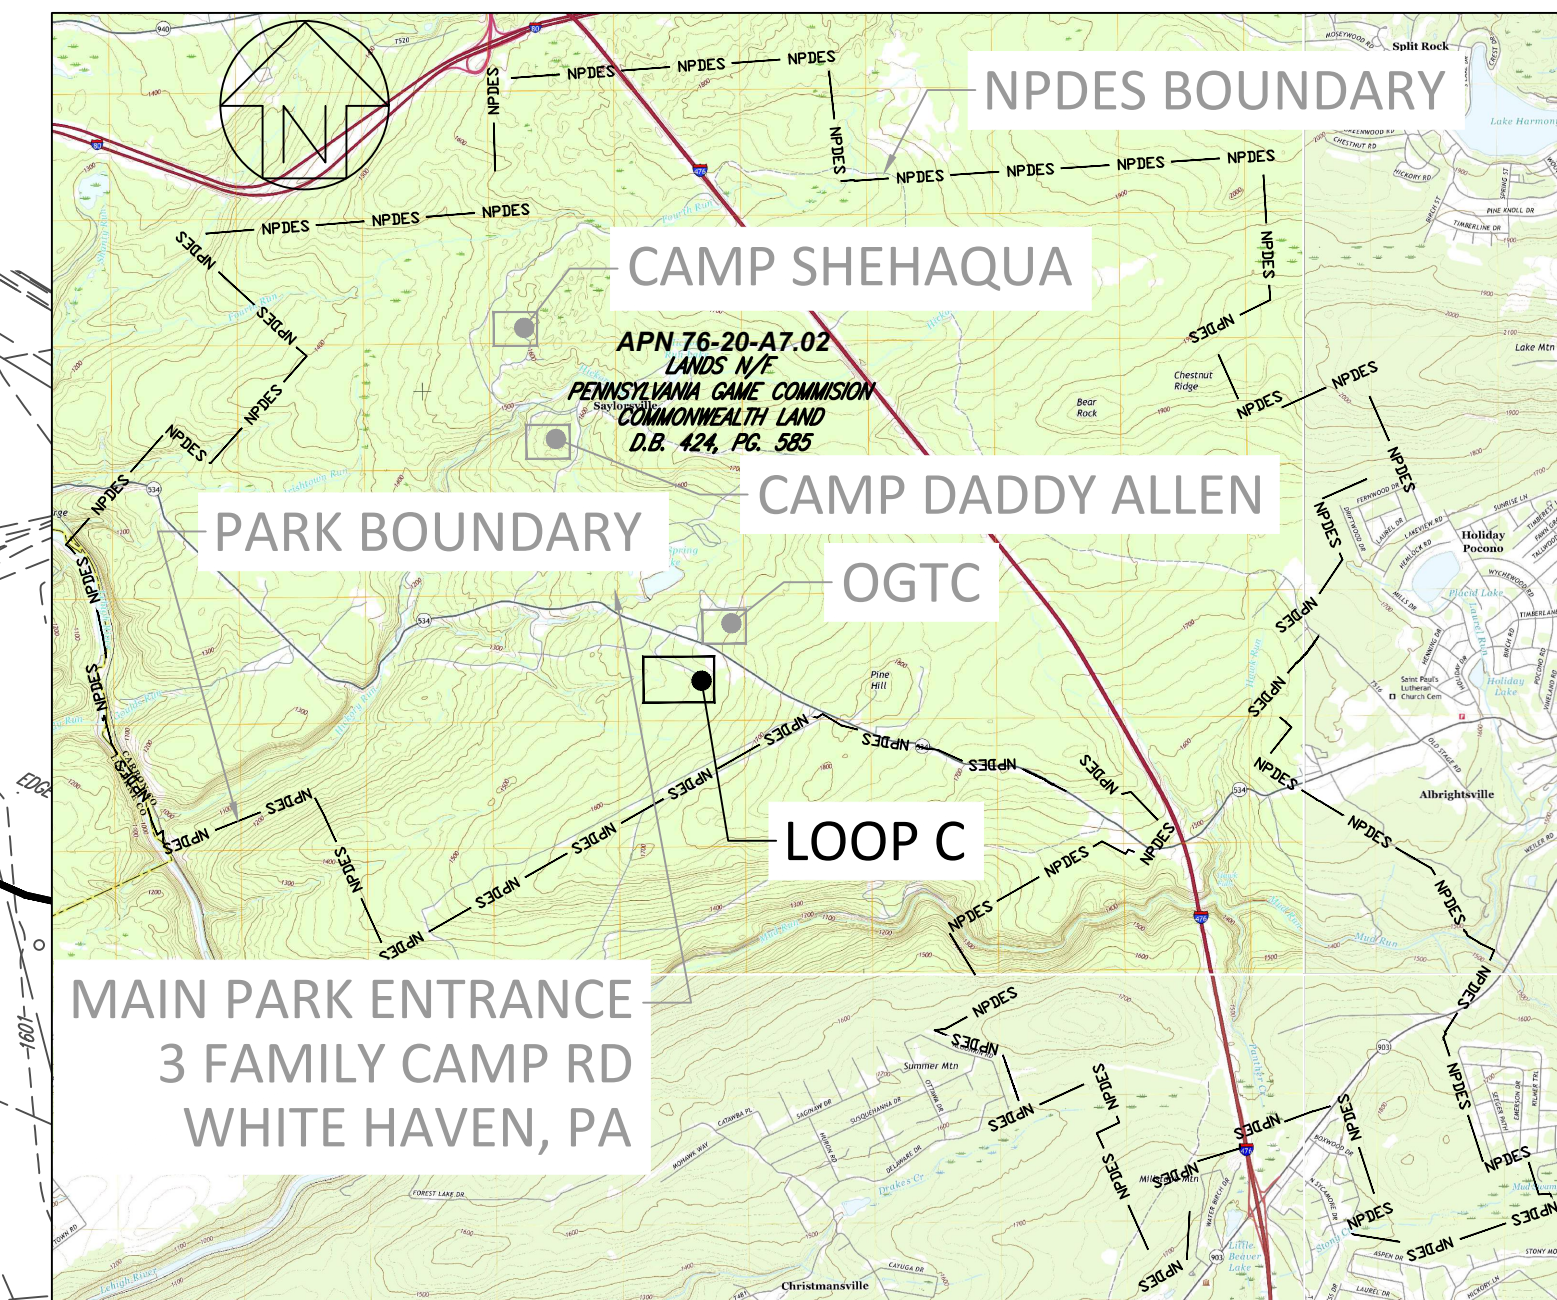

- LEGEND**
- PROJECT BOUNDARY/LIMIT OF DISTURBANCE
 - TREE PROTECTION
 - COMPOST SOCK
 - CONSTRUCTION FENCE
 - ROCK CONSTRUCTION ENTRANCE
 - EROSION CONTROL BLANKET
 - SEDIMENT TRAP
 - INFILTRATION STAKEOUT FENCE

Map Unit Symbol	Map Unit Name	Rating
WuA	Wurtsboro channery loam, 0 to 3 percent slopes	Somewhat Limited
WvB	Wurtsboro very stony loam, 0 to 8 percent slopes	Somewhat Limited

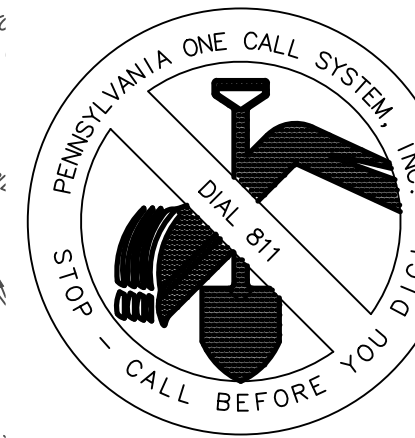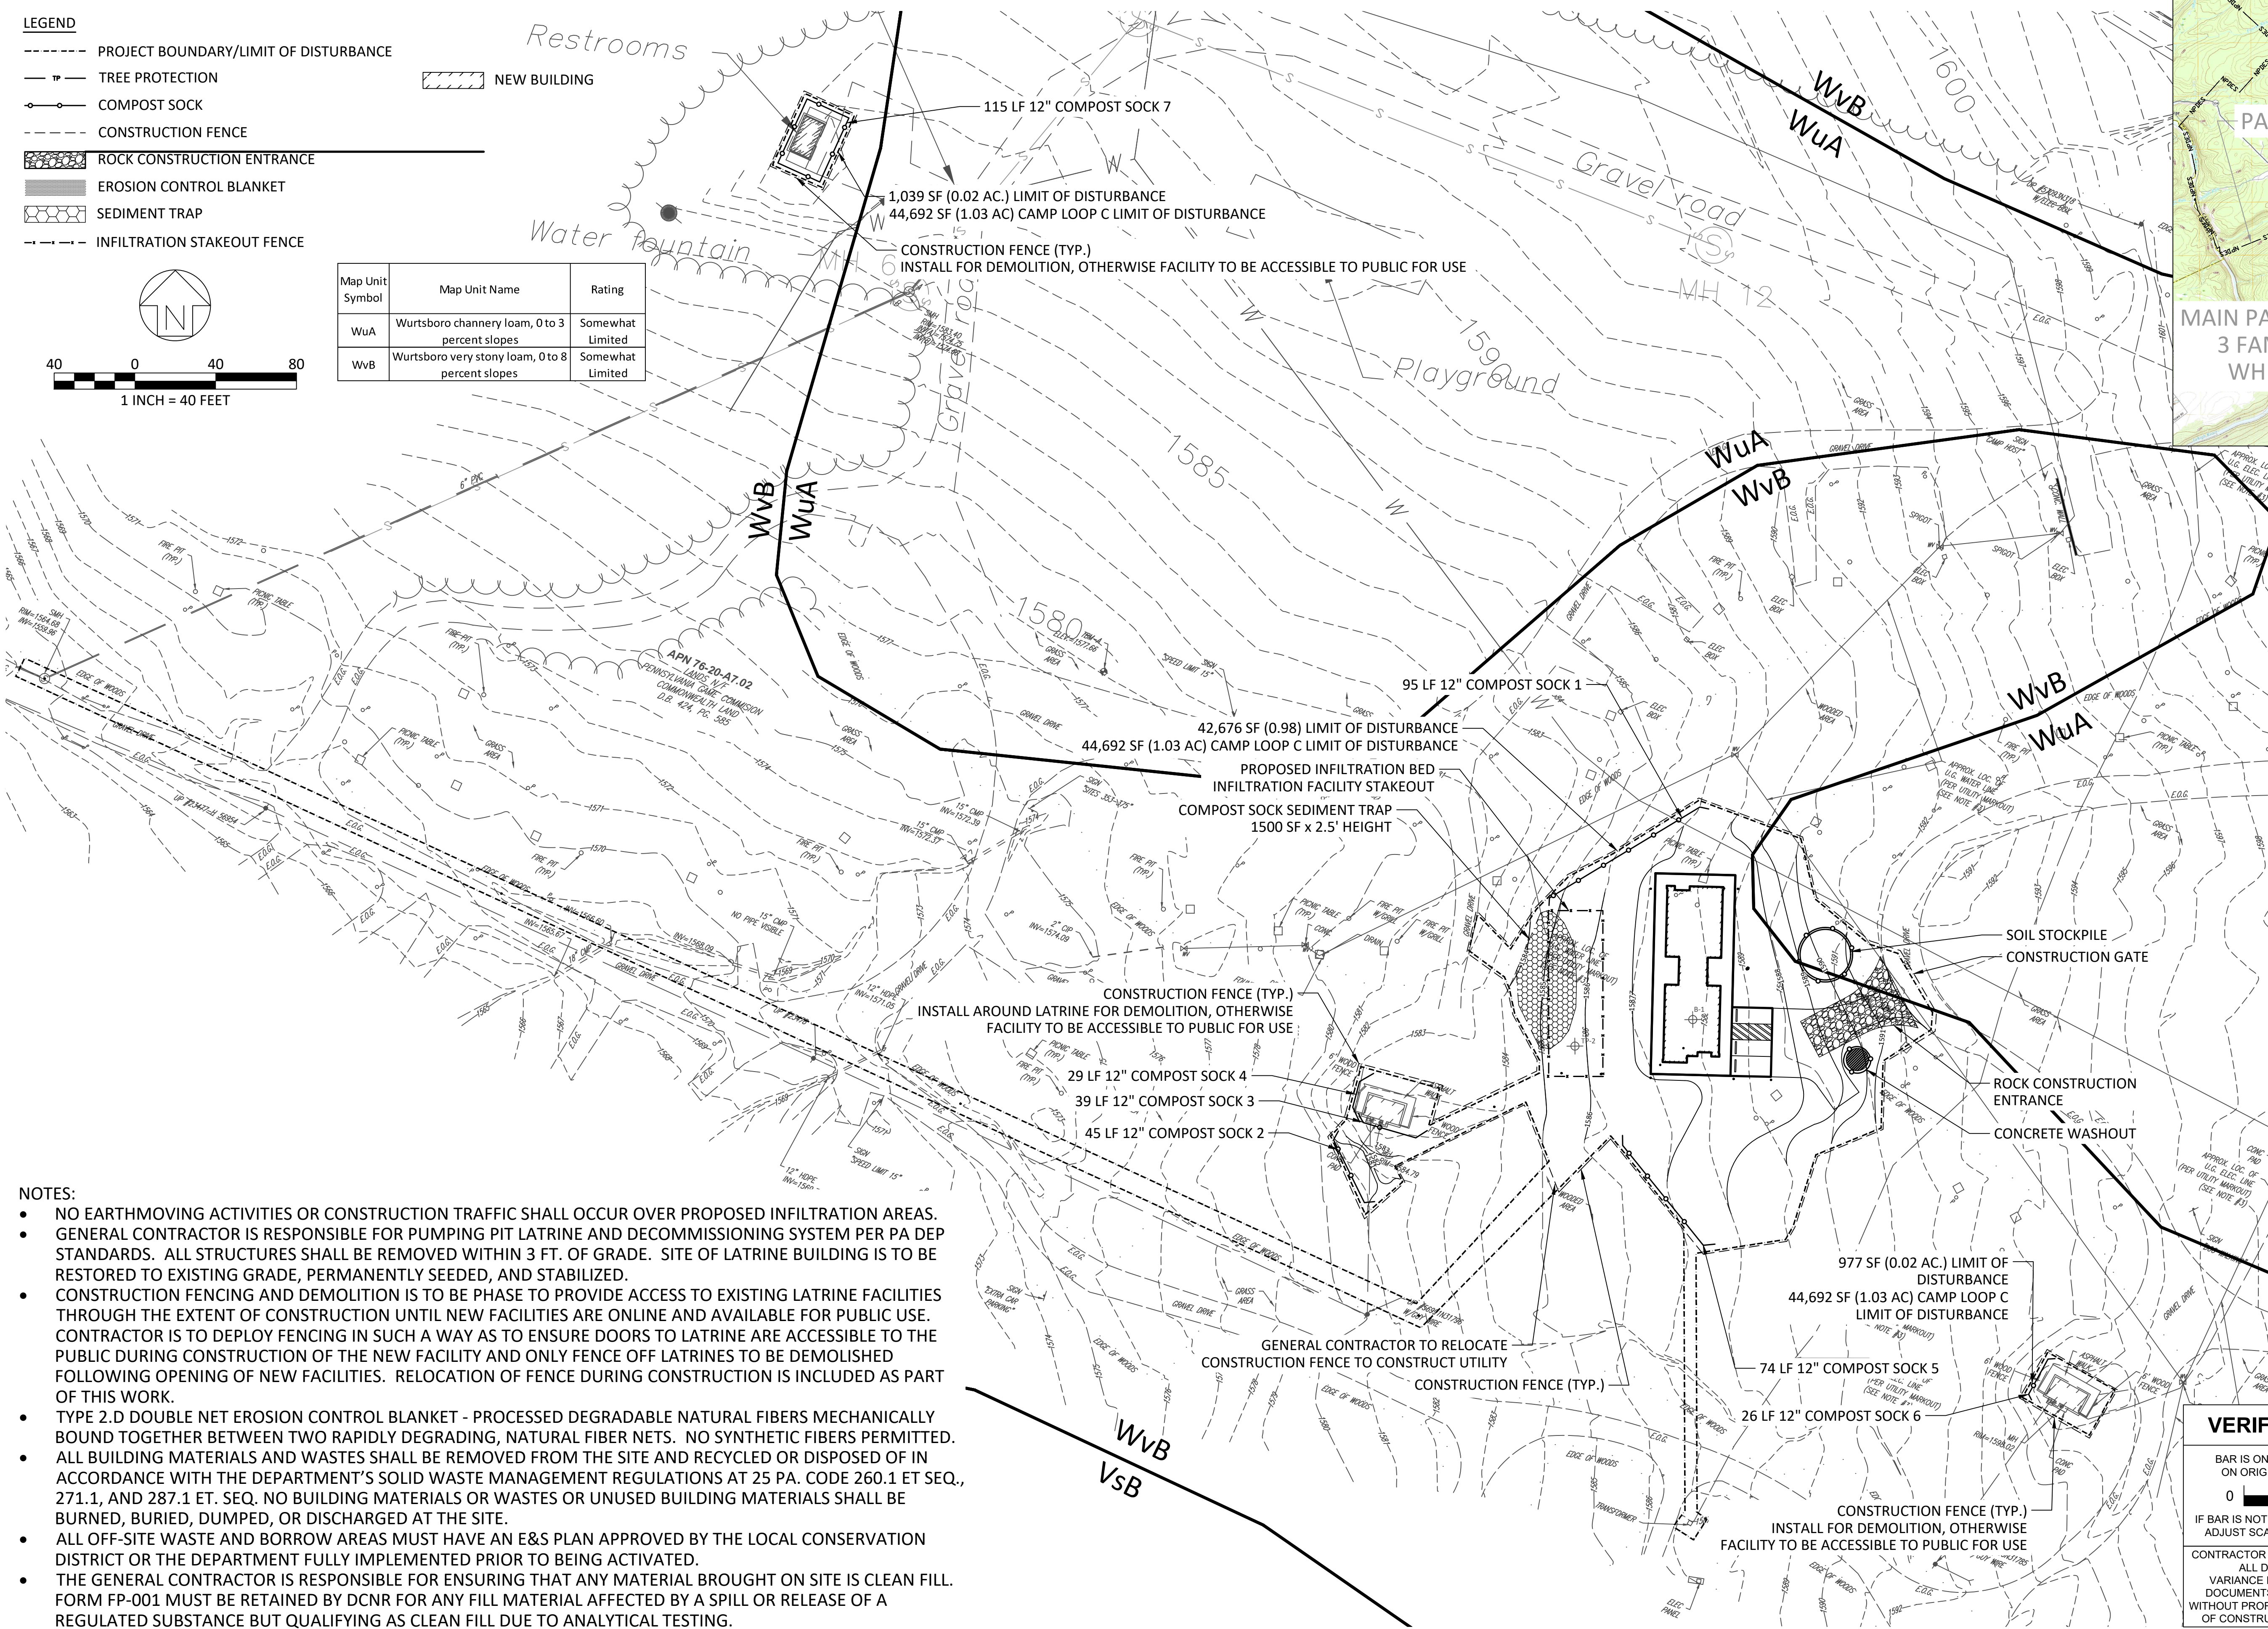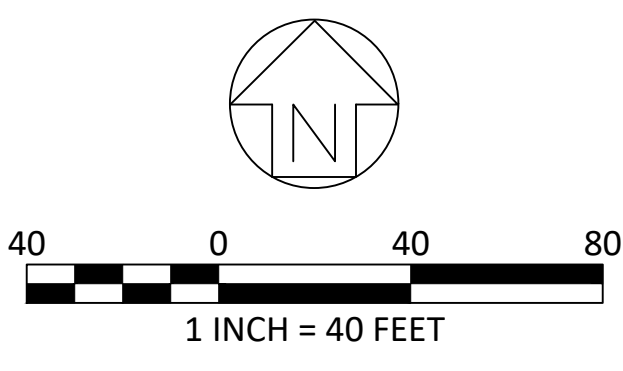

PA ONE CALL SERIAL NUMBER - 20202343070
 ALL LOCATIONS OF EXISTING UTILITIES SHOWN ON THIS PLAN HAVE BEEN DEVELOPED FROM EXISTING UTILITY RECORDS AND/OR ABOVE GROUND EXAMINATION OF THE SITE. COMPLETENESS OR ACCURACY OF LOCATION AND DEPTH OF UNDERGROUND UTILITIES OR STRUCTURES CANNOT BE GUARANTEED. CONTRACTOR MUST VERIFY LOCATION AND DEPTH OF ALL UNDERGROUND UTILITIES AND FACILITIES BEFORE START OF WORK PER PENNSYLVANIA ACT 287 OF 1974 AS AMENDED BY ACT 199 OF 2004 OR LATER.

CONSTRUCTION DOCUMENTS



RECORD REVISIONS

Professional Engineer Seal for Marc B. Henderson, No. 088402, State of Pennsylvania. Signature and Date: 06/15/22.

SMP ARCHITECTS
 1600 WALNUT STREET, SECOND FLOOR
 PHILADELPHIA, PENNSYLVANIA

COMMONWEALTH OF PENNSYLVANIA
 DEPARTMENT OF GENERAL SERVICES
 HARRISBURG, PENNSYLVANIA

D.G.S. PROJECT No. C-114-0006 PHASE 1
HICKORY RUN STATE PARK
 LATRINE IMPROVEMENTS
 DEPT of CONSERVATION AND NATURAL RESOURCES
 WHITE HAVEN, CARBON COUNTY, PA
EROSION AND SEDIMENT CONTROL PLAN - CAMP LOOP C

DRAWN BY: L GILL DATE: 06/17/2022
 CHECKED BY: M HENDERSON SCALE: AS NOTED

DRAWING No. C-3 of 44

- NOTES:**
- NO EARTHMOVING ACTIVITIES OR CONSTRUCTION TRAFFIC SHALL OCCUR OVER PROPOSED INFILTRATION AREAS.
 - GENERAL CONTRACTOR IS RESPONSIBLE FOR PUMPING PIT LATRINE AND DECOMMISSIONING SYSTEM PER PA DEP STANDARDS. ALL STRUCTURES SHALL BE REMOVED WITHIN 3 FT. OF GRADE. SITE OF LATRINE BUILDING IS TO BE RESTORED TO EXISTING GRADE, PERMANENTLY SEEDING, AND STABILIZED.
 - CONSTRUCTION FENCING AND DEMOLITION IS TO BE PHASE TO PROVIDE ACCESS TO EXISTING LATRINE FACILITIES THROUGH THE EXTENT OF CONSTRUCTION UNTIL NEW FACILITIES ARE ONLINE AND AVAILABLE FOR PUBLIC USE. CONTRACTOR IS TO DEPLOY FENCING IN SUCH A WAY AS TO ENSURE DOORS TO LATRINE ARE ACCESSIBLE TO THE PUBLIC DURING CONSTRUCTION OF THE NEW FACILITY AND ONLY FENCE OFF LATRINES TO BE DEMOLISHED FOLLOWING OPENING OF NEW FACILITIES. RELOCATION OF FENCE DURING CONSTRUCTION IS INCLUDED AS PART OF THIS WORK.
 - TYPE 2.D DOUBLE NET EROSION CONTROL BLANKET - PROCESSED DEGRADABLE NATURAL FIBERS MECHANICALLY BOUND TOGETHER BETWEEN TWO RAPIDLY DEGRADING, NATURAL FIBER NETS. NO SYNTHETIC FIBERS PERMITTED.
 - ALL BUILDING MATERIALS AND WASTES SHALL BE REMOVED FROM THE SITE AND RECYCLED OR DISPOSED OF IN ACCORDANCE WITH THE DEPARTMENT'S SOLID WASTE MANAGEMENT REGULATIONS AT 25 PA. CODE 260.1 ET SEQ., 271.1, AND 287.1 ET. SEQ. NO BUILDING MATERIALS OR WASTES OR UNUSED BUILDING MATERIALS SHALL BE BURNED, BURIED, DUMPED, OR DISCHARGED AT THE SITE.
 - ALL OFF-SITE WASTE AND BORROW AREAS MUST HAVE AN E&S PLAN APPROVED BY THE LOCAL CONSERVATION DISTRICT OR THE DEPARTMENT FULLY IMPLEMENTED PRIOR TO BEING ACTIVATED.
 - THE GENERAL CONTRACTOR IS RESPONSIBLE FOR ENSURING THAT ANY MATERIAL BROUGHT ON SITE IS CLEAN FILL. FORM FP-001 MUST BE RETAINED BY DCNR FOR ANY FILL MATERIAL AFFECTED BY A SPILL OR RELEASE OF A REGULATED SUBSTANCE BUT QUALIFYING AS CLEAN FILL DUE TO ANALYTICAL TESTING.

VERIFY SCALE

BAR IS ONE (1) INCH LONG ON ORIGINAL DRAWING:
 0 1

IF BAR IS NOT ONE (1) INCH LONG, ADJUST SCALE ACCORDINGLY

CONTRACTOR SHALL FIELD VERIFY ALL DIMENSIONS. VARIANCE FROM CONTRACT DOCUMENTS NOT PERMITTED WITHOUT PROFESSIONAL & BUREAU OF CONSTRUCTION APPROVAL.



FILE PATH: I:\2020\0607 - Hickory Run State Park\CAD\Shehaqua\2022 - EROSION AND SEDIMENT CONTROL PLAN.dwg PLOTTED BY: Marc Henderson LAYOUT TAB: EROSION AND SEDIMENT CONTROL PLAN - CAMP LOOP C

LEGEND


- PROJECT BOUNDARY/LIMIT OF DISTURBANCE
- × TREE TO BE REMOVED
- TREE TO BE PROTECTED
- ⊙ TREE TO BE IMPACTED
- UTILITY STRUCTURE REMOVAL
- +++ UTILITY LINE REMOVAL
- ▨ BUILDING DEMOLITION
- CONCRETE DEMOLITION

NOTES:

1. TREE STUMPS TO BE LEFT SHALL BE CUT LESS THAN 5 INCHES HIGH.
2. GENERAL CONTRACTOR IS RESPONSIBLE FOR PUMPING PIT LATRINES AND DECOMMISSIONING SYSTEM PER PA DEP STANDARDS. ALL STRUCTURES SHALL BE REMOVED WITHIN 3 FT. OF GRADE. SITE OF LATRINE BUILDING IS TO BE RESTORED TO EXISTING GRADE, PERMANENTLY STABILIZED.

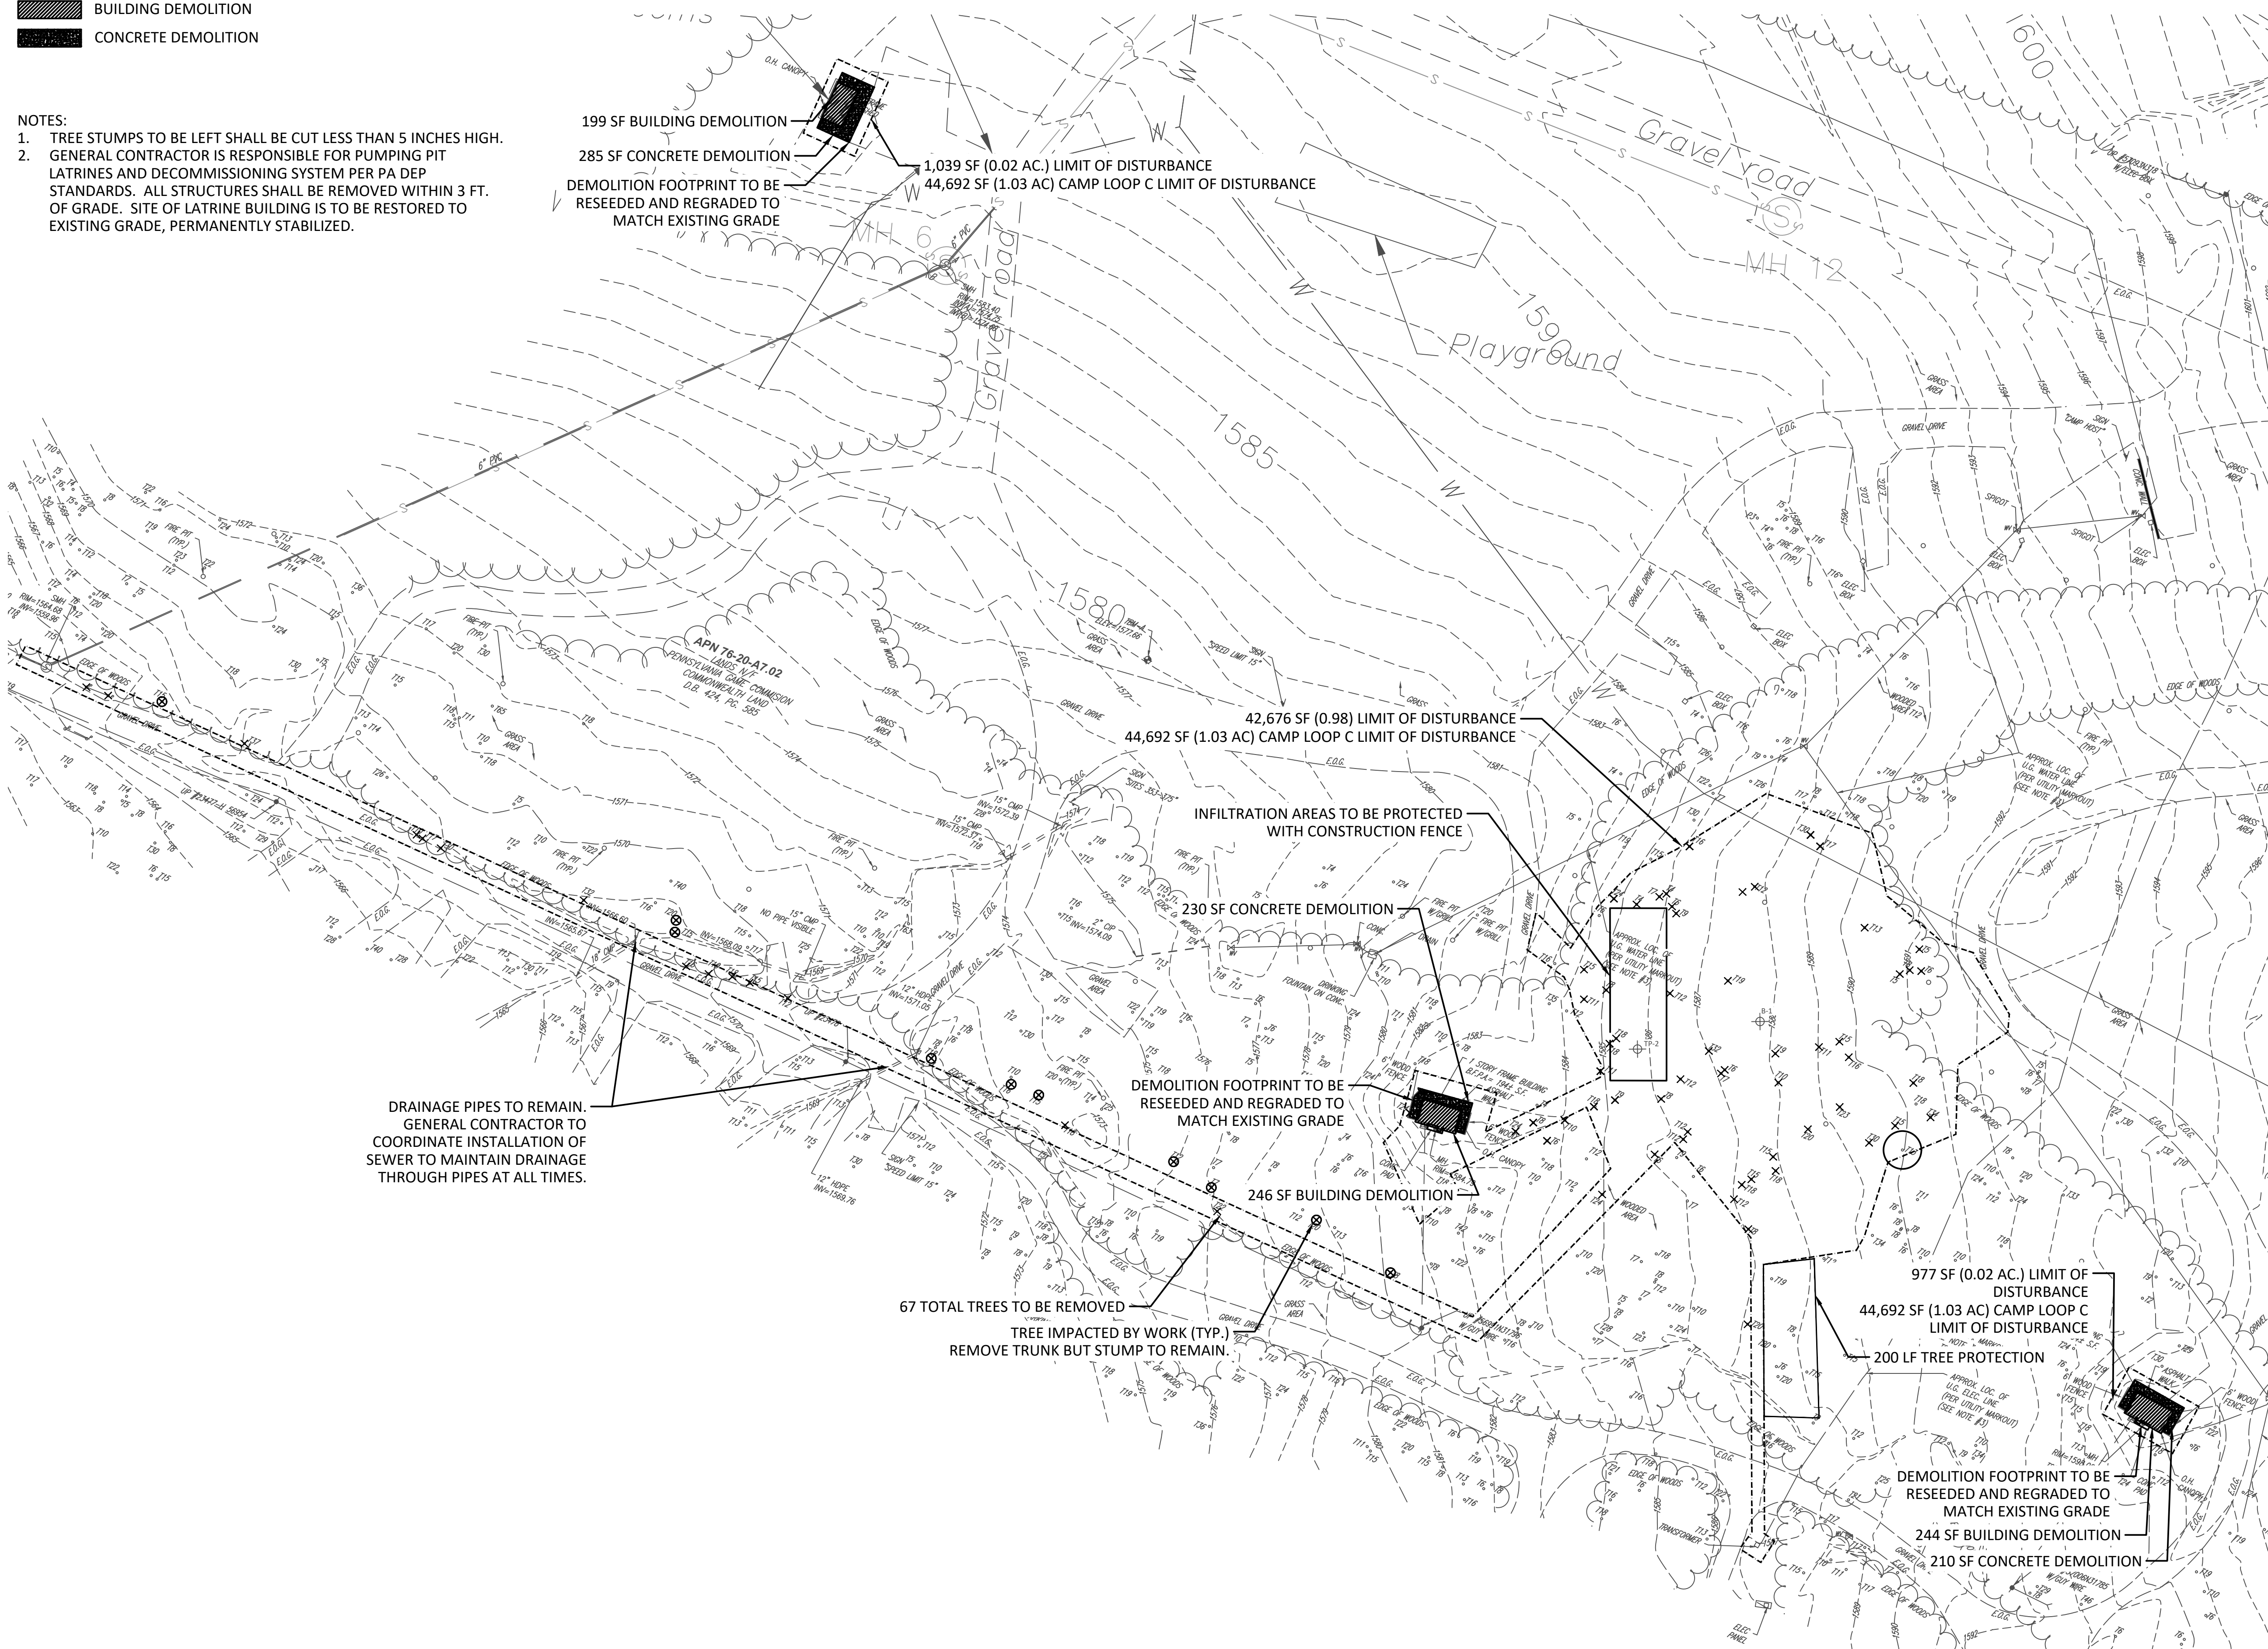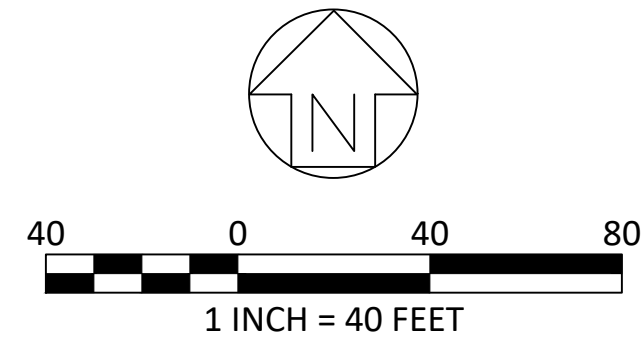

SITE LOCATION

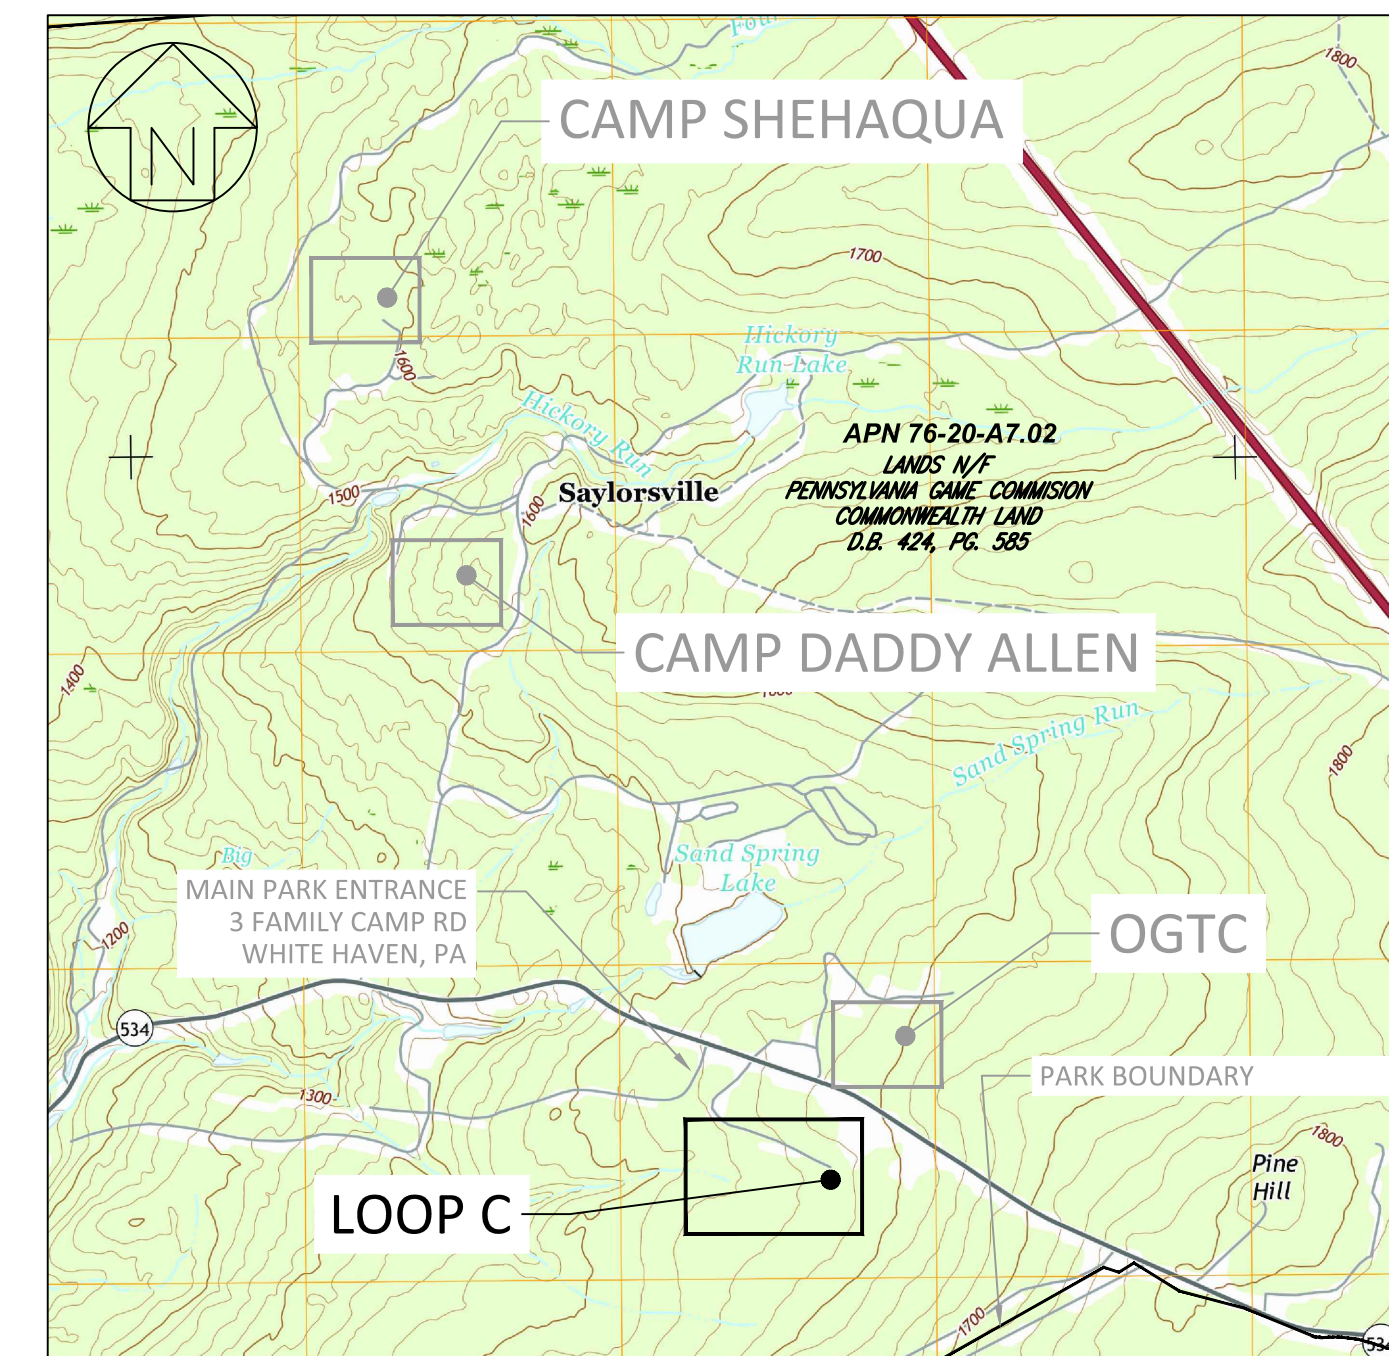


SCALE: 1" = 2000'

CONSTRUCTION DOCUMENTS



RECORD REVISIONS

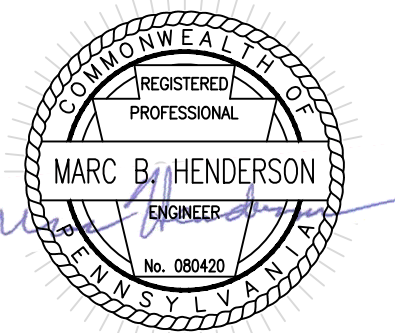

SIGNATURE: *Marc B. Henderson* DATE: 06/15/22

SMP ARCHITECTS
1600 WALNUT STREET, SECOND FLOOR
PHILADELPHIA, PENNSYLVANIA

COMMONWEALTH OF PENNSYLVANIA
DEPARTMENT OF GENERAL SERVICES
HARRISBURG, PENNSYLVANIA

D.G.S. PROJECT No. C-114-0006 PHASE 1
HICKORY RUN STATE PARK
LATRINE IMPROVEMENTS
DEPT of CONSERVATION AND NATURAL RESOURCES
WHITE HAVEN, CARBON COUNTY, PA

DEMOLITION PLAN -
CAMP LOOP C

VERIFY SCALE

BAR IS ONE (1) INCH LONG ON ORIGINAL DRAWING:
0 1
IF BAR IS NOT ONE (1) INCH LONG, ADJUST SCALE ACCORDINGLY

CONTRACTOR SHALL FIELD VERIFY ALL DIMENSIONS. VARIANCE FROM CONTRACT DOCUMENTS NOT PERMITTED WITHOUT PROFESSIONAL & BUREAU OF CONSTRUCTION APPROVAL.

DRAWN BY L GILL	DATE 06/17/2022
CHECKED BY M HENDERSON	SCALE AS NOTED

DRAWING No. **C-4**


LEGEND

- PROJECT BOUNDARY/LIMIT OF DISTURBANCE
- PROPOSED BUILDING
- 1519- CONTOUR
- ST STORM PIPE
- INFILTRATION BED
- RAIN GARDEN
- TP/B-9 SOIL TEST PIT (TP) OR BORING (B) LOCATION
- OBSERVATION WELL


BORING ID	SURFACE ELEVATION	BORING DEPTH	OBSERVED WATER SURFACE DEPTH
B-1	1588.5' ±	25'	N/A

STORMWATER TEST PIT ID	SURFACE ELEVATION	PIT DEPTH	TEST DEPTH	AVERAGE FIELD INFIL. RATE (IN/HR)	FACTOR OF SAFETY	DESIGN INFIL. RATE (IN/HR)
TP-2	1586'	5'	7'	0.59	2	0.30


- NOTES:**
- PROPOSED SANITARY AND/OR ELECTRICAL UTILITY CLEARING TO BE REGRADED TO MATCH EXISTING GRADE AND REMAIN CLEARED AND OPEN FOR PEDESTRIAN ACCESS.
 - GENERAL CONTRACTOR RESPONSIBLE FOR CONNECTIONS FROM BUILDING DOWNSPOUTS TO STORMWATER SYSTEM. DOWNSPOUT CONNECTIONS VARY BY TYPE AND LOCATION. SEE PLANS FOR DOWNSPOUT CONNECTION DETAILS.

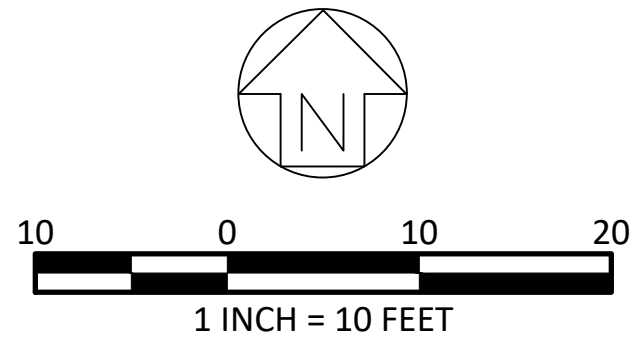

SITE LOCATION

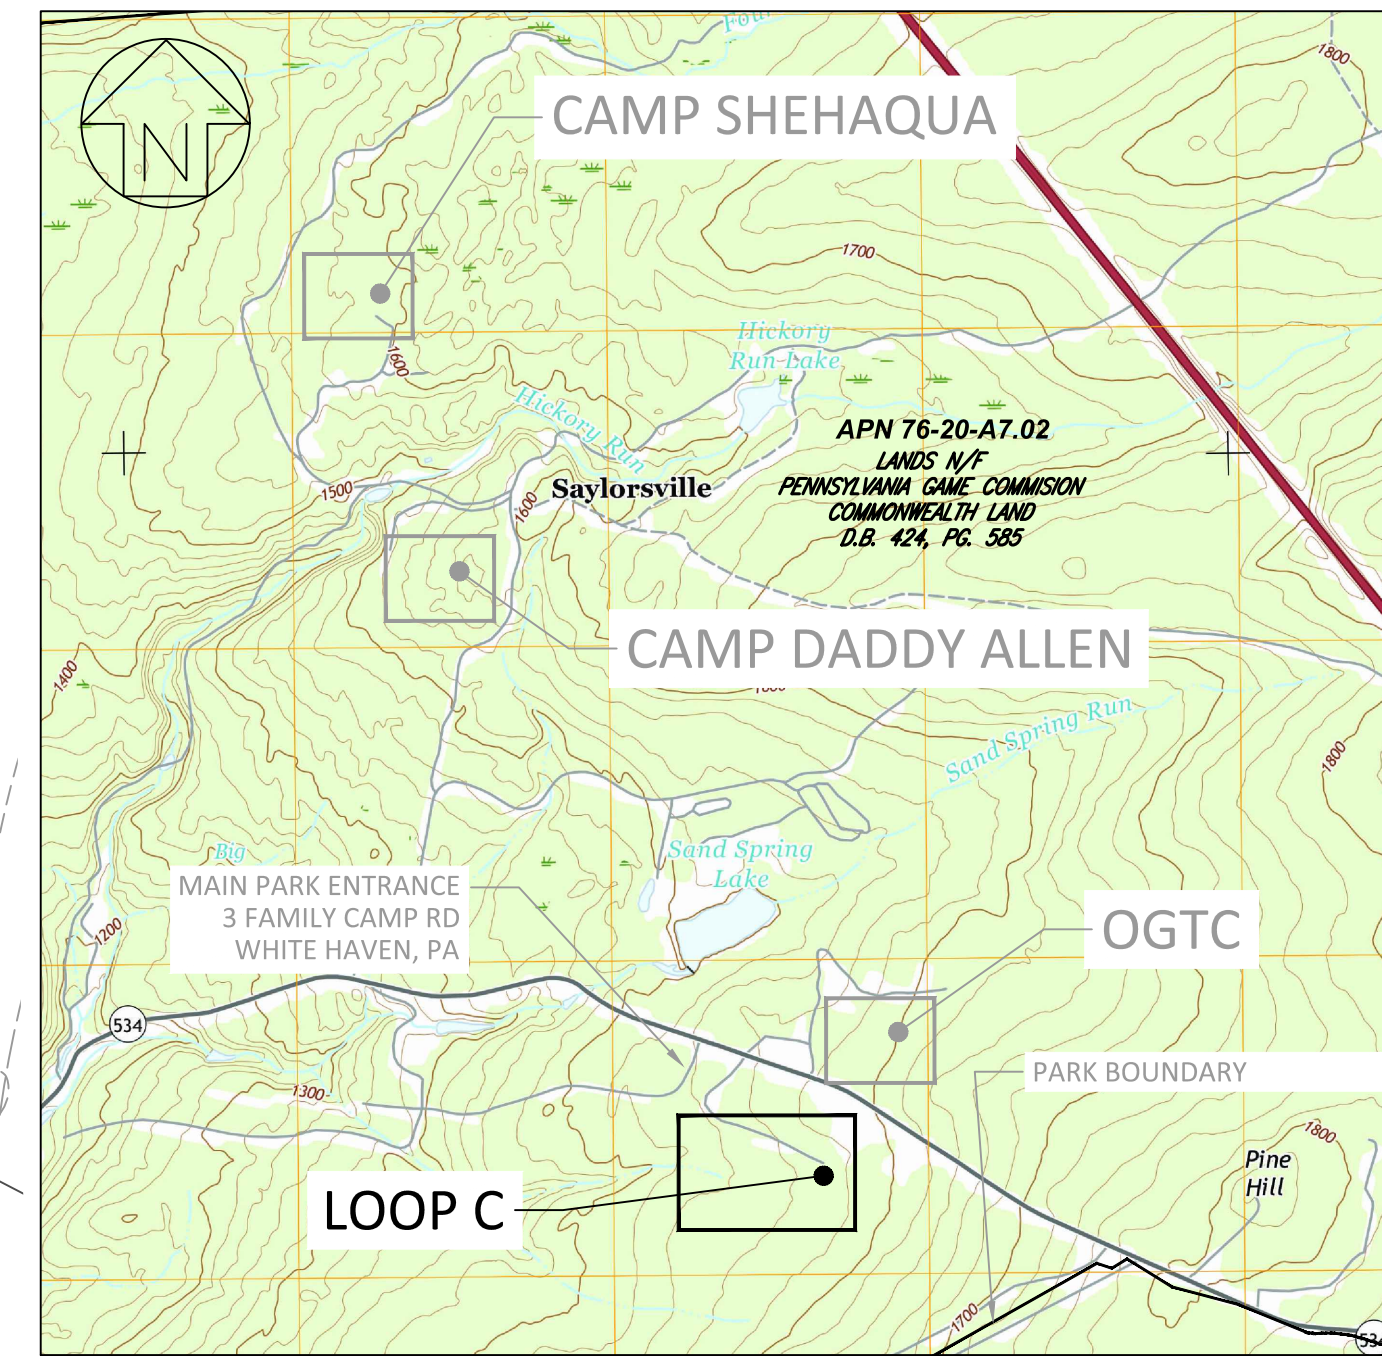

SCALE: 1" = 2000'

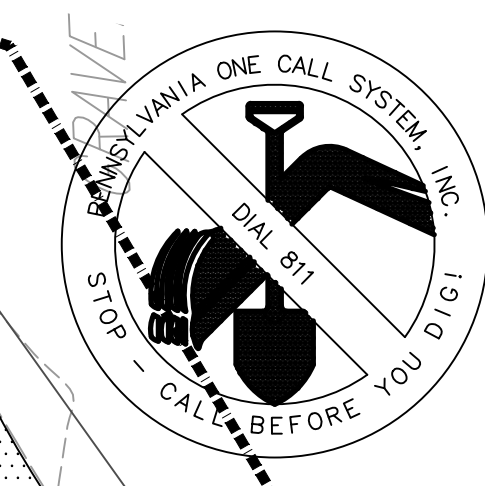

PA ONE CALL SERIAL NUMBER - 20202343070
 ALL LOCATIONS OF EXISTING UTILITIES SHOWN ON THIS PLAN HAVE BEEN DEVELOPED FROM EXISTING UTILITY RECORDS AND/OR ABOVE GROUND EXAMINATION OF THE SITE. COMPLETENESS OR ACCURACY OF LOCATION AND DEPTH OF UNDERGROUND UTILITIES OR STRUCTURES CANNOT BE GUARANTEED. CONTRACTOR MUST VERIFY LOCATION AND DEPTH OF ALL UNDERGROUND UTILITIES AND FACILITIES BEFORE START OF WORK PER PENNSYLVANIA ACT 287 OF 1974 AS AMENDED BY ACT 199 OF 2004 OR LATER.

CONSTRUCTION DOCUMENTS



NO.	REVISION

RECORD REVISIONS

MARC B. HENDERSON
 ENGINEER
 No. 08840
 PENNSYLVANIA

Signature: *Marc Henderson* DATE: 06/15/22

SMP ARCHITECTS
 1600 WALNUT STREET, SECOND FLOOR
 PHILADELPHIA, PENNSYLVANIA

COMMONWEALTH OF PENNSYLVANIA
 DEPARTMENT OF GENERAL SERVICES
 HARRISBURG, PENNSYLVANIA

D.G.S. PROJECT No.
C-114-0006 PHASE 1

HICKORY RUN STATE PARK
LATRINE IMPROVEMENTS
 DEPT of CONSERVATION AND NATURAL RESOURCES
 WHITE HAVEN, CARBON COUNTY, PA

STORMWATER AND GRADING PLAN -
CAMP LOOP C


CONTRACTOR SHALL FIELD VERIFY ALL DIMENSIONS. VARIANCE FROM CONTRACT DOCUMENTS NOT PERMITTED WITHOUT PROFESSIONAL & BUREAU OF CONSTRUCTION APPROVAL.

DRAWN BY L GILL	DATE 06/17/2022	DRAWING No. C-5
CHECKED BY M HENDERSON	SCALE AS NOTED	

VERIFY SCALE



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IF BAR IS NOT ONE (1) INCH LONG, ADJUST SCALE ACCORDINGLY

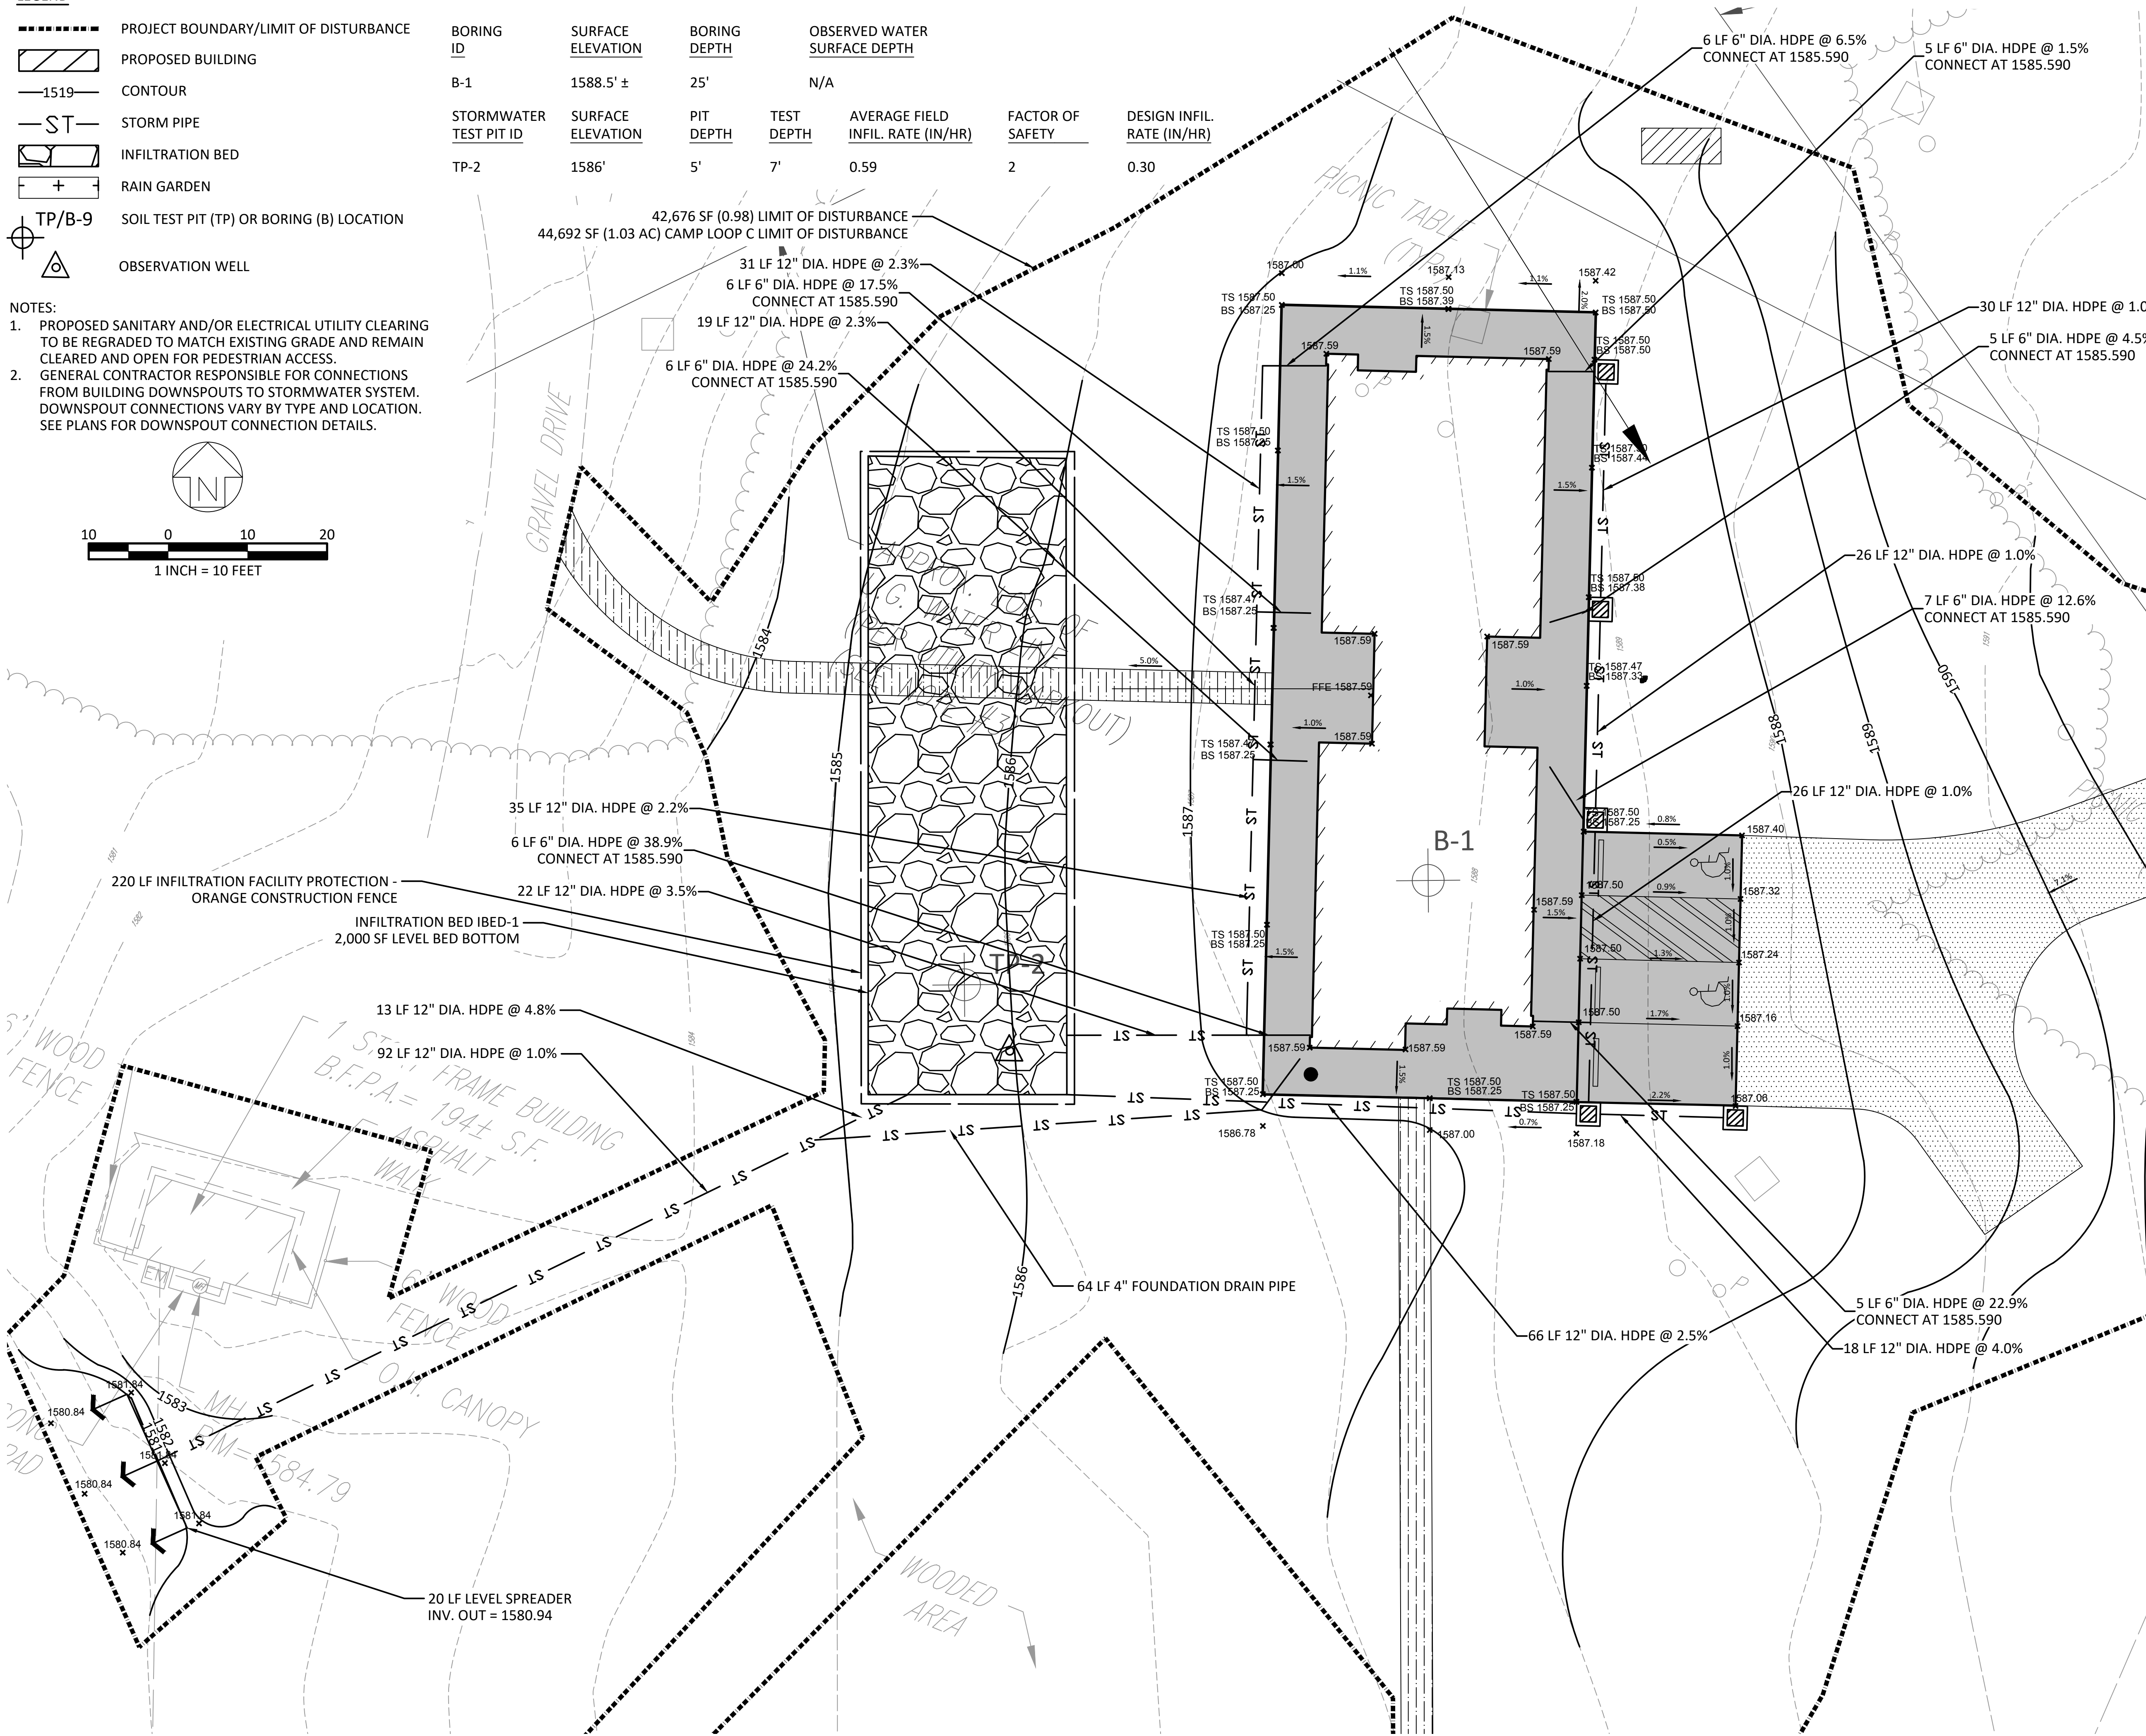


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 PLOTTED BY: Laura L. Gill
 PLOTTED: 2022.06.13 10:43 AM
 LAST SAVED: 2022.06.13 10:43 AM

- LEGEND**
- PROJECT BOUNDARY/LIMIT OF DISTURBANCE
 - PROPOSED CONCRETE
 - ▨ PROPOSED DRIVING SURFACE AGGREGATE
 - ▩ PROPOSED RAIN GARDEN SEED MIX
 - ▧ PROPOSED LANDSCAPE RESTORATION
 - ▦ PROPOSED TRAIL SURFACE AGGREGATE

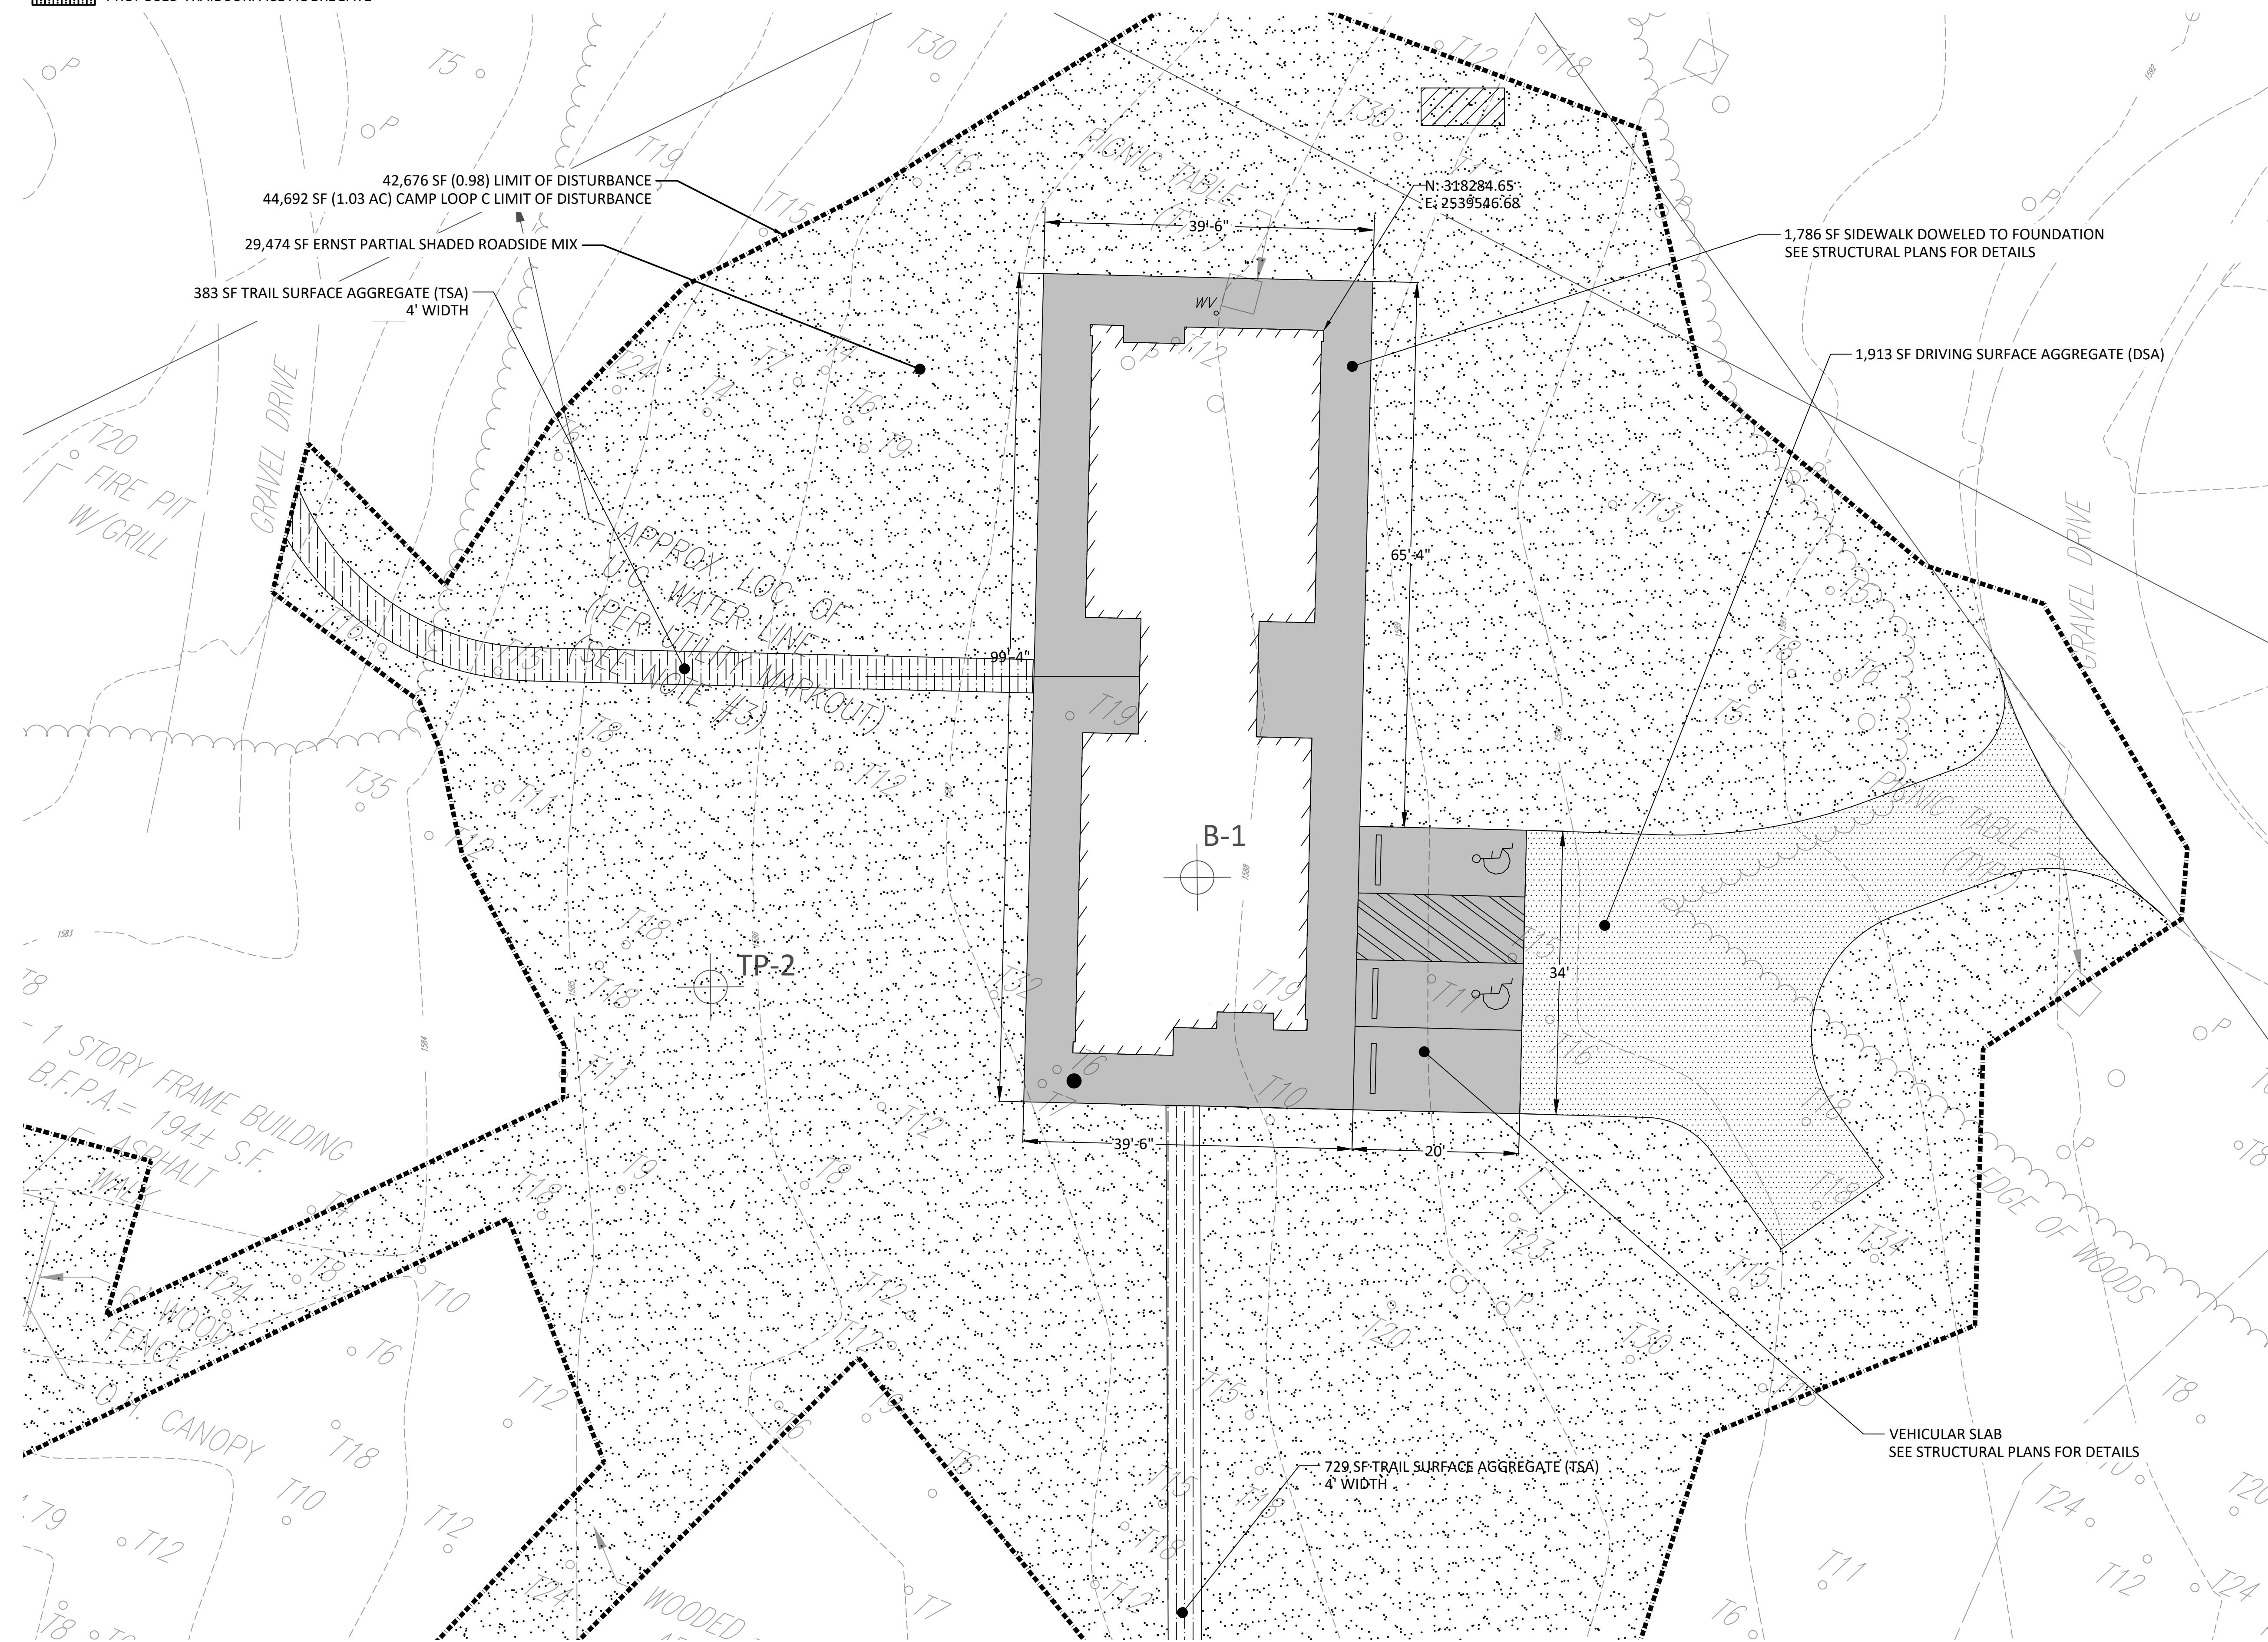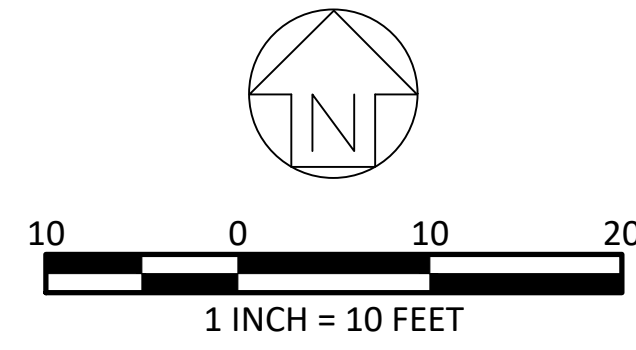

SITE LOCATION

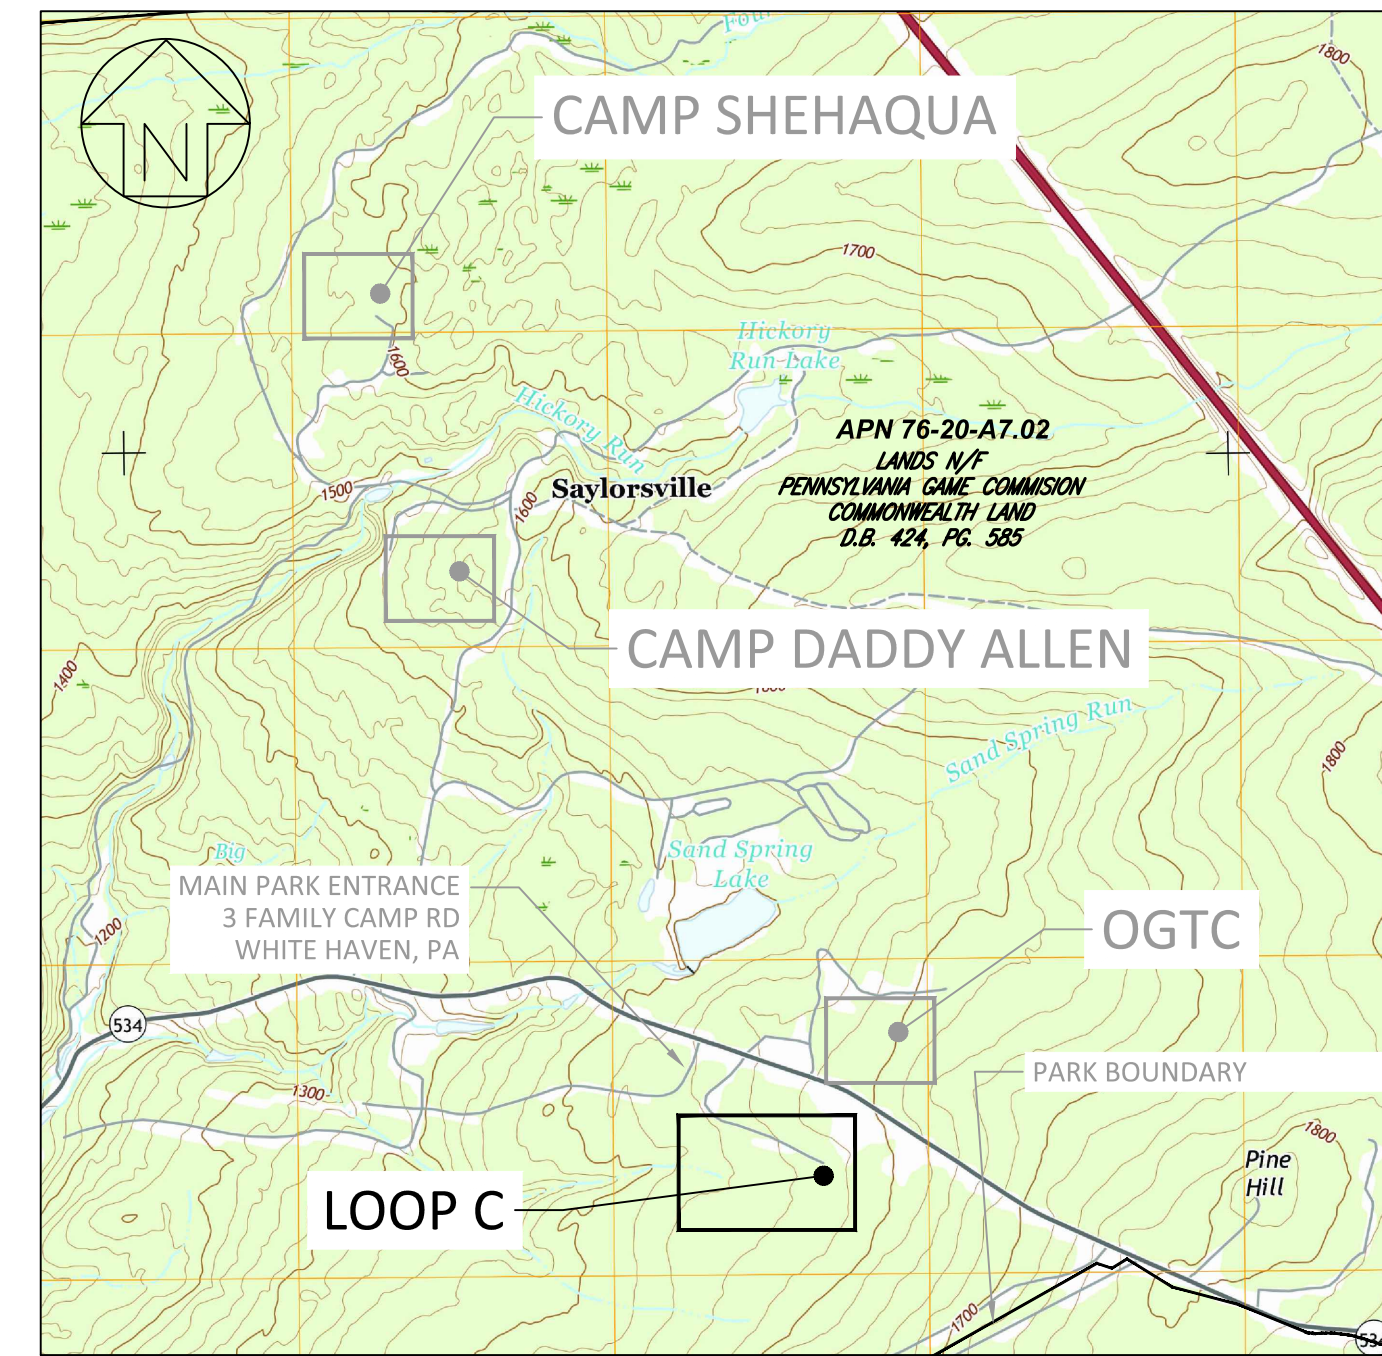

CONSTRUCTION DOCUMENTS



RECORD REVISIONS

SIGNATURE: *Marc Henderson* DATE: 06/15/22

SMP ARCHITECTS
1600 WALNUT STREET, SECOND FLOOR
PHILADELPHIA, PENNSYLVANIA

COMMONWEALTH OF PENNSYLVANIA
DEPARTMENT OF GENERAL SERVICES
HARRISBURG, PENNSYLVANIA

D.G.S. PROJECT No. C-114-0006 PHASE 1
HICKORY RUN STATE PARK
LATRINE IMPROVEMENTS
DEPT of CONSERVATION AND NATURAL RESOURCES
WHITE HAVEN, CARBON COUNTY, PA

SITE PLAN - CAMP LOOP C

CONTRACTOR SHALL FIELD VERIFY ALL DIMENSIONS. VARIANCE FROM CONTRACT DOCUMENTS NOT PERMITTED WITHOUT PROFESSIONAL & BUREAU OF CONSTRUCTION APPROVAL.	DRAWN BY L GILL	DATE 06/17/2022	DRAWING No. C-6
	CHECKED BY M HENDERSON	SCALE AS NOTED	



VERIFY SCALE

BAR IS ONE (1) INCH LONG ON ORIGINAL DRAWING:

IF BAR IS NOT ONE (1) INCH LONG, ADJUST SCALE ACCORDINGLY


FILE PATH: I:\2020\09077 - Hickory Run State Park\CAD\Shehaqua\2027 - LATRINE PLAN.dwg LAYOUT TAB: SITE PLAN - CAMP LOOP C PLOTTED BY: Laura L. Gill LAST SAVED: 2022.05.05 11:02 AM PLOTTED: 2022.06.15 04:19 PM

- LEGEND**
- PROJECT BOUNDARY/LIMIT OF DISTURBANCE
 - PROPOSED CONCRETE
 - ▨ PROPOSED DRIVING SURFACE AGGREGATE
 - PROPOSED TRAIL SURFACE AGGREGATE
 - ⊙ SEWER MANHOLE
 - ⊙ SEWER CLEANOUT
 - - - - - PROPOSED WATER LINE
 - - - - - PROPOSED SANITARY SEWER LINE
 - - - - - PROPOSED ELECTRIC LINE
 - - - - - STORM PIPE

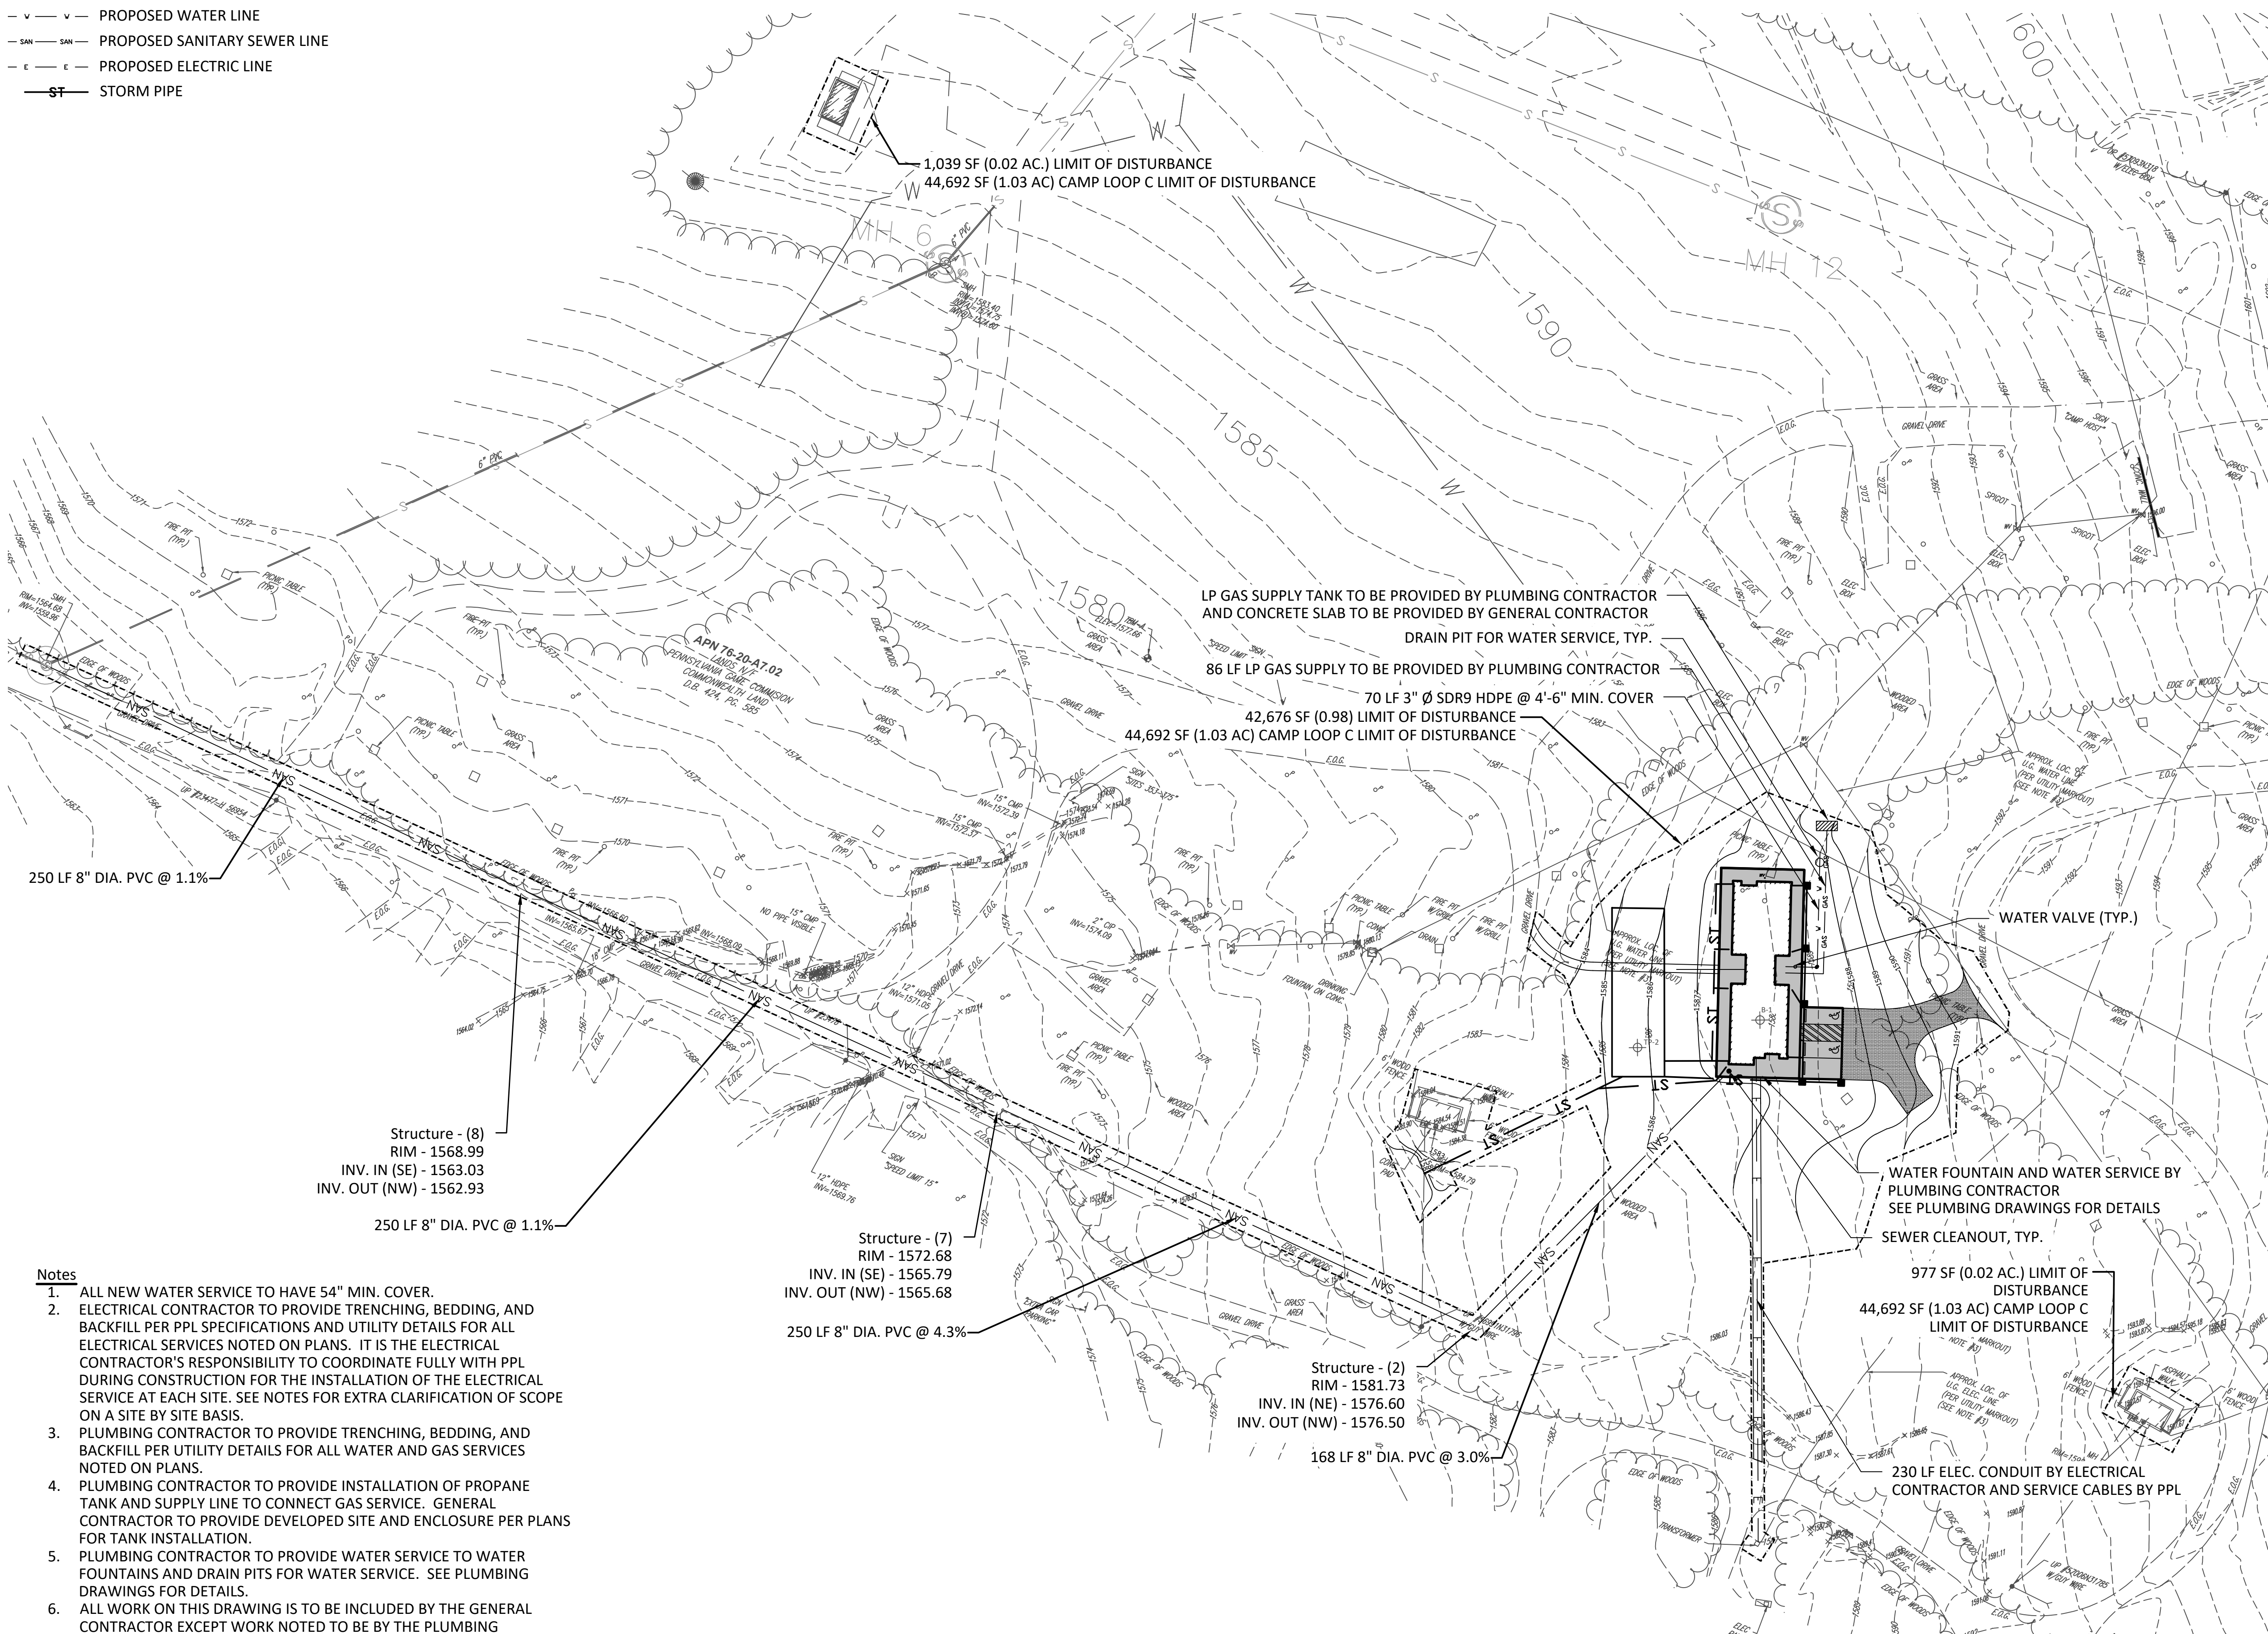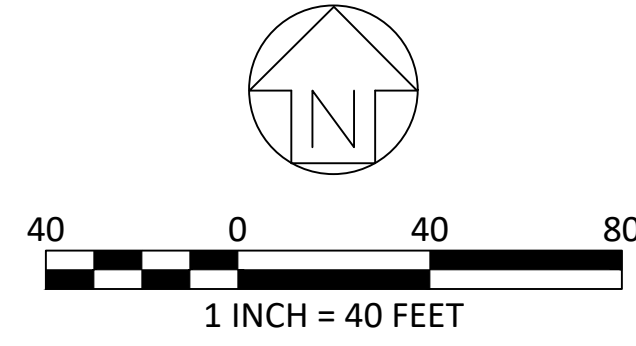

- Notes**
- ALL NEW WATER SERVICE TO HAVE 54" MIN. COVER.
 - ELECTRICAL CONTRACTOR TO PROVIDE TRENCHING, BEDDING, AND BACKFILL PER PPL SPECIFICATIONS AND UTILITY DETAILS FOR ALL ELECTRICAL SERVICES NOTED ON PLANS. IT IS THE ELECTRICAL CONTRACTOR'S RESPONSIBILITY TO COORDINATE FULLY WITH PPL DURING CONSTRUCTION FOR THE INSTALLATION OF THE ELECTRICAL SERVICE AT EACH SITE. SEE NOTES FOR EXTRA CLARIFICATION OF SCOPE ON A SITE BY SITE BASIS.
 - PLUMBING CONTRACTOR TO PROVIDE TRENCHING, BEDDING, AND BACKFILL PER UTILITY DETAILS FOR ALL WATER AND GAS SERVICES NOTED ON PLANS.
 - PLUMBING CONTRACTOR TO PROVIDE INSTALLATION OF PROPANE TANK AND SUPPLY LINE TO CONNECT GAS SERVICE. GENERAL CONTRACTOR TO PROVIDE DEVELOPED SITE AND ENCLOSURE PER PLANS FOR TANK INSTALLATION.
 - PLUMBING CONTRACTOR TO PROVIDE WATER SERVICE TO WATER FOUNTAINS AND DRAIN PITS FOR WATER SERVICE. SEE PLUMBING DRAWINGS FOR DETAILS.
 - ALL WORK ON THIS DRAWING IS TO BE INCLUDED BY THE GENERAL CONTRACTOR EXCEPT WORK NOTED TO BE BY THE PLUMBING CONTRACTOR OR ELECTRICAL CONTRACTOR.

SITE LOCATION

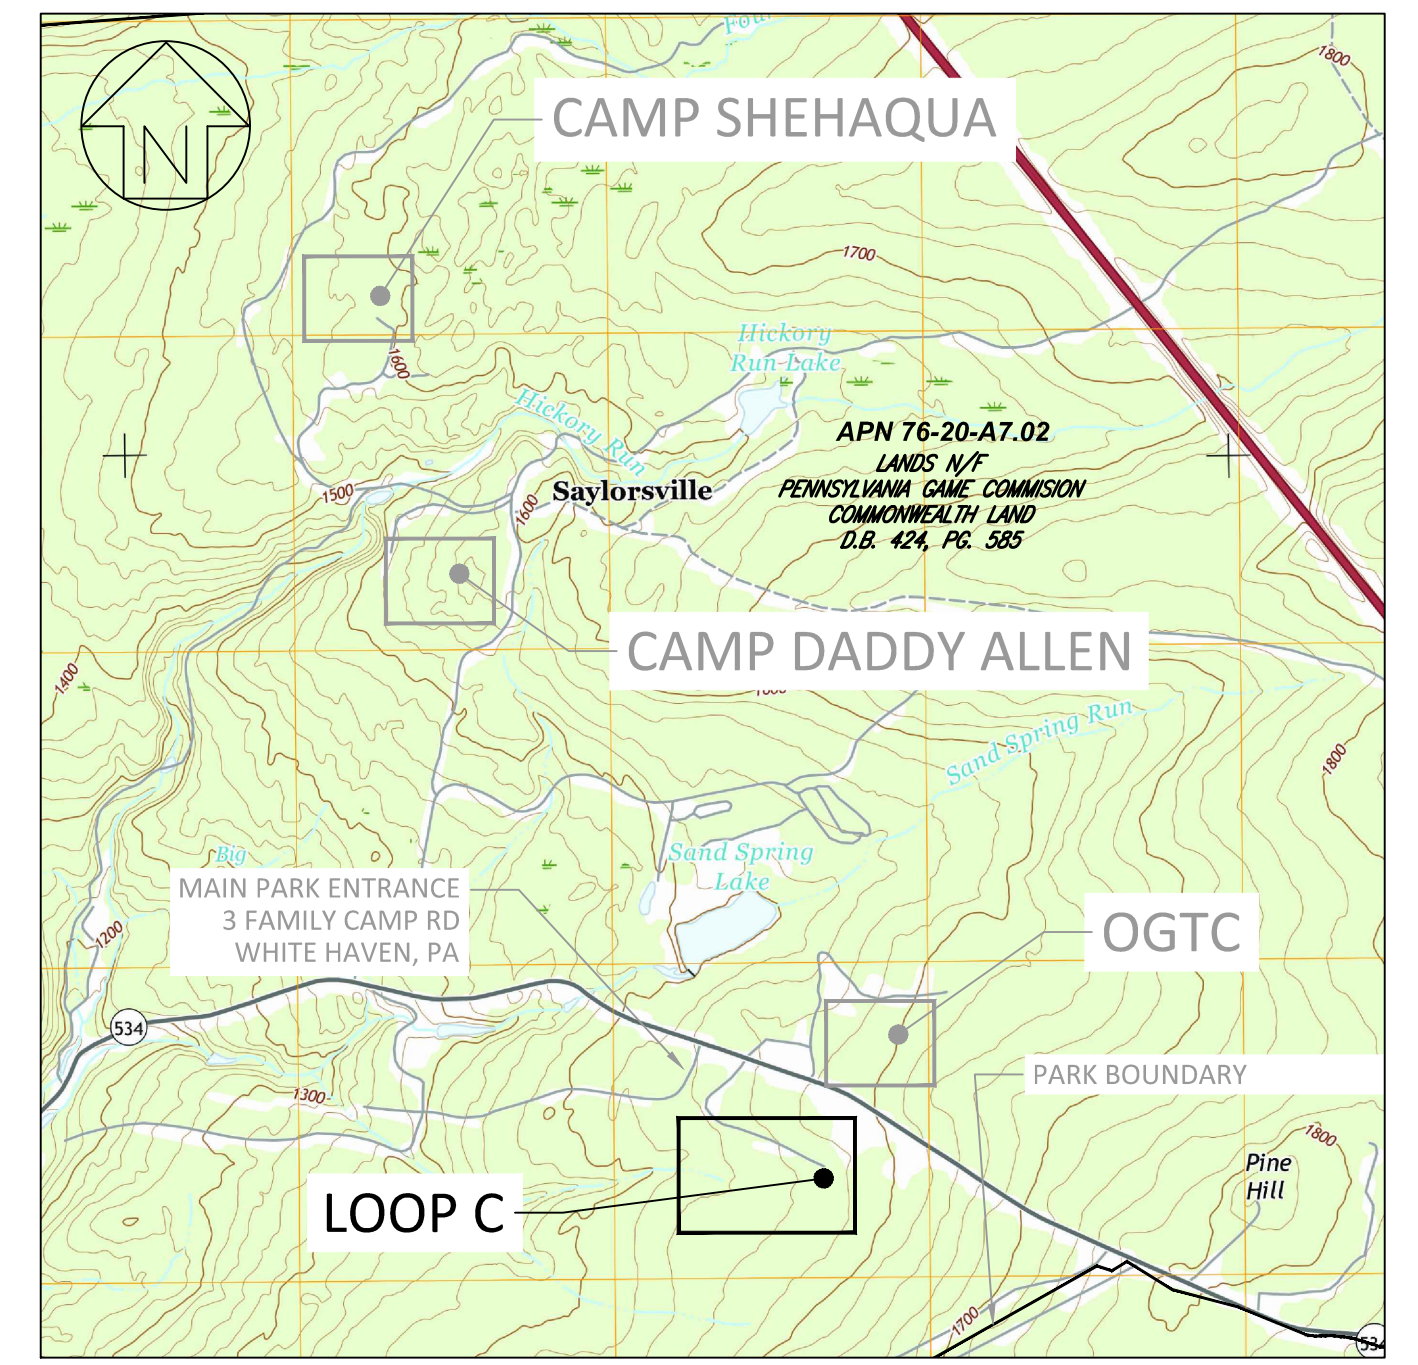

SCALE: 1" = 2000'

CONSTRUCTION DOCUMENTS



RECORD REVISIONS

SIGNATURE: *Marc B. Henderson* DATE: 06/15/22

SMP ARCHITECTS
1600 WALNUT STREET, SECOND FLOOR
PHILADELPHIA, PENNSYLVANIA

COMMONWEALTH OF PENNSYLVANIA
DEPARTMENT OF GENERAL SERVICES
HARRISBURG, PENNSYLVANIA

D.G.S. PROJECT No. C-114-0006 PHASE 1
HICKORY RUN STATE PARK
LATRINE IMPROVEMENTS
DEPT of CONSERVATION AND NATURAL RESOURCES
WHITE HAVEN, CARBON COUNTY, PA

UTILITY PLAN -
CAMP LOOP C

CONTRACTOR SHALL FIELD VERIFY ALL DIMENSIONS. VARIANCE FROM CONTRACT DOCUMENTS NOT PERMITTED WITHOUT PROFESSIONAL & BUREAU OF CONSTRUCTION APPROVAL.


DRAWN BY L GILL	DATE 06/17/2022	DRAWING No. CPE-7
CHECKED BY M HENDERSON	SCALE AS NOTED	20 OF 144

VERIFY SCALE


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IF BAR IS NOT ONE (1) INCH LONG, ADJUST SCALE ACCORDINGLY


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1 PROFILE VIEW
 CPE-8 CAMP LOOP C - SANITARY SEWER 1"=50' H, 1"=10' V

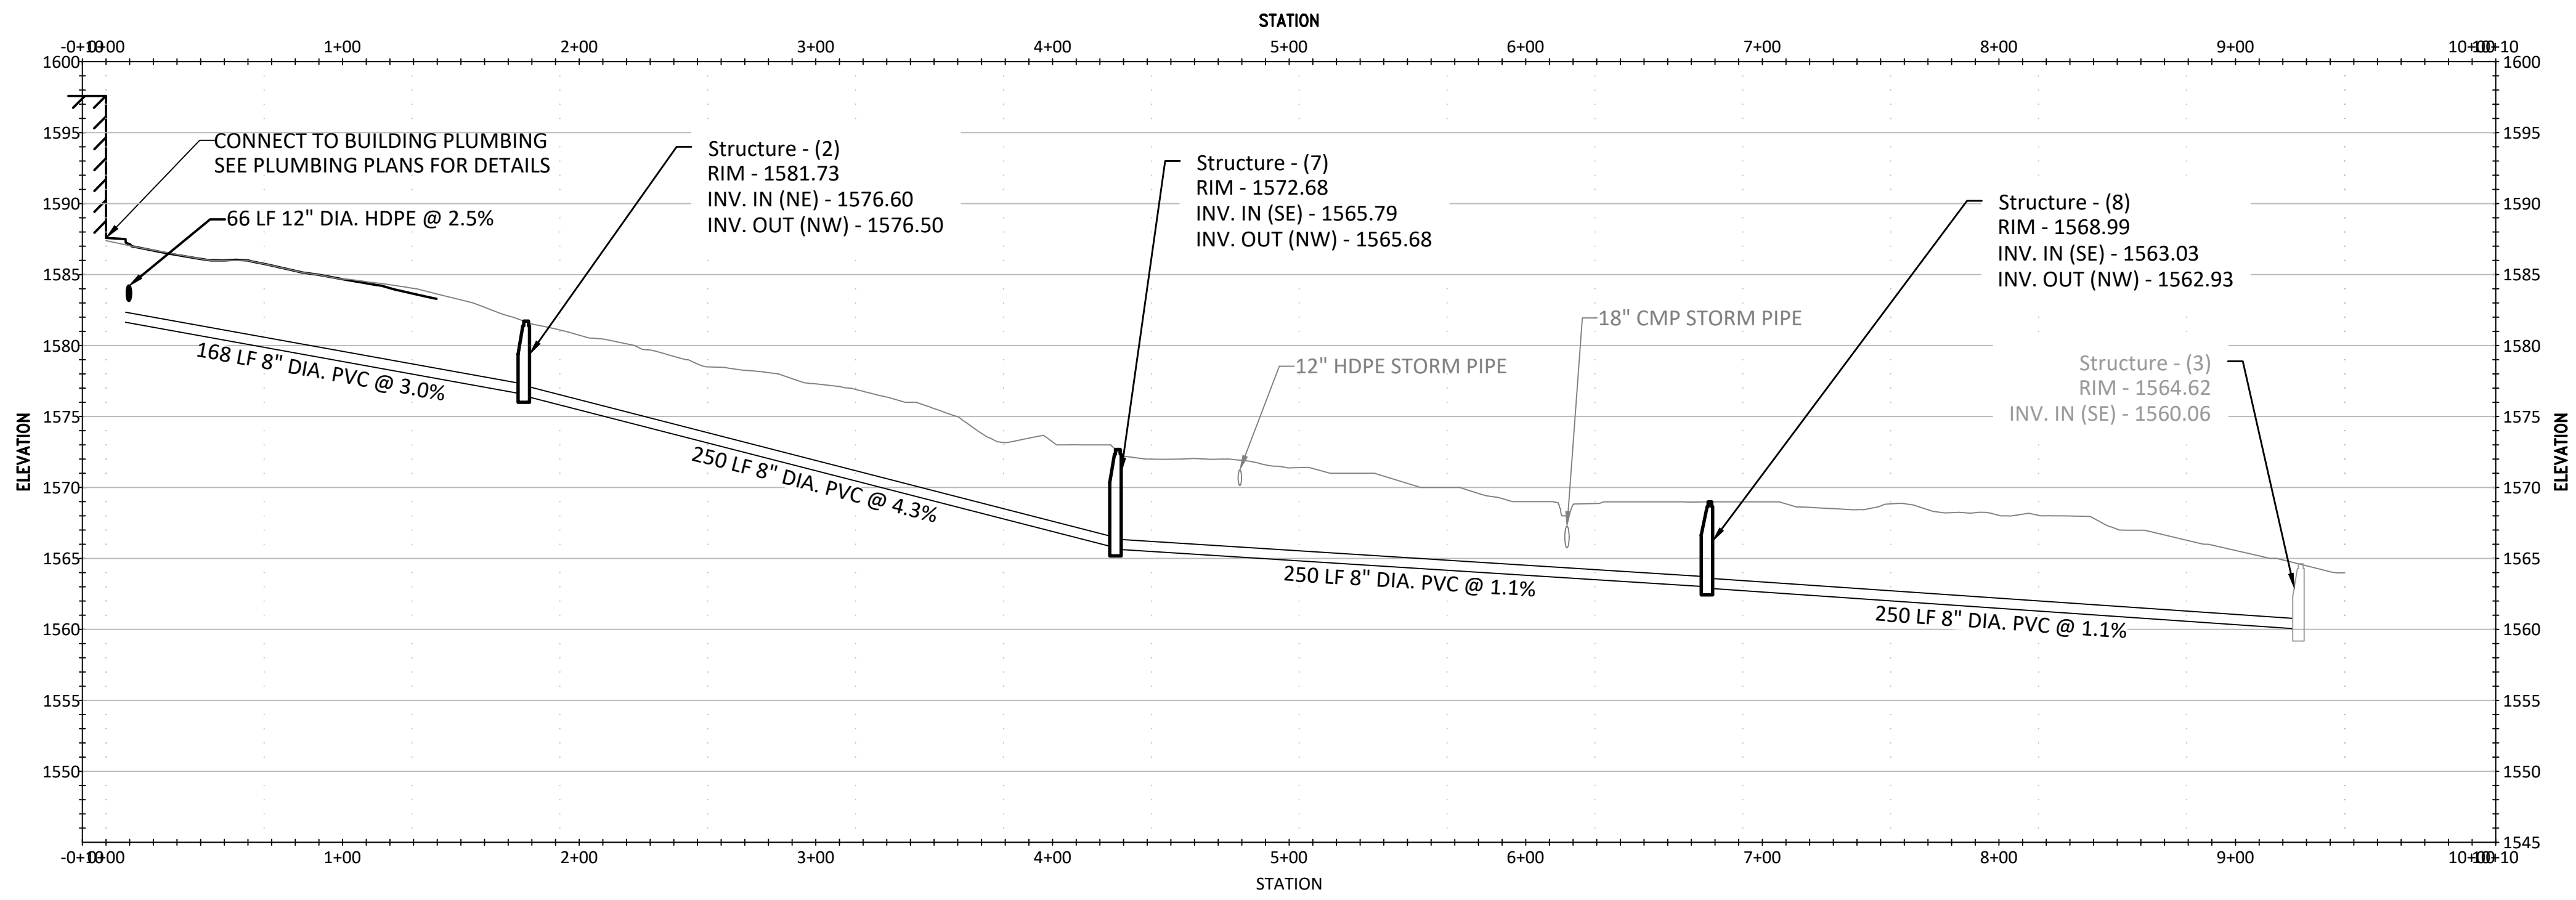

1 PROFILE VIEW
 CPE-8 CAMP LOOP C - ELECTRIC LINE 1"=50' H, 1"=10' V

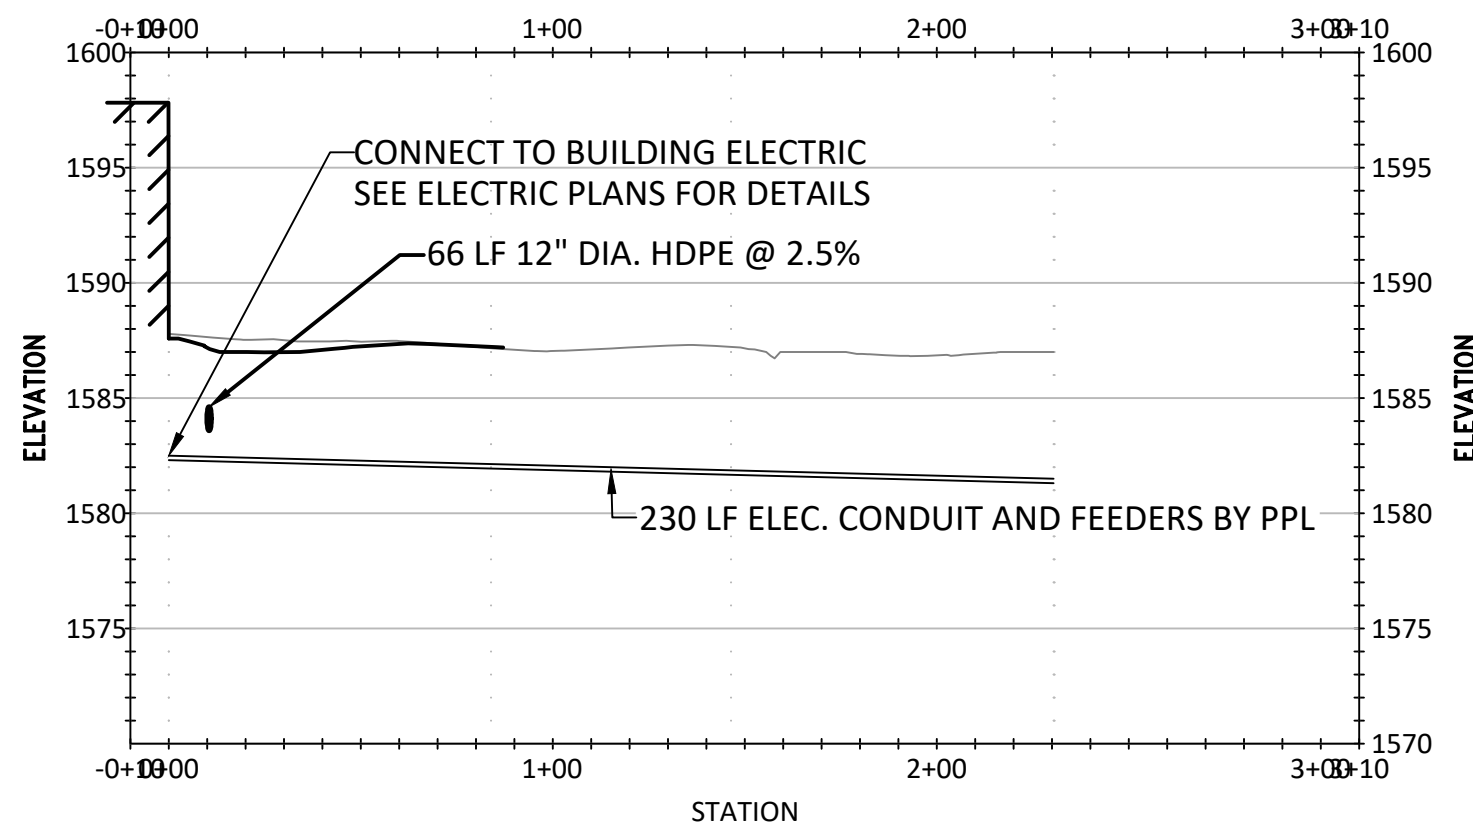

3 PROFILE VIEW
 CPE-8 CAMP LOOP C - WATER LINE 1"=50' H, 1"=10' V

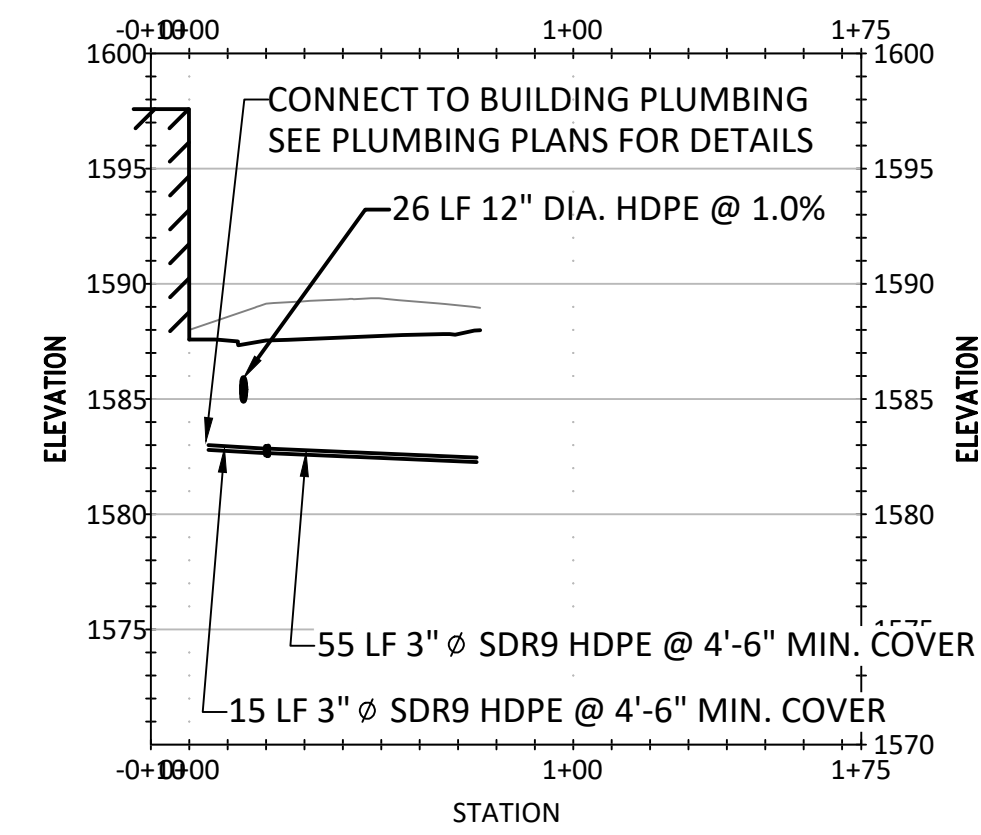
NOTES:

1. WATER AND SEWER LINES TO BE INSTALLED BELOW FROST DEPTH.
2. ALL WORK ON THIS DRAWING IS TO BE INCLUDED BY THE GENERAL CONTRACTOR EXCEPT WORK NOTED TO BE BY THE PLUMBING CONTRACTOR OR ELECTRICAL CONTRACTOR.

CONSTRUCTION DOCUMENTS



RECORD REVISIONS

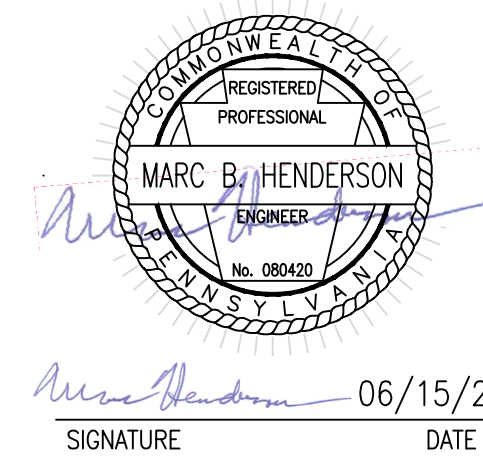

SMP ARCHITECTS
 1600 WALNUT STREET, SECOND FLOOR
 PHILADELPHIA, PENNSYLVANIA

COMMONWEALTH OF PENNSYLVANIA
 DEPARTMENT OF GENERAL SERVICES
 HARRISBURG, PENNSYLVANIA














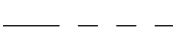

D.G.S. PROJECT No.
C-114-0006 PHASE 1





HICKORY RUN STATE PARK
LATRINE IMPROVEMENTS
 DEPT of CONSERVATION AND NATURAL RESOURCES
 WHITE HAVEN, CARBON COUNTY, PA

UTILITY PROFILES - CAMP LOOP C

VERIFY SCALE BAR IS ONE (1) INCH LONG ON ORIGINAL DRAWING: 0 1 IF BAR IS NOT ONE (1) INCH LONG, ADJUST SCALE ACCORDINGLY CONTRACTOR SHALL FIELD VERIFY ALL DIMENSIONS. VARIANCE FROM CONTRACT DOCUMENTS NOT PERMITTED WITHOUT PROFESSIONAL & BUREAU OF CONSTRUCTION APPROVAL.	DRAWN BY L GILL	DATE 06/17/2022	DRAWING No. CPE-8 21 OF 144
	CHECKED BY M HENDERSON	SCALE AS NOTED	

FILE PATH: I:\2020\0907 - Hickory Run State Park\CAD Sheets\2022\Utility Profiles.dwg PLOTTED BY: Laura L. Gill
 LAYOUT TAB: UTILITY PROFILES - CAMP LOOP C
 LAST SAVED: 2022.06.17 03:52 PM PLOTTED: 2022.06.17 04:16 PM

-  EXISTING 6" PVC GRAVITY SEWER
-  EXISTING WATER MAIN
-  EXISTING UTILITY POLE
-  EXISTING POWER LINE
-  EXISTING TREE
-  EXISTING CONTOUR
-  LEGAL RIGHT-OF-WAY LINE
-  EXISTING EDGE OF PAVEMENT
-  TEXT FOR EXISTING ITEMS
-  WOODS LINE
-  EXISTING STORM SEWER
-  EXISTING SANITARY MANHOLE
-  SOIL TEST PIT (TP) OR BORING (B) LOCATION
-  SLOPES 15%-25%
-  SLOPES >25%

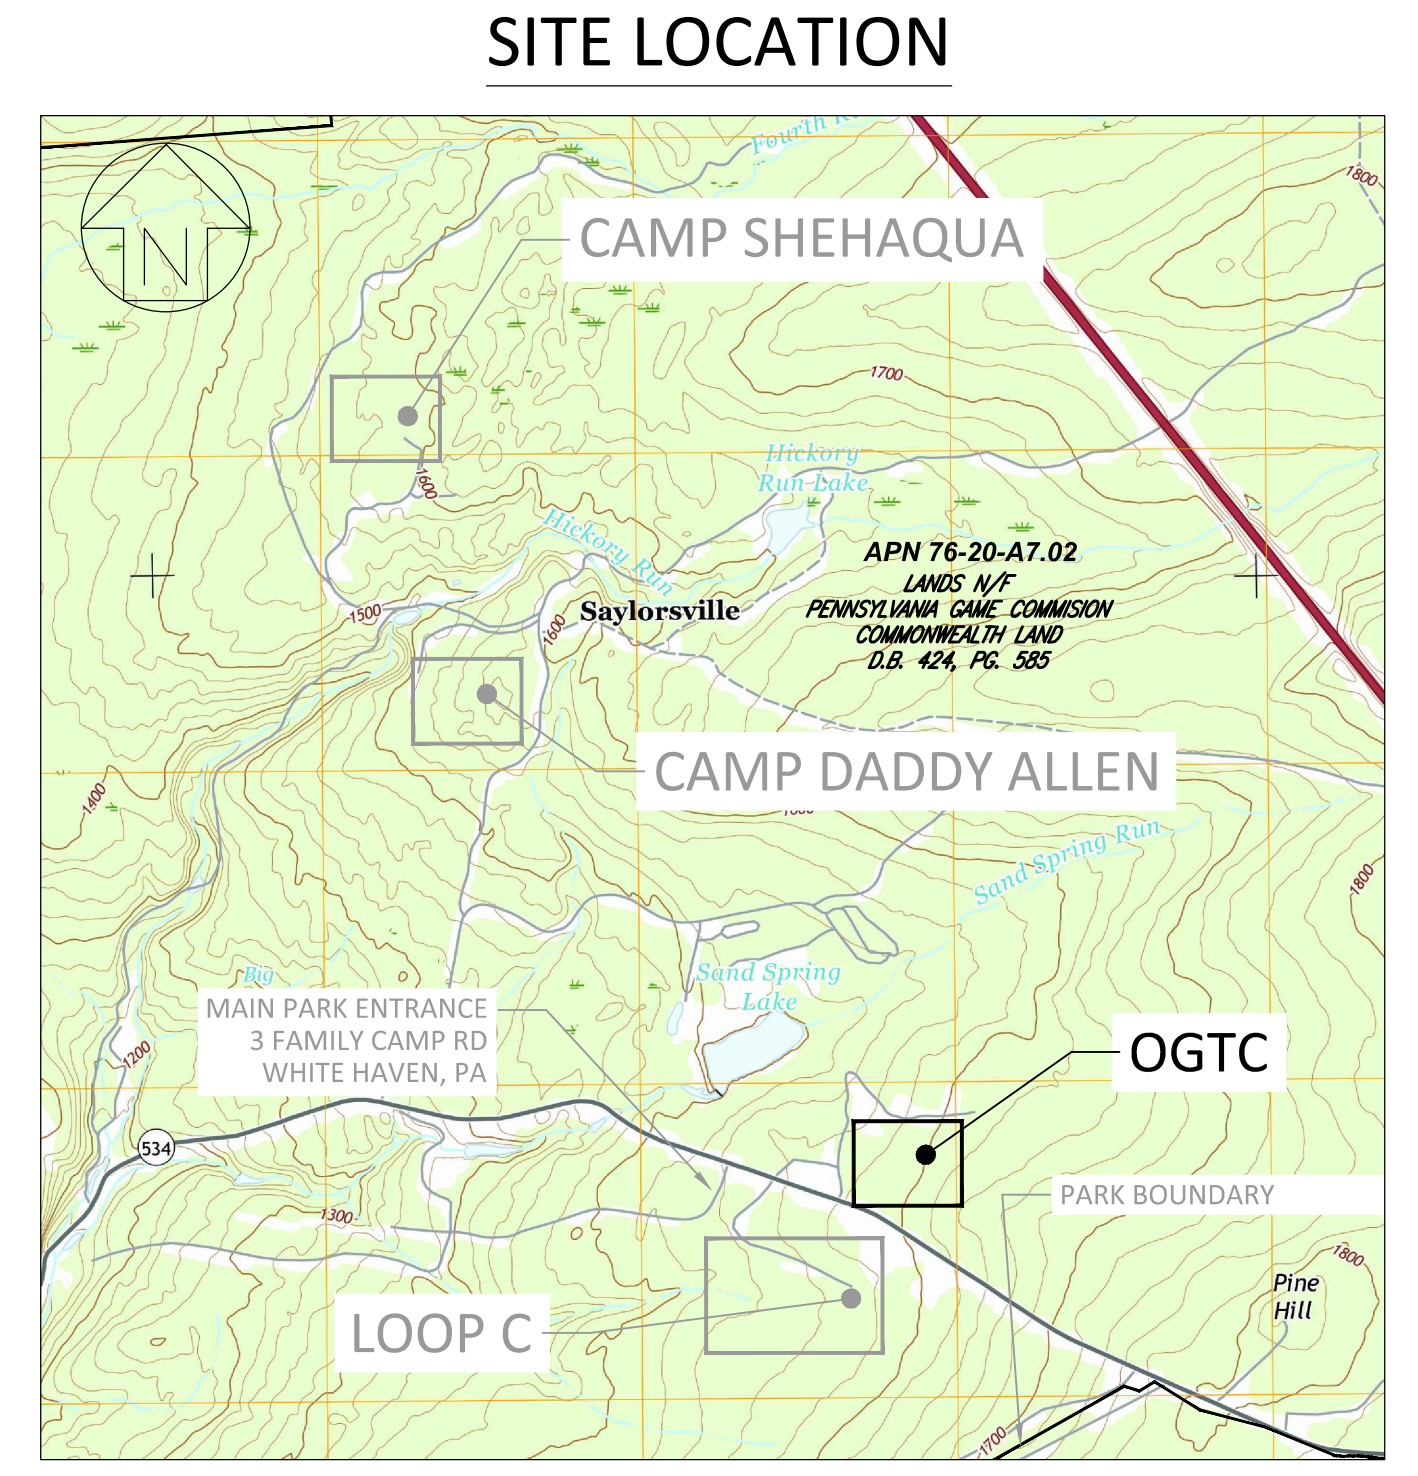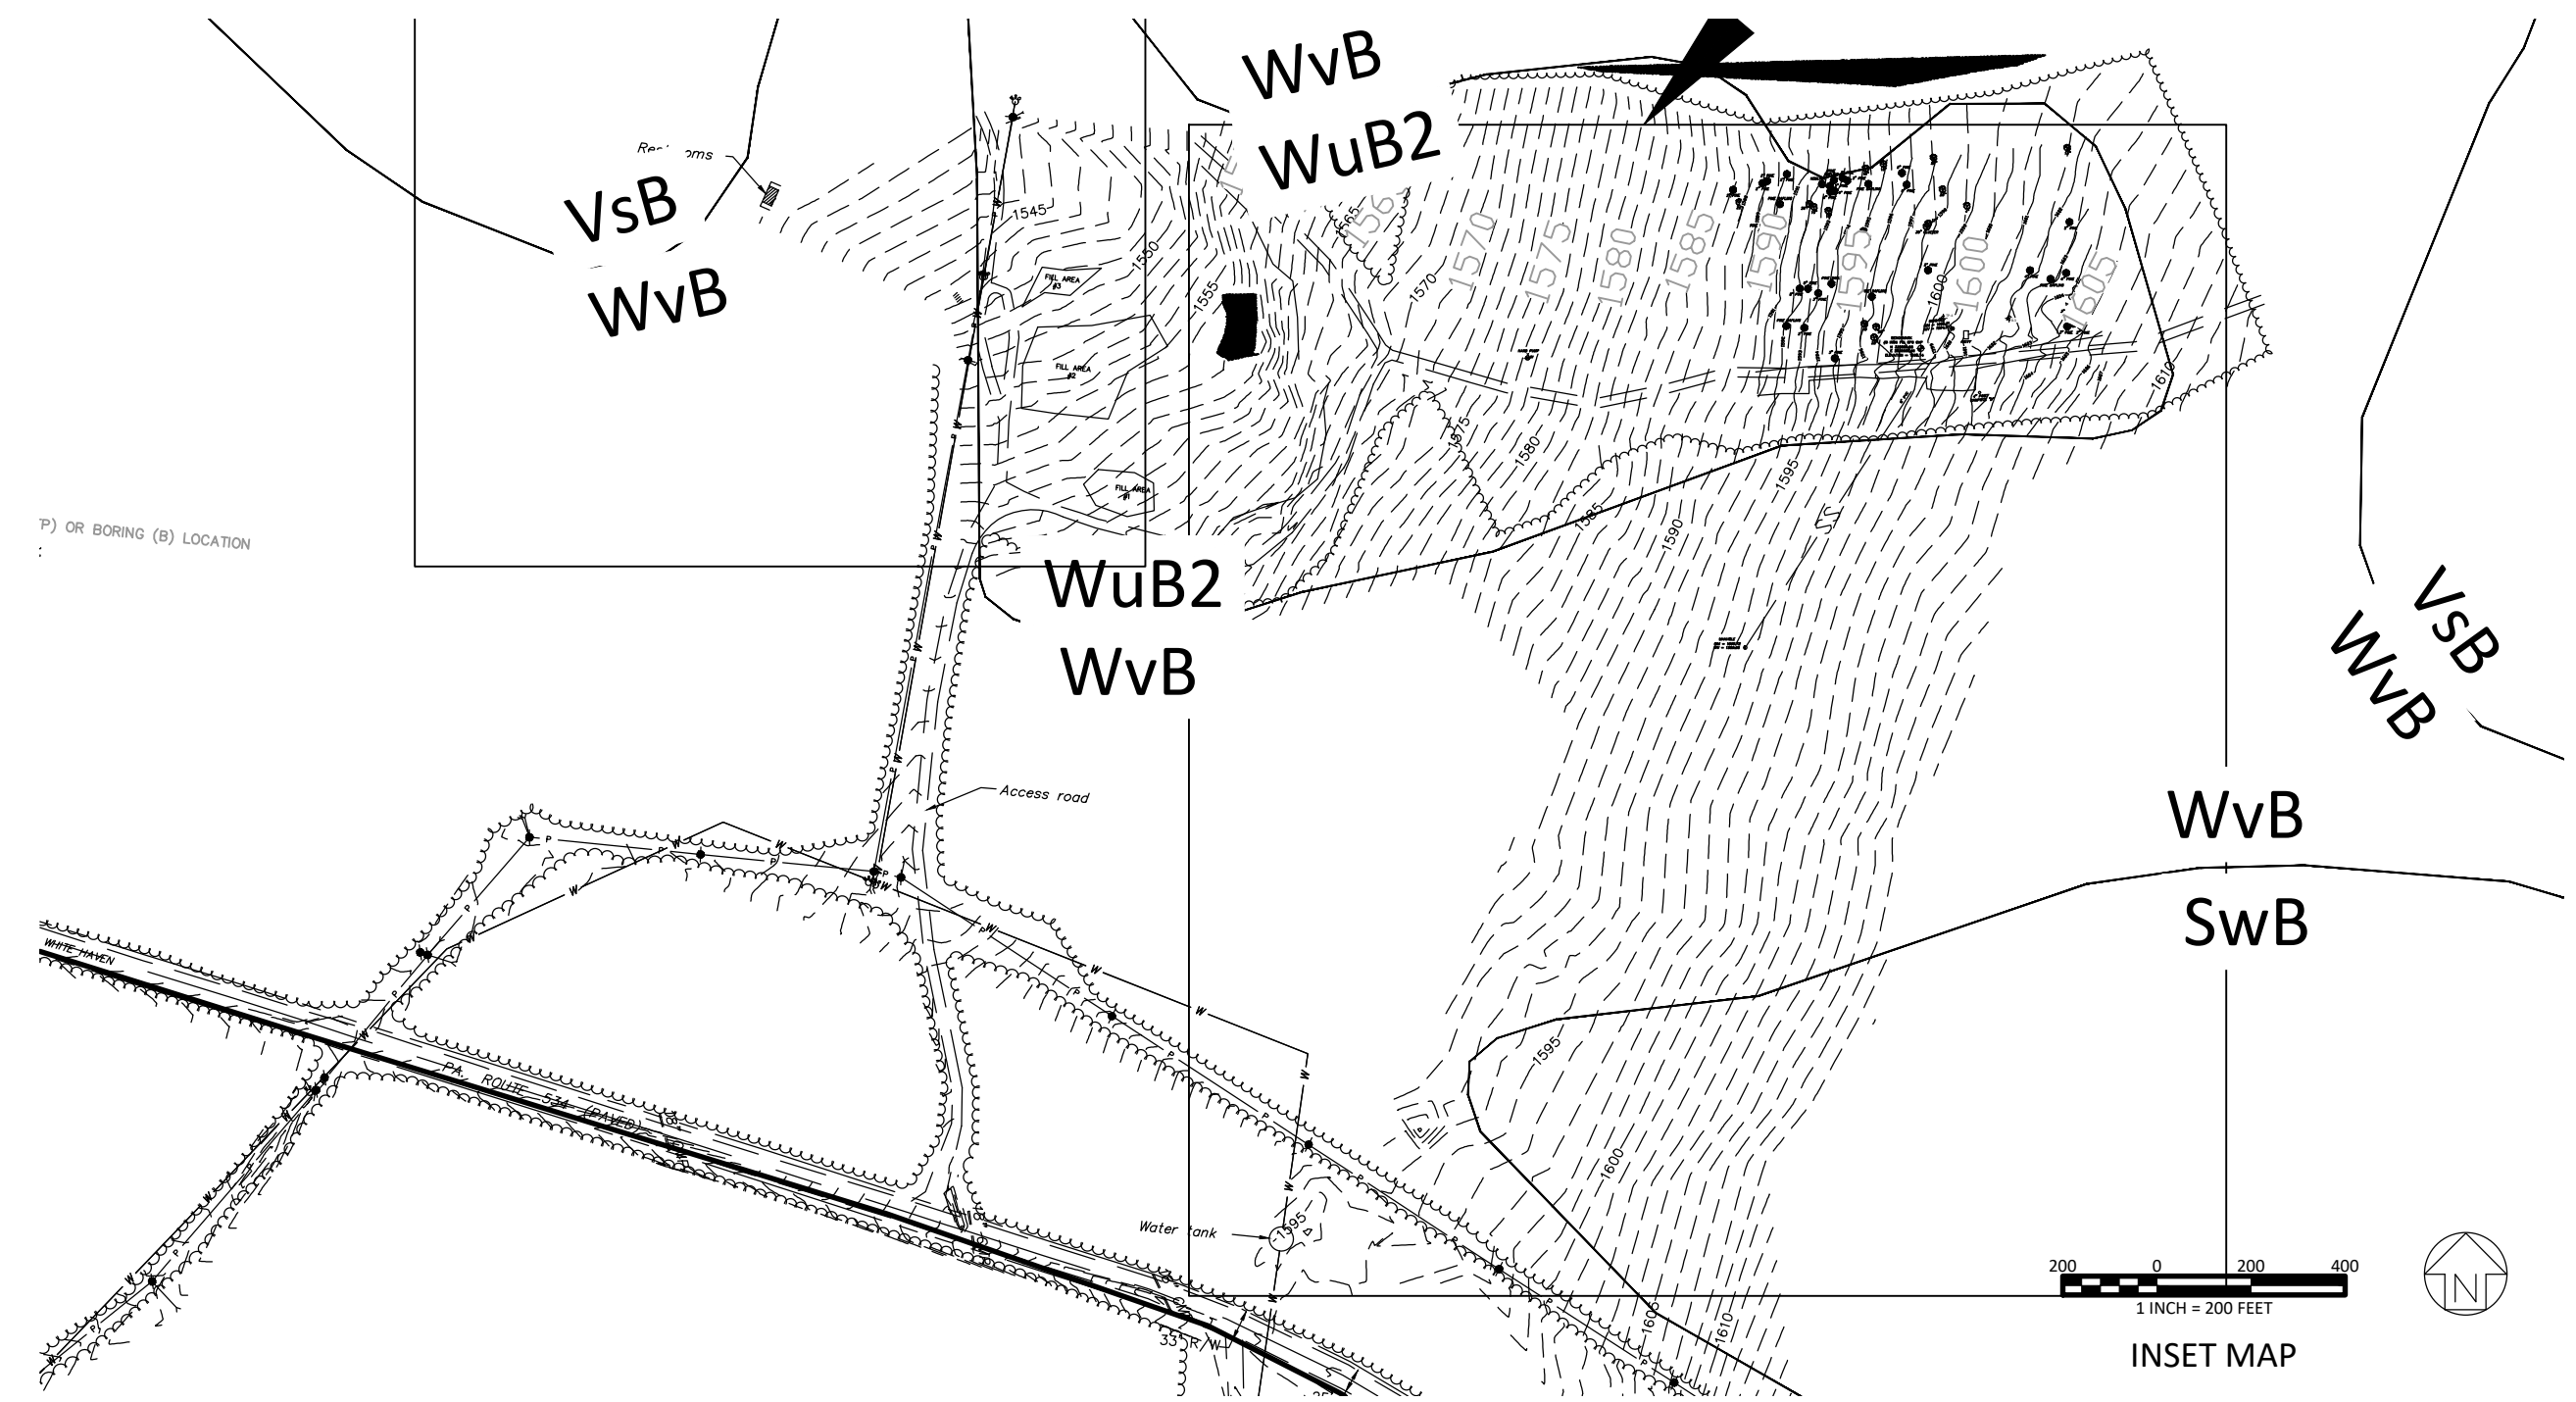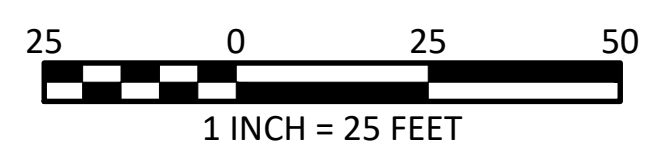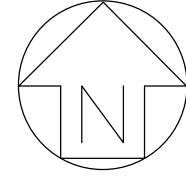

CONSTRUCTION DOCUMENTS



RECORD REVISIONS

Marc B. Henderson 06/15/22
SIGNATURE DATE

SMP ARCHITECTS
1600 WALNUT STREET, SECOND FLOOR
PHILADELPHIA, PENNSYLVANIA

COMMONWEALTH OF PENNSYLVANIA
DEPARTMENT OF GENERAL SERVICES
HARRISBURG, PENNSYLVANIA

D.G.S. PROJECT No.
C-114-0006 PHASE 1

HICKORY RUN STATE PARK
LATRINE IMPROVEMENTS
DEPT of CONSERVATION AND NATURAL RESOURCES
WHITE HAVEN, CARBON COUNTY, PA

EXISTING CONDITIONS PLAN -
OGTC

VERIFY SCALE

BAR IS ONE (1) INCH LONG ON ORIGINAL DRAWING:

IF BAR IS NOT ONE (1) INCH LONG, ADJUST SCALE ACCORDINGLY


CONTRACTOR SHALL FIELD VERIFY ALL DIMENSIONS. VARIANCE FROM CONTRACT DOCUMENTS NOT PERMITTED WITHOUT PROFESSIONAL & BUREAU OF CONSTRUCTION APPROVAL.

DRAWN BY	DATE	DRAWING No.
CHECKED BY	SCALE	C-9
	AS NOTED	22 OF 144

FILE PATH: I:\2020\0907 - Hickory Run State Park\CAD\Sheet Files\2027 - EXISTING CONDITIONS PLAN (05).dwg LAYOUT TAB: EXISTING CONDITIONS PLAN - OGTC
LAST SAVED: 2022.06.15 01:12 PM PLOTTED BY: Laura L. Gill



LEGEND

	PROJECT BOUNDARY/LIMIT OF DISTURBANCE
	TREE PROTECTION
	COMPOST SOCK
	CONSTRUCTION FENCE
	ROCK CONSTRUCTION ENTRANCE
	EROSION CONTROL BLANKET
	SEDIMENT TRAP
	INFILTRATION STAKE OUT FENCE
	NEW BUILDING

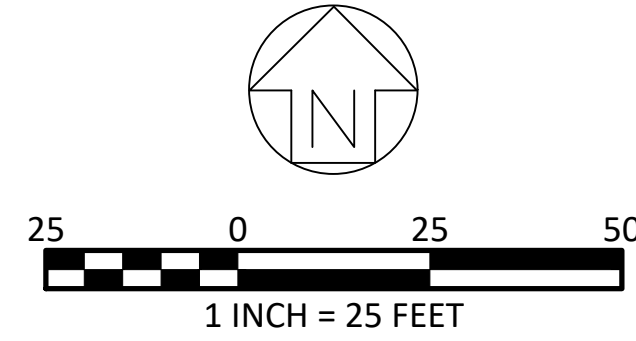

- NOTES:**
- NO EARTHMOVING ACTIVITIES OR CONSTRUCTION TRAFFIC SHALL OCCUR OVER PROPOSED INFILTRATION AREAS.
 - TYPE 2.D DOUBLE NET EROSION CONTROL BLANKET - PROCESSED DEGRADABLE NATURAL FIBERS MECHANICALLY BOUND TOGETHER BETWEEN TWO RAPIDLY DEGRADING, NATURAL FIBER NETS. NO SYNTHETIC FIBERS PERMITTED.
 - ALL BUILDING MATERIALS AND WASTES SHALL BE REMOVED FROM THE SITE AND RECYCLED OR DISPOSED OF IN ACCORDANCE WITH THE DEPARTMENT'S SOLID WASTE MANAGEMENT REGULATIONS AT 25 PA. CODE 260.1 ET SEQ., 271.1, AND 287.1 ET. SEQ. NO BUILDING MATERIALS OR WASTES OR UNUSED BUILDING MATERIALS SHALL BE BURNED, BURIED, DUMPED, OR DISCHARGED AT THE SITE.
 - ALL OFF-SITE WASTE AND BORROW AREAS MUST HAVE AN E&S PLAN APPROVED BY THE LOCAL CONSERVATION DISTRICT OR THE DEPARTMENT FULLY IMPLEMENTED PRIOR TO BEING ACTIVATED.
 - THE GENERAL CONTRACTOR IS RESPONSIBLE FOR ENSURING THAT ANY MATERIAL BROUGHT ON SITE IS CLEAN FILL. FORM FP-001 MUST BE RETAINED BY DCNR FOR ANY FILL MATERIAL AFFECTED BY A SPILL OR RELEASE OF A REGULATED SUBSTANCE BUT QUALIFYING AS CLEAN FILL DUE TO ANALYTICAL TESTING.

Map Unit Symbol	Map Unit Name	Rating
SwB	Swartswood very stony loam, 0 to 8 percent slopes	Somewhat Limited
WuB2	Wurtsboro channery loam, 3 to 8 percent slopes, moderately eroded	Very Limited
WvB	Wurtsboro very stony loam, 0 to 8 percent slopes	Somewhat Limited

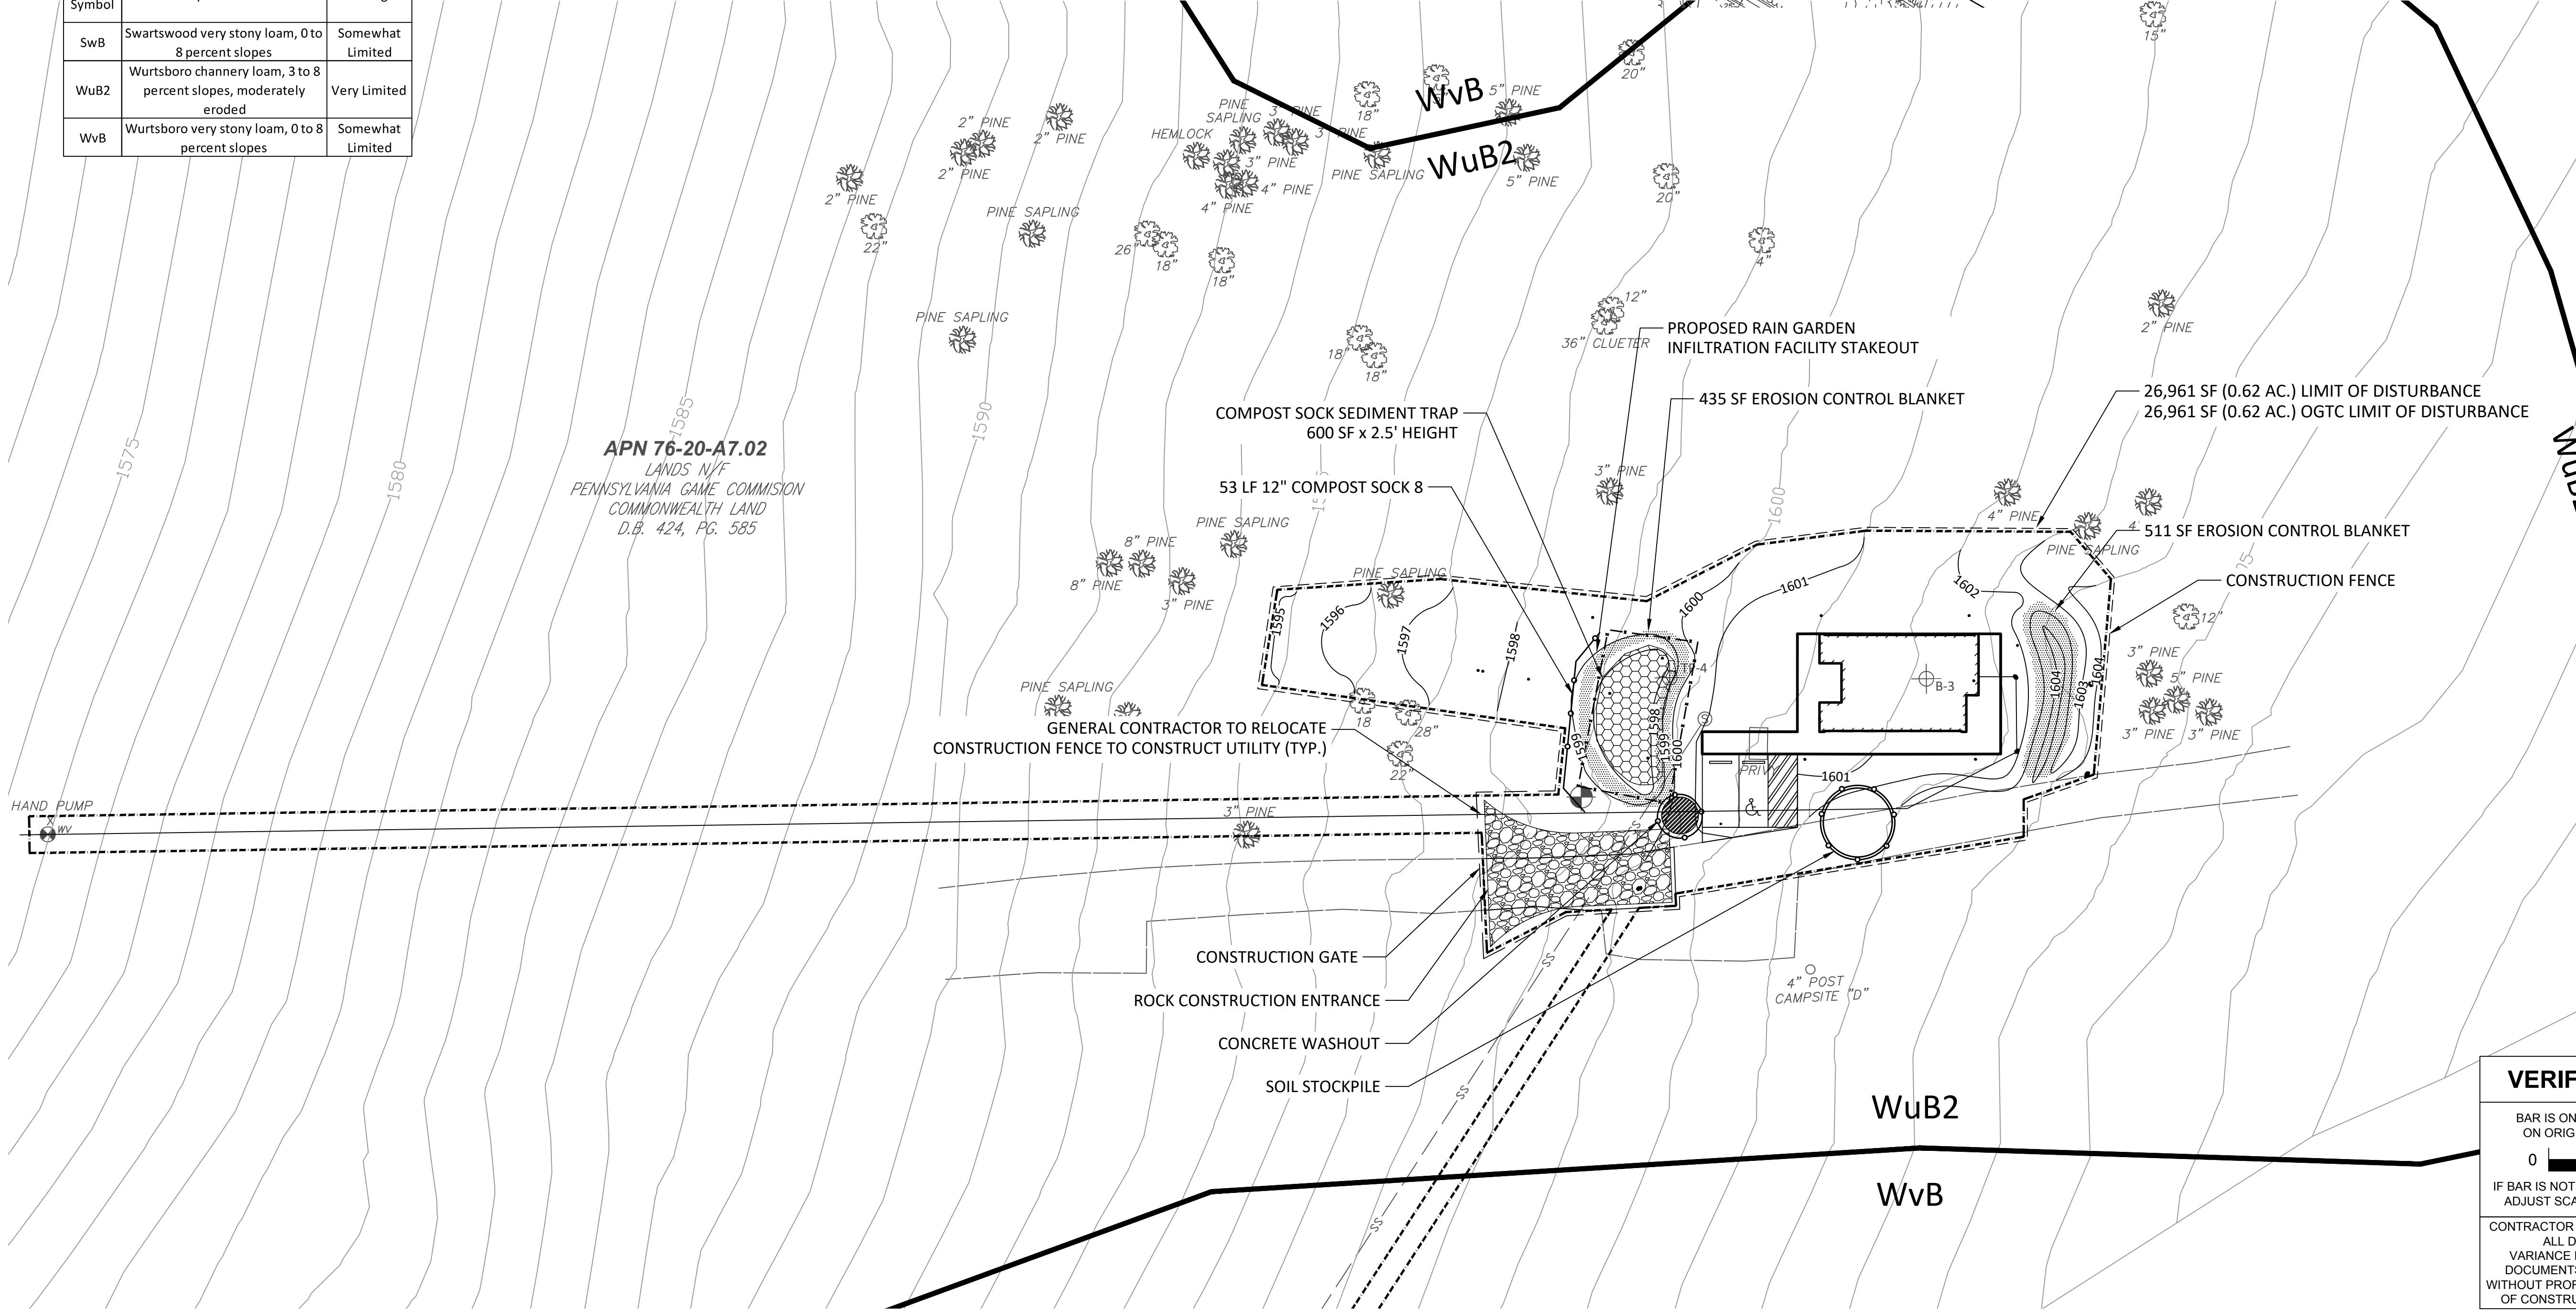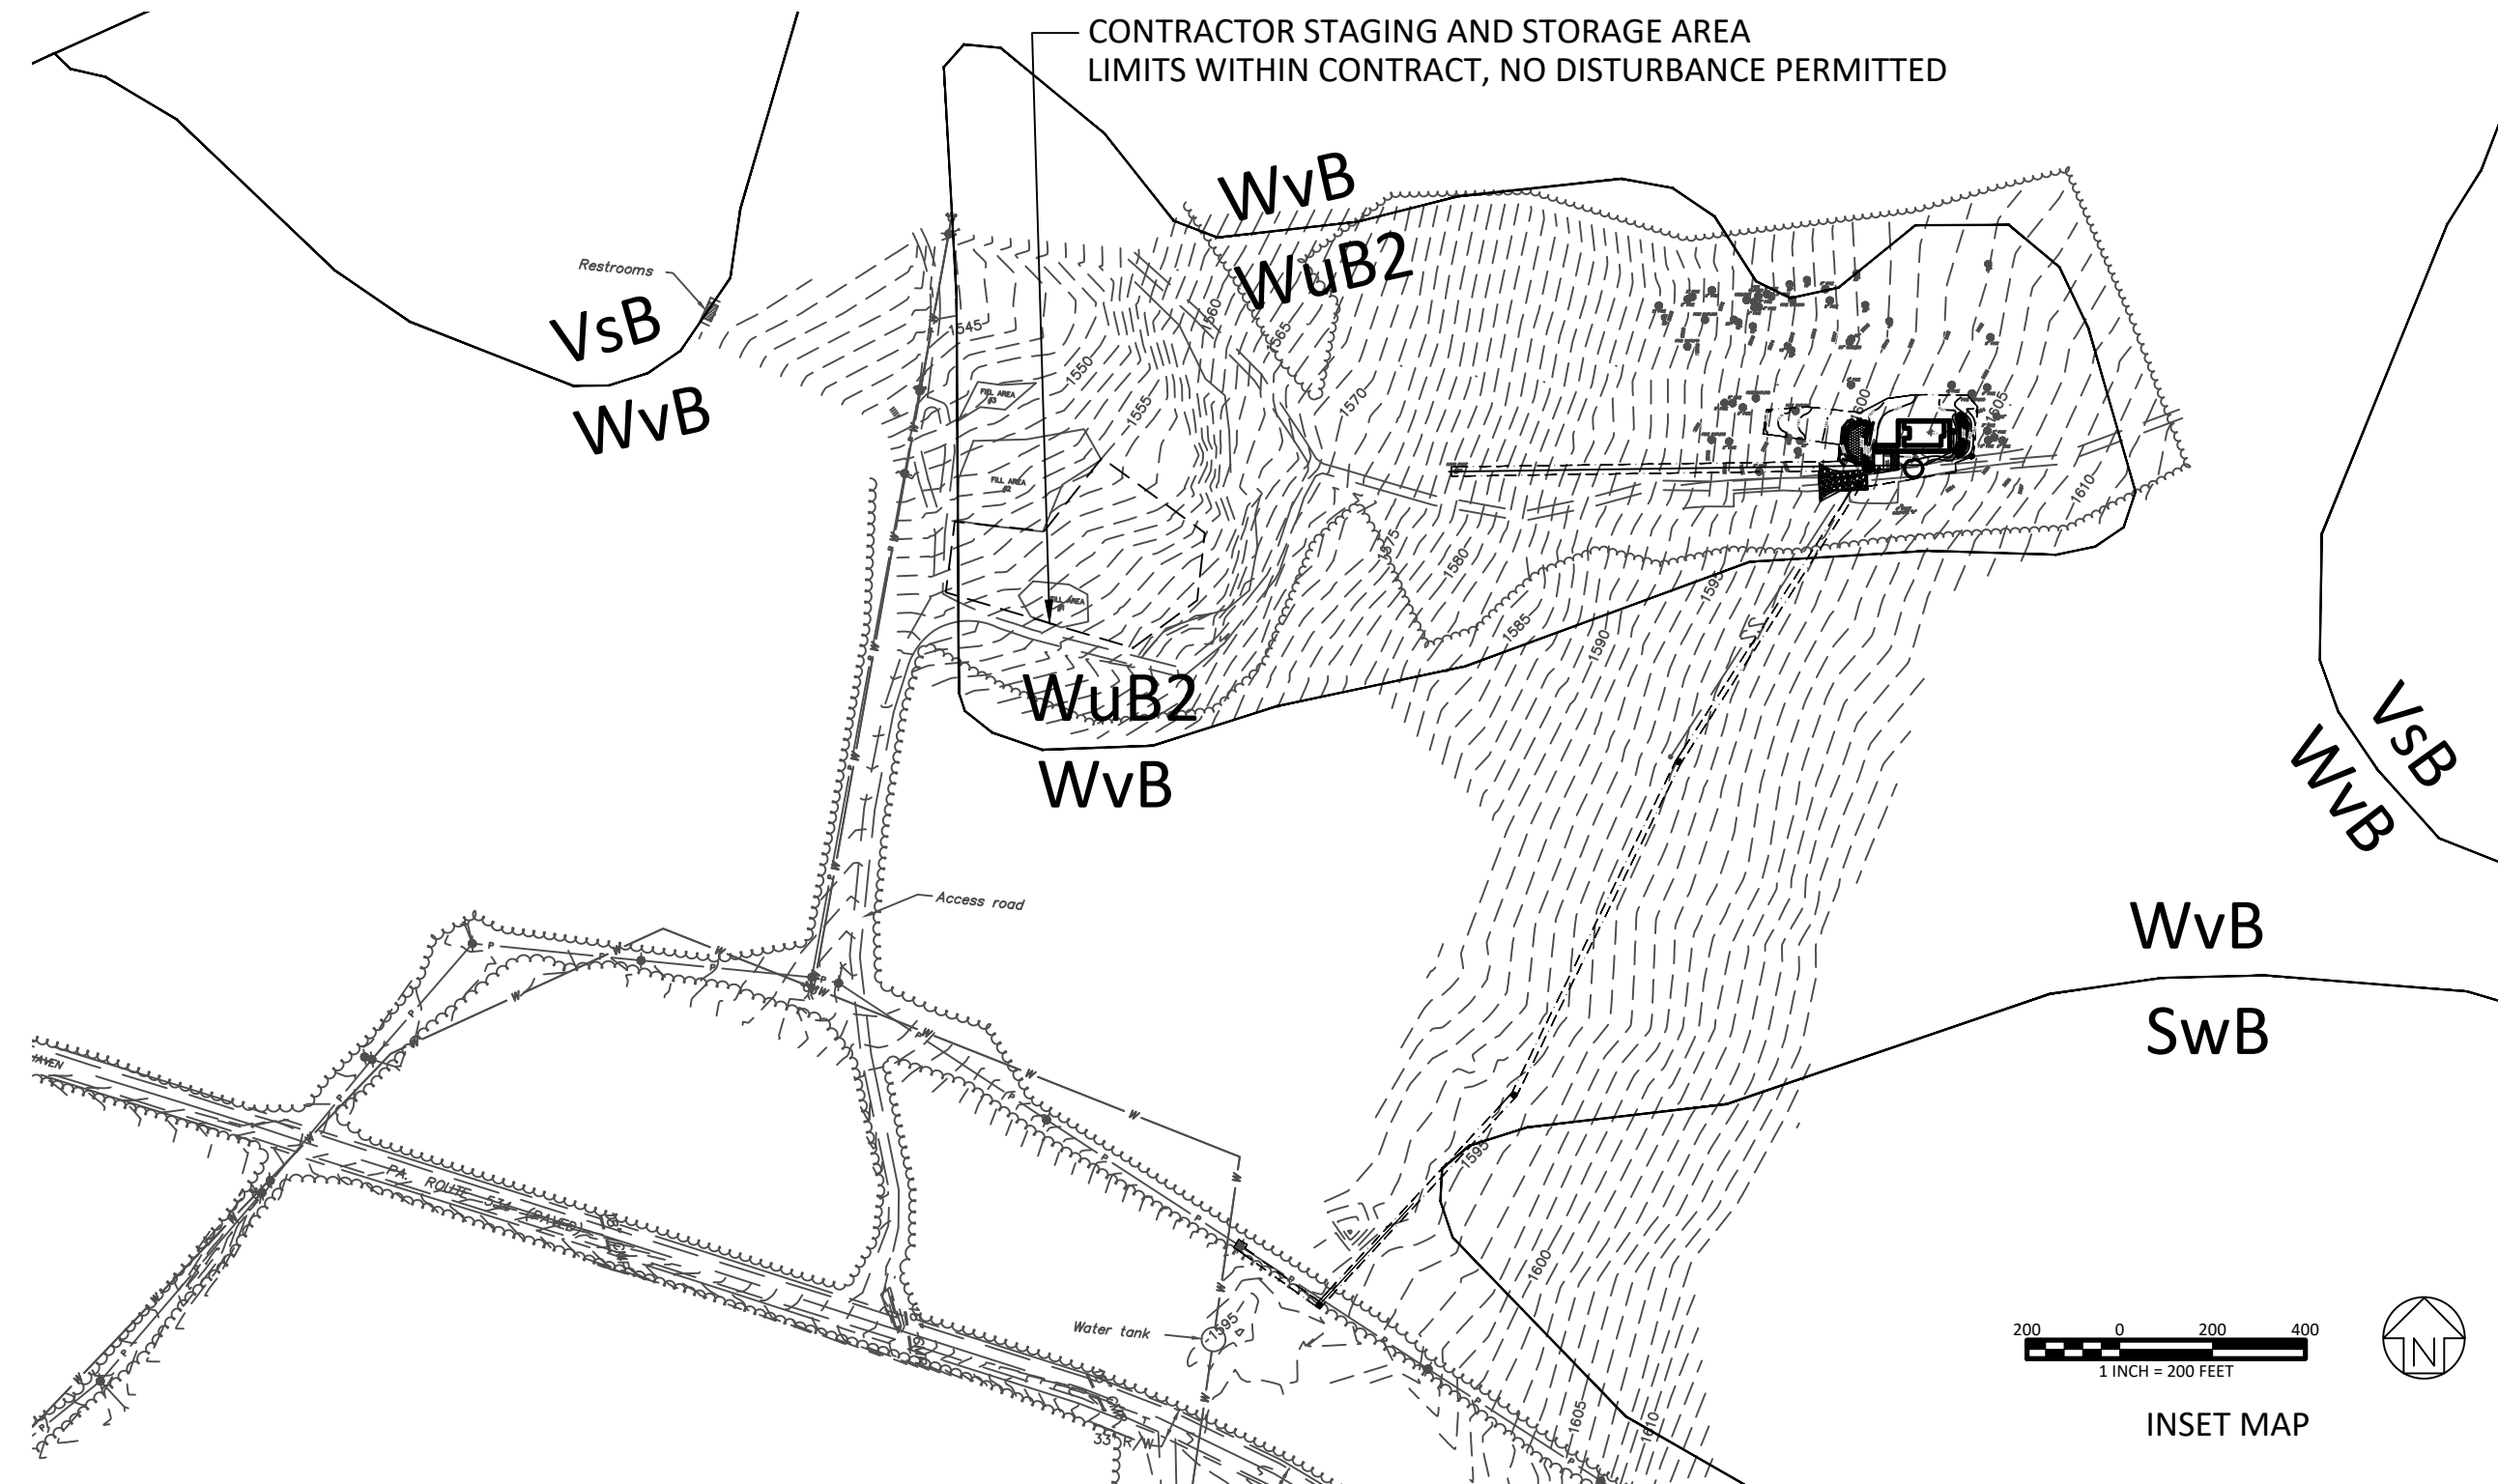

PA ONE CALL SERIAL NUMBER - 20202343070

ALL LOCATIONS OF EXISTING UTILITIES SHOWN ON THIS PLAN HAVE BEEN DEVELOPED FROM EXISTING UTILITY RECORDS AND/OR ABOVE GROUND EXAMINATION OF THE SITE. COMPLETENESS OR ACCURACY OF LOCATION AND DEPTH OF UNDERGROUND UTILITIES OR STRUCTURES CANNOT BE GUARANTEED. CONTRACTOR MUST VERIFY LOCATION AND DEPTH OF ALL UNDERGROUND UTILITIES AND FACILITIES BEFORE START OF WORK PER PENNSYLVANIA ACT 287 OF 1974 AS AMENDED BY ACT 199 OF 2004 OR LATER.

CONSTRUCTION DOCUMENTS

meliora

259 MORGAN STREET, PHOENIXVILLE, PA 19460
(610) 933-0123
melioradesign.com

NO.	REVISION

RECORD REVISIONS

MARC B. HENDERSON
REGISTERED PROFESSIONAL ENGINEER
No. 088402

06/15/22
SIGNATURE DATE

SMP ARCHITECTS
1600 WALNUT STREET, SECOND FLOOR
PHILADELPHIA, PENNSYLVANIA

COMMONWEALTH OF PENNSYLVANIA
DEPARTMENT OF GENERAL SERVICES
HARRISBURG, PENNSYLVANIA

D.G.S. PROJECT No.
C-114-0006 PHASE 1

HICKORY RUN STATE PARK
LATRINE IMPROVEMENTS

DEPT of CONSERVATION AND NATURAL RESOURCES
WHITE HAVEN, CARBON COUNTY, PA

EROSION AND SEDIMENT CONTROL PLAN - OGTC

DRAWN BY: L GILL
DATE: 06/17/2022

CHECKED BY: M HENDERSON
SCALE: AS NOTED

DRAWING No.
C-11

24 OF 144

VERIFY SCALE

BAR IS ONE (1) INCH LONG ON ORIGINAL DRAWING:


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IF BAR IS NOT ONE (1) INCH LONG, ADJUST SCALE ACCORDINGLY


CONTRACTOR SHALL FIELD VERIFY ALL DIMENSIONS. VARIANCE FROM CONTRACT DOCUMENTS NOT PERMITTED WITHOUT PROFESSIONAL & BUREAU OF CONSTRUCTION APPROVAL.

FILE PATH: I:\2020\09077 - Hickory Run State Park\CAD Sheets\Plan\2022\ EROSION AND SEDIMENT CONTROL PLAN.dwg PLOTTED BY: Laura L. Gill
LAST SAVED: 2022.06.22 09:05 AM PLOTTED: 2022.06.22 09:06 AM



- LEGEND**
- PROJECT BOUNDARY/LIMIT OF DISTURBANCE
 - X TREE TO BE REMOVED
 - TREE TO BE PROTECTED
 - ⊗ TREE TO BE IMPACTED
 - ⊕ UTILITY STRUCTURE REMOVAL
 - ⊕ UTILITY LINE REMOVAL
 - ▨ BUILDING DEMOLITION
 - ▨ CONCRETE DEMOLITION

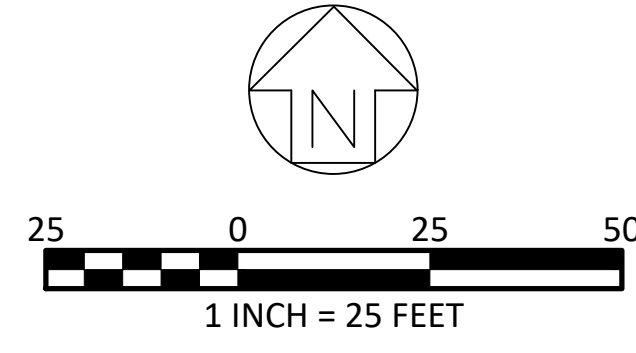

NOTES:
1. TREE STUMPS TO BE LEFT SHALL BE CUT LESS THAN 5 INCHES HIGH.

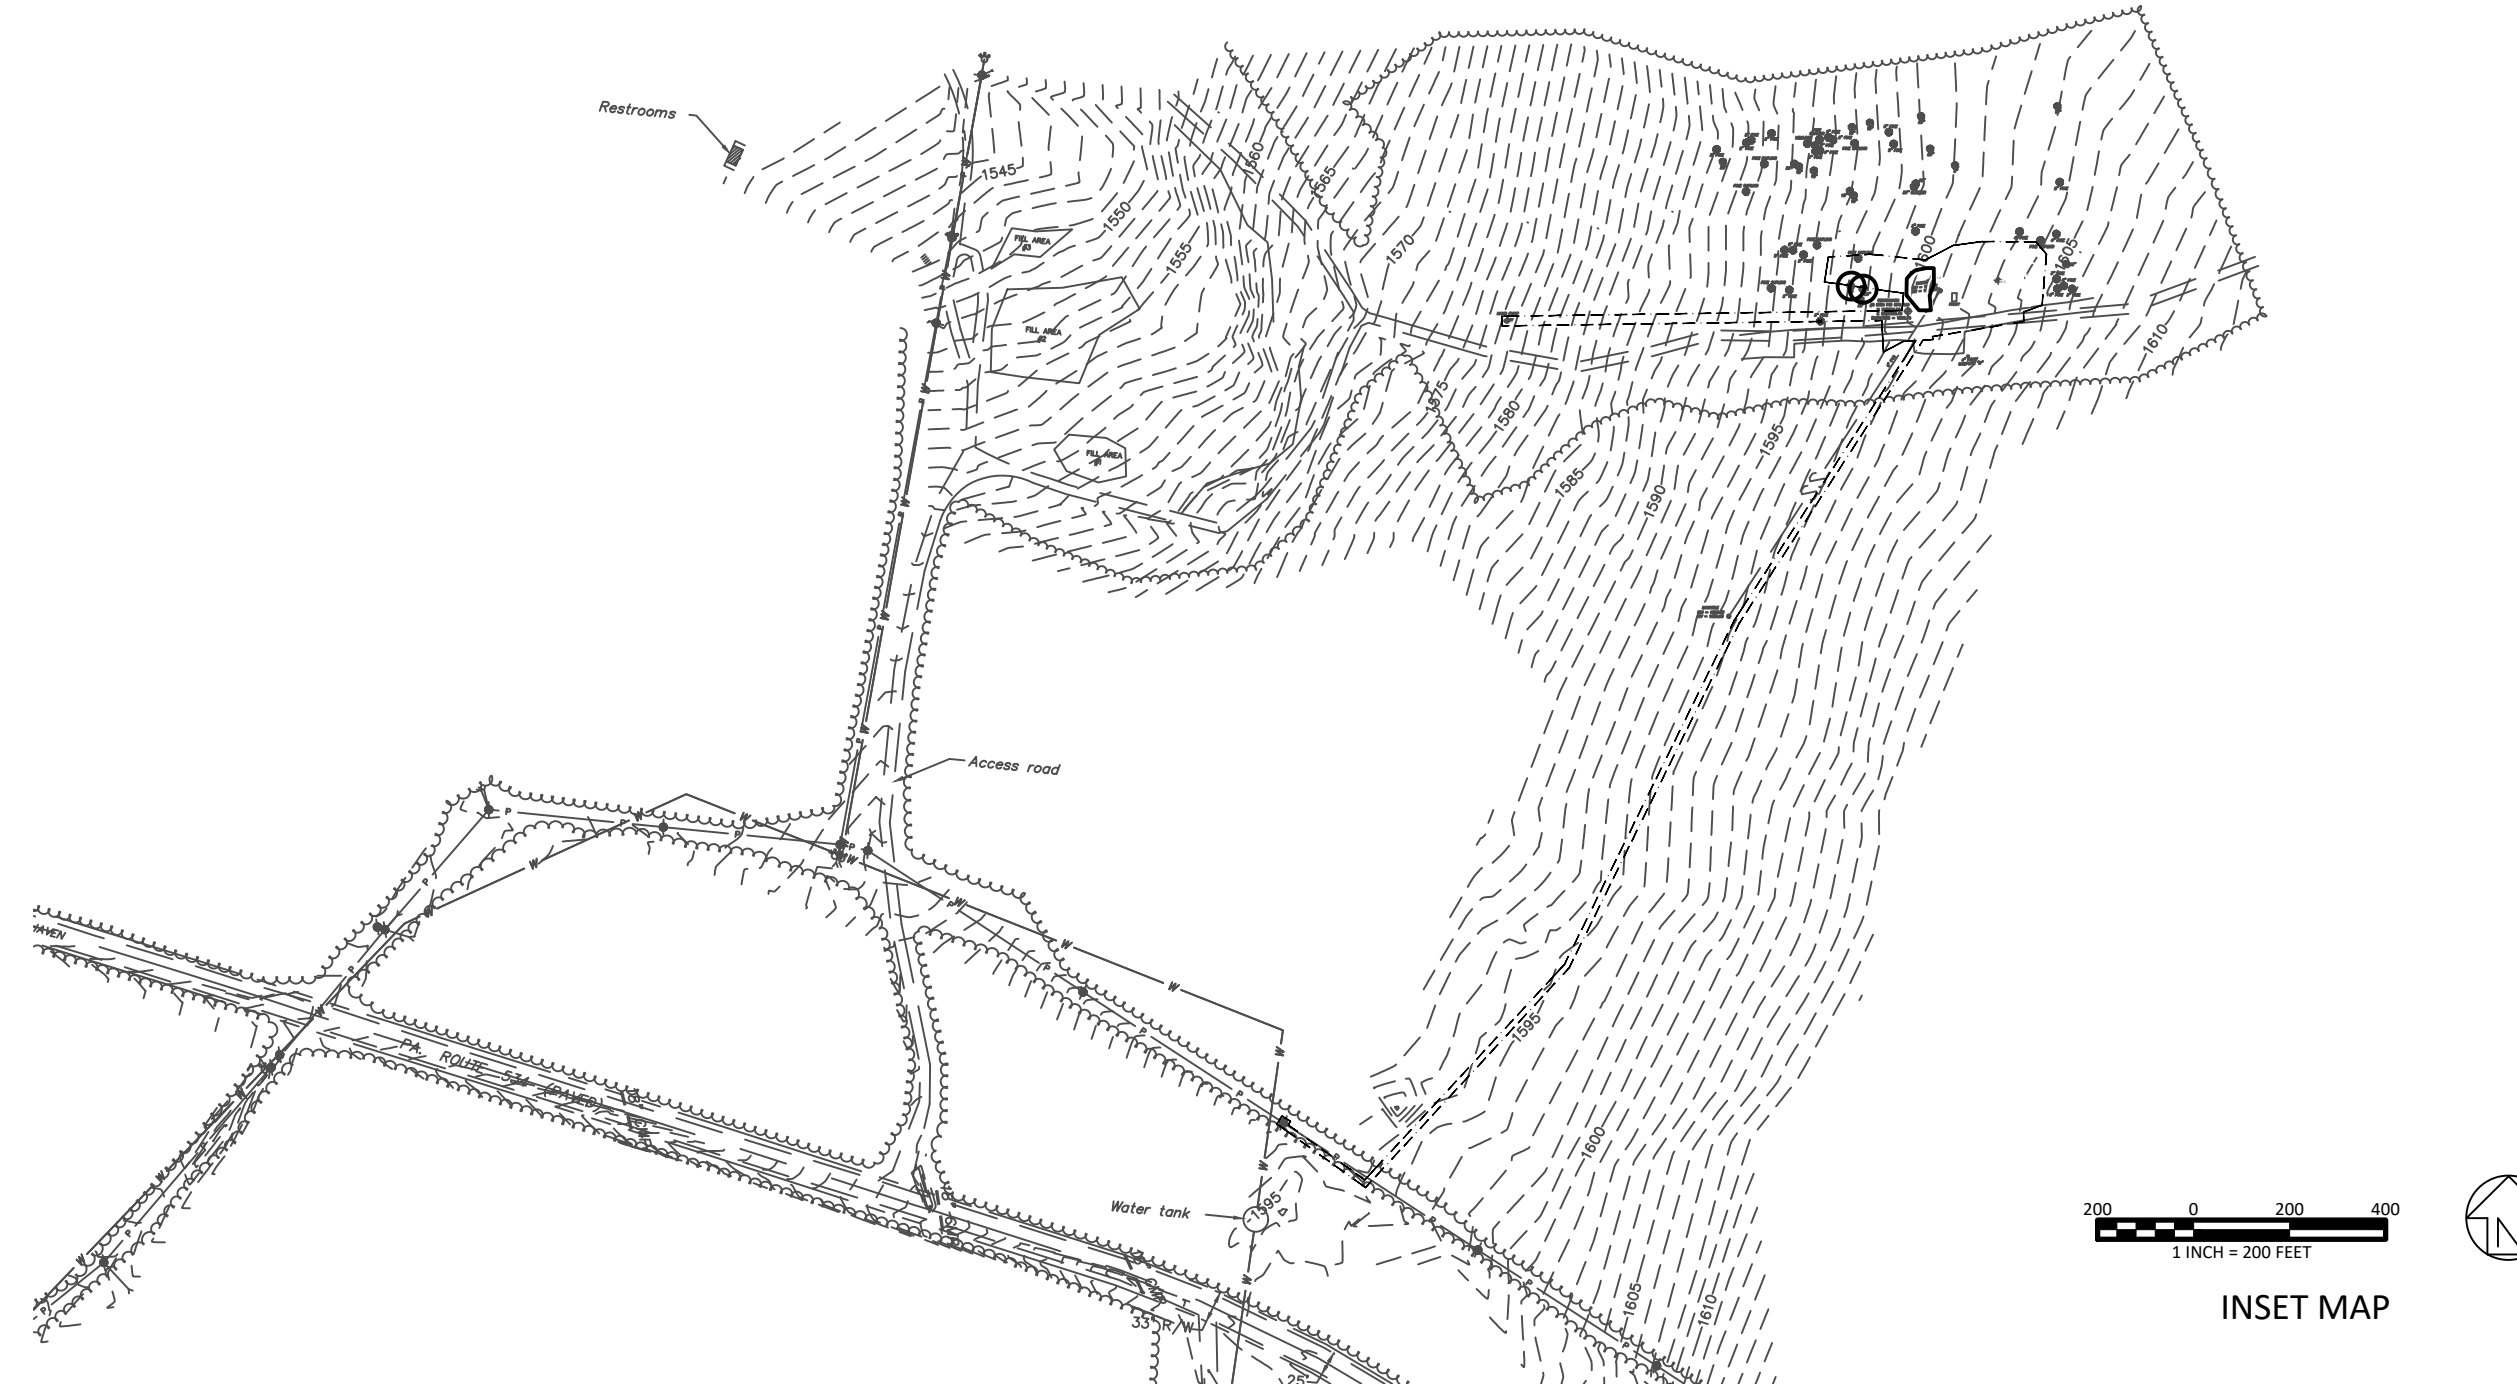

SITE LOCATION

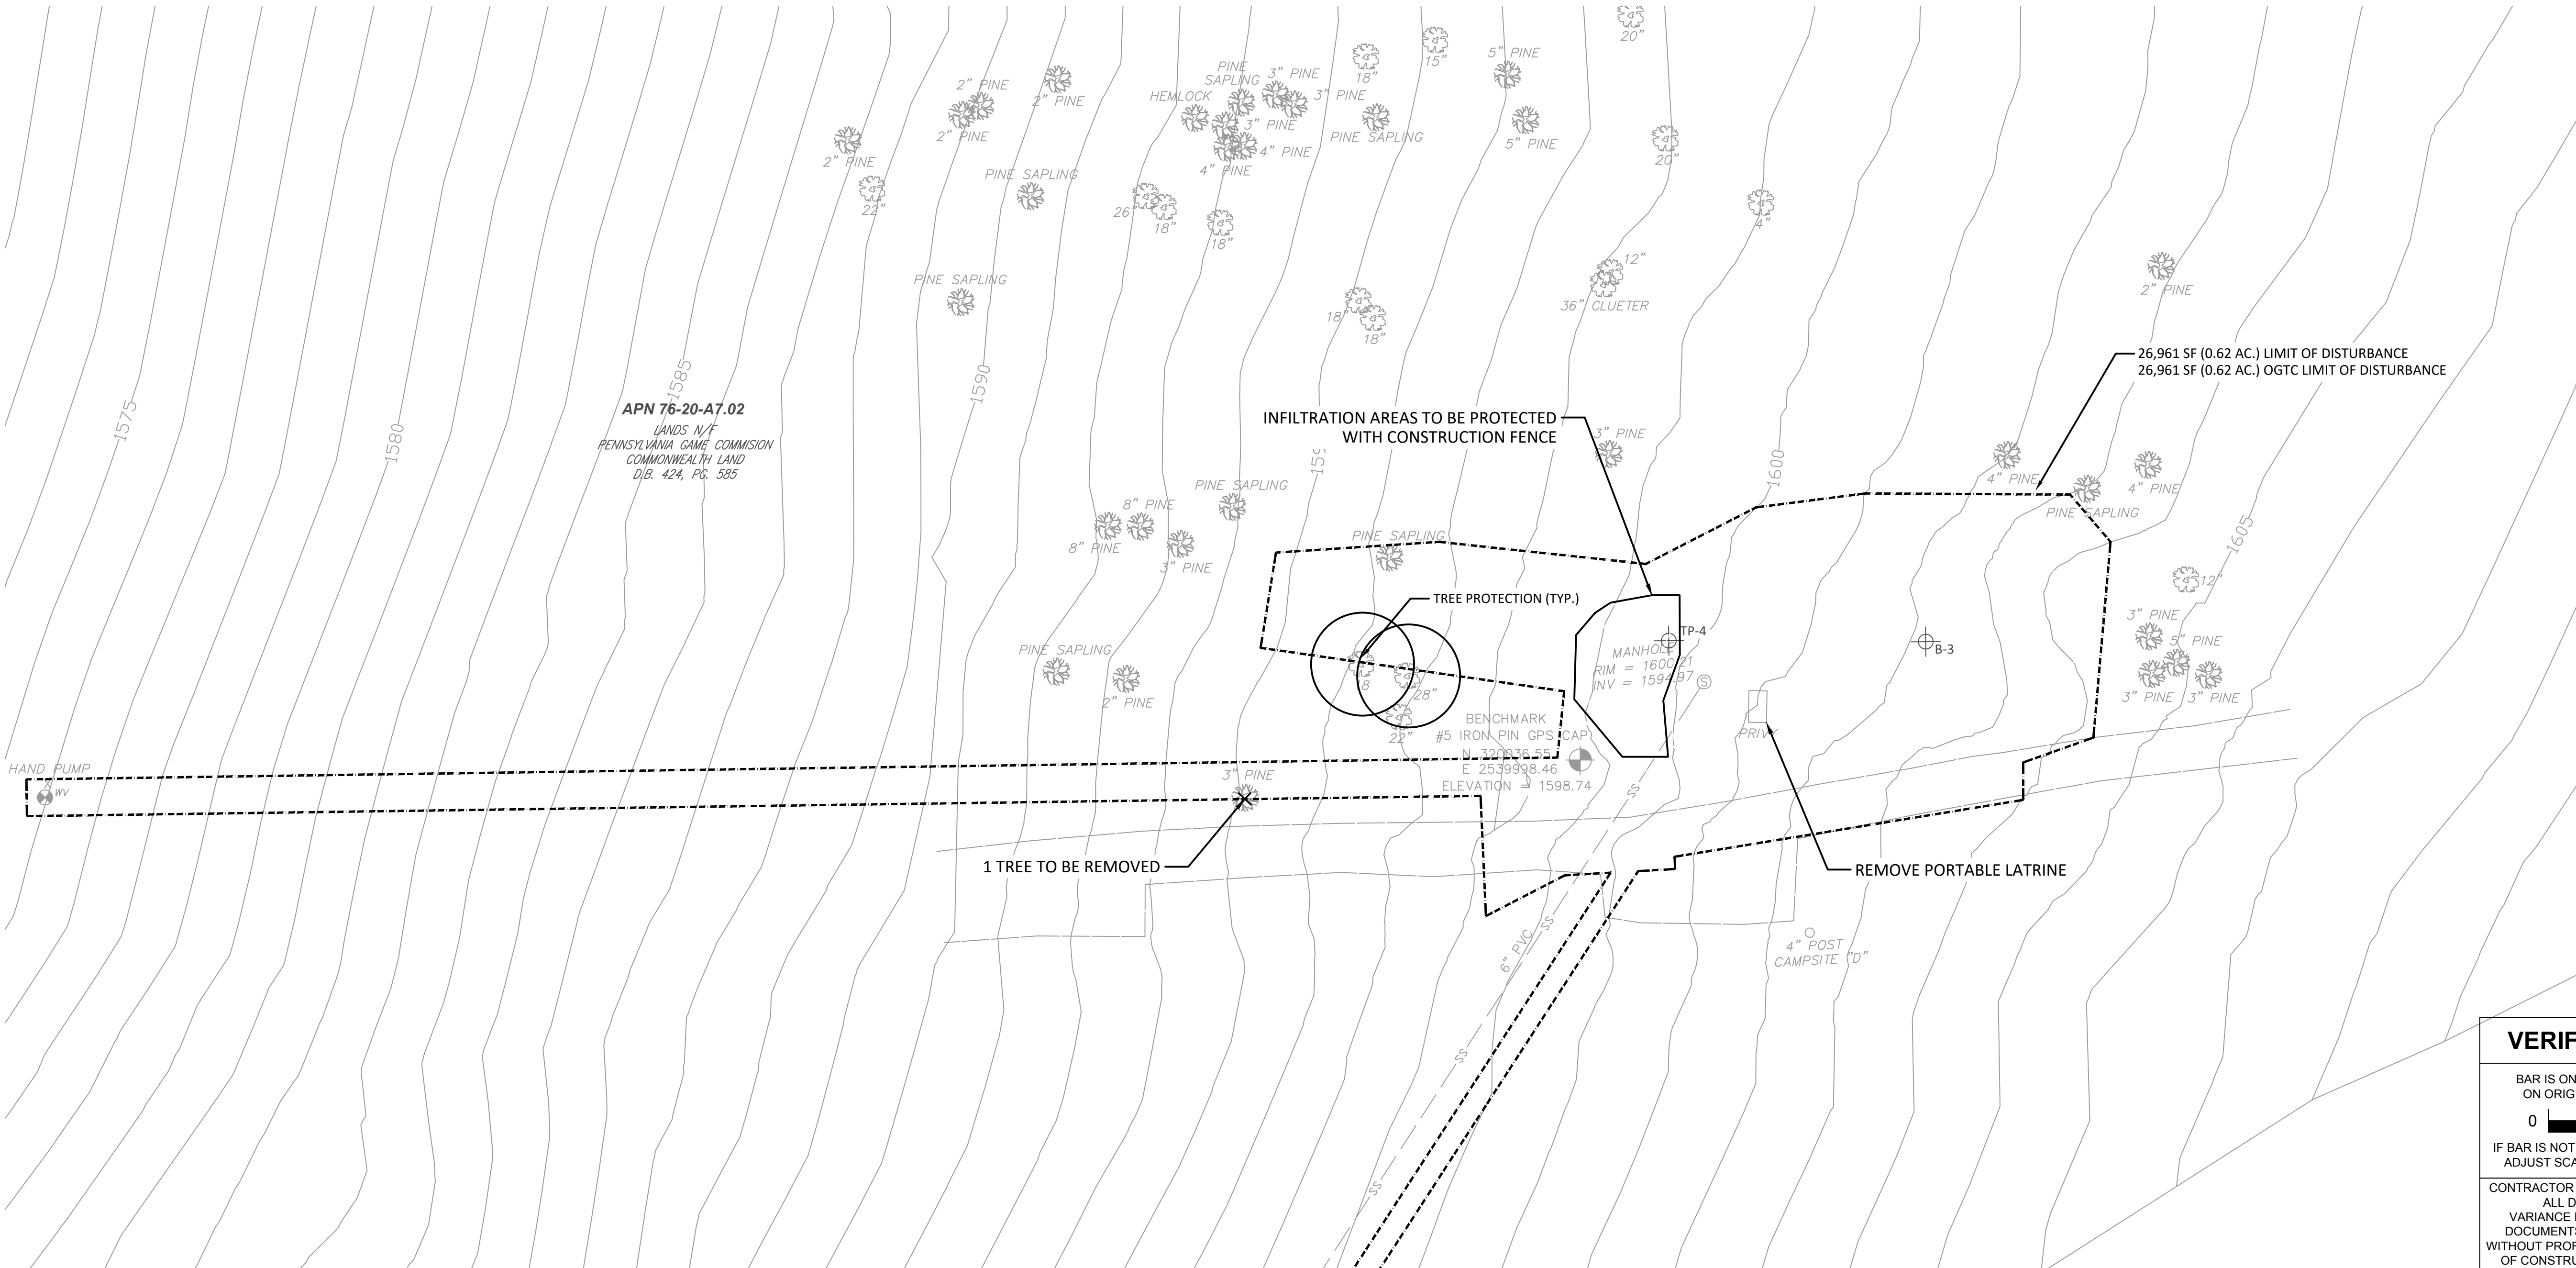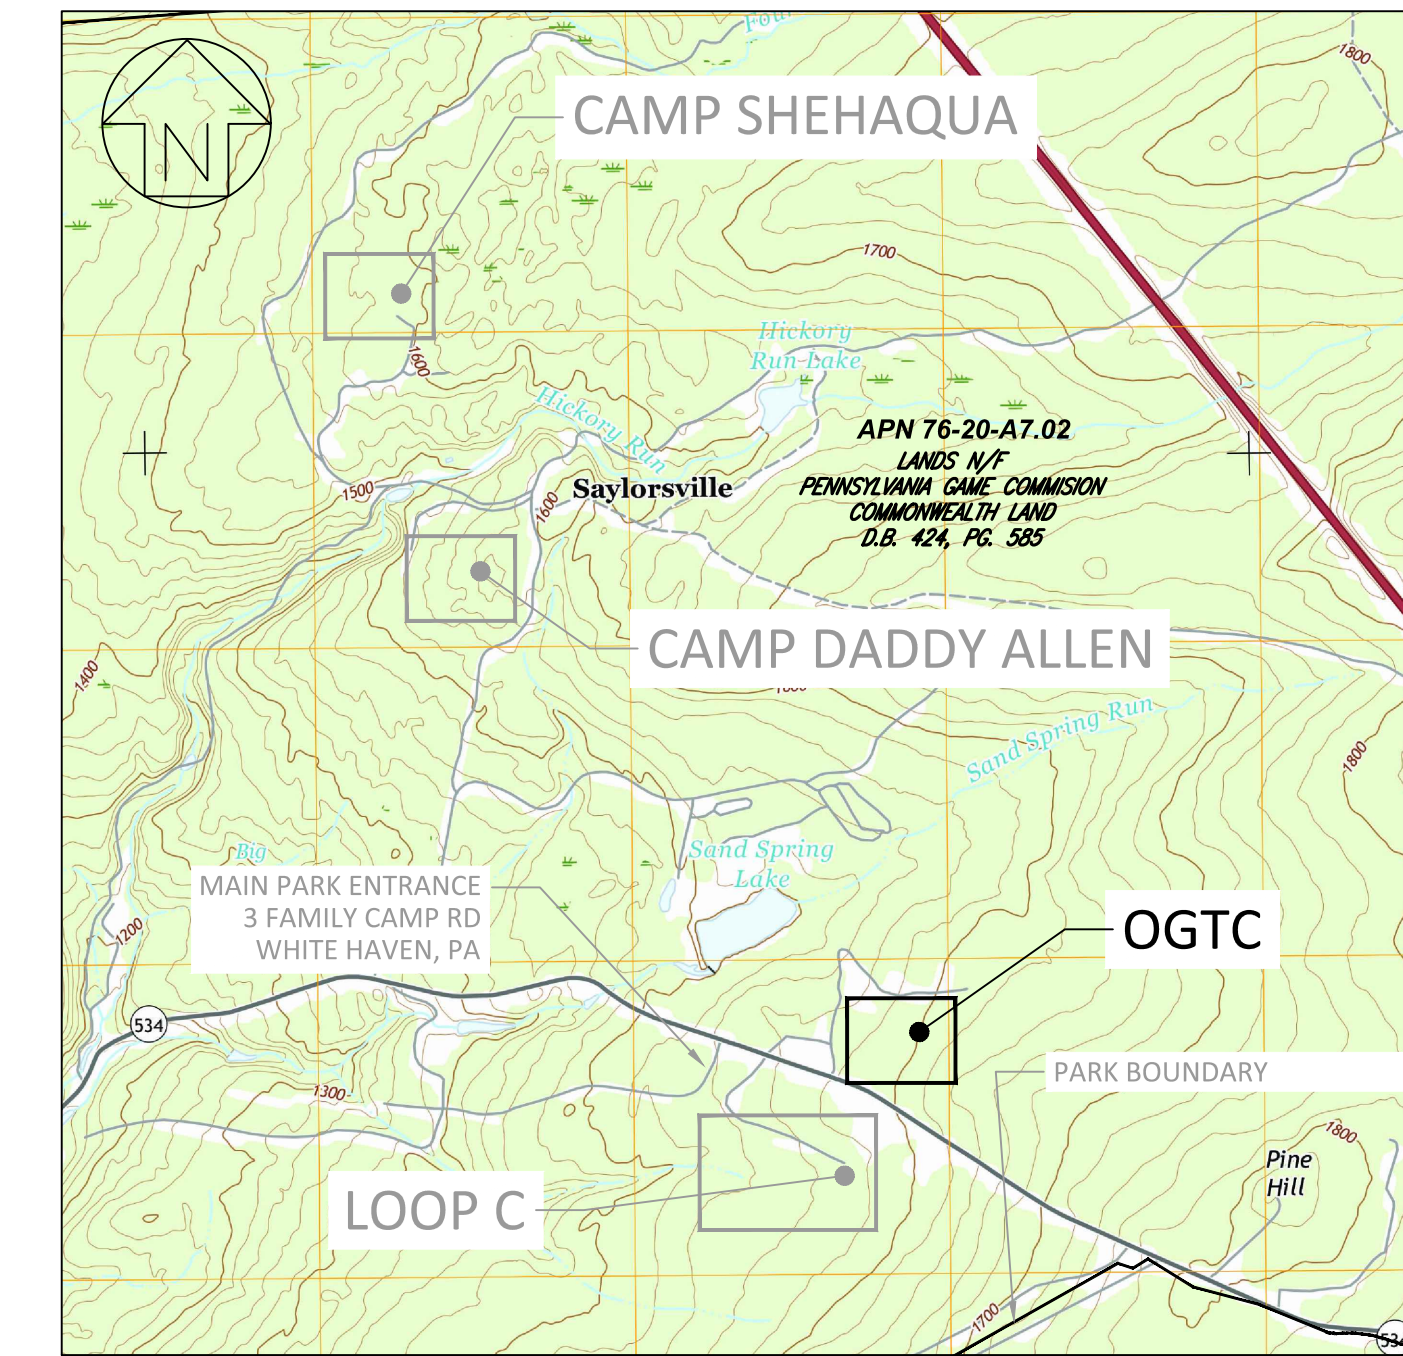

CONSTRUCTION DOCUMENTS



RECORD REVISIONS



SIGNATURE: *Marc B. Henderson* DATE: 06/15/22

SMP ARCHITECTS
1600 WALNUT STREET, SECOND FLOOR
PHILADELPHIA, PENNSYLVANIA

COMMONWEALTH OF PENNSYLVANIA
DEPARTMENT OF GENERAL SERVICES
HARRISBURG, PENNSYLVANIA

D.G.S. PROJECT No.
C-114-0006 PHASE 1

HICKORY RUN STATE PARK
LATRINE IMPROVEMENTS
DEPT of CONSERVATION AND NATURAL RESOURCES
WHITE HAVEN, CARBON COUNTY, PA

DEMOLITION PLAN - OGTC

DRAWN BY: **L GILL** DATE: **06/17/2022** DRAWING No. **C-12**

CHECKED BY: **M HENDERSON** SCALE: **AS NOTED**

VERIFY SCALE

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
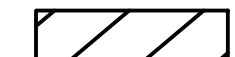
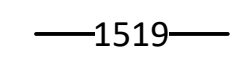





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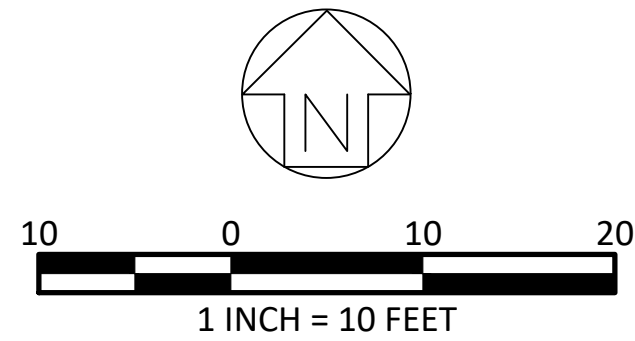
IF BAR IS NOT ONE (1) INCH LONG, ADJUST SCALE ACCORDINGLY

CONTRACTOR SHALL FIELD VERIFY ALL DIMENSIONS. VARIANCE FROM CONTRACT DOCUMENTS NOT PERMITTED WITHOUT PROFESSIONAL & BUREAU OF CONSTRUCTION APPROVAL.

FILE PATH: I:\2020\09077 - Hickory Run State Park\CA\Sheha Camp\2022 - DEMOLITION PLAN.dwg PLOTTED BY: Laura L. Gill LAST SAVED: 2022.06.15 04:24 PM PLOTTED: 2022.06.15 04:24 PM LAYOUT TAB: DEMOLITION PLAN - OGTC

LEGEND

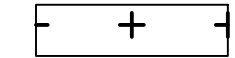-  PROJECT BOUNDARY/LIMIT OF DISTURBANCE
-  PROPOSED BUILDING
-  CONTOUR
-  STORM PIPE
-  INFILTRATION BED
-  RAIN GARDEN
-  TP/B-9 SOIL TEST PIT (TP) OR BORING (B) LOCATION
-  DOMED RISER




NOTES:

1. PROPOSED SANITARY AND/OR ELECTRICAL UTILITY CLEARING TO BE REGRADED TO MATCH EXISTING GRADE AND REMAIN CLEARED AND OPEN FOR PEDESTRIAN ACCESS.
2. GENERAL CONTRACTOR RESPONSIBLE FOR CONNECTIONS FROM BUILDING DOWNSPOUTS TO STORMWATER SYSTEM. DOWNSPOUT CONNECTIONS VARY BY TYPE AND LOCATION. SEE PLANS FOR DOWNSPOUT CONNECTION DETAILS.


BORING ID	SURFACE ELEVATION	BORING DEPTH	OBSERVED WATER SURFACE DEPTH
B-3	1601.5' ±	25'	N/A

STORMWATER TEST PIT ID	SURFACE ELEVATION	PIT DEPTH	TEST DEPTH	AVERAGE FIELD INFIL. RATE (IN/HR)	FACTOR OF SAFETY	DESIGN INFIL. RATE (IN/HR)
TP-4	1598'	5'	7'	0.94	2	0.47

SITE LOCATION

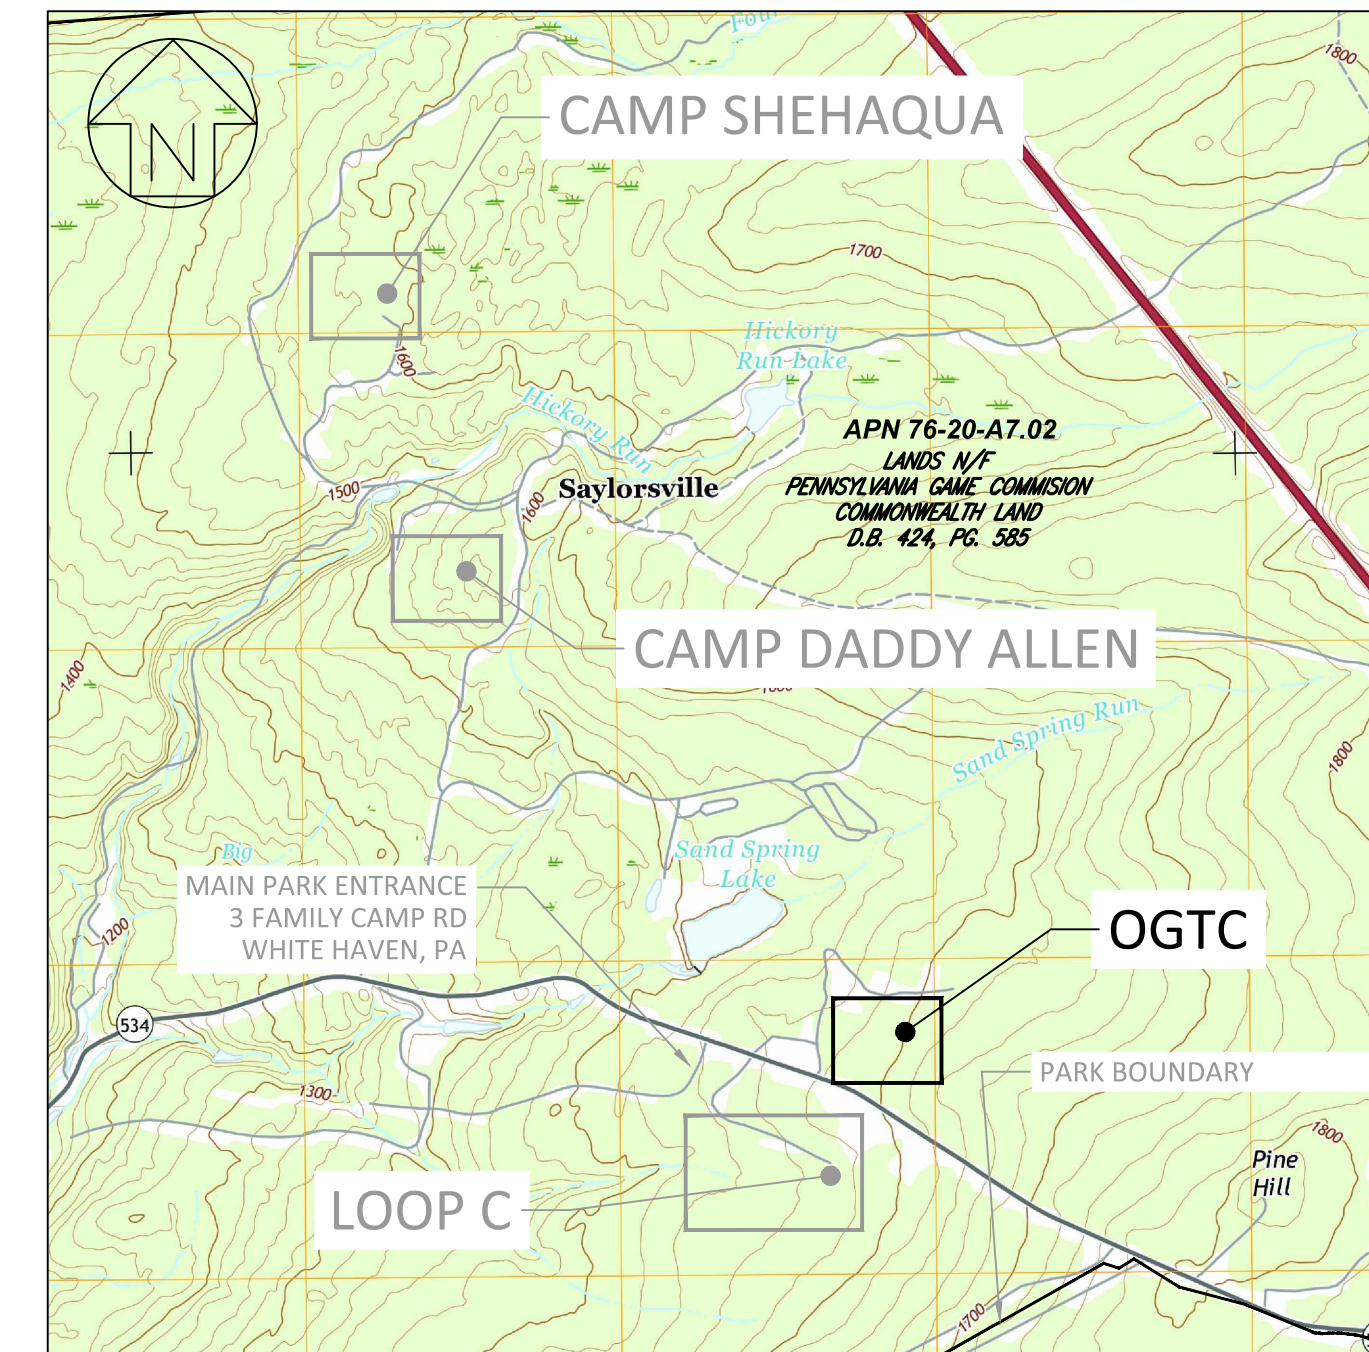

SCALE: 1" = 2000'
PA ONE CALL SERIAL NUMBER - 20202343070
 ALL LOCATIONS OF EXISTING UTILITIES SHOWN ON THIS PLAN HAVE BEEN DEVELOPED FROM EXISTING UTILITY RECORDS AND/OR ABOVE GROUND EXAMINATION OF THE SITE. COMPLETENESS OR ACCURACY OF LOCATION AND DEPTH OF UNDERGROUND UTILITIES OR STRUCTURES CANNOT BE GUARANTEED. CONTRACTOR MUST VERIFY LOCATION AND DEPTH OF ALL UNDERGROUND UTILITIES AND FACILITIES BEFORE START OF WORK PER PENNSYLVANIA ACT 287 OF 1974 AS AMENDED BY ACT 199 OF 2004 OR LATER.

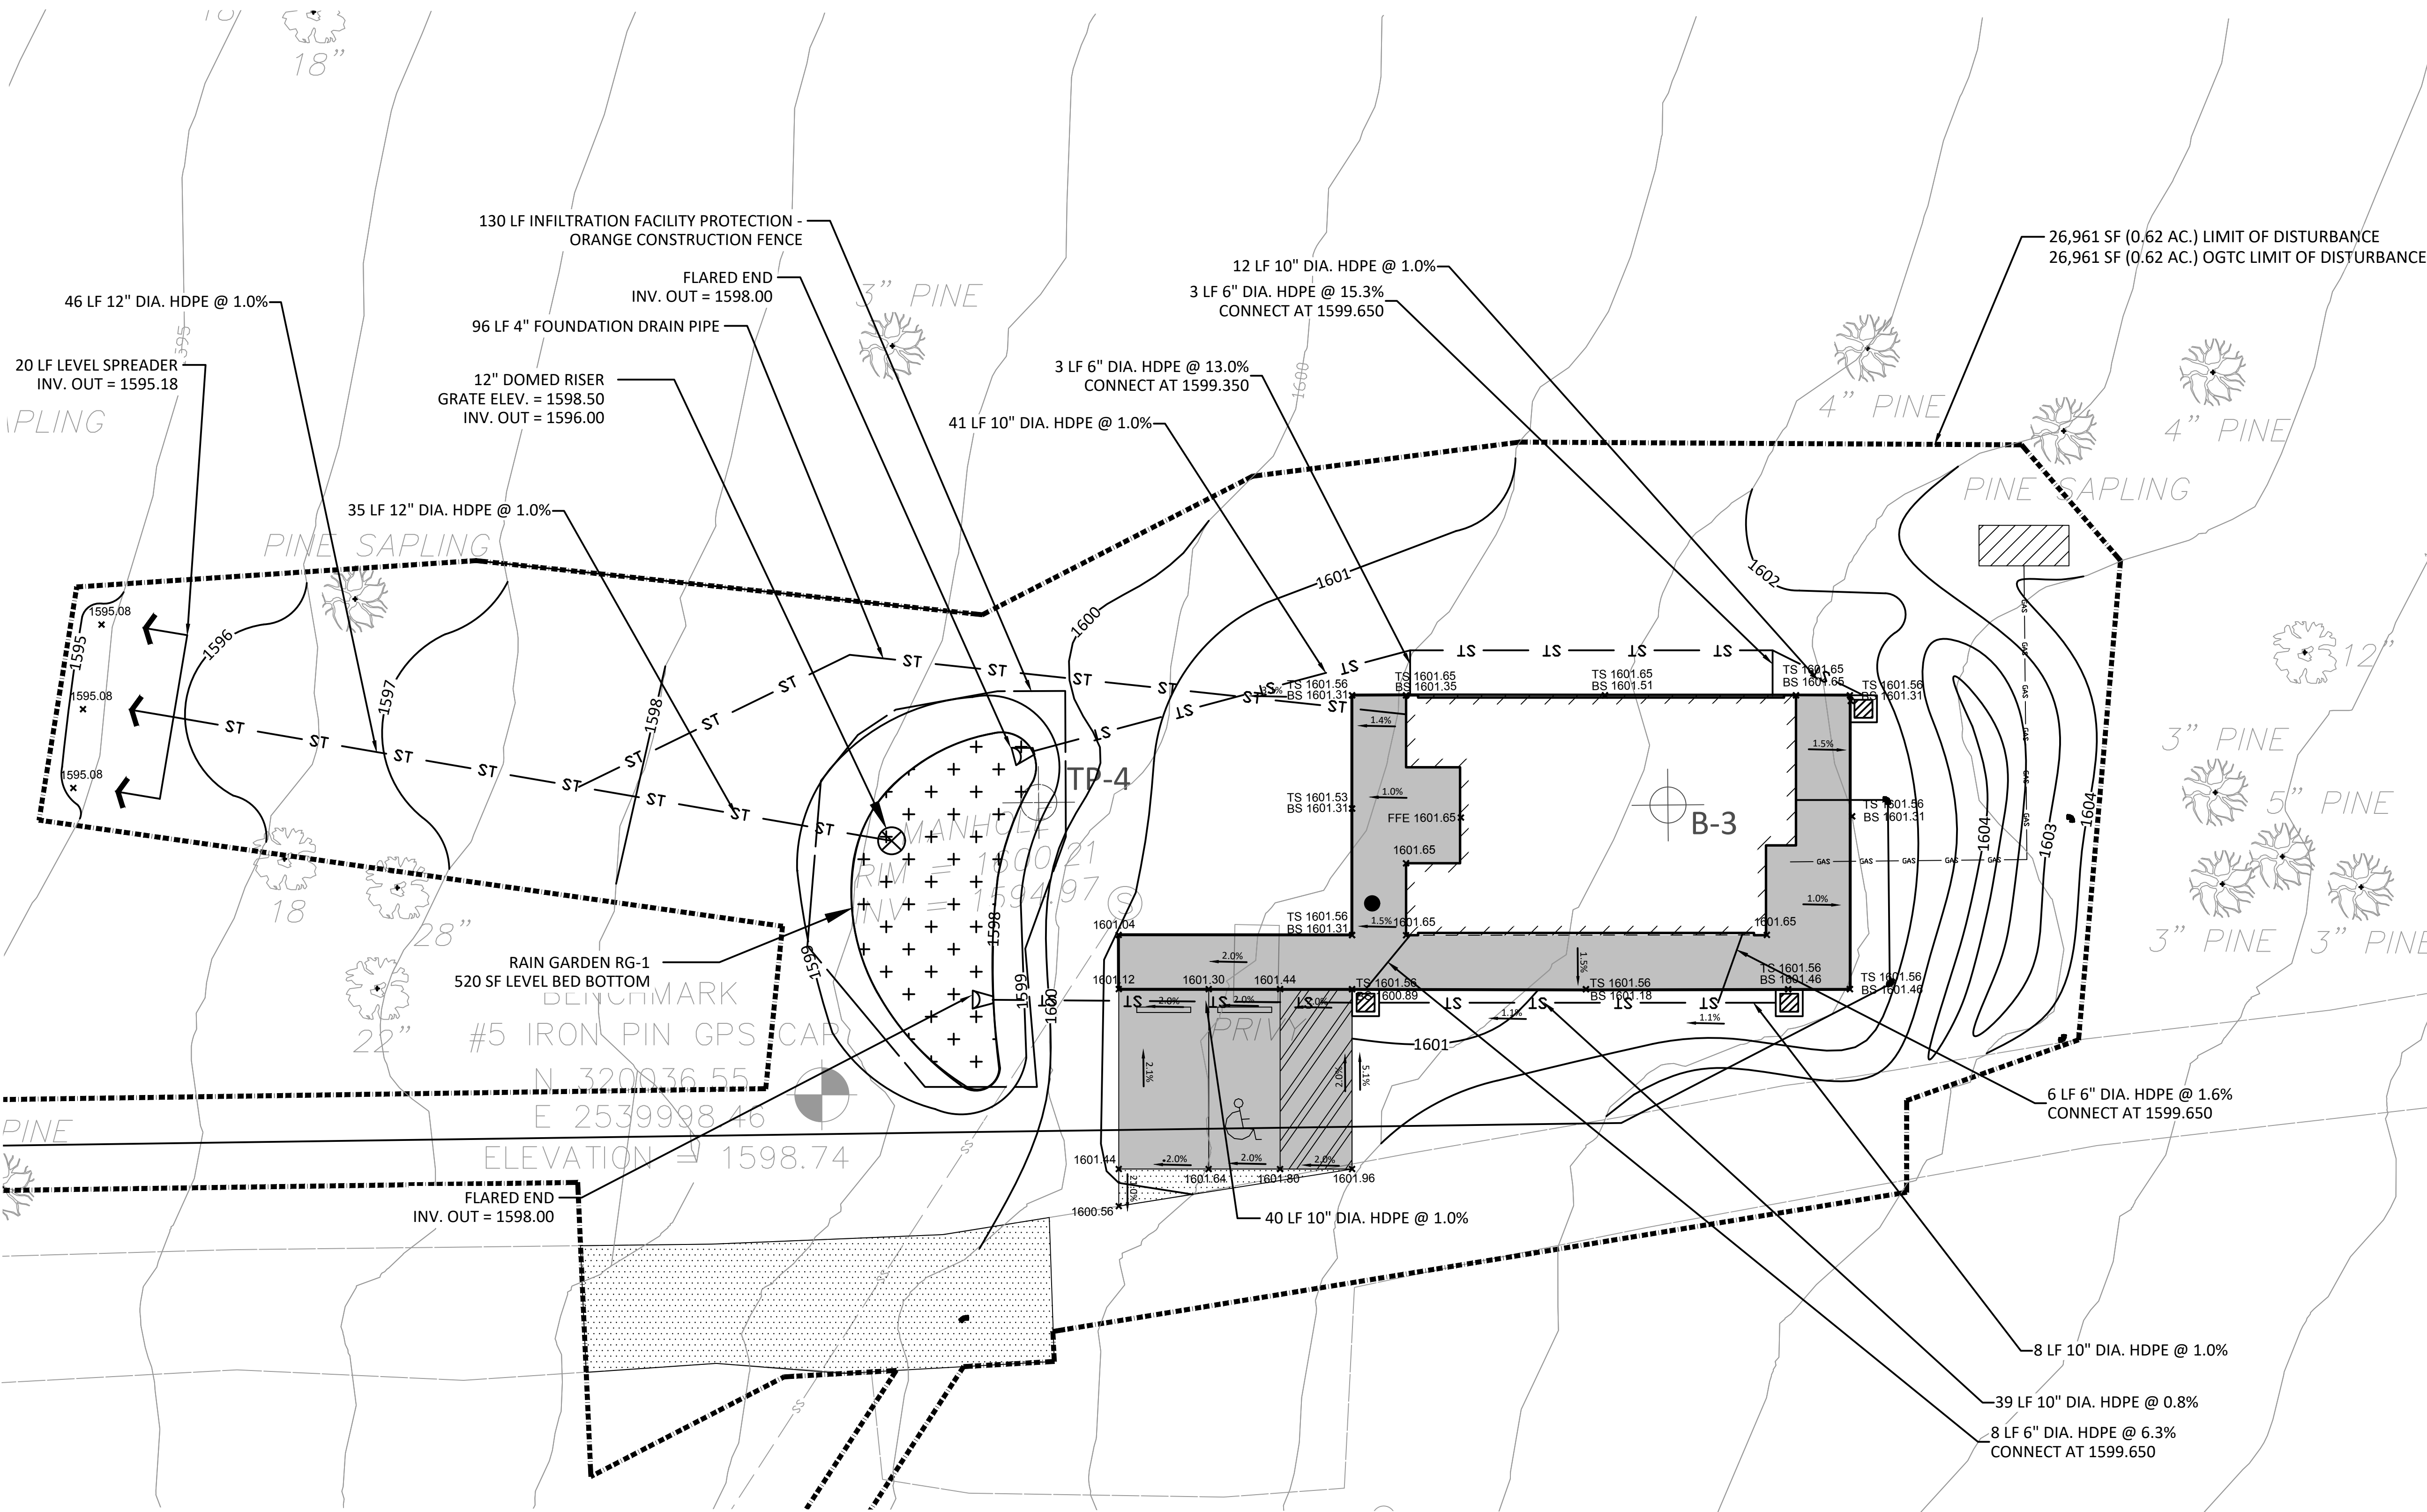


CONSTRUCTION DOCUMENTS



NO.	REVISION	DATE

RECORD REVISIONS

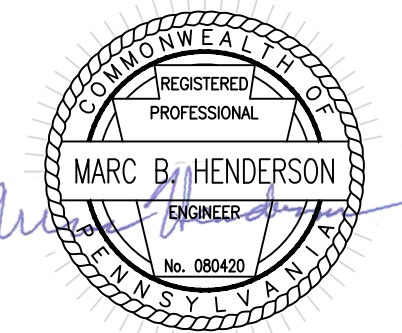

SIGNATURE: *Marc B. Henderson* DATE: 06/15/22

SMP ARCHITECTS
 1600 WALNUT STREET, SECOND FLOOR
 PHILADELPHIA, PENNSYLVANIA

COMMONWEALTH OF PENNSYLVANIA
 DEPARTMENT OF GENERAL SERVICES
 HARRISBURG, PENNSYLVANIA

D.G.S. PROJECT No. **C-114-0006 PHASE 1**
HICKORY RUN STATE PARK
LATRINE IMPROVEMENTS
 DEPT of CONSERVATION AND NATURAL RESOURCES
 WHITE HAVEN, CARBON COUNTY, PA
STORMWATER AND GRADING PLAN -
OGTC

VERIFY SCALE




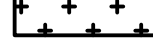

BAR IS ONE (1) INCH LONG ON ORIGINAL DRAWING.
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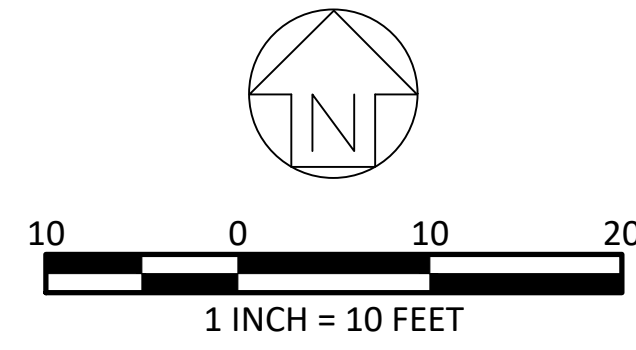
CONTRACTOR SHALL FIELD VERIFY ALL DIMENSIONS AND VARIANCE FROM CONTRACT DOCUMENTS NOT PERMITTED WITHOUT PROFESSIONAL & BUREAU OF CONSTRUCTION APPROVAL.

DRAWN BY: **L GILL**
 DATE: **06/17/2022**
 CHECKED BY: **M HENDERSON**
 SCALE: **AS NOTED**


DRAWING No. **C-13**
 26 OF 144

FILE PATH: I:\2020\0907 - Hickory Run State Park\GIS\Shehaqua\2022 - Stormwater and Grading Plan.dwg LAYOUT TAB: STORMWATER AND GRADING PLAN - OGTC
 PLOTTED BY: Laura L. Gill
 PLOTTED: 2022.06.13 10:43 AM


- LEGEND**
-  PROJECT BOUNDARY/LIMIT OF DISTURBANCE
 -  PROPOSED CONCRETE
 -  PROPOSED DRIVING SURFACE AGGREGATE
 -  PROPOSED RAIN GARDEN SEED MIX
 -  PROPOSED LANDSCAPE RESTORATION



SITE LOCATION

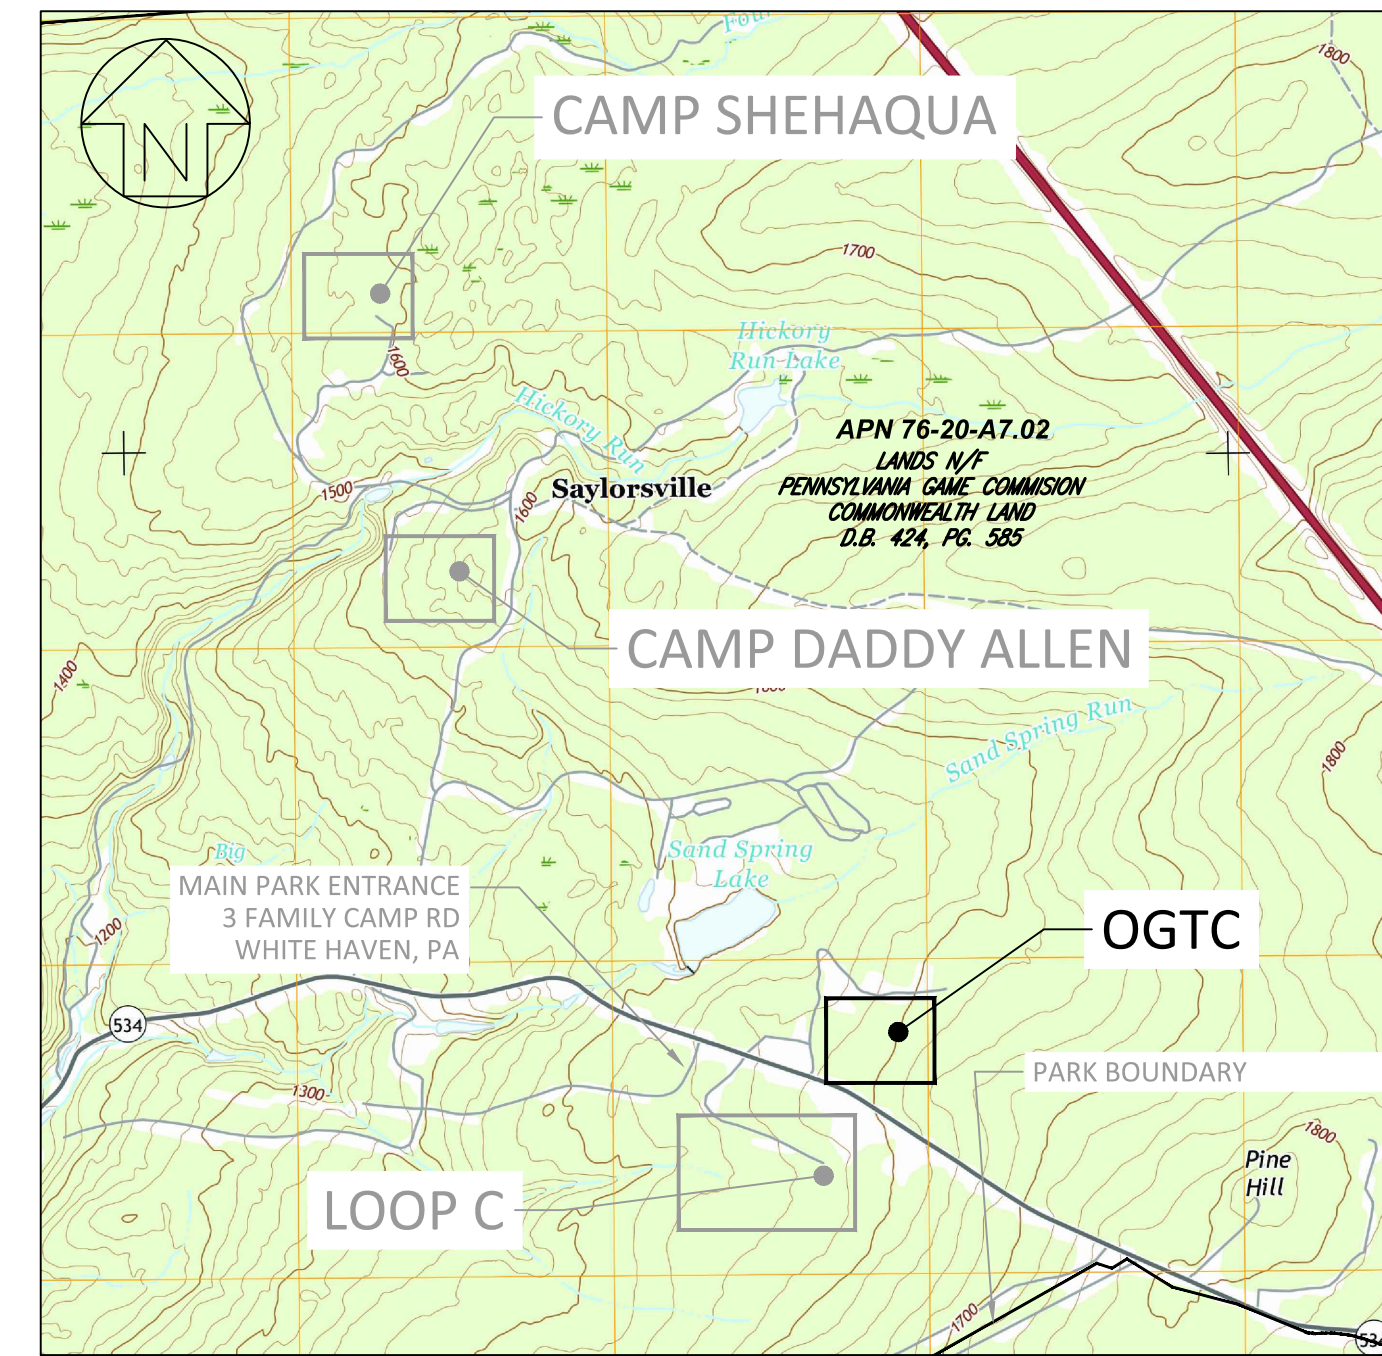


SCALE: 1" = 2000'

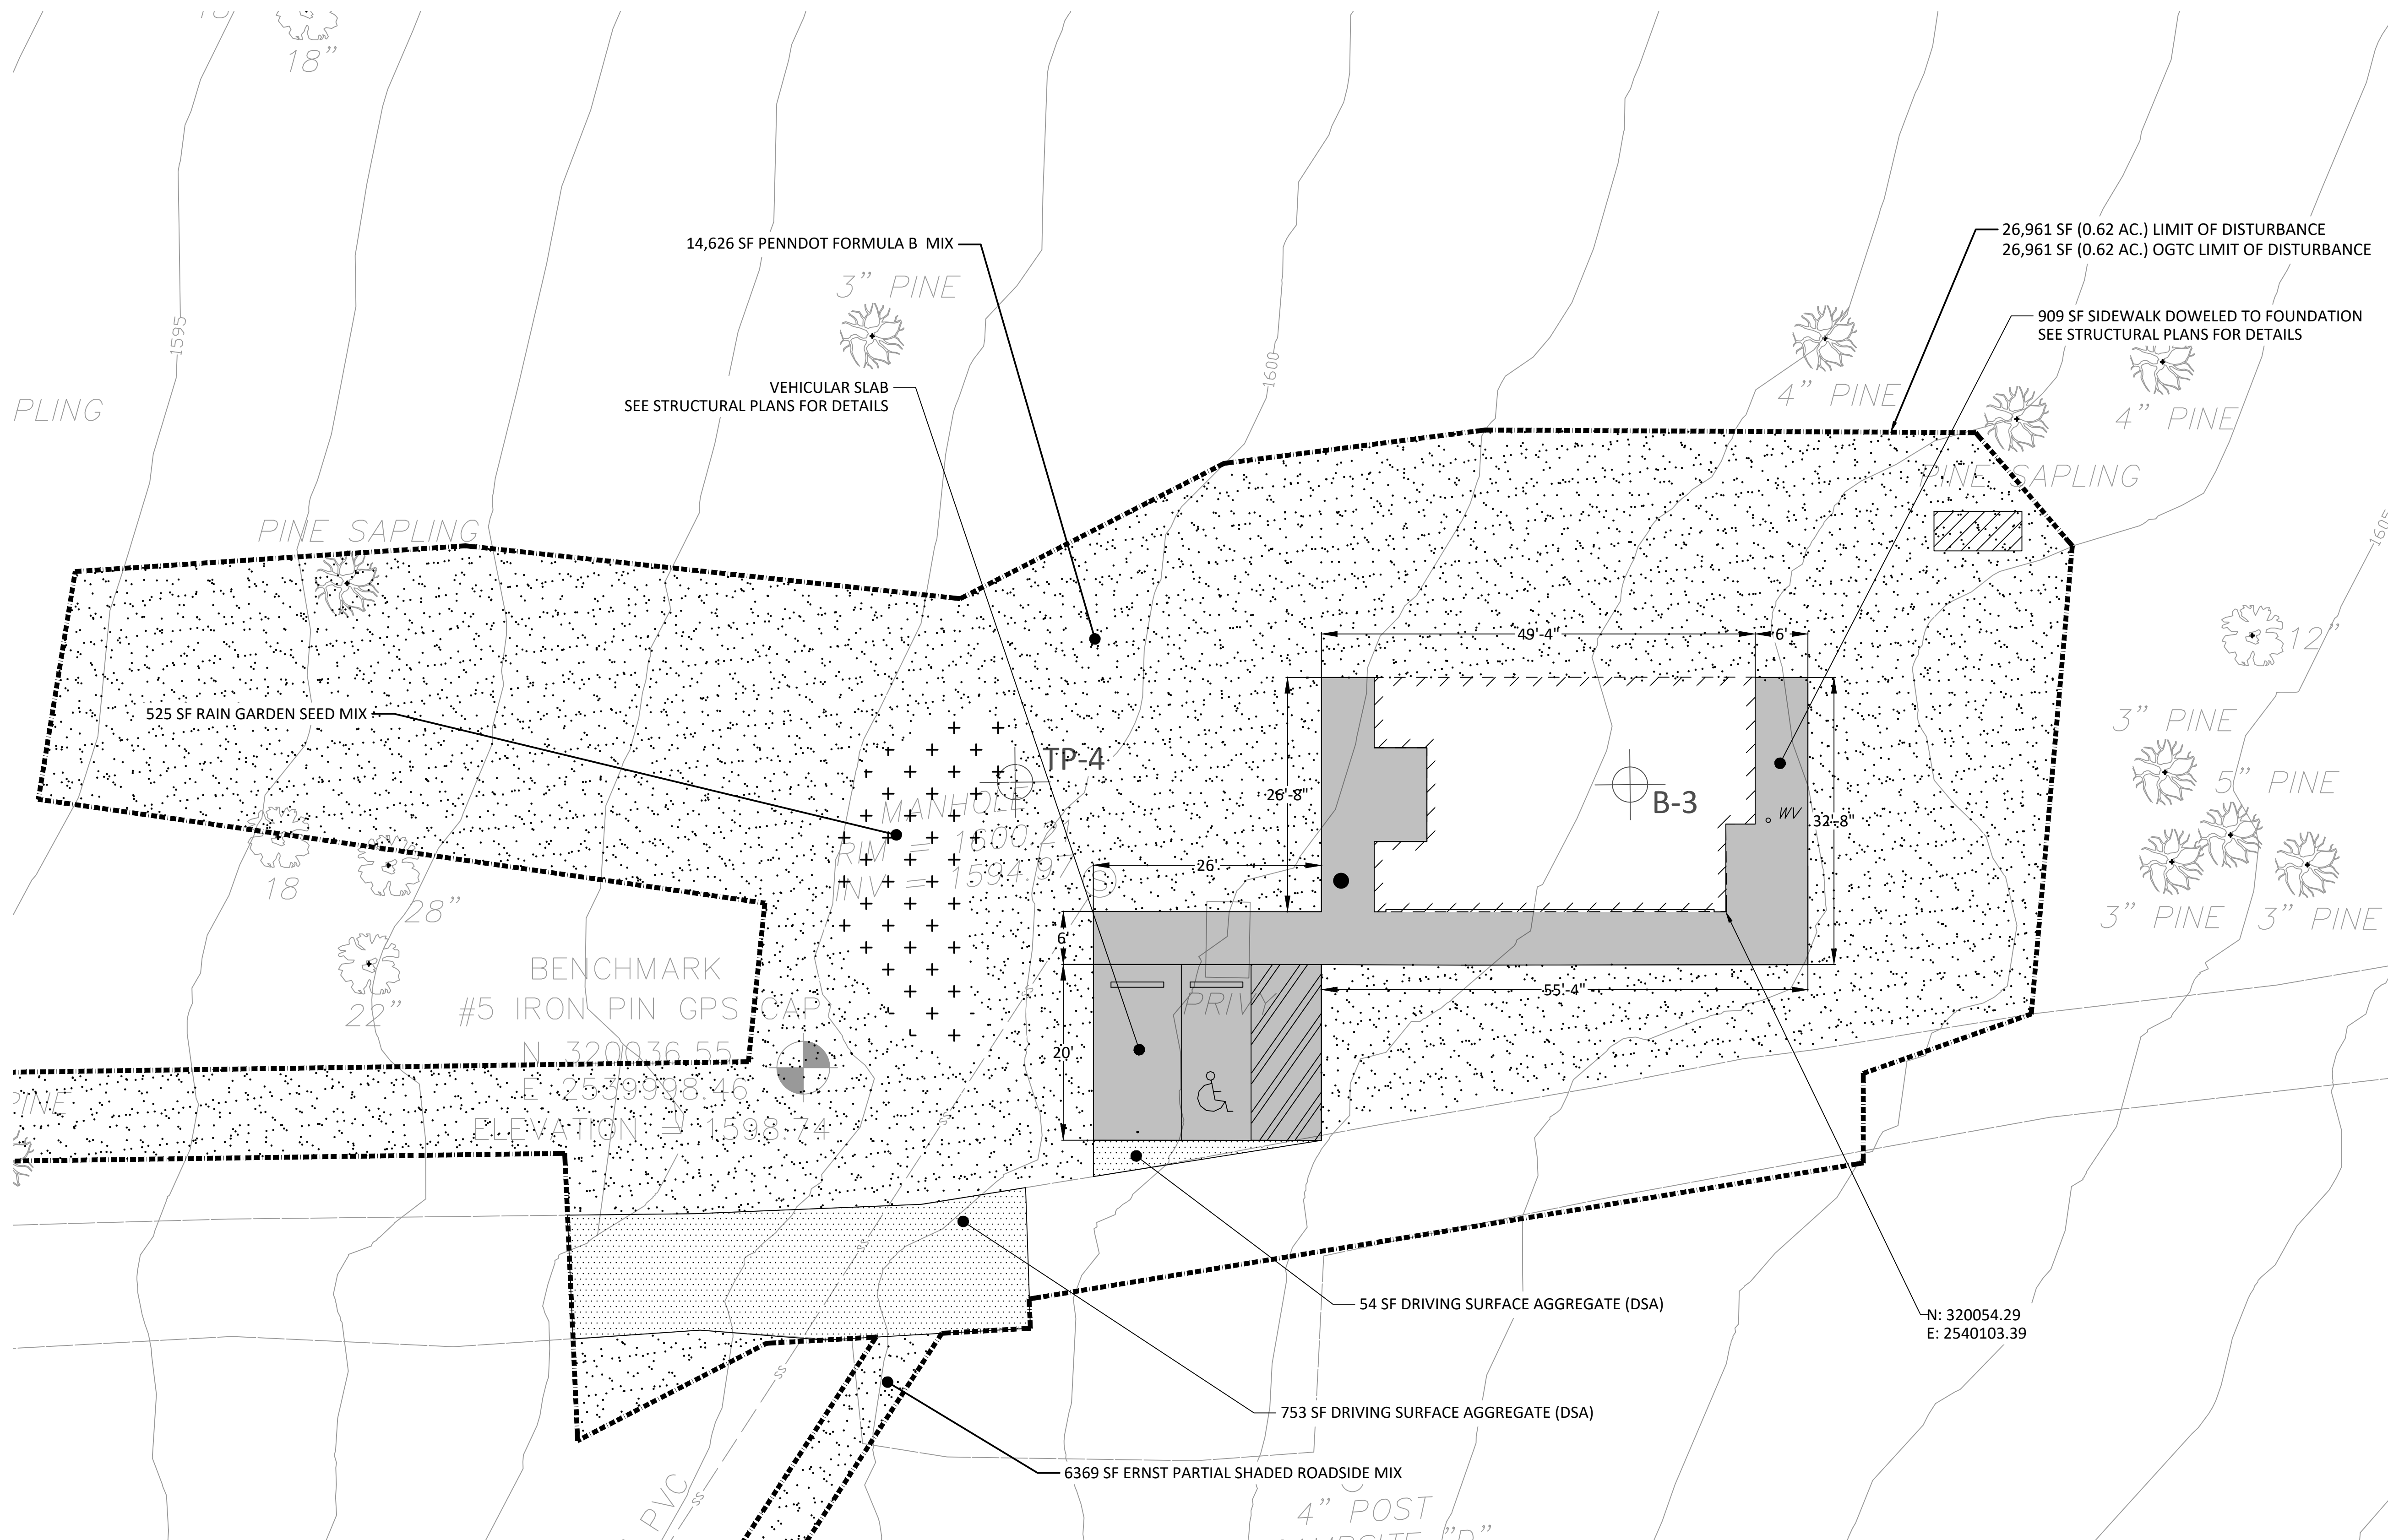

CONSTRUCTION DOCUMENTS



RECORD REVISIONS

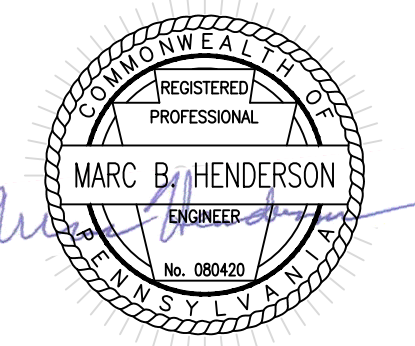

SIGNATURE: *Marc B. Henderson* DATE: 06/15/22

SMP ARCHITECTS
1600 WALNUT STREET, SECOND FLOOR
PHILADELPHIA, PENNSYLVANIA

COMMONWEALTH OF PENNSYLVANIA
DEPARTMENT OF GENERAL SERVICES
HARRISBURG, PENNSYLVANIA


D.G.S. PROJECT No. C-114-0006 PHASE 1

HICKORY RUN STATE PARK
LATRINE IMPROVEMENTS
DEPT of CONSERVATION AND NATURAL RESOURCES
WHITE HAVEN, CARBON COUNTY, PA

SITE PLAN - OGTC

VERIFY SCALE

BAR IS ONE (1) INCH LONG ON ORIGINAL DRAWING:



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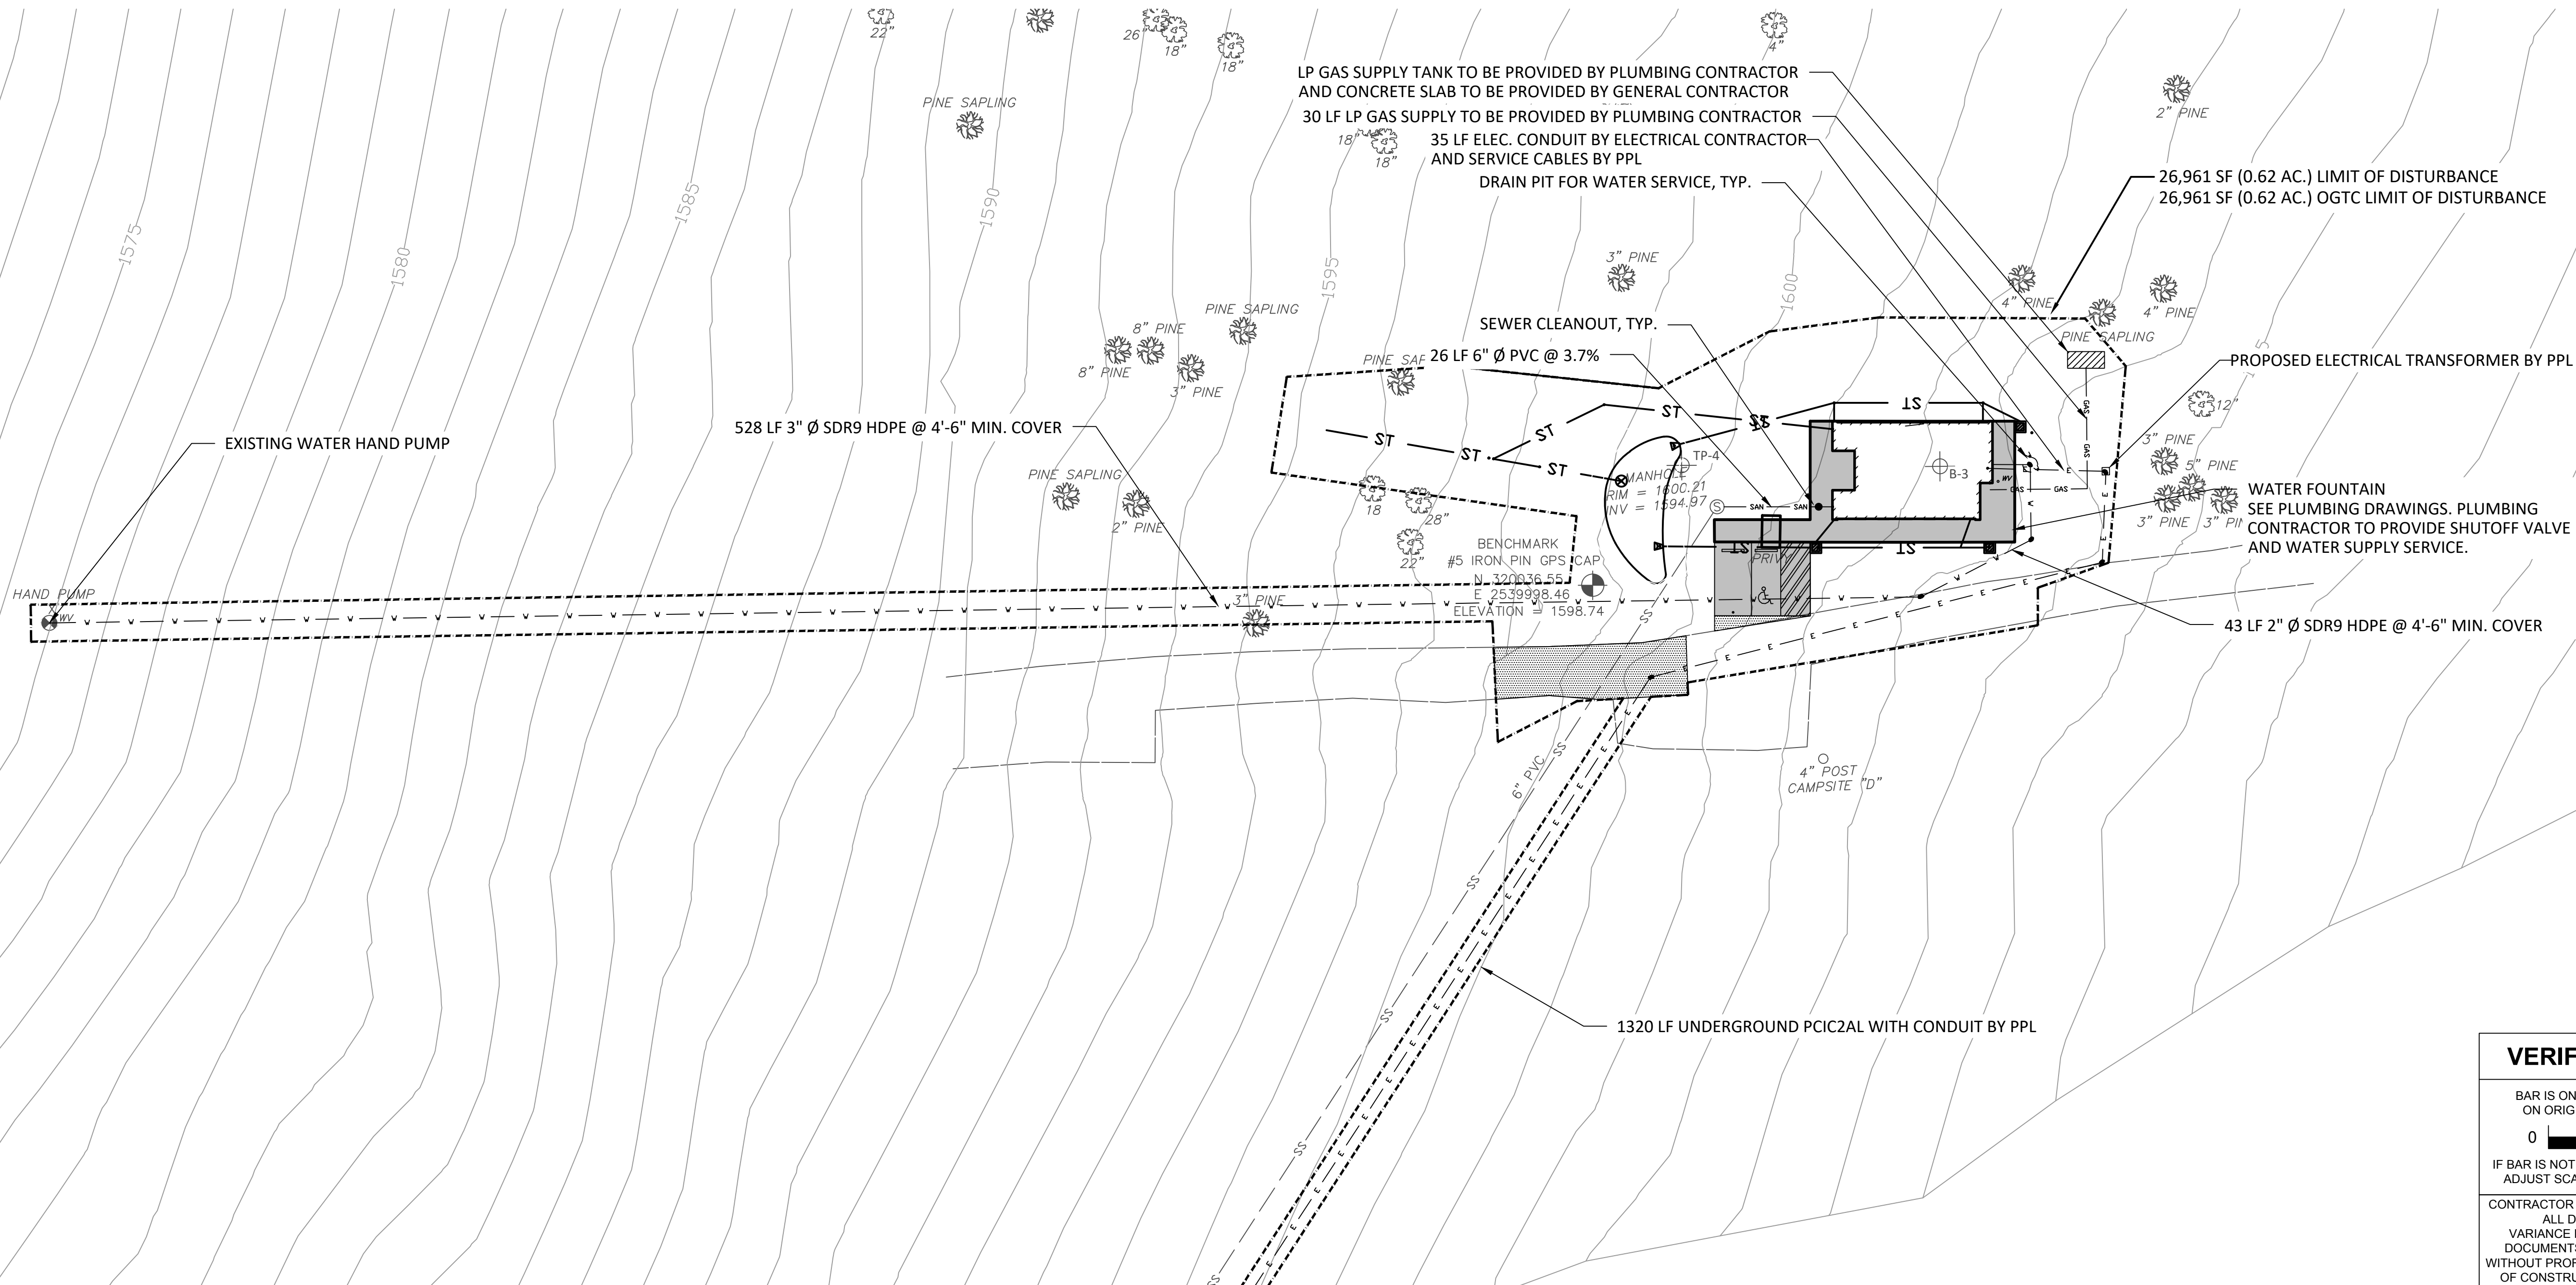
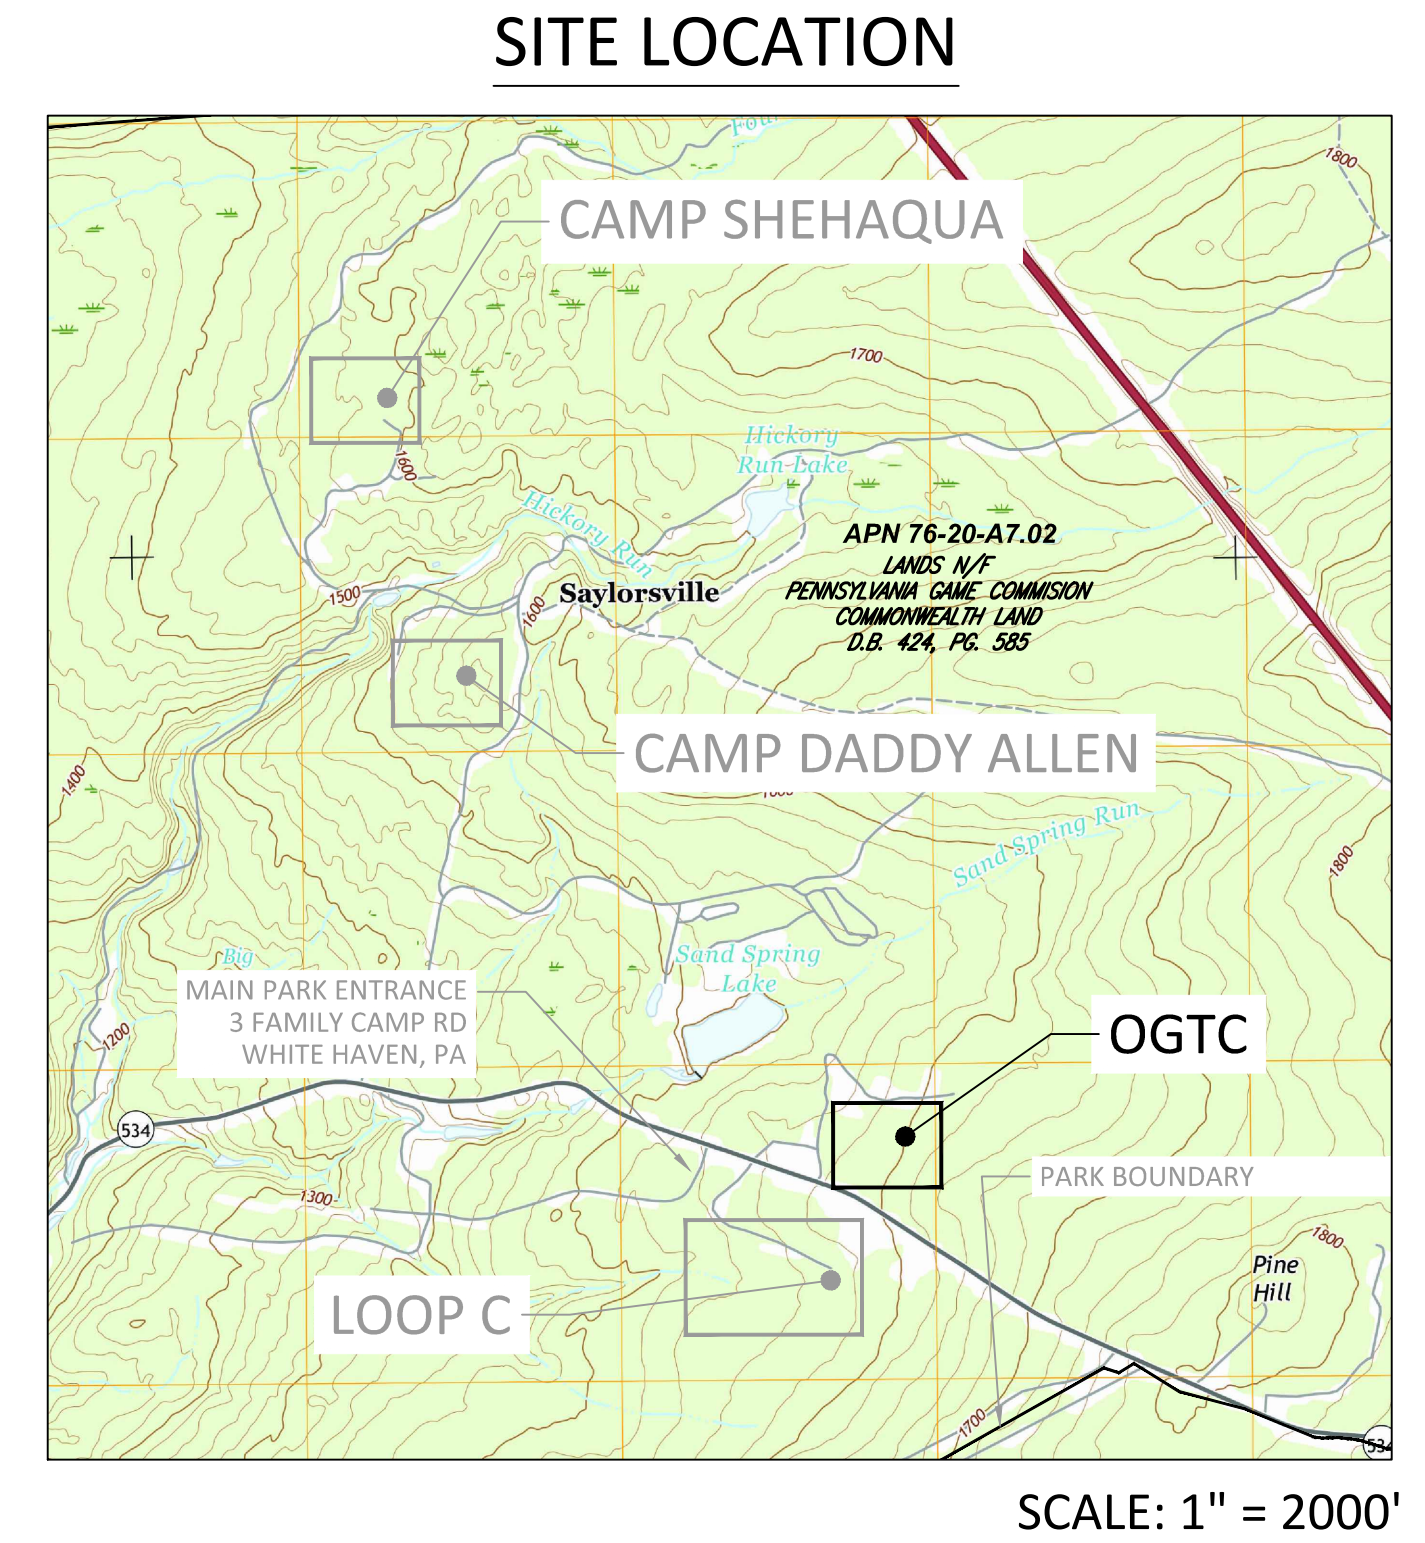
CONTRACTOR SHALL FIELD VERIFY ALL DIMENSIONS. VARIANCE FROM CONTRACT DOCUMENTS NOT PERMITTED WITHOUT PROFESSIONAL & BUREAU OF CONSTRUCTION APPROVAL.

DRAWN BY L GILL	DATE 06/17/2022	DRAWING No. C-14
CHECKED BY M HENDERSON	SCALE AS NOTED	

FILE PATH: I:\2020\09077 - Hickory Run State Park\CAD Sheets\Final\2022 - LANSING\SPRING PLAN.dwg PLOTTED BY: Laura L. Gill
LAST SAVED: 2022.05.05 11:02 AM PLOTTED: 2022.06.15 04:28 PM LAYOUT TAB: SITE PLAN - OGTC

- LEGEND**
- PROJECT BOUNDARY/LIMIT OF DISTURBANCE
 - PROPOSED CONCRETE
 - ▨ PROPOSED DRIVING SURFACE AGGREGATE
 - ⊙ SEWER MANHOLE
 - SEWER CLEANOUT
 - WV WATER VALVE
 - v - v - PROPOSED WATER LINE
 - SAN - SAN - PROPOSED SANITARY SEWER LINE
 - E - E - PROPOSED ELECTRIC LINE
 - ST - ST - STORM PIPE

- Notes**
1. ALL NEW WATER SERVICE TO HAVE 54" MIN. COVER.
 2. ELECTRICAL CONTRACTOR TO PROVIDE TRENCHING, BEDDING, AND BACKFILL PER PPL SPECIFICATIONS AND UTILITY DETAILS FOR ALL ELECTRICAL SERVICES NOTED ON PLANS. IT IS THE ELECTRICAL CONTRACTOR'S RESPONSIBILITY TO COORDINATE FULLY WITH PPL DURING CONSTRUCTION FOR THE INSTALLATION OF THE ELECTRICAL SERVICE AT EACH SITE. SEE NOTES FOR EXTRA CLARIFICATION OF SCOPE ON A SITE BY SITE BASIS.
 3. PLUMBING CONTRACTOR TO PROVIDE TRENCHING, BEDDING, AND BACKFILL PER UTILITY DETAILS FOR ALL WATER AND GAS SERVICES NOTED ON PLANS.
 4. PLUMBING CONTRACTOR TO PROVIDE INSTALLATION OF PROPANE TANK AND SUPPLY LINE TO CONNECT GAS SERVICE. GENERAL CONTRACTOR TO PROVIDE DEVELOPED SITE AND ENCLOSURE PER PLANS FOR TANK INSTALLATION.
 5. PLUMBING CONTRACTOR TO PROVIDE WATER SERVICE TO WATER FOUNTAINS AND DRAIN PITS FOR WATER SERVICE. SEE PLUMBING DRAWINGS FOR DETAILS.
 6. ALL WORK ON THIS DRAWING IS TO BE INCLUDED BY THE GENERAL CONTRACTOR EXCEPT WORK NOTED TO BE BY THE PLUMBING CONTRACTOR OR ELECTRICAL CONTRACTOR.



CONSTRUCTION DOCUMENTS

meliora

259 MORGAN STREET, PHOENIXVILLE, PA 19460
(610) 933-0123
melioradesign.com

NO.	REVISION

RECORD REVISIONS

MARK B. HENDERSON
ENGINEER
No. 08040

SIGNATURE

06/15/22
DATE

SMP ARCHITECTS
1600 WALNUT STREET, SECOND FLOOR
PHILADELPHIA, PENNSYLVANIA

COMMONWEALTH OF PENNSYLVANIA
DEPARTMENT OF GENERAL SERVICES
HARRISBURG, PENNSYLVANIA

D.G.S. PROJECT No.
C-114-0006 PHASE 1

HICKORY RUN STATE PARK
LATRINE IMPROVEMENTS
DEPT of CONSERVATION AND NATURAL RESOURCES
WHITE HAVEN, CARBON COUNTY, PA

VERIFY SCALE

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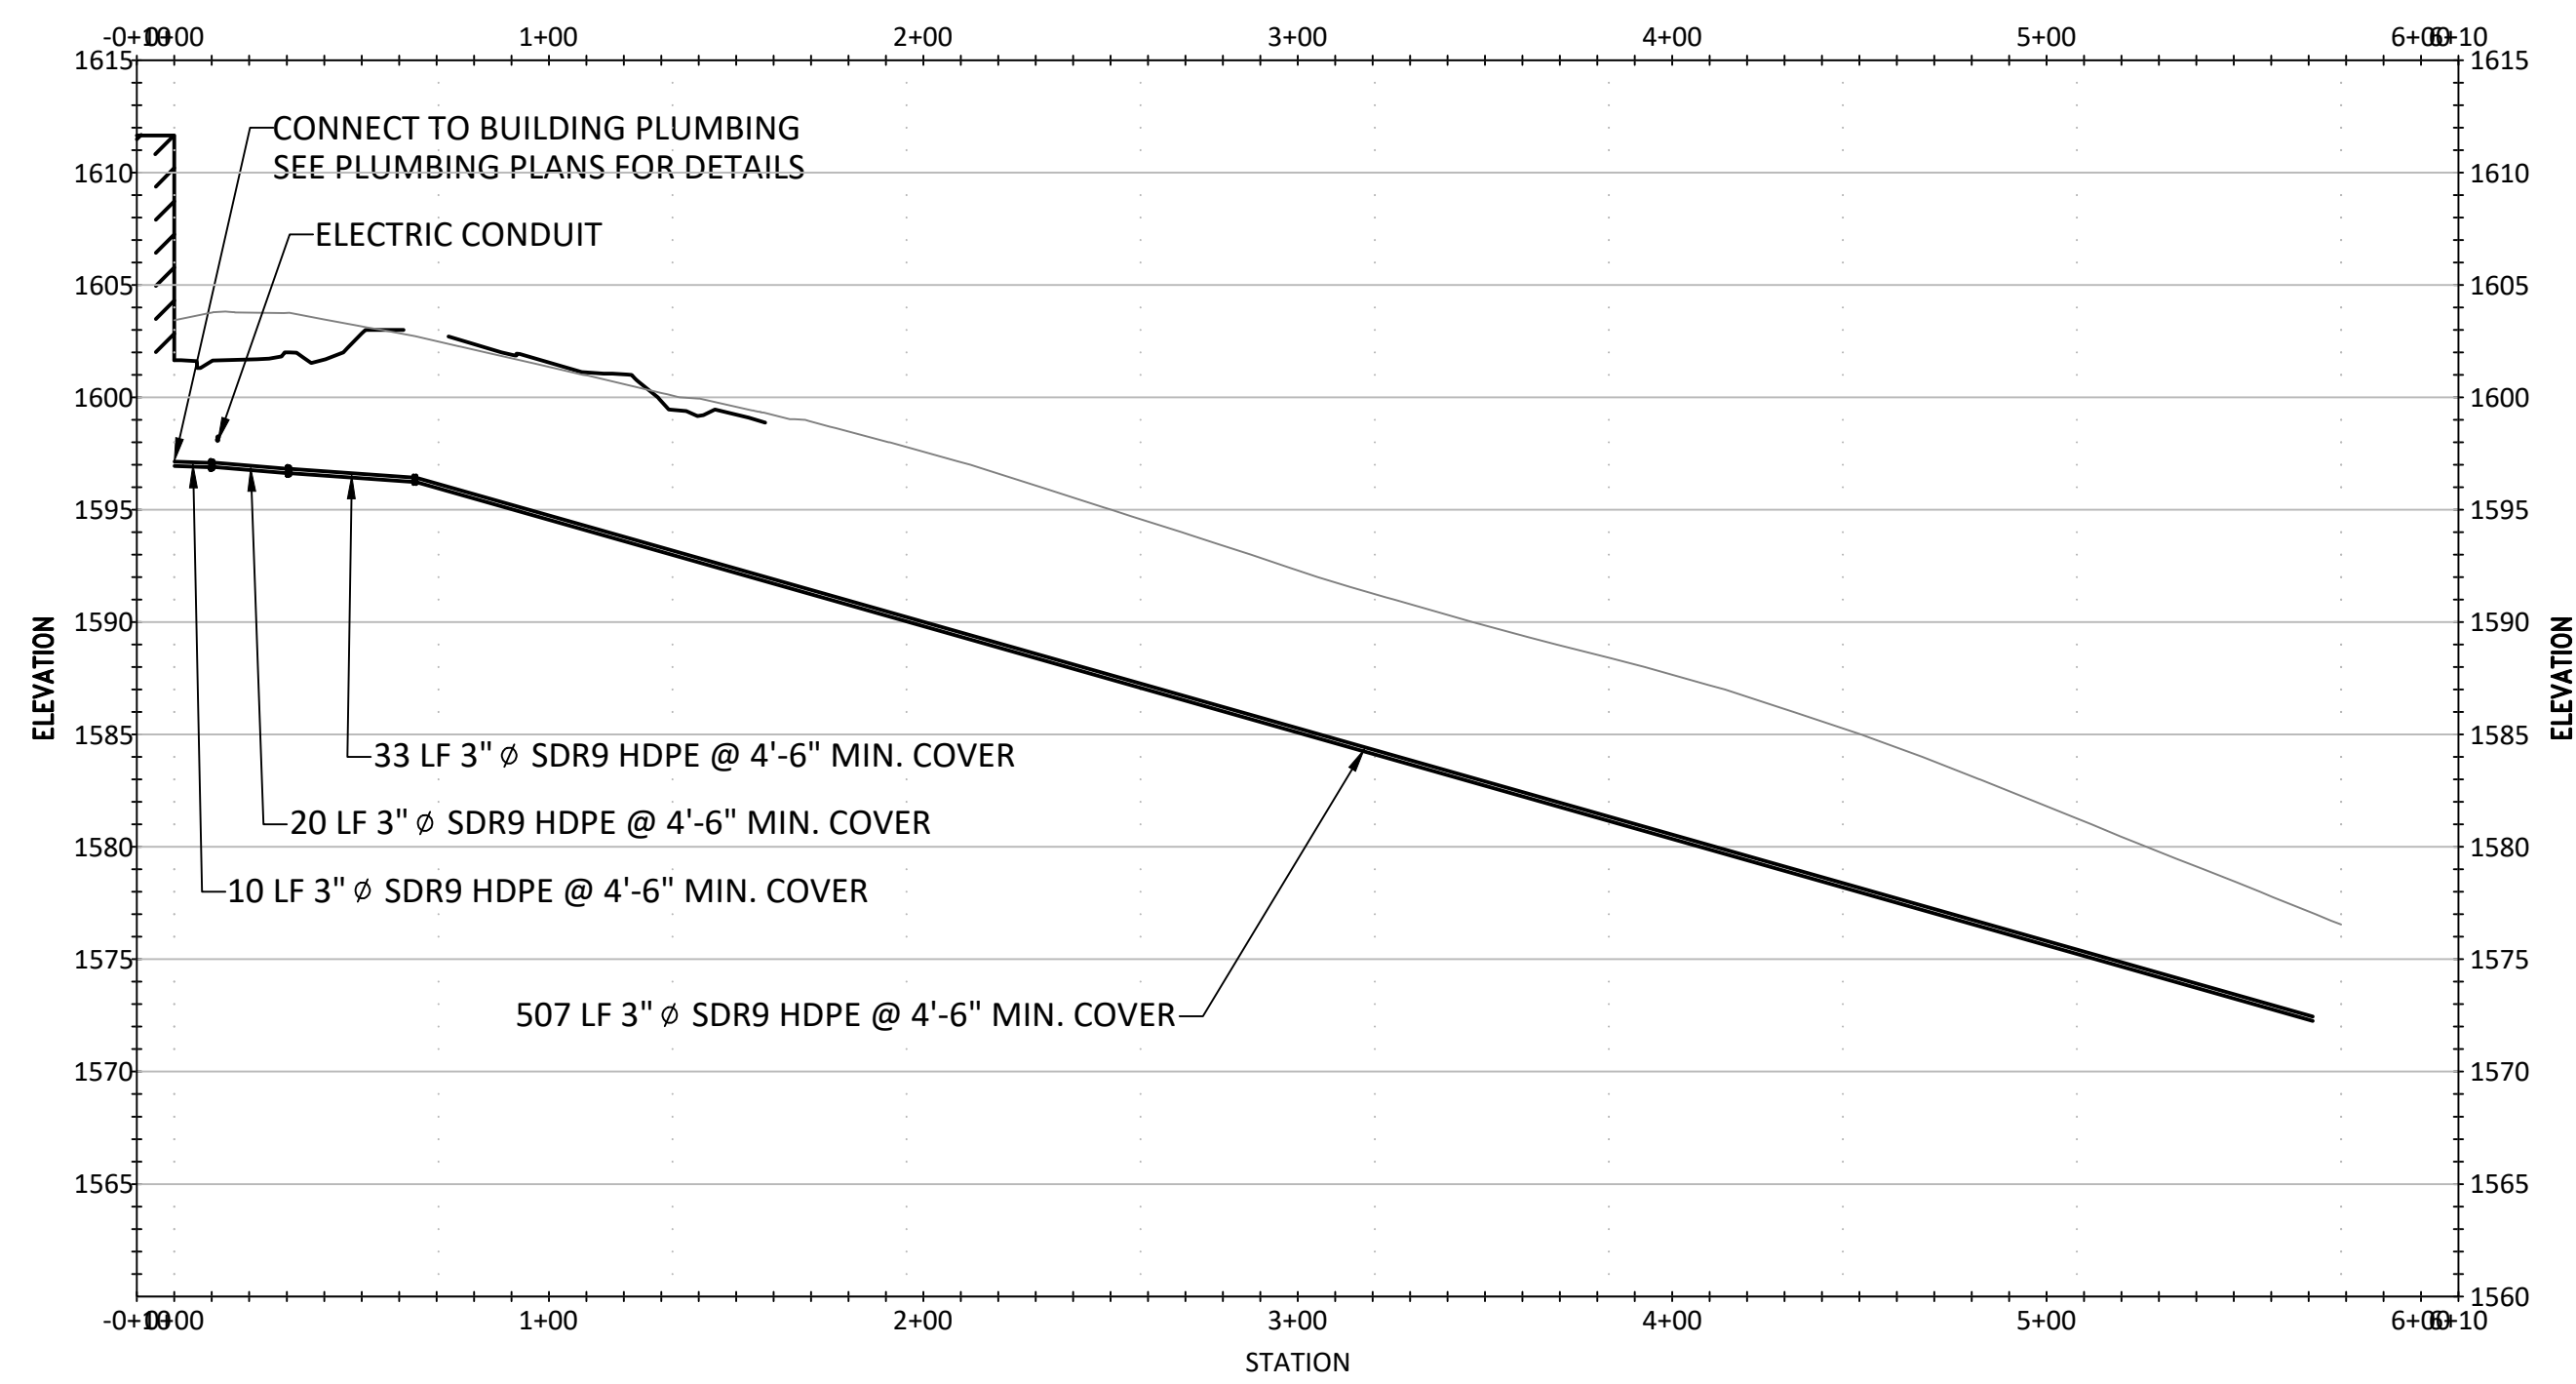
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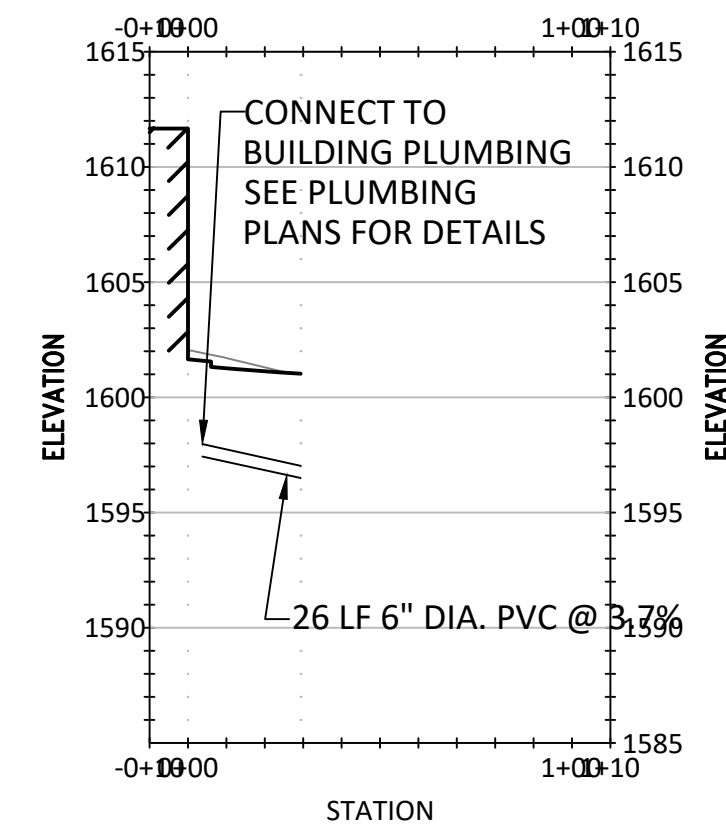
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DRAWN BY L GILL	DATE 06/17/2022	DRAWING No. CPE-15
CHECKED BY M HENDERSON	SCALE AS NOTED	28 OF 144


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LAYOUT TAB: UTILITY PLAN - OGTC
PLOTTED BY: Laura L. Gill
PLOTTED: 2022.06.17 02:24 PM



1 PROFILE VIEW
CPE-16 OGTC - WATER LINE 1"=50' H, 1"=10' V



2 PROFILE VIEW
CPE-16 OGTC - SANITARY SEWER 1"=50' H, 1"=10' V

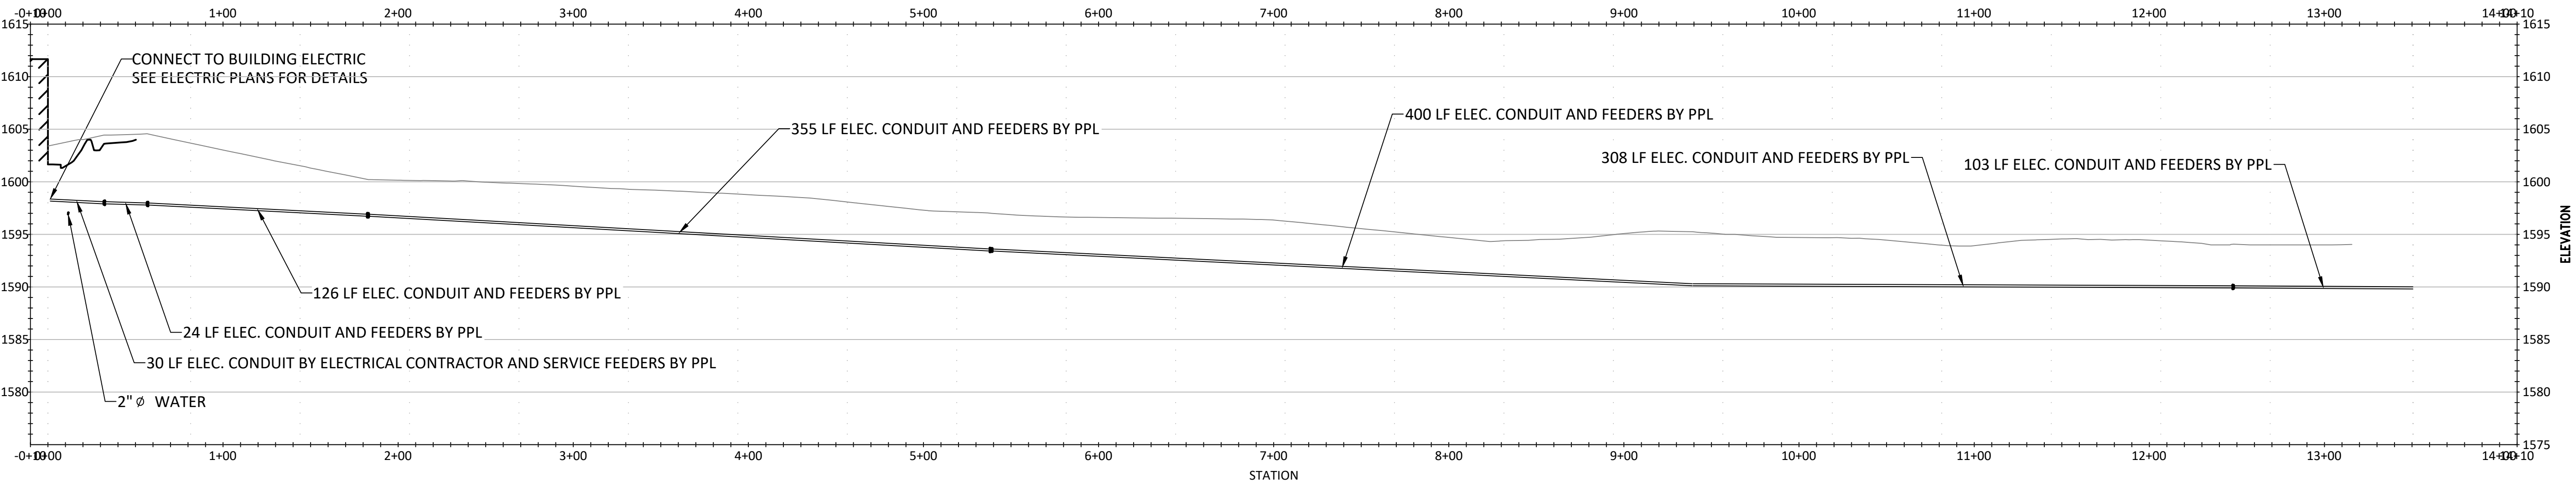

3 PROFILE VIEW
CPE-16 OGTC - ELECTRIC LINE 1"=50' H, 1"=10' V

NOTES:

1. WATER AND SEWER LINES TO BE INSTALLED BELOW FROST DEPTH.
2. ALL WORK ON THIS DRAWING IS TO BE INCLUDED BY THE GENERAL CONTRACTOR EXCEPT WORK NOTED TO BE BY THE PLUMBING CONTRACTOR OR ELECTRICAL CONTRACTOR.

VERIFY SCALE

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0 1
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DRAWN BY L GILL	DATE 06/17/2022	DRAWING No. CPE-16
CHECKED BY M HENDERSON	SCALE AS NOTED	

29 OF 144

CONSTRUCTION DOCUMENTS



RECORD REVISIONS

MARC B. HENDERSON
REGISTERED PROFESSIONAL ENGINEER
No. 08040
06/15/22
SIGNATURE DATE

SMP ARCHITECTS
1600 WALNUT STREET, SECOND FLOOR
PHILADELPHIA, PENNSYLVANIA


COMMONWEALTH OF PENNSYLVANIA
DEPARTMENT OF GENERAL SERVICES
HARRISBURG, PENNSYLVANIA

D.G.S. PROJECT No.
C-114-0006 PHASE 1


HICKORY RUN STATE PARK
LATRINE IMPROVEMENTS
DEPT of CONSERVATION AND NATURAL RESOURCES
WHITE HAVEN, CARBON COUNTY, PA

UTILITY PROFILES - CAMP OGTC

- LEGEND**
- EXISTING 6" PVC GRAVITY SEWER
 - EXISTING WATER MAIN
 - EXISTING UTILITY POLE
 - EXISTING POWER LINE
 - EXISTING TREE
 - EXISTING CONTOUR
 - LEGAL RIGHT-OF-WAY LINE
 - EXISTING EDGE OF PAVEMENT
 - TEXT FOR EXISTING ITEMS
 - WOODS LINE
 - EXISTING STORM SEWER
 - EXISTING SANITARY MANHOLE
 - SOIL TEST PIT (TP) OR BORING (B) LOCATION
 - SLOPES 15%-25%
 - SLOPES >25%

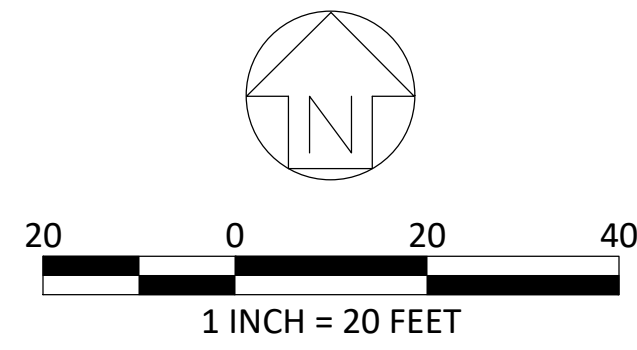

SITE LOCATION

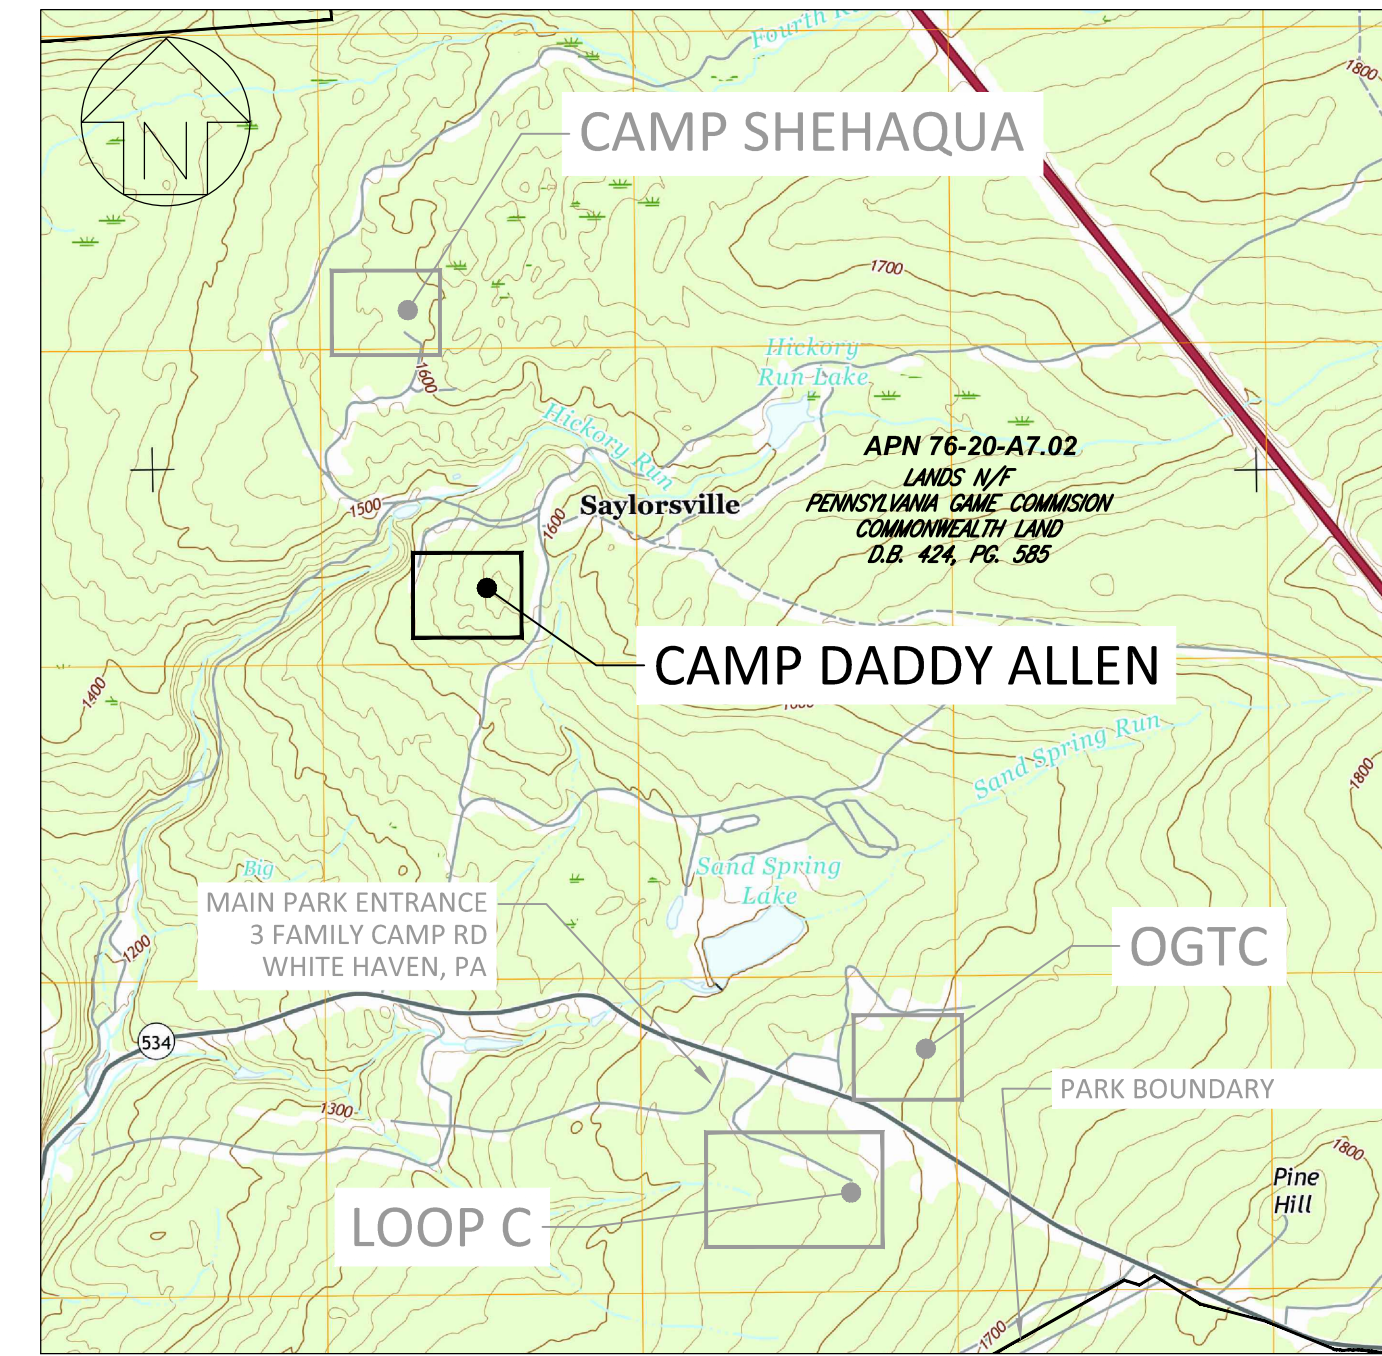

SCALE: 1" = 2000'

CONSTRUCTION DOCUMENTS

meliora

259 MORGAN STREET, PHOENIXVILLE, PA 19460
(610) 933-0123
melioradesign.com

RECORD REVISIONS

MARC B. HENDERSON
ENGINEER
No. 08840

Marc Henderson 06/15/22
SIGNATURE DATE

SMP ARCHITECTS
1600 WALNUT STREET, SECOND FLOOR
PHILADELPHIA, PENNSYLVANIA

COMMONWEALTH OF PENNSYLVANIA
DEPARTMENT OF GENERAL SERVICES
HARRISBURG, PENNSYLVANIA

D.G.S. PROJECT No.
C-114-0006 PHASE 1

HICKORY RUN STATE PARK
LATRINE IMPROVEMENTS
DEPT of CONSERVATION AND NATURAL RESOURCES
WHITE HAVEN, CARBON COUNTY, PA

EXISTING CONDITIONS PLAN -
CAMP DADDY ALLEN

VERIFY SCALE

BAR IS ONE (1) INCH LONG
ON ORIGINAL DRAWING:

0 1

IF BAR IS NOT ONE (1) INCH LONG,
ADJUST SCALE ACCORDINGLY

CONTRACTOR SHALL FIELD VERIFY
ALL DIMENSIONS.
VARIANCE FROM CONTRACT
DOCUMENTS NOT PERMITTED
WITHOUT PROFESSIONAL & BUREAU
OF CONSTRUCTION APPROVAL.

DRAWN BY	DATE	DRAWING No.
CHECKED BY	SCALE	C-17
	AS NOTED	30 OF 144

FILE PATH: I:\2020\0907 - Hickory Run State Park\CAD\Shehaqua\2022\CAD\2022_06_15_04:35 PM PLOTTED BY: Laura L. Gill
LAYOUT TAB: EXISTING CONDITIONS PLAN - CAMP DADDY ALLEN

CONSTRUCTION SEQUENCE

THE CONSTRUCTION PLANS HAVE BEEN DEVELOPED BASED ON AVAILABLE INFORMATION PROVIDED BY DCNR (INCLUDING A COMPREHENSIVE SITE SURVEY). THE PROJECT AREA INCLUDES EXISTING UTILITIES OF UNKNOWN LOCATION AND DEPTH. ACTUAL CONDITIONS MAY DIFFER FROM THE PLANS. THE CONTRACTOR IS RESPONSIBLE FOR VERIFYING ALL CONDITIONS PRIOR TO INITIATING WORK, AND FOR NOTIFYING THE DEPARTMENT IMMEDIATELY UPON BECOMING AWARE OF POTENTIAL CONFLICTS OR VARIATIONS IN CONDITIONS. THE CONTRACTOR IS RESPONSIBLE FOR FIELD VERIFICATION OF ALL UTILITY AND STRUCTURE LOCATIONS AND ELEVATIONS AS REQUIRED FOR CONSTRUCTION. THE SITE WORK INCLUDES THE CONSTRUCTION OF MULTIPLE COMPONENTS INCLUDING BUT NOT LIMITED TO THE INSTALLATION OF:

- EROSION AND SEDIMENTATION CONTROL MEASURES
- DEMOLITION OF ASSOCIATED SITE FEATURES AND REMOVAL OF PAVEMENT
- INSTALL NEW UTILITIES (STORMWATER, WATER, SANITARY SERVICE)
- STORMWATER PIPES AND STRUCTURES THAT CONVEY RUNOFF
- SITE IMPROVEMENT FEATURES
- PAVING AND STRIPING PARKING AREAS
- INSTALLATION OF LANDSCAPE COMPONENTS

DOCUMENTATION FOR THESE SITE COMPONENTS IS PROVIDED ON MULTIPLE PLAN SHEETS AND SPECIFICATIONS. THE GENERAL CONTRACTOR IS RESPONSIBLE FOR CONSTRUCTION OF ALL SITE IMPROVEMENTS IN A MANNER TO AVOID CONFLICTS AND DAMAGE TO EXISTING SYSTEMS OR SITE COMPONENTS AS PART OF THIS PROJECT. UPON COMPLETION OR TEMPORARY CESSATION OF EARTH DISTURBANCE ACTIVITIES OR ANY STAGE THEREOF, THE PROJECT SHALL BE IMMEDIATELY STABILIZED WITH THE APPROPRIATE TEMPORARY OR PERMANENT STABILIZATION. ALL EARTH DISTURBANCE ACTIVITIES SHALL PROCEED IN ACCORDANCE WITH THE FOLLOWING SEQUENCE. EACH STAGE SHALL BE COMPLETED BEFORE ANY FOLLOWING STAGE IS INITIATED. CLEARING AND GRUBBING SHALL BE LIMITED ONLY TO THOSE AREAS DESCRIBED IN EACH STAGE.

1. STATE LAW REQUIRES A MINIMUM THREE DAY BUSINESS DAY NOTICE, BUT NOT MORE THAN TEN BUSINESS DAYS, PRIOR TO EARTH DISTURBANCE. ORDER A UTILITY MARK OUT UTILIZING THE PENNSYLVANIA ONE CALL SYSTEM. SITE UTILITIES MUST BE FIELD LOCATED AND MARKED BEFORE THE START OF ANY SITE WORK, INCLUDING ALL PRIVATE UTILITIES. CONFIRM LOCATIONS AND INVERTS.
2. THE GENERAL CONTRACTOR SHALL SCHEDULE A PRE-CONSTRUCTION MEETING WITH DCNR PROJECT MANAGER AND DESIGN PROFESSIONAL OF RECORD. THE PROJECT DISTURBANCE AREA SHALL BE REVIEWED AT THIS MEETING. AN ON-SITE PRE-CONSTRUCTION MEETING IS REQUIRED TO OCCUR NO LESS THAN 7- DAYS PRIOR TO ANY EARTH DISTURBANCE UNLESS NOTIFIED OTHERWISE BY NERO DEP OR THE CARBON COUNTY CONSERVATION DISTRICT. PERMITTEES, CO-PERMITTEES, OPERATORS, ALL APPROPRIATE MUNICIPAL OFFICIALS, REPRESENTATIVES FROM THE CARBON COUNTY CONSERVATION DISTRICT AND THE NERO DEP, AND LICENSED PROFESSIONALS OR DESIGNEES RESPONSIBLE FOR THE EARTH DISTURBANCE ACTIVITY, INCLUDING IMPLEMENTATION OF E&S AND PCSM PLANS AND CRITICAL STAGES OF IMPLEMENTATION OF THE APPROVED PCSM PLAN, SHALL ATTEND A PRECONSTRUCTION MEETING. AT LEAST 7 DAYS BEFORE STARTING ANY EARTH DISTURBANCE ACTIVITIES,
3. UPON COMPLETION OR TEMPORARY CESSATION OF THE EARTH DISTURBANCE ACTIVITY EXCEEDING 4 DAYS, OR ANY STAGE THEREOF, THE PROJECT SITE SHALL BE IMMEDIATELY STABILIZED WITH THE APPROPRIATE TEMPORARY OR PERMANENT STABILIZATION.

CAMP DADDY ALLEN

1. INSTALL CONSTRUCTION FENCING, ROCK CONSTRUCTION ENTRANCE, TREE PROTECTION, COMPOST SOCK AND SEDIMENT TRAP AS SHOWN ON THE PLAN. NO DISTURBANCE CAN TAKE PLACE OUTSIDE OF THE LIMIT OF DISTURBANCE.
2. REMOVE TOPSOIL ONLY IN AREAS TO BE GRADED AND STOCKPILE IN AREA DELINEATED ON PLAN. INSTALL COMPOST SOCK AROUND STOCKPILE AS SHOWN. TOPSOIL IS TO REMAIN SEPARATE FROM SUBSOIL MATERIAL. TOPSOIL IS NOT TO LEAVE THE SITE WITHOUT WRITTEN PERMISSION OF THE DEPARTMENT.
3. PERFORM SITE DEMOLITION OF EXISTING BUILDING AND STRUCTURES AS INDICATED ON PLAN. ONLY DEMOLISH EXISTING STORMWATER PIPES AND INLETS AS THEY ARE REPLACED OR AFTER NEW CONVEYANCE IS PROVIDED. EXISTING BUILDINGS TO BE DEMOLISHED AFTER NEW BUILDINGS ARE COMPLETE.
4. INSTALL RAIN GARDEN. (CRITICAL STAGE)
5. INSTALL STRUCTURES AND STORMWATER PIPES AS INDICATED ON POST-CONSTRUCTION STORMWATER MANAGEMENT PLAN.
6. THE FOLLOWING ITEMS ARE TO BE INSTALLED AS APPROPRIATE TO LOCATION AND ELEVATIONS ON THE PLAN:
 - b. PERFORM MAJOR EXCAVATIONS AND ROUGH GRADE FOR CURB INSTALLATION AS INDICATED ON GRADING PLAN, REMOVING ANY DELETERIOUS MATERIAL 2-INCHES OR LARGER. REMOVE EXCESS CUT FROM SITE AND DISPOSE OF IN A LEGAL MANNER IN ACCORDANCE WITH THE SOLID WASTE MANAGEMENT REGULATIONS.
 - c. INSTALL BUILDING COMPONENTS AS REQUIRED.
7. INSTALL WATER AND SANITARY UTILITIES AS APPROPRIATE TO LOCATION AND ELEVATIONS ON PLAN. LIMIT THE TOTAL LENGTH OF EXCAVATED TRENCH OPEN AT ANY ONE TIME TO THAT WHICH CAN BE EXCAVATED AND BACK-FILLED IN ONE WORKING DAY. NO MORE THAN 50 LINEAR FEET OF OPEN TRENCH SHOULD EXIST WHEN UTILITY LINE INSTALLATION CEASES AT THE END OF ANY WORK DAY. IMMEDIATELY STABILIZE DISTURBED AREAS.
8. GRADE AS SHOWN ON PLANS AND DETAILS. INSTALL EROSION CONTROL BLANKET IN AREAS SHOWN FOLLOWING ESTABLISHMENT OF FINAL GRADE. COORDINATE INSTALLATION WITH RIPARIAN BUFFER INSTALLATION AND LANDSCAPE RESTORATION.
9. INSTALL PAVEMENT AS SHOWN ON PLANS AND DETAILS. FINAL WEARING COURSE FOR ALL ASPHALT TO BE INSTALLED FOLLOWING COMPLETION OF ALL 4 PHASES OF CONSTRUCTION.
10. STRIPE PARKING AREAS AND INSTALL ANY MISCELLANEOUS SITE FEATURES AS APPROPRIATE SUCH AS SIGNS, WHEEL STOPS, ETC. FOLLOWING WEARING COURSE INSTALLATION.
11. AFTER FINAL SITE STABILIZATION HAS BEEN ACHIEVED (VEGETATED AREAS SHALL BE CONSIDERED PERMANENTLY STABILIZED WHEN A UNIFORM 70% VEGETATIVE COVER OF EROSION RESISTANT PERENNIAL SPECIES HAS BEEN ACHIEVED), REMOVE TEMPORARY EROSION AND SEDIMENTATION INLET PROTECTION CONTROLS ONLY. AREAS DISTURBED DURING REMOVAL OF THE CONTROLS MUST ALSO BE STABILIZED IMMEDIATELY.

PCSM BMP INSTALLATION

1. TO AVOID SOIL DISTURBANCE AND COMPACTION DURING CONSTRUCTION, AREAS FOR PROPOSED INFILTRATION STORMWATER MANAGEMENT PRACTICES MUST BE PHYSICALLY STAKED OUT BEFORE ANY SITE WORK BEGINS.
2. THE GENERAL CONTRACTOR SHALL FENCE OFF THE LOCATIONS OF ANY FUTURE INFILTRATION AREAS. THESE AREAS SHALL BE PROTECTED FROM COMPACTION AND HEAVY VEHICLE DISTURBANCE THROUGHOUT CONSTRUCTION.
3. ORDER A UTILITY MARK OUT UTILIZING THE PENNSYLVANIA ONE CALL SYSTEM. SITE UTILITIES MUST BE FIELD LOCATED AND MARKED BEFORE THE START OF ANY SITE WORK, INCLUDING ALL PRIVATE UTILITIES.
4. ALL REGULATORY AGENCIES INCLUDING KIDDER TOWNSHIP AND THE LOCAL CONSERVATION DISTRICT SHOULD BE NOTIFIED FOR INSPECTION AT LEAST THREE (3) DAYS IN ADVANCE OF THE CONSTRUCTION OF STORMWATER MANAGEMENT PRACTICES.
5. REMOVE TOPSOIL ONLY IN AREAS TO BE GRADED AND STOCKPILE IN AREA DELINEATED ON PLAN. INSTALL COMPOST SOCK AROUND STOCKPILE AS SHOWN. TOPSOIL IS TO REMAIN SEPARATE FROM SUBSOIL MATERIAL. TOPSOIL IS NOT TO LEAVE THE SITE WITHOUT WRITTEN PERMISSION OF OWNER.
6. EXCAVATION WILL BE REQUIRED TO REMOVE SURFACE HARDPAN AND ACHIEVE FINAL STONE BED BOTTOM GRADES. ONCE FINAL EXCAVATION IS COMPLETED, USE ORANGE PLASTIC CONSTRUCTION FENCE OR OTHER MEANS AS NECESSARY TO PROTECT THESE AREAS FROM COMPACTION OR SILTATION.
7. THE PERMITTEE SHALL PROVIDE ENGINEERING CONSTRUCTION OVERSIGHT FOR THE PROPOSED STORMWATER BMPS. ADDITIONAL SOIL TESTING MAY BE REQUIRED PRIOR TO THE INSTALLATION OF BMPS TO ENSURE PROPER LOCATION AND FUNCTION. A LICENSED PROFESSIONAL ENGINEER KNOWLEDGEABLE IN THE DESIGN AND CONSTRUCTION OF STORMWATER BMPS, PREFERABLY THE DESIGN PROFESSIONAL, SHALL CONDUCT THE OVERSIGHT.
8. ALL CRITICAL STAGES OF IMPLEMENTATION OF THE PCSM PLAN REQUIRE THE DESIGN PROFESSIONAL TO BE PRESENT ON SITE.
9. INSTALL THE RAIN GARDENS. **CRITICAL STAGE**
 - 9.1. ROUGH GRADE RAIN GARDENS. DO NOT COMPACT FOOTPRINT.
 - 9.2. PLACE NON-WOVEN GEOTEXTILE AND BACKFILL THE EXCAVATED AREA WITH CLEAN-WASHED STONE AS SOON AS POSSIBLE TO AVOID ACCUMULATION OF DEBRIS. PLACE CLEAN-WASHED STONE STORAGE. WRAP FULLY WITH GEOTEXTILE. PLACE RAIN GARDEN SOILS IN 12- TO 18-INCH LIFTS, AND TAMP LIGHTLY BY HAND OR COMPACT BY WATERING EACH LIFT. SLIGHT OVERFILLING MIGHT BE NECESSARY TO ACCOUNT FOR SETTLEMENT. PRESOAK THE SOIL AT LEAST ONE DAY PRIOR TO FINAL GRADING AND LANDSCAPING TO ALLOW FOR SETTLEMENT.
 - 9.3. AFTER ALLOWING FOR SETTLEMENT, COMPLETE FINAL GRADING WITHIN ABOUT TWO INCHES OF THE PROPOSED DESIGN ELEVATION, LEAVING SPACE FOR TOP DRESSING.

- 9.4. INSTALL ANY REMAINING STORMWATER STRUCTURES. CONNECT OVERFLOW STRUCTURES PER PLAN. INSTALL INLET PROTECTION AND DO NOT ALLOW SEDIMENT INTO PIPES AND STRUCTURES.
- 9.5. ANY STONE WITHIN THE INFILTRATION SMP MUST REMAIN FREE OF SEDIMENT AND MEET THE WASHED STONE SPECIFICATIONS. IF SEDIMENT ENTERS THE STONE, THE GENERAL CONTRACTOR MAY BE REQUIRED TO REMOVE THE SEDIMENT AND REPLACE WITH CLEAN WASHED STONE.
10. INSTALL REMAINING STORMWATER STRUCTURES AND PIPES AS INDICATED ON POST-CONSTRUCTION STORMWATER MANAGEMENT PLAN.
11. UPON COMPLETION OF ALL EARTH DISTURBANCE ACTIVITIES AND PERMANENT STABILIZATION OF ALL DISTURBED AREAS, THE OWNER AND/OR OPERATOR SHALL CONTACT APPROPRIATE REGULATORY AGENCIES FOR A FINAL INSPECTION PRIOR TO REMOVAL/CONVERSION OF THE E&S BMPS.
12. REMOVE TEMPORARY EROSION CONTROL MEASURES AS APPROPRIATE.
13. THE NPDES NOTICE OF TERMINATION (N.O.T.) MUST BE SUBMITTED TO PA DEP UPON COMPLETION OF CONSTRUCTION (WHEN APPLICABLE).

THE FOLLOWING ARE CRITICAL STAGES OF IMPLEMENTATION OF THE PCSM PLAN FOR WHICH THE DESIGN PROFESSIONAL SHOULD BE PRESENT ON SITE:

1. INFILTRATION BED EXCAVATION
2. INFILTRATION BED INSTALLATION
3. RAIN GARDEN INSTALLATION
4. INFILTRATION BERM INSTALLATION
5. LEVEL SPREADER INSTALLATION
6. LANDSCAPE RESTORATION

Map unit symbol	Map unit name	Small Commercial Buildings		Shallow Excavations		Unpaved Local Roads and Streets		Resolutions
		Rating	Rating reasons (numeric values)	Rating	Rating reasons (numeric values)	Rating	Rating reasons (numeric values)	
SwD	Swartswood very stony loam, 8 to 25 percent slopes	Very limited	Slope (1.00)	Very limited	Depth to saturated zone (1.00)	Very limited	Slope (1.00)	Future Building sites were evaluated for subsurface conditions and those conditions informed the design of foundations. All roadwork proposed is the restoration of existing unpaved access roads within the park therefore the subbase and general conditions below the unpaved road have previously been improved and addressed for frost action and saturation depth. Geotechnical investigations have also identified depth to saturated zones and this information has also informed design of stormwater features which account for most shallow excavations on site. Utility installations are at risk of conflict with rock, cemented pans, saturated zones, and also unstable excavation walls and notes have been included to notify Engineer should these undesirable conditions be discovered during construction. Erosion control blanket is shown on slopes exceeding 3H:1V. All access roads are unpaved but improved roads which will limit dusty conditions of the native soil.
			Depth to saturated zone (0.05)		Slope (1.00)		Frost action (0.50)	
		Dusty (0.02)	Dusty (0.02)	Depth to saturated zone (0.02)				
		Unstable excavation walls (0.01)	Dusty (0.02)					
TuD	Tunkhannock gravelly loam, 15 to 25 percent slopes	Very limited	Slope (1.00)	Very limited	Slope (1.00)	Very limited	Slope (1.00)	
					Dusty (0.01)		Dusty (0.01)	
					Unstable excavation walls (0.01)			

PCSM BMP MAINTENANCE SCHEDULE			
BMP TYPE	INSPECTION SCHEDULE	MAINTENANCE DIRECTIONS	REPAIRS
RAIN GARDENS	BEFORE AND AFTER MAJOR PRECIPITATION EVENTS AND IF SIGNS OF EROSION, CLOGGING, OR PLANT DAMAGE OCCUR	REMOVE DEBRIS FROM RAIN GARDENS REGULARLY. INSPECT FOR SIGNS OF EROSION (GULLIES), CLOGGING (PONDED WATER), AND DAMAGE TO VEGETATION.	REPAIR ERODED AREAS BY ADJUSTING GRADES PER DESIGN TO AVOID CONCENTRATED FLOWS BY USING EROSION CONTROL BLANKET OR BY ESTABLISHING VEGETATION. CLOGGING OF RAIN GARDEN SOILS MAY REQUIRE SOIL AMENDMENT, REPLACEMENT, OR A HYDRAULIC CONNECTION TO A PIPE OR SUBSURFACE STONE BED THAT IS NOT CLOGGED. DAMAGE TO VEGETATION SHOULD BE CONDUCTED PER THE ADVICE OF A QUALIFIED PROFESSIONAL.
INFILTRATION BERMS/LEVEL SPREADERS	BEFORE AND AFTER MAJOR PRECIPITATION EVENTS AND IF SIGNS OF EROSION OR VEGETATION DAMAGE OCCUR	REMOVE DEBRIS FROM BMPS REGULARLY. INSPECT FOR SIGNS OF EROSION (GULLIES) AND DAMAGE TO VEGETATION.	REPAIR ERODED AREAS BY ADJUSTING GRADES PER DESIGN TO AVOID CONCENTRATED FLOWS BY USING EROSION CONTROL BLANKET OR BY ESTABLISHING VEGETATION. DAMAGE TO VEGETATION SHOULD BE CONDUCTED PER THE ADVICE OF A QUALIFIED PROFESSIONAL.
STORMWATER STRUCTURES AND PIPES	BEFORE AND AFTER MAJOR PRECIPITATION EVENTS	REMOVE DEBRIS FROM STRUCTURES REGULARLY AND FROM PIPES WHEN	REPAIR DAMAGED PIPES AND STRUCTURES AS NEEDED.
SUBSURFACE STORAGE BEDS	DURING INSTALLATION AND IF SIGNS OF CLOGGING OCCUR	ENSURE PIPES AND STRUCTURES CONVEYING WATER TO BEDS ARE CLEAR TO PREVENT CLOGGING.	CLOGGED SUBSURFACE STORAGE BEDS MAY NEED TO BE REPLACED OR EQUIPPED WITH AN UNDERDRAIN IN THE CASE OF FAILURE.

NOTE: UNDER NO CIRCUMSTANCES SHALL SEDIMENT OR WASTE REMOVED FROM THE SYSTEMS BE DISPOSED OF ON-SITE. ALL SEDIMENT AND/OR WASTE SHALL BE REMOVED OFF-SITE AND IN A LEGAL MANNER.




PA ONE CALL SERIAL NUMBER - 20202343070

ALL LOCATIONS OF EXISTING UTILITIES SHOWN ON THIS PLAN HAVE BEEN DEVELOPED FROM EXISTING UTILITY RECORDS AND/OR ABOVE GROUND EXAMINATION OF THE SITE. COMPLETENESS OR ACCURACY OF LOCATION AND DEPTH OF UNDERGROUND UTILITIES OR STRUCTURES CANNOT BE GUARANTEED. CONTRACTOR MUST VERIFY LOCATION AND DEPTH OF ALL UNDERGROUND UTILITIES AND FACILITIES BEFORE START OF WORK PER PENNSYLVANIA ACT 287 OF 1974 AS AMENDED BY ACT 199 OF 2004 OR LATER.

CONSTRUCTION DOCUMENTS



RECORD REVISIONS

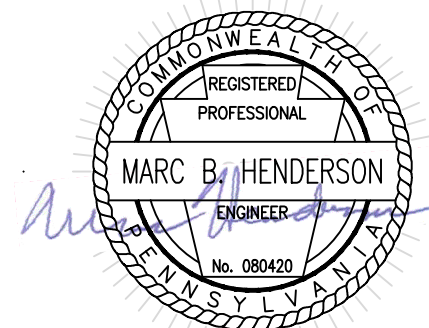

SIGNATURE: *Marc Henderson* DATE: 06/15/22

SMP ARCHITECTS
1600 WALNUT STREET, SECOND FLOOR
PHILADELPHIA, PENNSYLVANIA

COMMONWEALTH OF PENNSYLVANIA
DEPARTMENT OF GENERAL SERVICES
HARRISBURG, PENNSYLVANIA

D.G.S. PROJECT No. C-114-0006 PHASE 1

HICKORY RUN STATE PARK
LATRINE IMPROVEMENTS
DEPT of CONSERVATION AND NATURAL RESOURCES
WHITE HAVEN, CARBON COUNTY, PA

SEQUENCE OF CONSTRUCTION – CAMP DADDY ALLEN

VERIFY SCALE BAR IS ONE (1) INCH LONG ON ORIGINAL DRAWING: 0 1 IF BAR IS NOT ONE (1) INCH LONG, ADJUST SCALE ACCORDINGLY	DRAWN BY L GILL	DATE 06/17/2022	DRAWING No. C-18 31 OF 144
	CONTRACTOR SHALL FIELD VERIFY ALL DIMENSIONS. VARIANCE FROM CONTRACT DOCUMENTS NOT PERMITTED WITHOUT PROFESSIONAL & BUREAU OF CONSTRUCTION APPROVAL.	CHECKED BY M HENDERSON	

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LAST SAVED: 2022.06.17 03:15 PM PLOTTED BY: Laura E. Gill
SEQUENCE OF CONSTRUCTION – CAMP DADDY ALLEN


LEGEND

- PROJECT BOUNDARY/LIMIT OF DISTURBANCE
- TREE PROTECTION
- COMPOST SOCK
- CONSTRUCTION FENCE
- ROCK CONSTRUCTION ENTRANCE
- EROSION CONTROL BLANKET
- SEDIMENT TRAP
- INFILTRATION STAKE OUT FENCE


NOTES:

- NO EARTHMOVING ACTIVITIES OR CONSTRUCTION TRAFFIC SHALL OCCUR OVER PROPOSED INFILTRATION AREAS.
- TYPE 2.D DOUBLE NET EROSION CONTROL BLANKET - PROCESSED DEGRADABLE NATURAL FIBERS MECHANICALLY BOUND TOGETHER BETWEEN TWO RAPIDLY DEGRADING, NATURAL FIBER NETS. NO SYNTHETIC FIBERS PERMITTED.
- ALL BUILDING MATERIALS AND WASTES SHALL BE REMOVED FROM THE SITE AND RECYCLED OR DISPOSED OF IN ACCORDANCE WITH THE DEPARTMENT'S SOLID WASTE MANAGEMENT REGULATIONS AT 25 PA. CODE 260.1 ET SEQ., 271.1, AND 287.1 ET. SEQ. NO BUILDING MATERIALS OR WASTES OR UNUSED BUILDING MATERIALS SHALL BE BURNED, BURIED, DUMPED, OR DISCHARGED AT THE SITE.
- ALL OFF-SITE WASTE AND BORROW AREAS MUST HAVE AN E&S PLAN APPROVED BY THE LOCAL CONSERVATION DISTRICT OR THE DEPARTMENT FULLY IMPLEMENTED PRIOR TO BEING ACTIVATED.
- THE GENERAL CONTRACTOR IS RESPONSIBLE FOR ENSURING THAT ANY MATERIAL BROUGHT ON SITE IS CLEAN FILL. FORM FP-001 MUST BE RETAINED BY DCNR FOR ANY FILL MATERIAL AFFECTED BY A SPILL OR RELEASE OF A REGULATED SUBSTANCE BUT QUALIFYING AS CLEAN FILL DUE TO ANALYTICAL TESTING.

Map Unit Symbol	Map Unit Name	Rating
SwD	Swartswood very stony loam, 8 to 25 percent slopes	Very Limited
TuD	Tunkhannock gravelly loam, 15 to 25 percent slopes	Very Limited

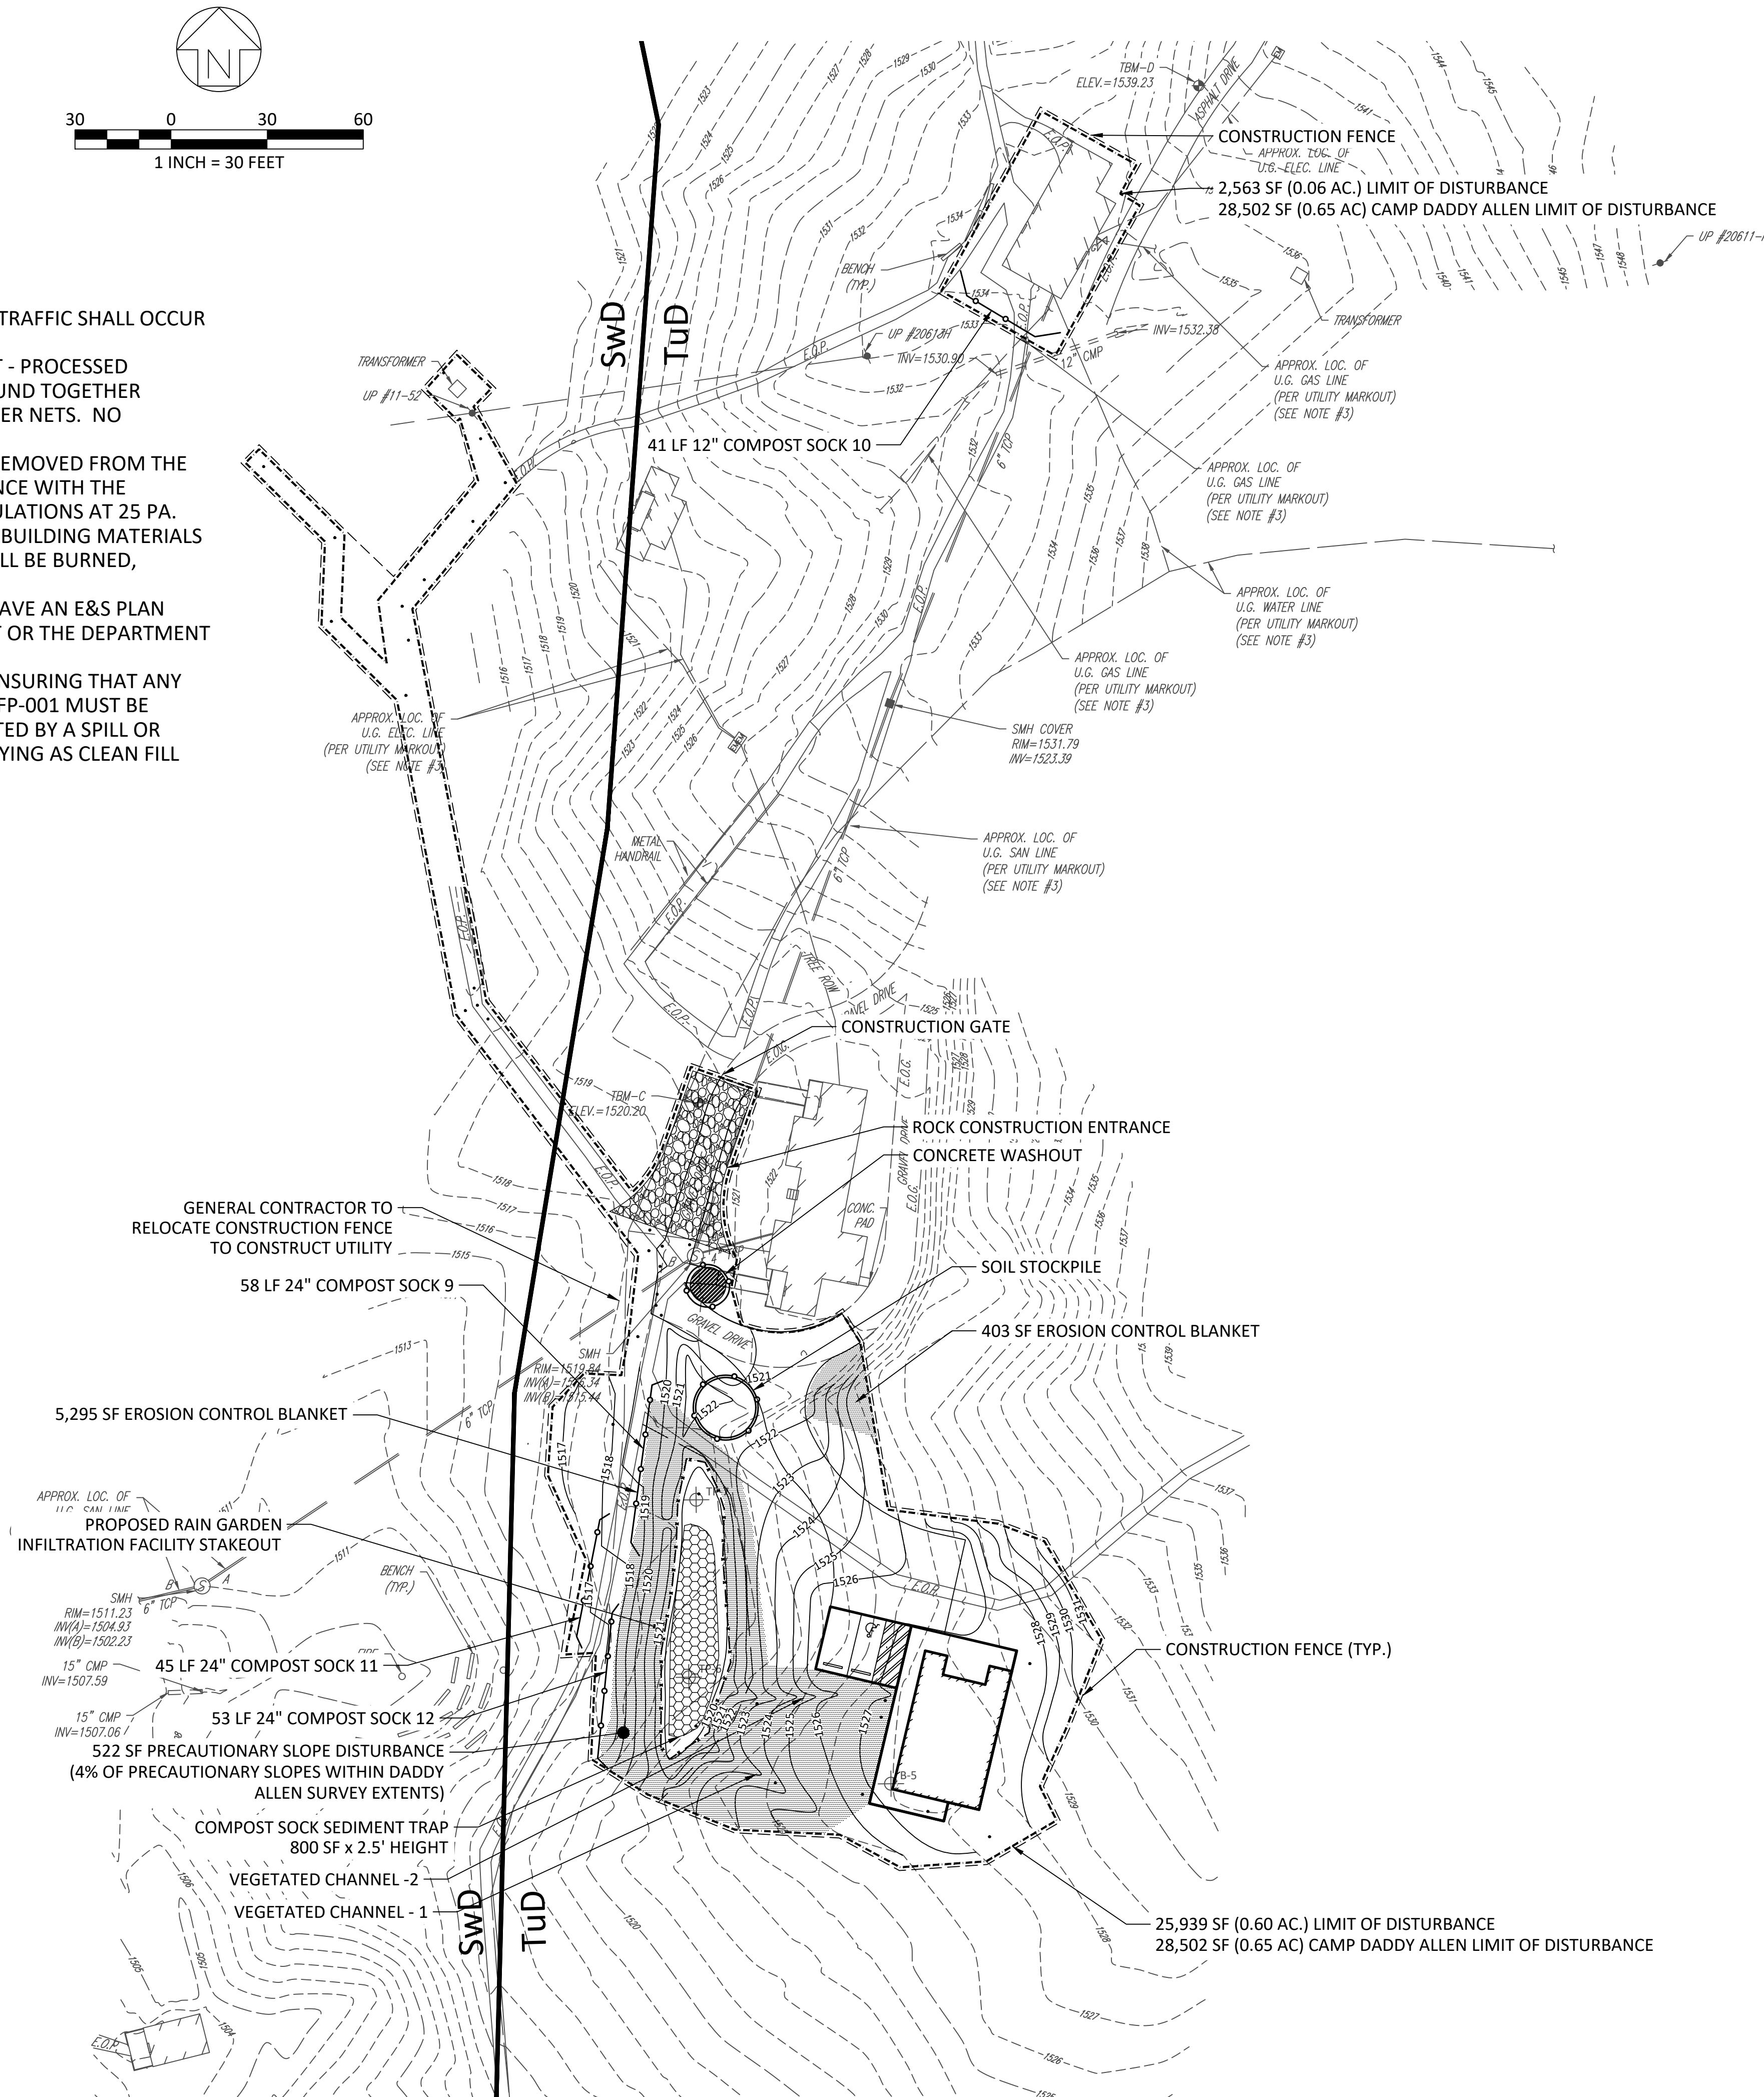

SITE LOCATION

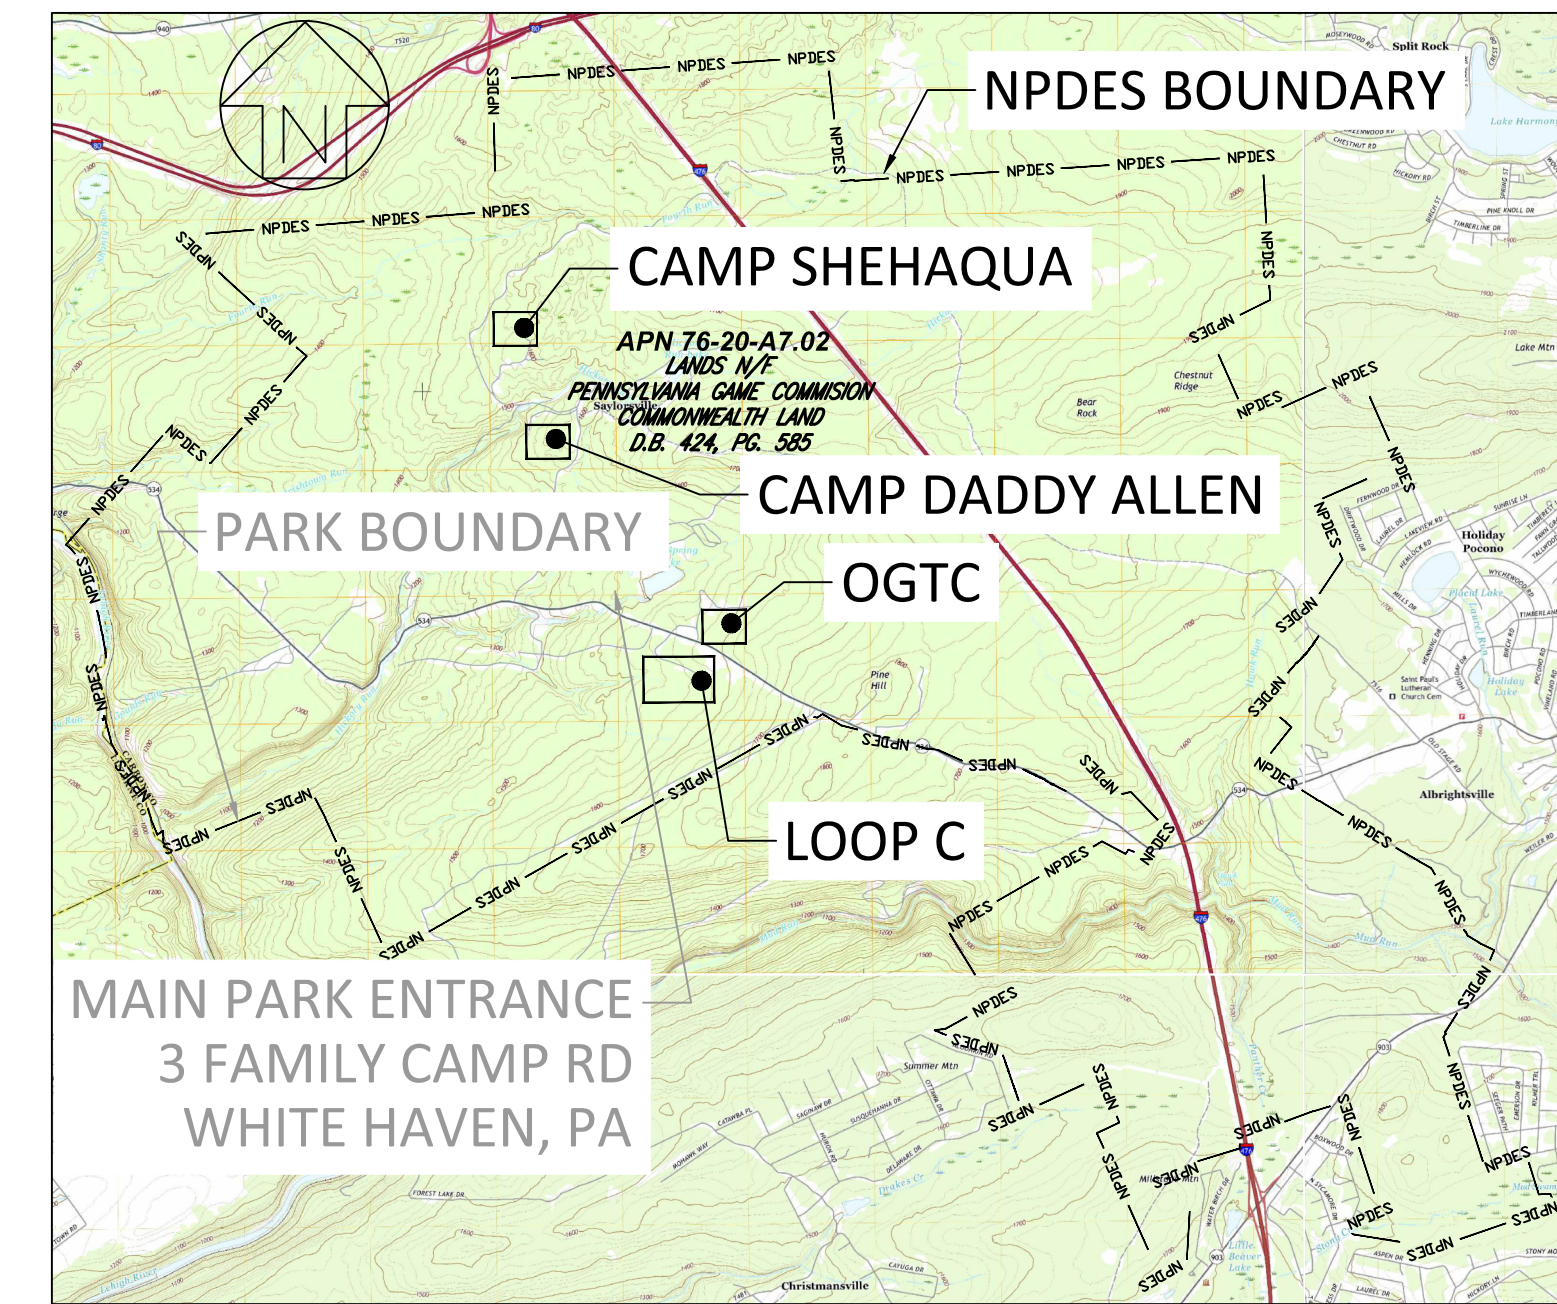

SCALE: 1" = 5000'



PA ONE CALL SERIAL NUMBER - 20202343070
 ALL LOCATIONS OF EXISTING UTILITIES SHOWN ON THIS PLAN HAVE BEEN DEVELOPED FROM EXISTING UTILITY RECORDS AND/OR ABOVE GROUND EXAMINATION OF THE SITE. COMPLETENESS OR ACCURACY OF LOCATION AND DEPTH OF UNDERGROUND UTILITIES OR STRUCTURES CANNOT BE GUARANTEED. CONTRACTOR MUST VERIFY LOCATION AND DEPTH OF ALL UNDERGROUND UTILITIES AND FACILITIES BEFORE START OF WORK PER PENNSYLVANIA ACT 287 OF 1974 AS AMENDED BY ACT 199 OF 2004 OR LATER.

CONSTRUCTION DOCUMENTS



NO.	REVISIONS

RECORD REVISIONS

SIGNATURE: *Marc B. Henderson* DATE: 06/15/22

SMP ARCHITECTS
 1600 WALNUT STREET, SECOND FLOOR
 PHILADELPHIA, PENNSYLVANIA

COMMONWEALTH OF PENNSYLVANIA
 DEPARTMENT OF GENERAL SERVICES
 HARRISBURG, PENNSYLVANIA

D.G.S. PROJECT No. C-114-0006 PHASE 1

HICKORY RUN STATE PARK
 LATRINE IMPROVEMENTS
 DEPT of CONSERVATION AND NATURAL RESOURCES
 WHITE HAVEN, CARBON COUNTY, PA

EROSION AND SEDIMENT CONTROL PLAN -
 CAMP DADDY ALLEN

VERIFY SCALE
 BAR IS ONE (1) INCH LONG ON ORIGINAL DRAWING:
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 IF BAR IS NOT ONE (1) INCH LONG, ADJUST SCALE ACCORDINGLY


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DRAWN BY L GILL	DATE 06/17/2022	DRAWING No. C-19
CHECKED BY M HENDERSON	SCALE AS NOTED	32 OF 144

FILE PATH: I:\2020\20027 - Hickory Run State Park\CD\sheet files\20027 - EROSION AND SEDIMENT CONTROL PLAN.dwg PLOTTED BY: Laura E. Gill LAST SAVED: 2022.06.12 10:20 PM PLOTTED: 2022.06.17 04:23 PM


LEGEND

- PROJECT BOUNDARY/LIMIT OF DISTURBANCE
- ⊗ TREE TO BE REMOVED
- TREE TO BE PROTECTED
- ⊗ TREE TO BE IMPACTED
- ⊗ UTILITY STRUCTURE REMOVAL
- +++ UTILITY LINE REMOVAL
- ▨ BUILDING DEMOLITION
- ▨ CONCRETE DEMOLITION
- ▨ ASPHALT DEMOLITION

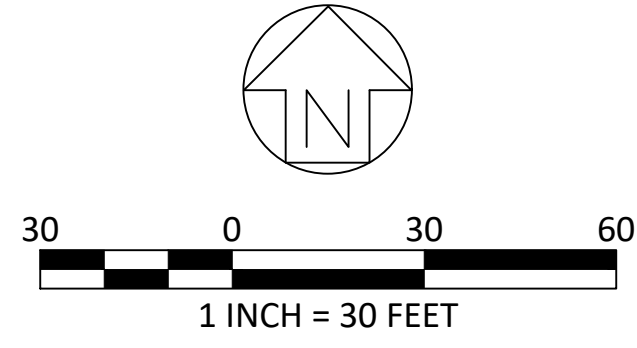


NOTES:

1. TREE STUMPS TO BE LEFT SHALL BE CUT LESS THAN 5 INCHES HIGH.
2. GENERAL CONTRACTOR TO DISCONNECT AND CAP ALL UTILITIES TO BUILDING TO BE DEMOLISHED.

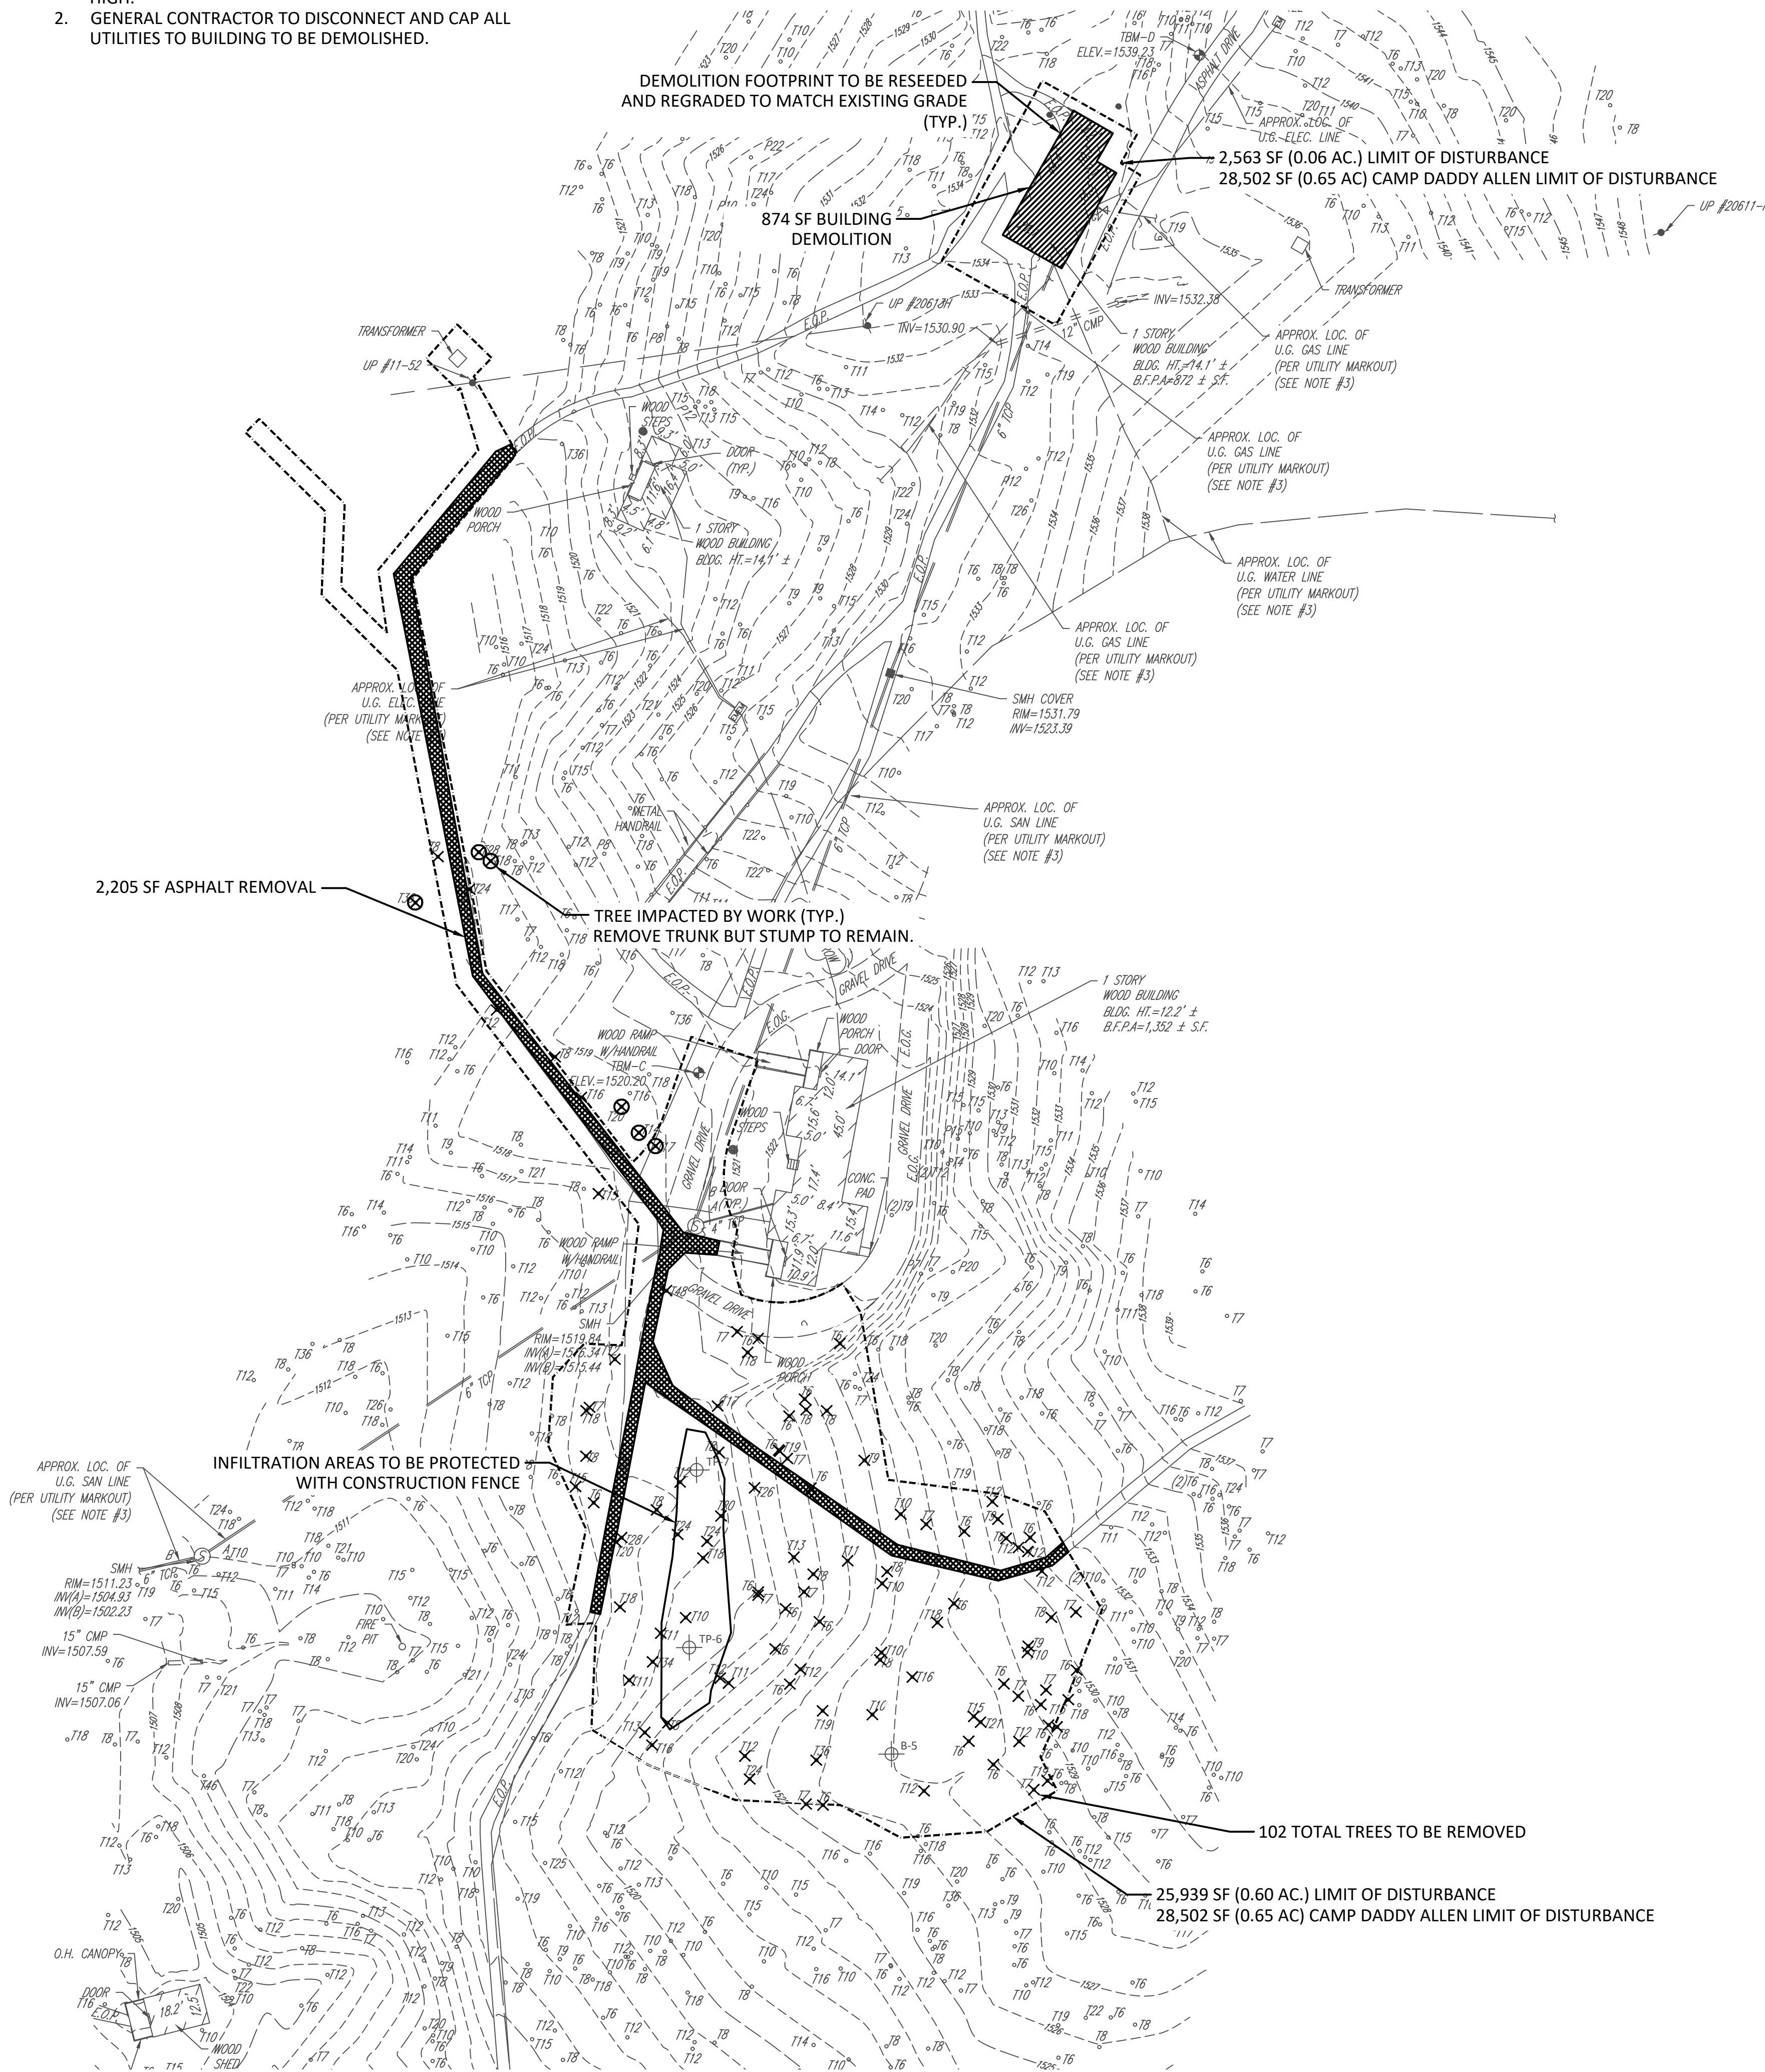

SITE LOCATION

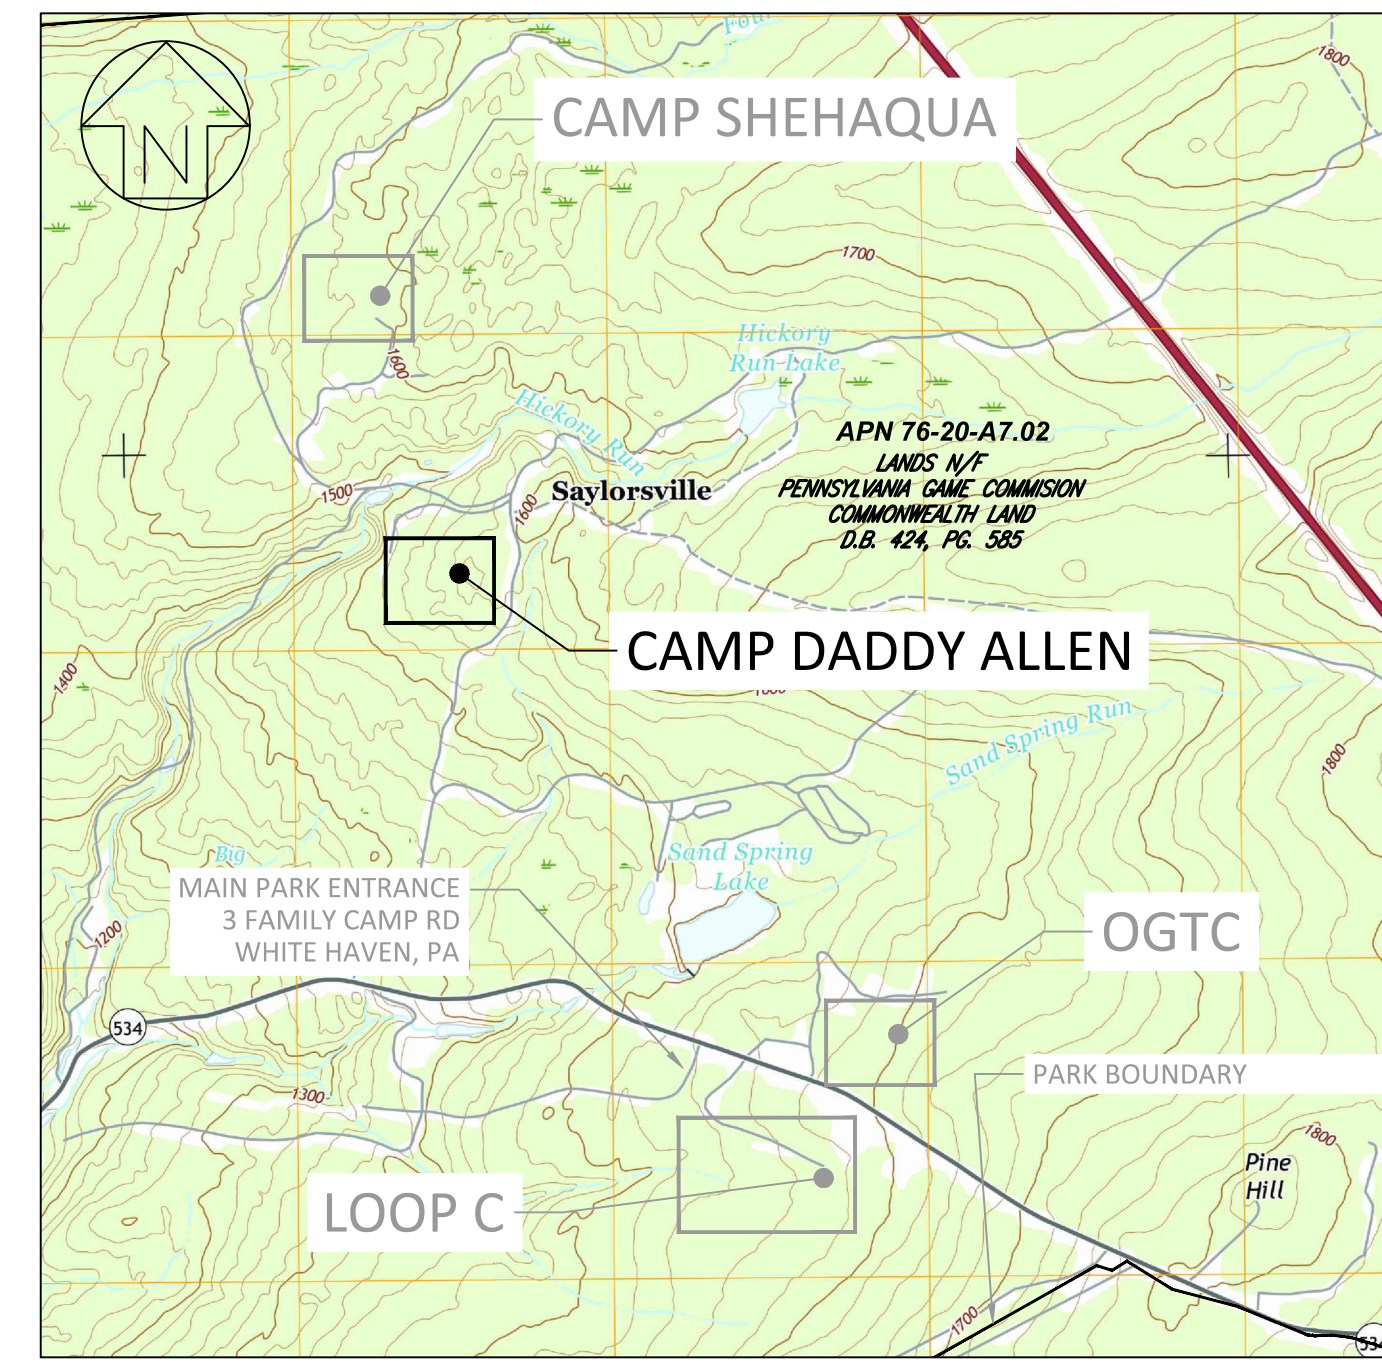


SCALE: 1" = 2000'

CONSTRUCTION DOCUMENTS



RECORD REVISIONS

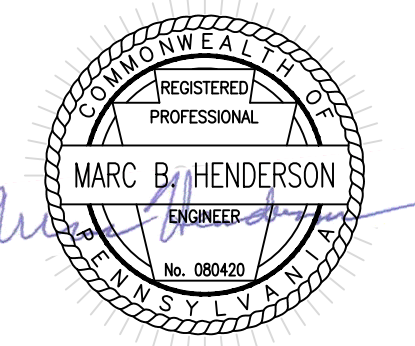

SIGNATURE: *Marc B. Henderson* DATE: 06/15/22

SMP ARCHITECTS
1600 WALNUT STREET, SECOND FLOOR
PHILADELPHIA, PENNSYLVANIA

COMMONWEALTH OF PENNSYLVANIA
DEPARTMENT OF GENERAL SERVICES
HARRISBURG, PENNSYLVANIA

D.G.S. PROJECT No. C-114-0006 PHASE 1

HICKORY RUN STATE PARK
LATRINE IMPROVEMENTS
DEPT of CONSERVATION AND NATURAL RESOURCES
WHITE HAVEN, CARBON COUNTY, PA

DEMOLITION PLAN -
CAMP DADDY ALLEN







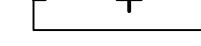


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IF BAR IS NOT ONE (1) INCH LONG, ADJUST SCALE ACCORDINGLY



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CHECKED BY M HENDERSON	SCALE AS NOTED	33 OF 144

FILE PATH: I:\2020\20027 - Hickory Run State Park\CAD\sheet files\20027 - DEMOLITION PLAN.dwg PLOTTED BY: Laura E. Gill LAYOUT TAB: DEMOLITION PLAN - CAMP DADDY ALLEN PLOTTED: 2022.06.17 04:25 PM

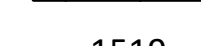LEGEND

-  PROJECT BOUNDARY/LIMIT OF DISTURBANCE
-  PROPOSED BUILDING
-  1519 CONTOUR
-  ST STORM PIPE
-  INFILTRATION BED
-  RAIN GARDEN
-  TP/B-9 SOIL TEST PIT (TP) OR BORING (B) LOCATION
-  DOMED RISER
-  FLARED END SECTION

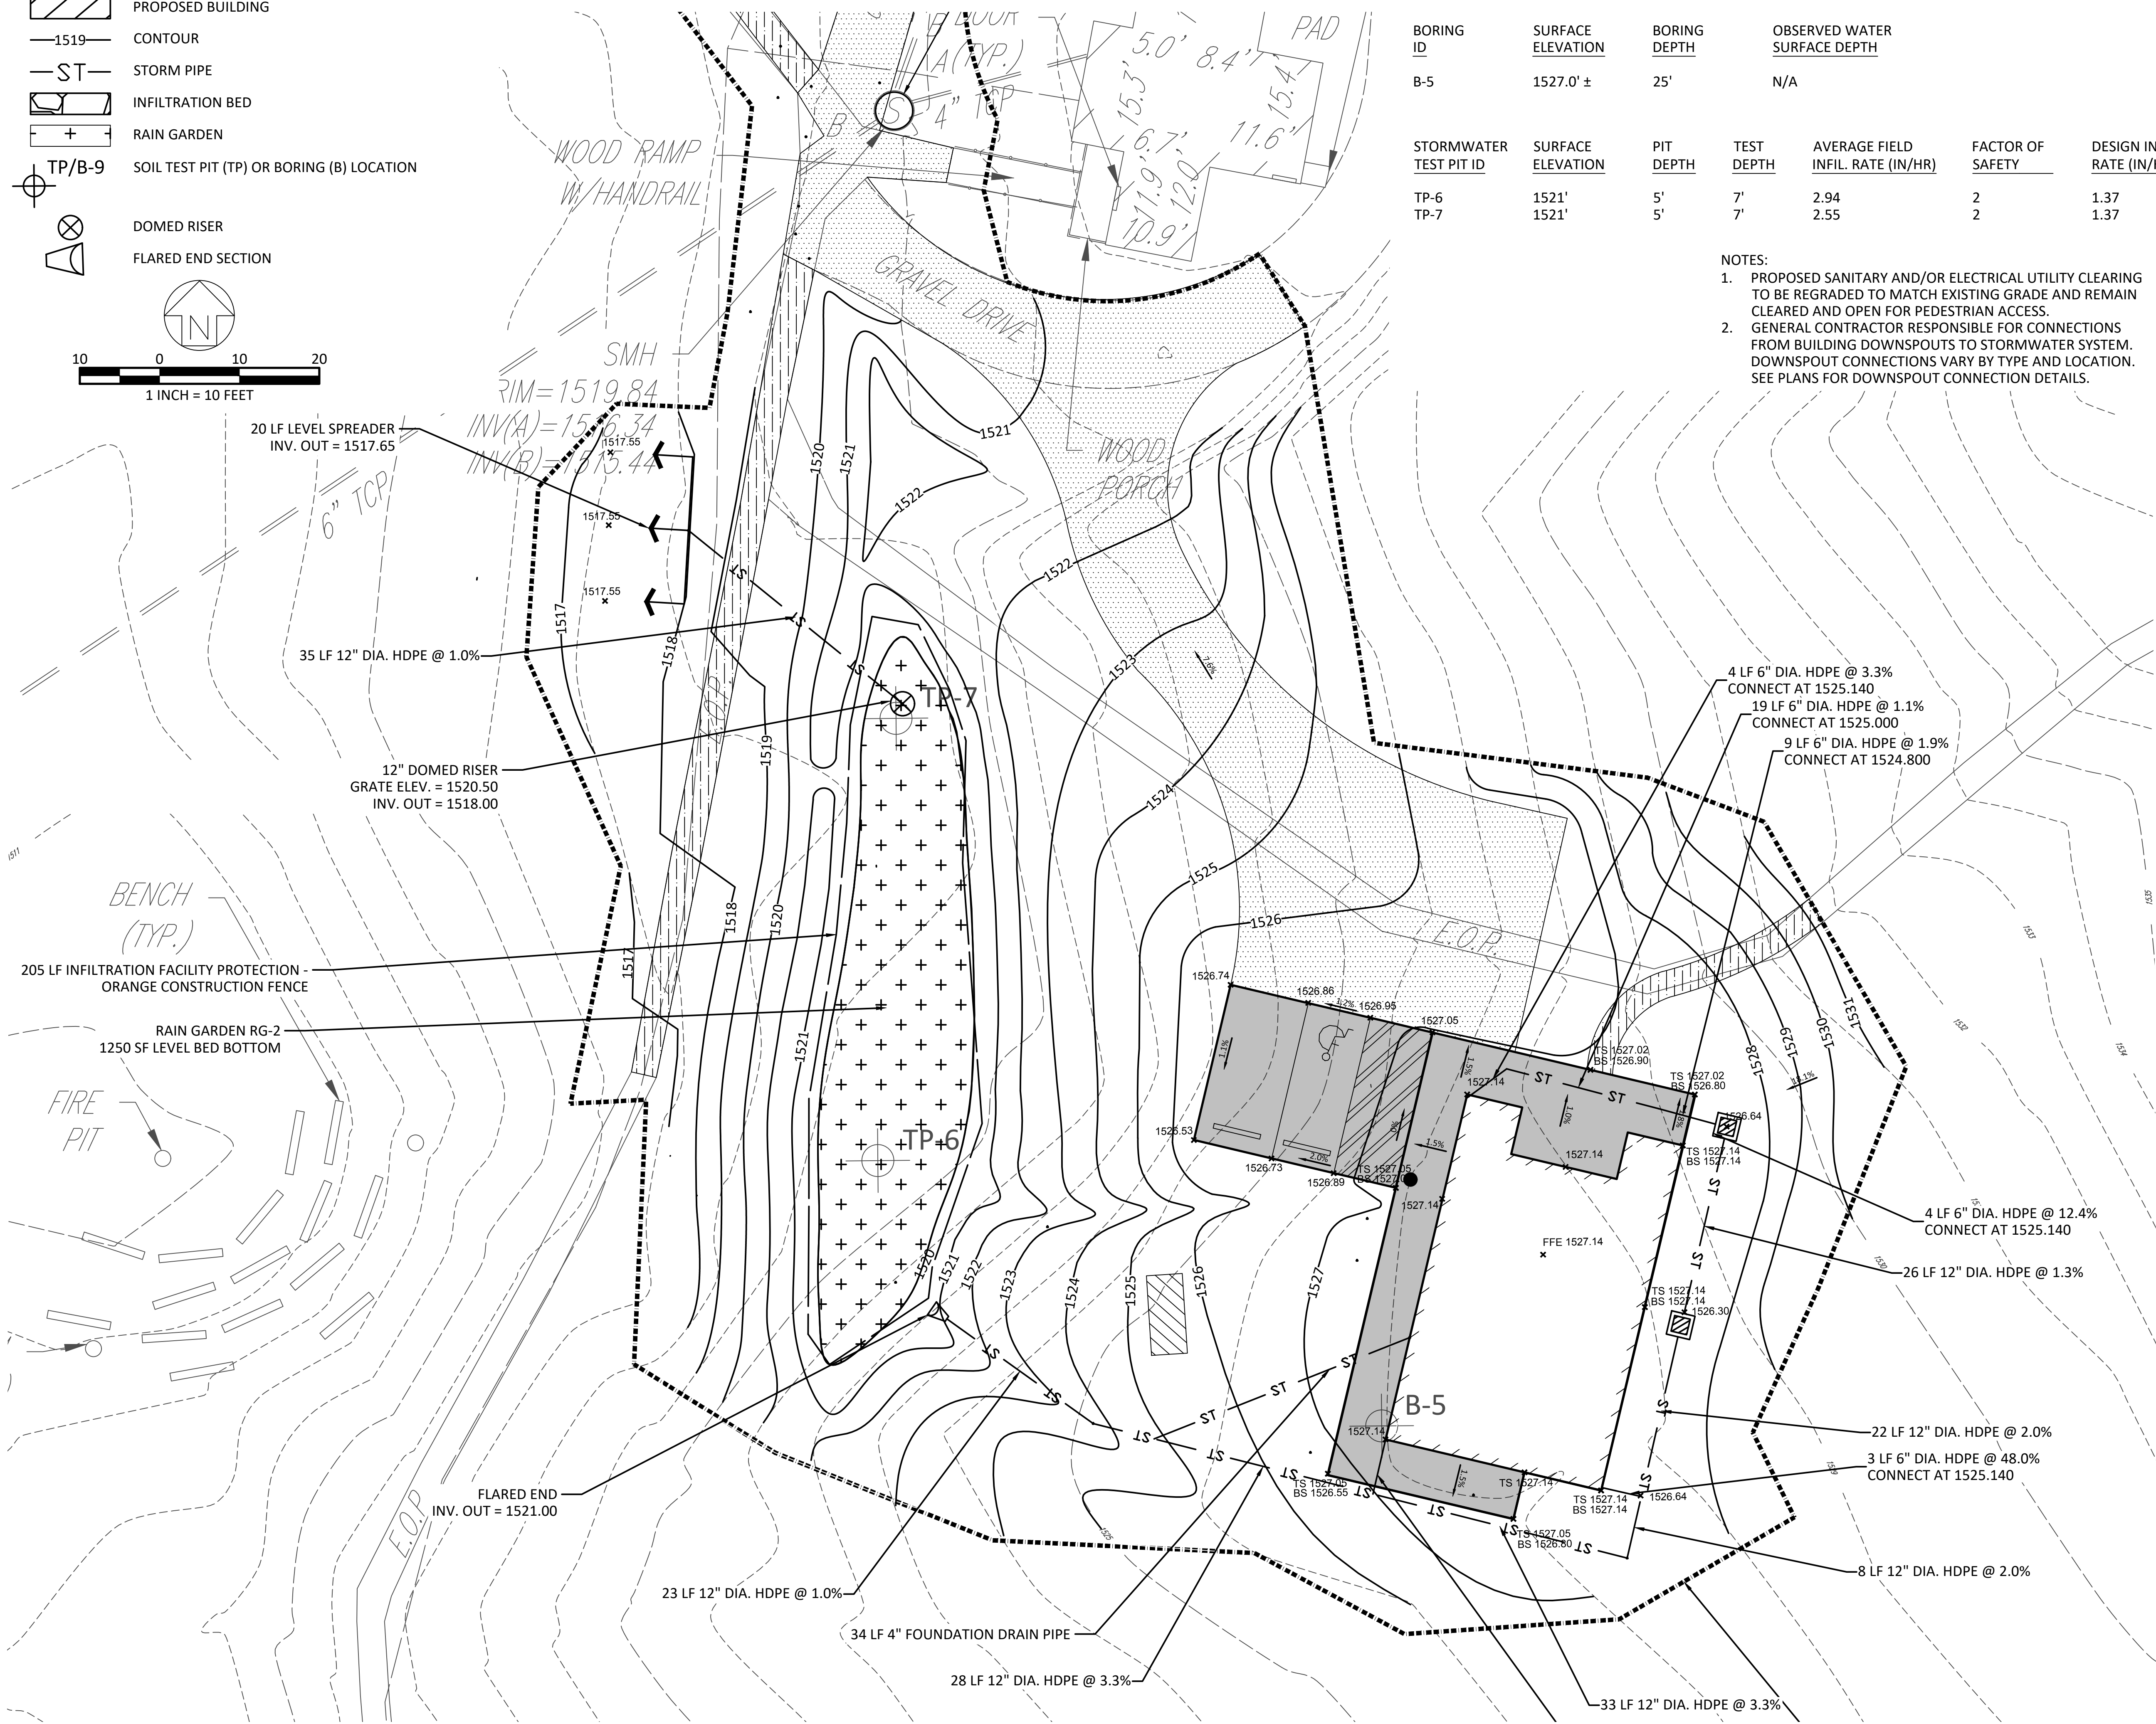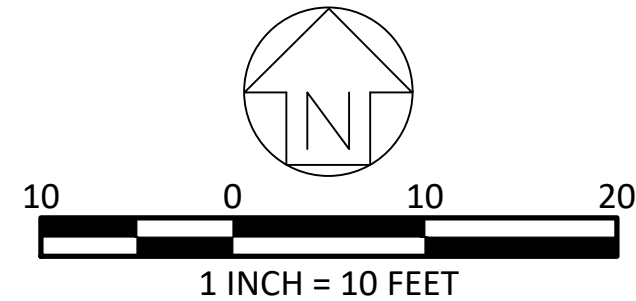


BORING ID	SURFACE ELEVATION	BORING DEPTH	OBSERVED WATER SURFACE DEPTH
B-5	1527.0' ±	25'	N/A

STORMWATER TEST PIT ID	SURFACE ELEVATION	PIT DEPTH	TEST DEPTH	AVERAGE FIELD INFIL. RATE (IN/HR)	FACTOR OF SAFETY	DESIGN INFIL. RATE (IN/HR)
TP-6	1521'	5'	7'	2.94	2	1.37
TP-7	1521'	5'	7'	2.55	2	1.37

- NOTES:**
- PROPOSED SANITARY AND/OR ELECTRICAL UTILITY CLEARING TO BE REGRADED TO MATCH EXISTING GRADE AND REMAIN CLEARED AND OPEN FOR PEDESTRIAN ACCESS.
 - GENERAL CONTRACTOR RESPONSIBLE FOR CONNECTIONS FROM BUILDING DOWNSPOUTS TO STORMWATER SYSTEM. DOWNSPOUT CONNECTIONS VARY BY TYPE AND LOCATION. SEE PLANS FOR DOWNSPOUT CONNECTION DETAILS.

SITE LOCATION

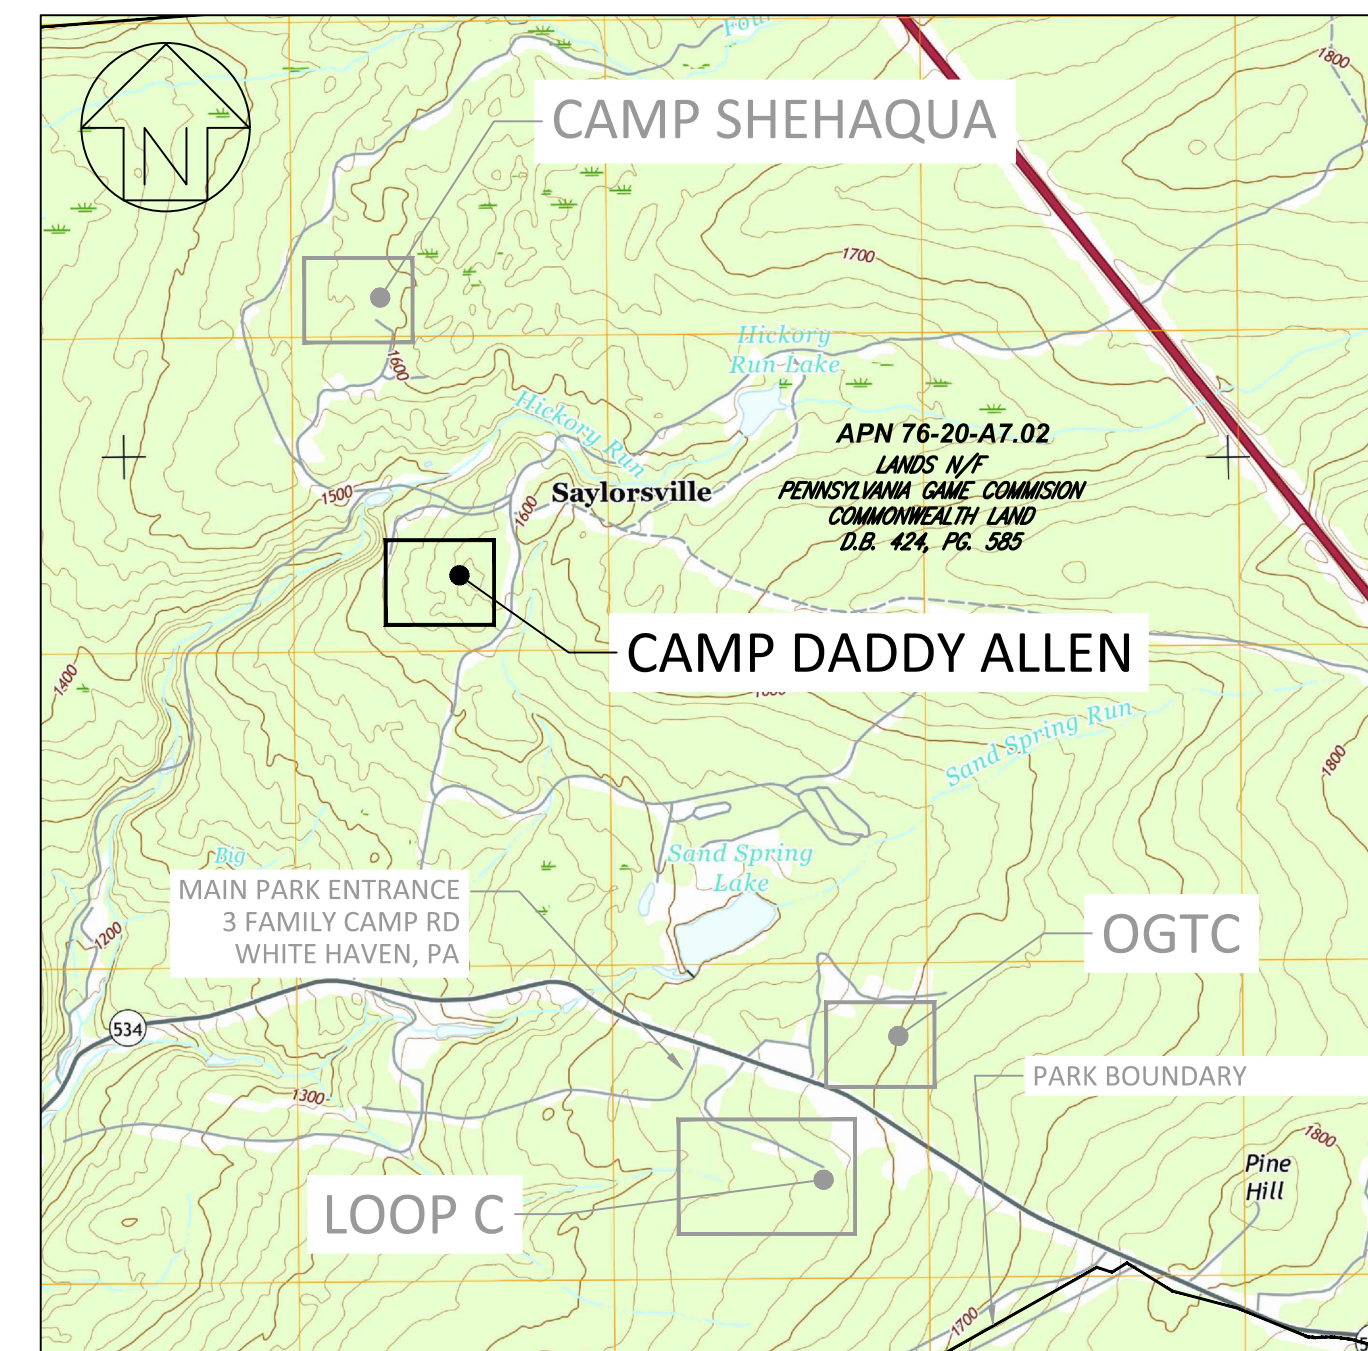

SCALE: 1" = 2000'
PA ONE CALL SERIAL NUMBER - 20202343070
 ALL LOCATIONS OF EXISTING UTILITIES SHOWN ON THIS PLAN HAVE BEEN DEVELOPED FROM EXISTING UTILITY RECORDS AND/OR ABOVE GROUND EXAMINATION OF THE SITE. COMPLETENESS OR ACCURACY OF LOCATION AND DEPTH OF UNDERGROUND UTILITIES OR STRUCTURES CANNOT BE GUARANTEED. CONTRACTOR MUST VERIFY LOCATION AND DEPTH OF ALL UNDERGROUND UTILITIES AND FACILITIES BEFORE START OF WORK PER PENNSYLVANIA ACT 287 OF 1974 AS AMENDED BY ACT 199 OF 2004 OR LATER.

CONSTRUCTION DOCUMENTS



NO.	REVISION	DATE

RECORD REVISIONS

Marc B. Henderson 06/15/22
 SIGNATURE DATE

SMP ARCHITECTS
 1600 WALNUT STREET, SECOND FLOOR
 PHILADELPHIA, PENNSYLVANIA

COMMONWEALTH OF PENNSYLVANIA
 DEPARTMENT OF GENERAL SERVICES
 HARRISBURG, PENNSYLVANIA

D.G.S. PROJECT No. **C-114-0006 PHASE 1**
HICKORY RUN STATE PARK
LATRINE IMPROVEMENTS
 DEPT of CONSERVATION AND NATURAL RESOURCES
 WHITE HAVEN, CARBON COUNTY, PA

STORMWATER AND GRADING PLAN - CAMP DADDY ALLEN

CONTRACTOR SHALL FIELD VERIFY ALL DIMENSIONS. VARIANCE FROM CONTRACT DOCUMENTS NOT PERMITTED WITHOUT PROFESSIONAL & BUREAU OF CONSTRUCTION APPROVAL.	DRAWN BY L GILL	DATE 06/17/2022	DRAWING No. C-21
	CHECKED BY M HENDERSON	SCALE AS NOTED	34 OF 144




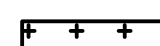
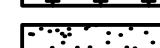

VERIFY SCALE




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IF BAR IS NOT ONE (1) INCH LONG, ADJUST SCALE ACCORDINGLY.


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LEGEND

-  PROJECT BOUNDARY/LIMIT OF DISTURBANCE
-  PROPOSED CONCRETE
-  PROPOSED DRIVING SURFACE AGGREGATE
-  PROPOSED RAIN GARDEN SEED MIX
-  PROPOSED LANDSCAPE RESTORATION
-  PROPOSED TRAIL SURFACE AGGREGATE



SITE LOCATION

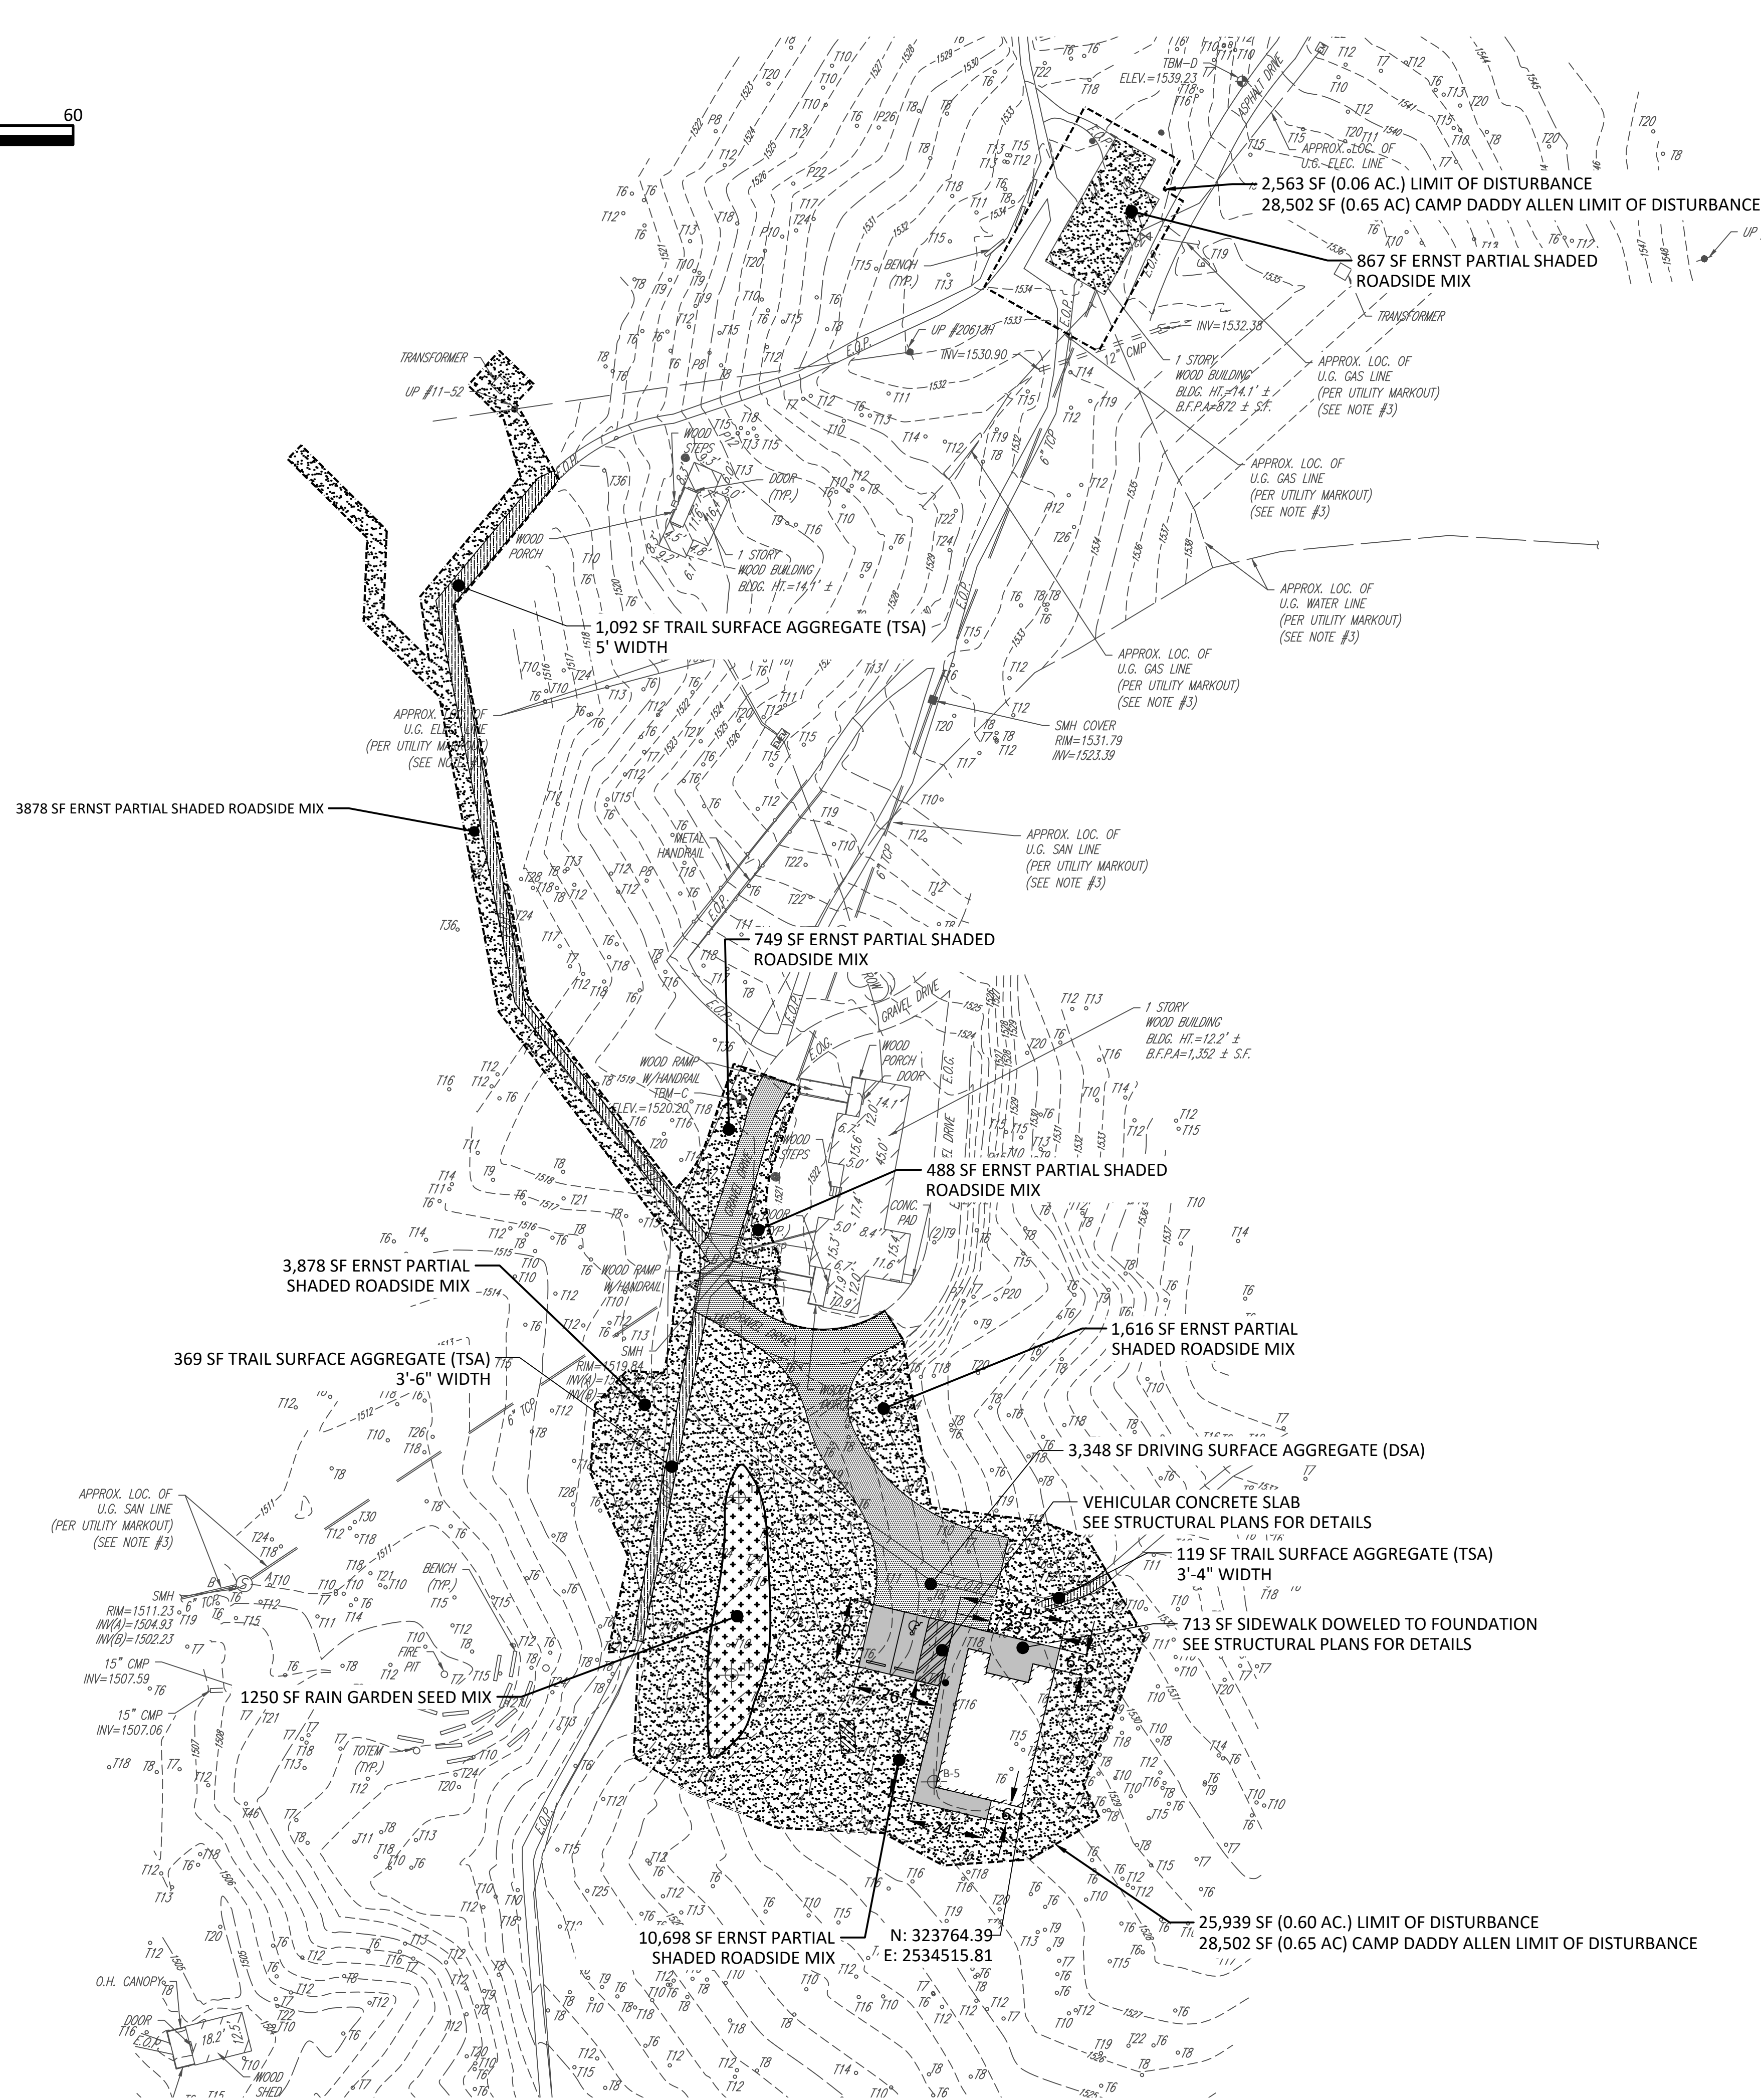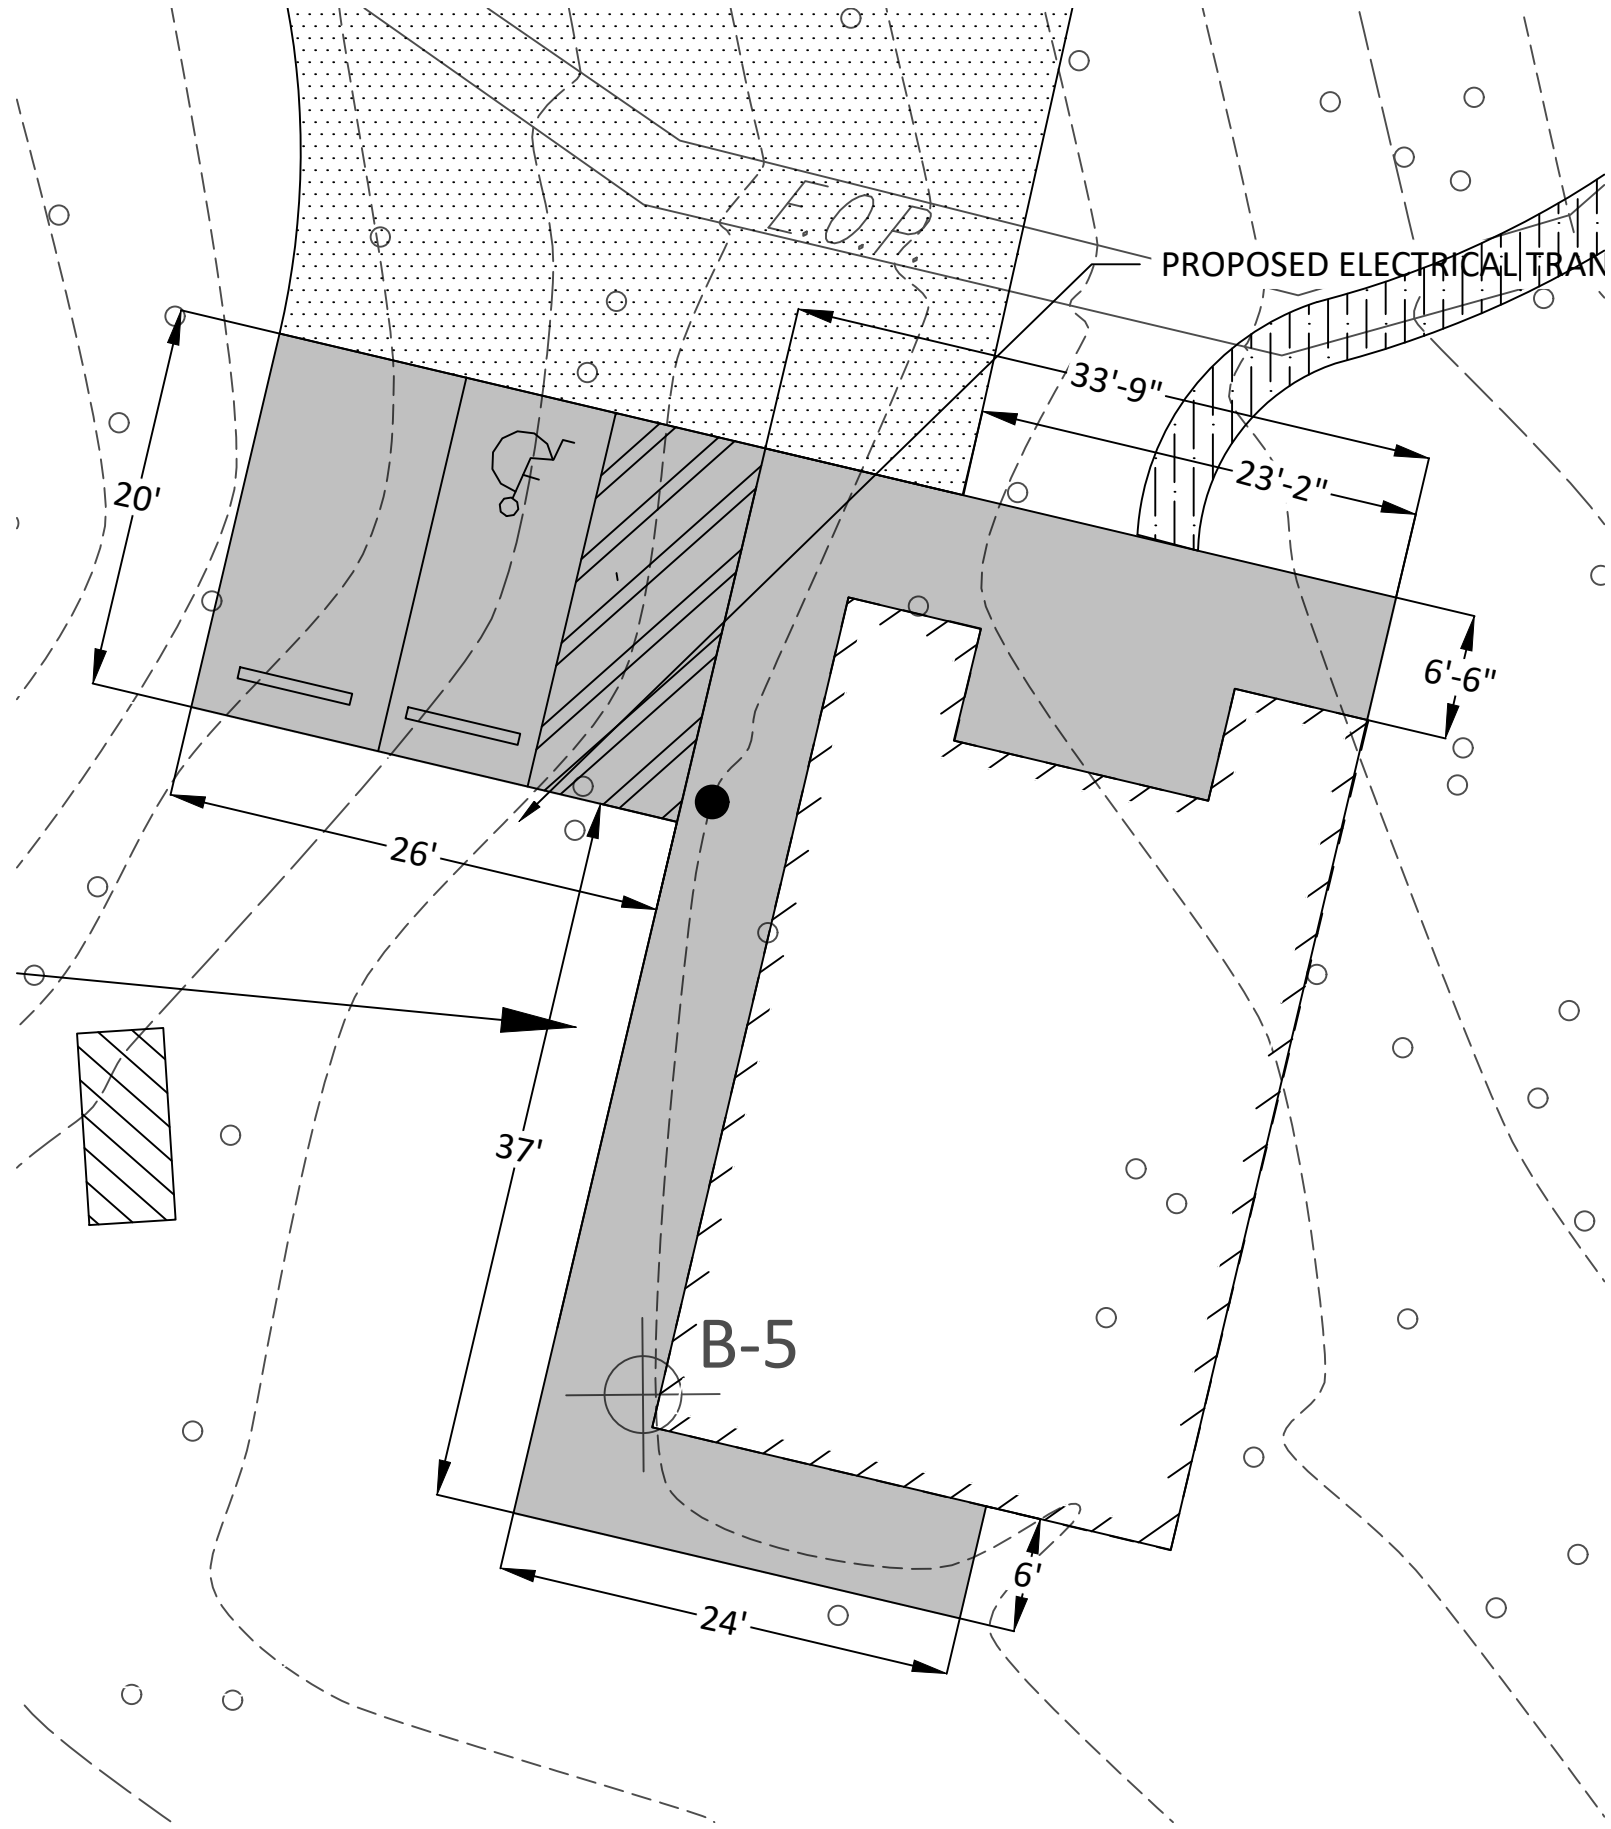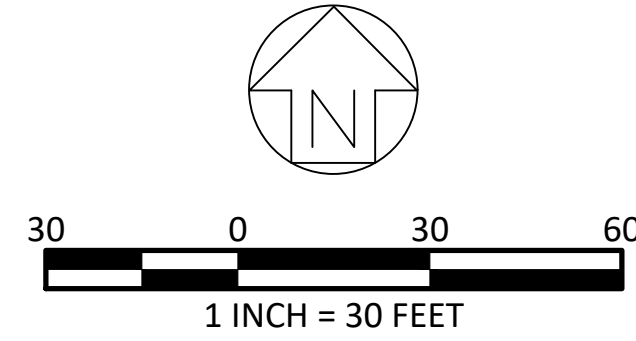

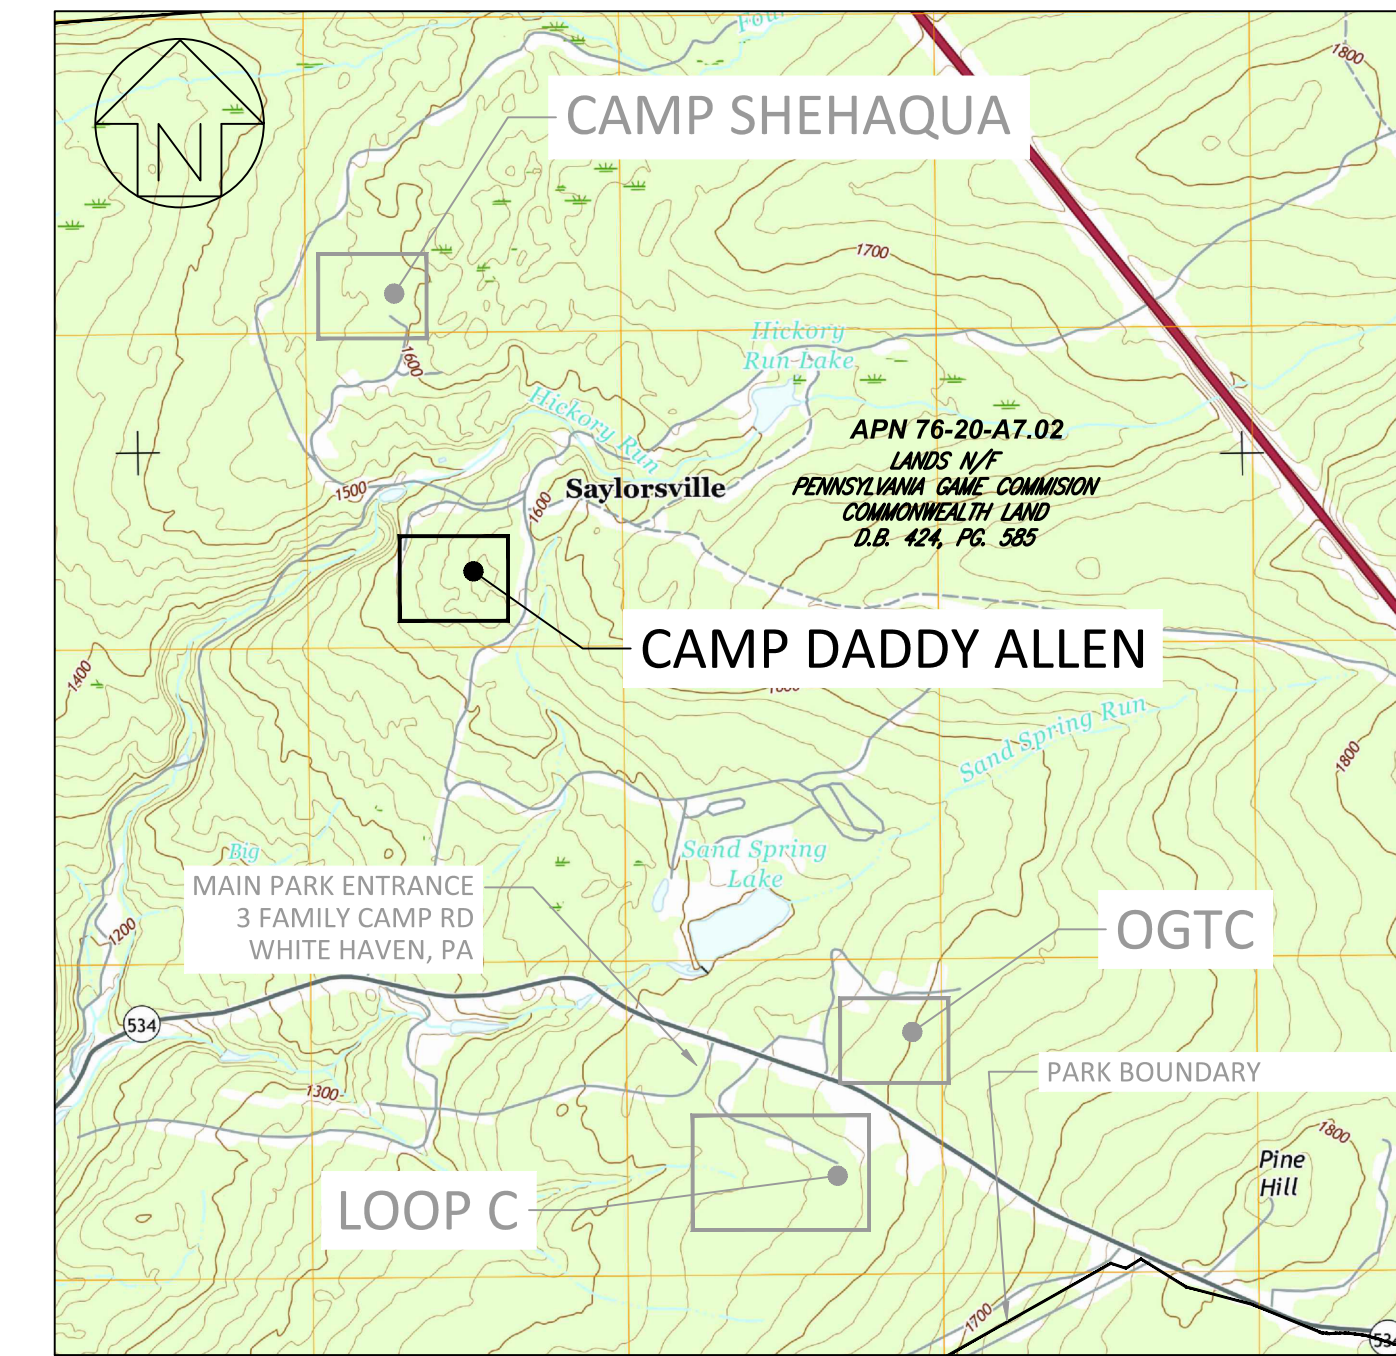SCALE: 1" = 2000'

CONSTRUCTION DOCUMENTS



RECORD REVISIONS



SIGNATURE: *Marc B. Henderson* DATE: 06/15/22

SMP ARCHITECTS
1600 WALNUT STREET, SECOND FLOOR
PHILADELPHIA, PENNSYLVANIA

COMMONWEALTH OF PENNSYLVANIA
DEPARTMENT OF GENERAL SERVICES
HARRISBURG, PENNSYLVANIA

D.G.S. PROJECT No. C-114-0006 PHASE 1

HICKORY RUN STATE PARK
LATRINE IMPROVEMENTS
DEPT of CONSERVATION AND NATURAL RESOURCES
WHITE HAVEN, CARBON COUNTY, PA

SITE PLAN - CAMP DADDY ALLEN

VERIFY SCALE
BAR IS ONE (1) INCH LONG ON ORIGINAL DRAWING:
0 1
IF BAR IS NOT ONE (1) INCH LONG, ADJUST SCALE ACCORDINGLY

CONTRACTOR SHALL FIELD VERIFY ALL DIMENSIONS. VARIANCE FROM CONTRACT DOCUMENTS NOT PERMITTED WITHOUT PROFESSIONAL & BUREAU OF CONSTRUCTION APPROVAL.



DRAWN BY L GILL	DATE 06/17/2022	DRAWING No. C-22
CHECKED BY M HENDERSON	SCALE AS NOTED	

FILE PATH: I:\2020\20027 - Hickory Run State Park\CDM\sheet files\20027 - LANDSCAPE PLAN.dwg PLOTTED BY: Laura L. Gill
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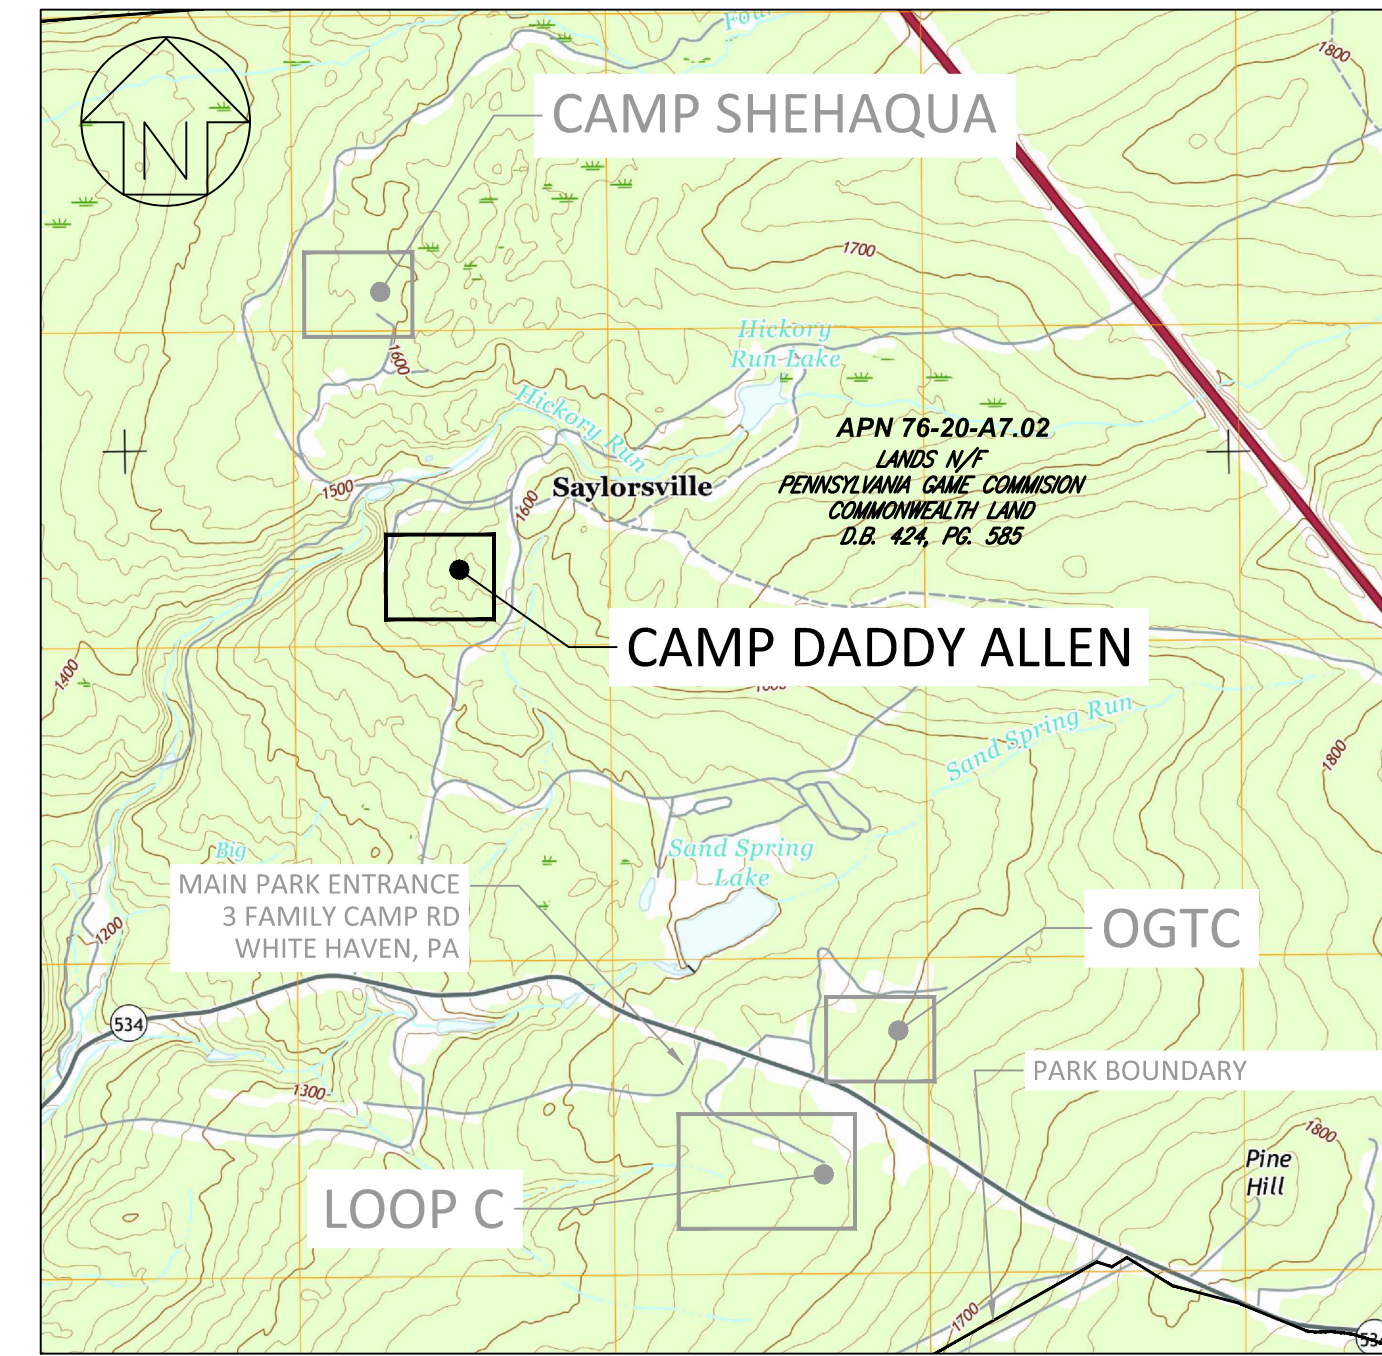
- LEGEND**
- PROJECT BOUNDARY/LIMIT OF DISTURBANCE
 - ▒ PROPOSED CONCRETE
 - ▒ PROPOSED DRIVING SURFACE AGGREGATE
 - ▒ PROPOSED TRAIL SURFACE AGGREGATE
 - ⊙ SEWER MANHOLE
 - ⊙ SEWER CLEANOUT
 - - - - - PROPOSED WATER LINE
 - - - - - PROPOSED SANITARY SEWER LINE
 - - - - - PROPOSED ELECTRIC LINE
 - ST STORM PIPE

Notes

1. ALL NEW WATER SERVICE TO HAVE 54" MIN. COVER.
2. ELECTRICAL CONTRACTOR TO PROVIDE TRENCHING, BEDDING, AND BACKFILL PER PPL SPECIFICATIONS AND UTILITY DETAILS FOR ALL ELECTRICAL SERVICES NOTED ON PLANS. IT IS THE ELECTRICAL CONTRACTOR'S RESPONSIBILITY TO COORDINATE FULLY WITH PPL DURING CONSTRUCTION FOR THE INSTALLATION OF THE ELECTRICAL SERVICE AT EACH SITE. SEE NOTES FOR EXTRA CLARIFICATION OF SCOPE ON A SITE BY SITE BASIS.
3. PLUMBING CONTRACTOR TO PROVIDE TRENCHING, BEDDING, AND BACKFILL PER UTILITY DETAILS FOR ALL WATER AND GAS SERVICES NOTED ON PLANS.
4. PLUMBING CONTRACTOR TO PROVIDE INSTALLATION OF PROPANE TANK AND SUPPLY LINE TO CONNECT GAS SERVICE. GENERAL CONTRACTOR TO PROVIDE DEVELOPED SITE AND ENCLOSURE PER PLANS FOR TANK INSTALLATION.
5. PLUMBING CONTRACTOR TO PROVIDE WATER SERVICE TO WATER FOUNTAINS AND DRAIN PITS FOR WATER SERVICE. SEE PLUMBING DRAWINGS FOR DETAILS.
6. ALL WORK ON THIS DRAWING IS TO BE INCLUDED BY THE GENERAL CONTRACTOR EXCEPT WORK NOTED TO BE BY THE PLUMBING CONTRACTOR OR ELECTRICAL CONTRACTOR.

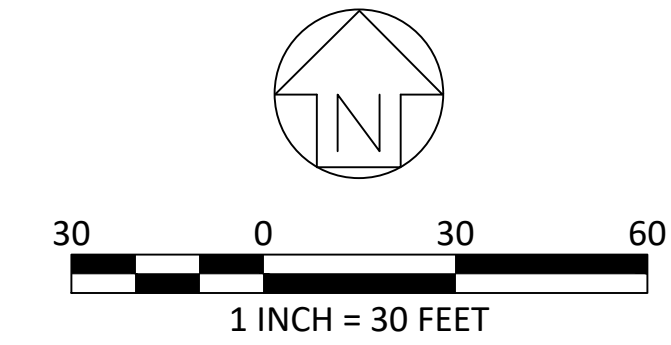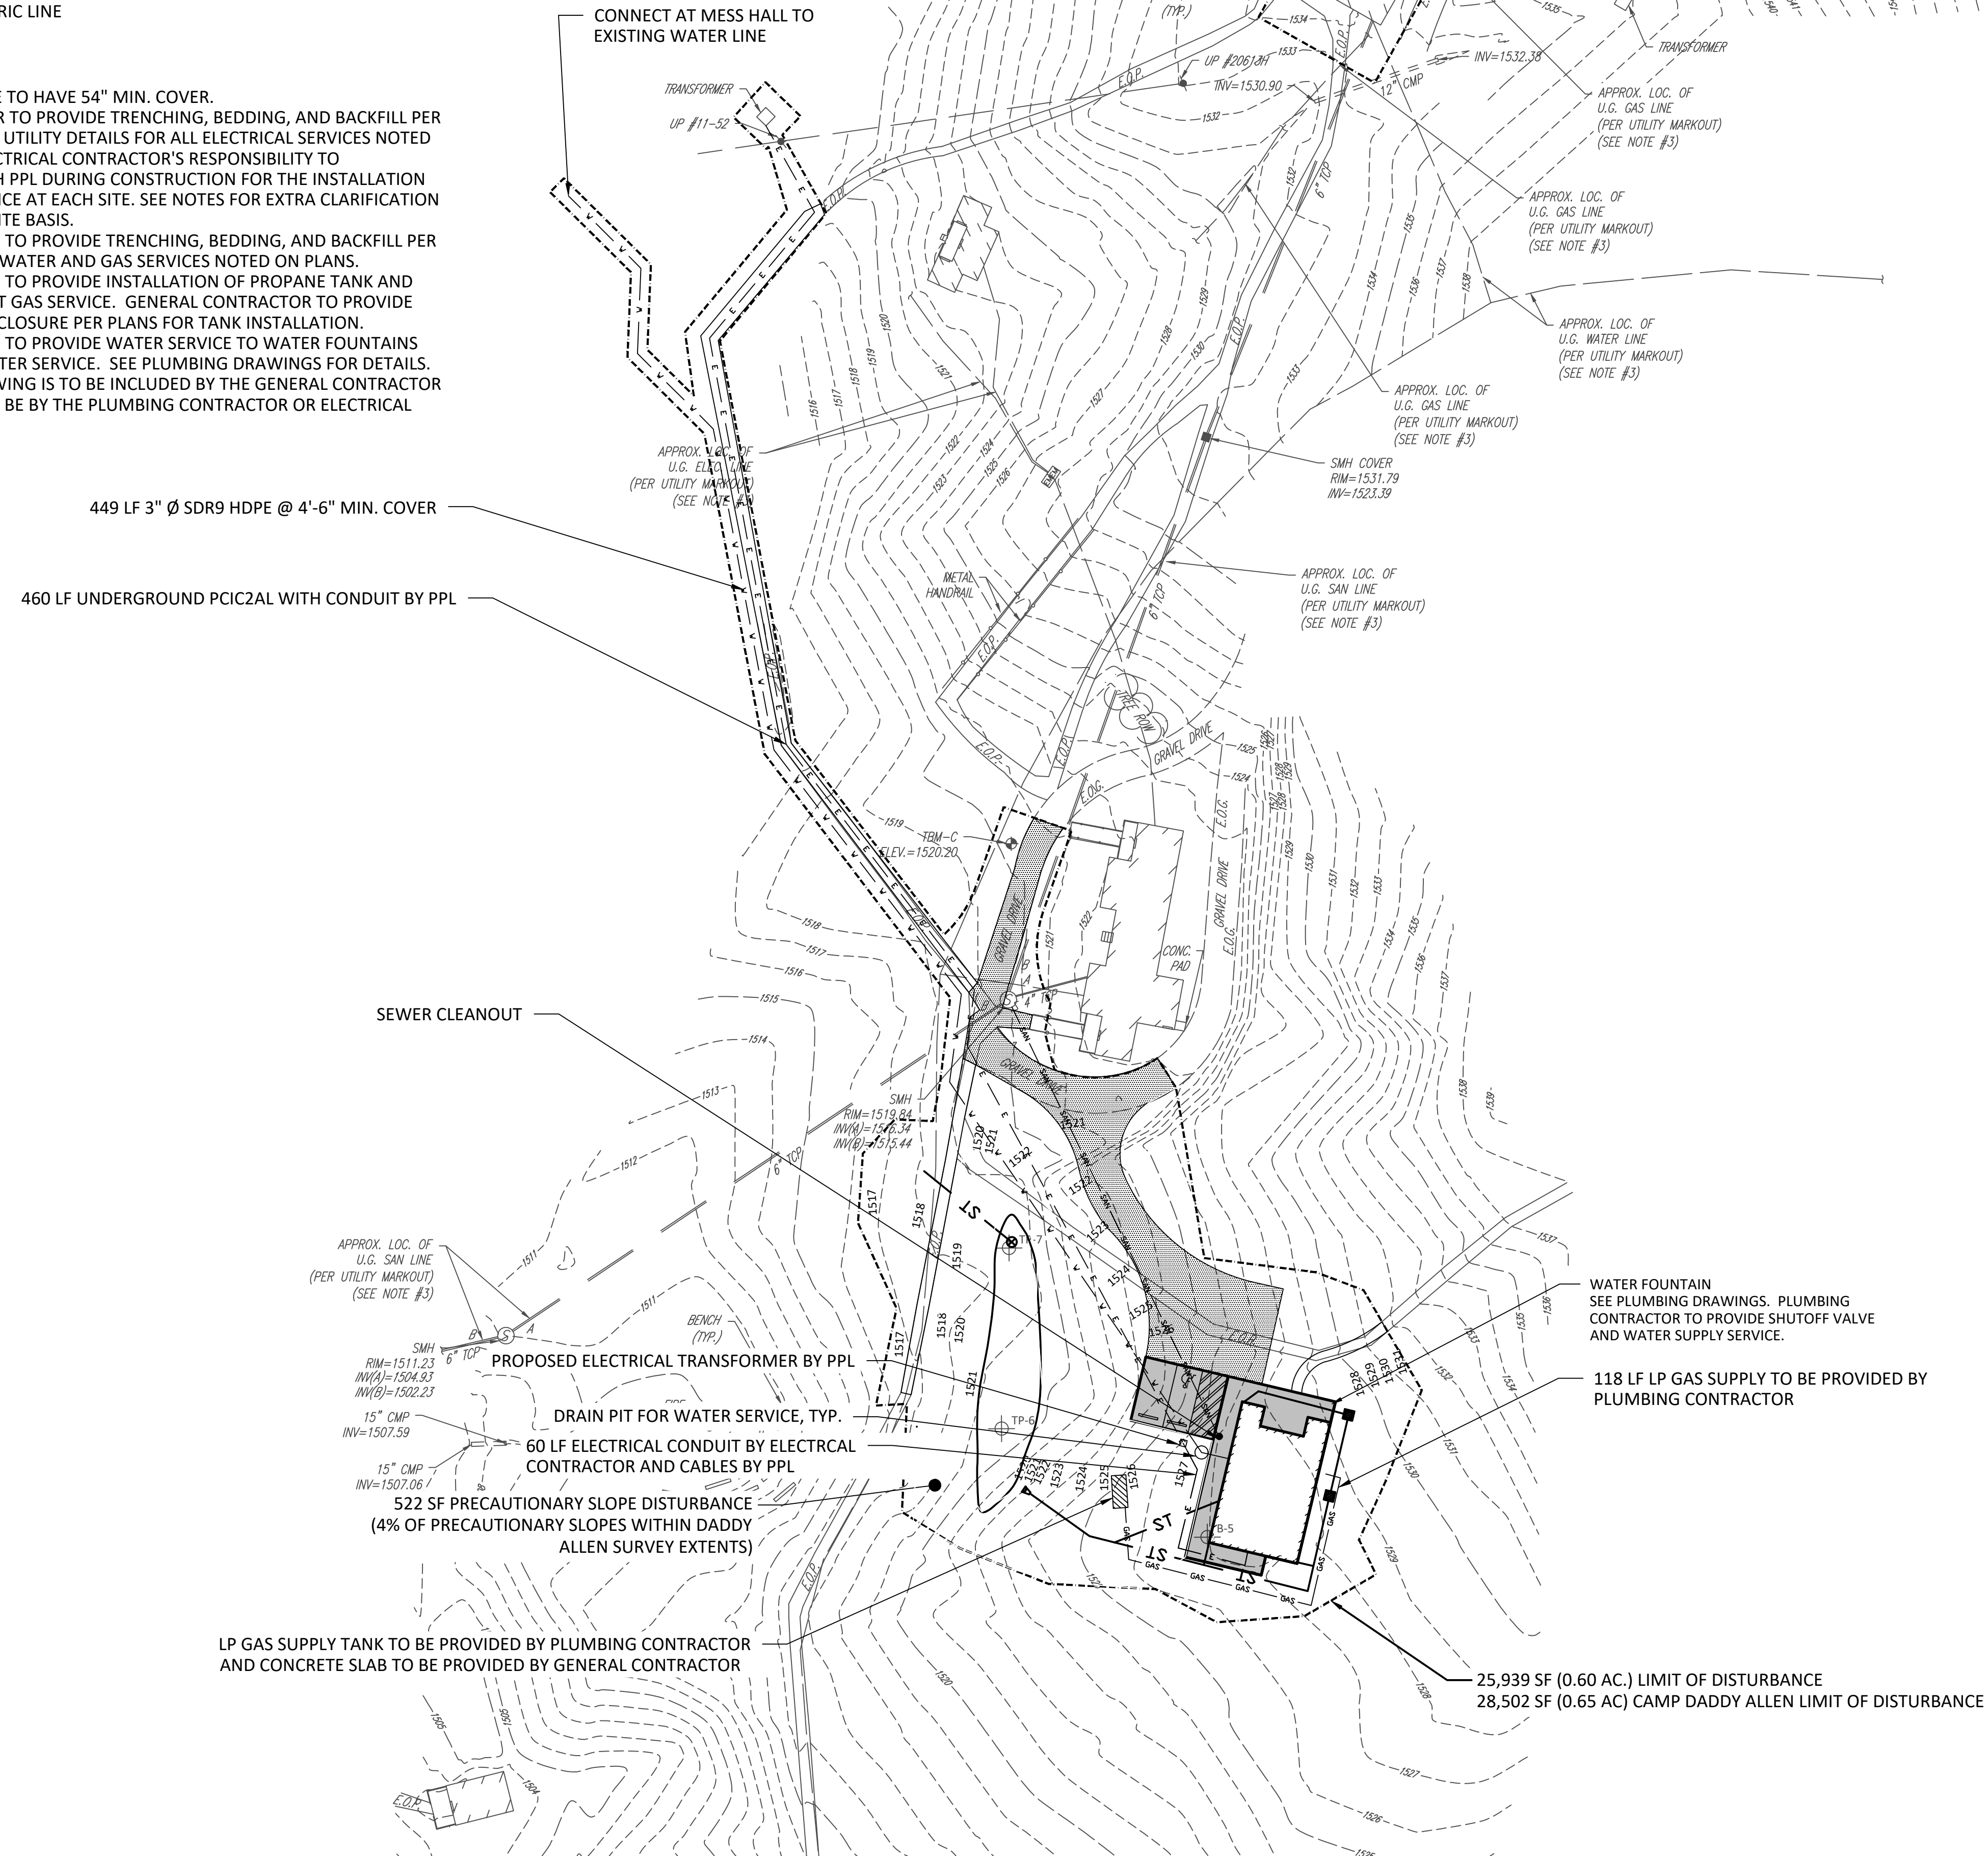

SITE LOCATION



SCALE: 1" = 2000'

CONSTRUCTION DOCUMENTS

meliora

259 MORGAN STREET, PHOENIXVILLE, PA 19460
(610) 933-0123
melioradesign.com

NO.	REVISION	DATE

REGISTERED PROFESSIONAL ENGINEER

MARC B. HENDERSON

ENGINEER No. 08040

Marc Henderson 06/15/22

SIGNATURE DATE

SMP ARCHITECTS
1600 WALNUT STREET, SECOND FLOOR
PHILADELPHIA, PENNSYLVANIA

COMMONWEALTH OF PENNSYLVANIA
DEPARTMENT OF GENERAL SERVICES
HARRISBURG, PENNSYLVANIA

D.G.S. PROJECT No. C-114-0006 PHASE 1

HICKORY RUN STATE PARK
LATRINE IMPROVEMENTS
DEPT of CONSERVATION AND NATURAL RESOURCES
WHITE HAVEN, CARBON COUNTY, PA

UTILITY PLAN -
CAMP DADDY ALLEN

VERIFY SCALE

BAR IS ONE (1) INCH LONG ON ORIGINAL DRAWING:


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IF BAR IS NOT ONE (1) INCH LONG, ADJUST SCALE ACCORDINGLY


CONTRACTOR SHALL FIELD VERIFY ALL DIMENSIONS. VARIANCE FROM CONTRACT DOCUMENTS NOT PERMITTED WITHOUT PROFESSIONAL & BUREAU OF CONSTRUCTION APPROVAL.

DRAWN BY L GILL	DATE 06/17/2022	DRAWING No. CPE-23
CHECKED BY M HENDERSON	SCALE AS NOTED	36 OF 144


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 PLOTTED BY: Laura L. Gill
 LAYOUT TAB: UTILITY PLAN - CAMP DADDY ALLEN
 PLOTTED: 2022.06.17 04:24 PM

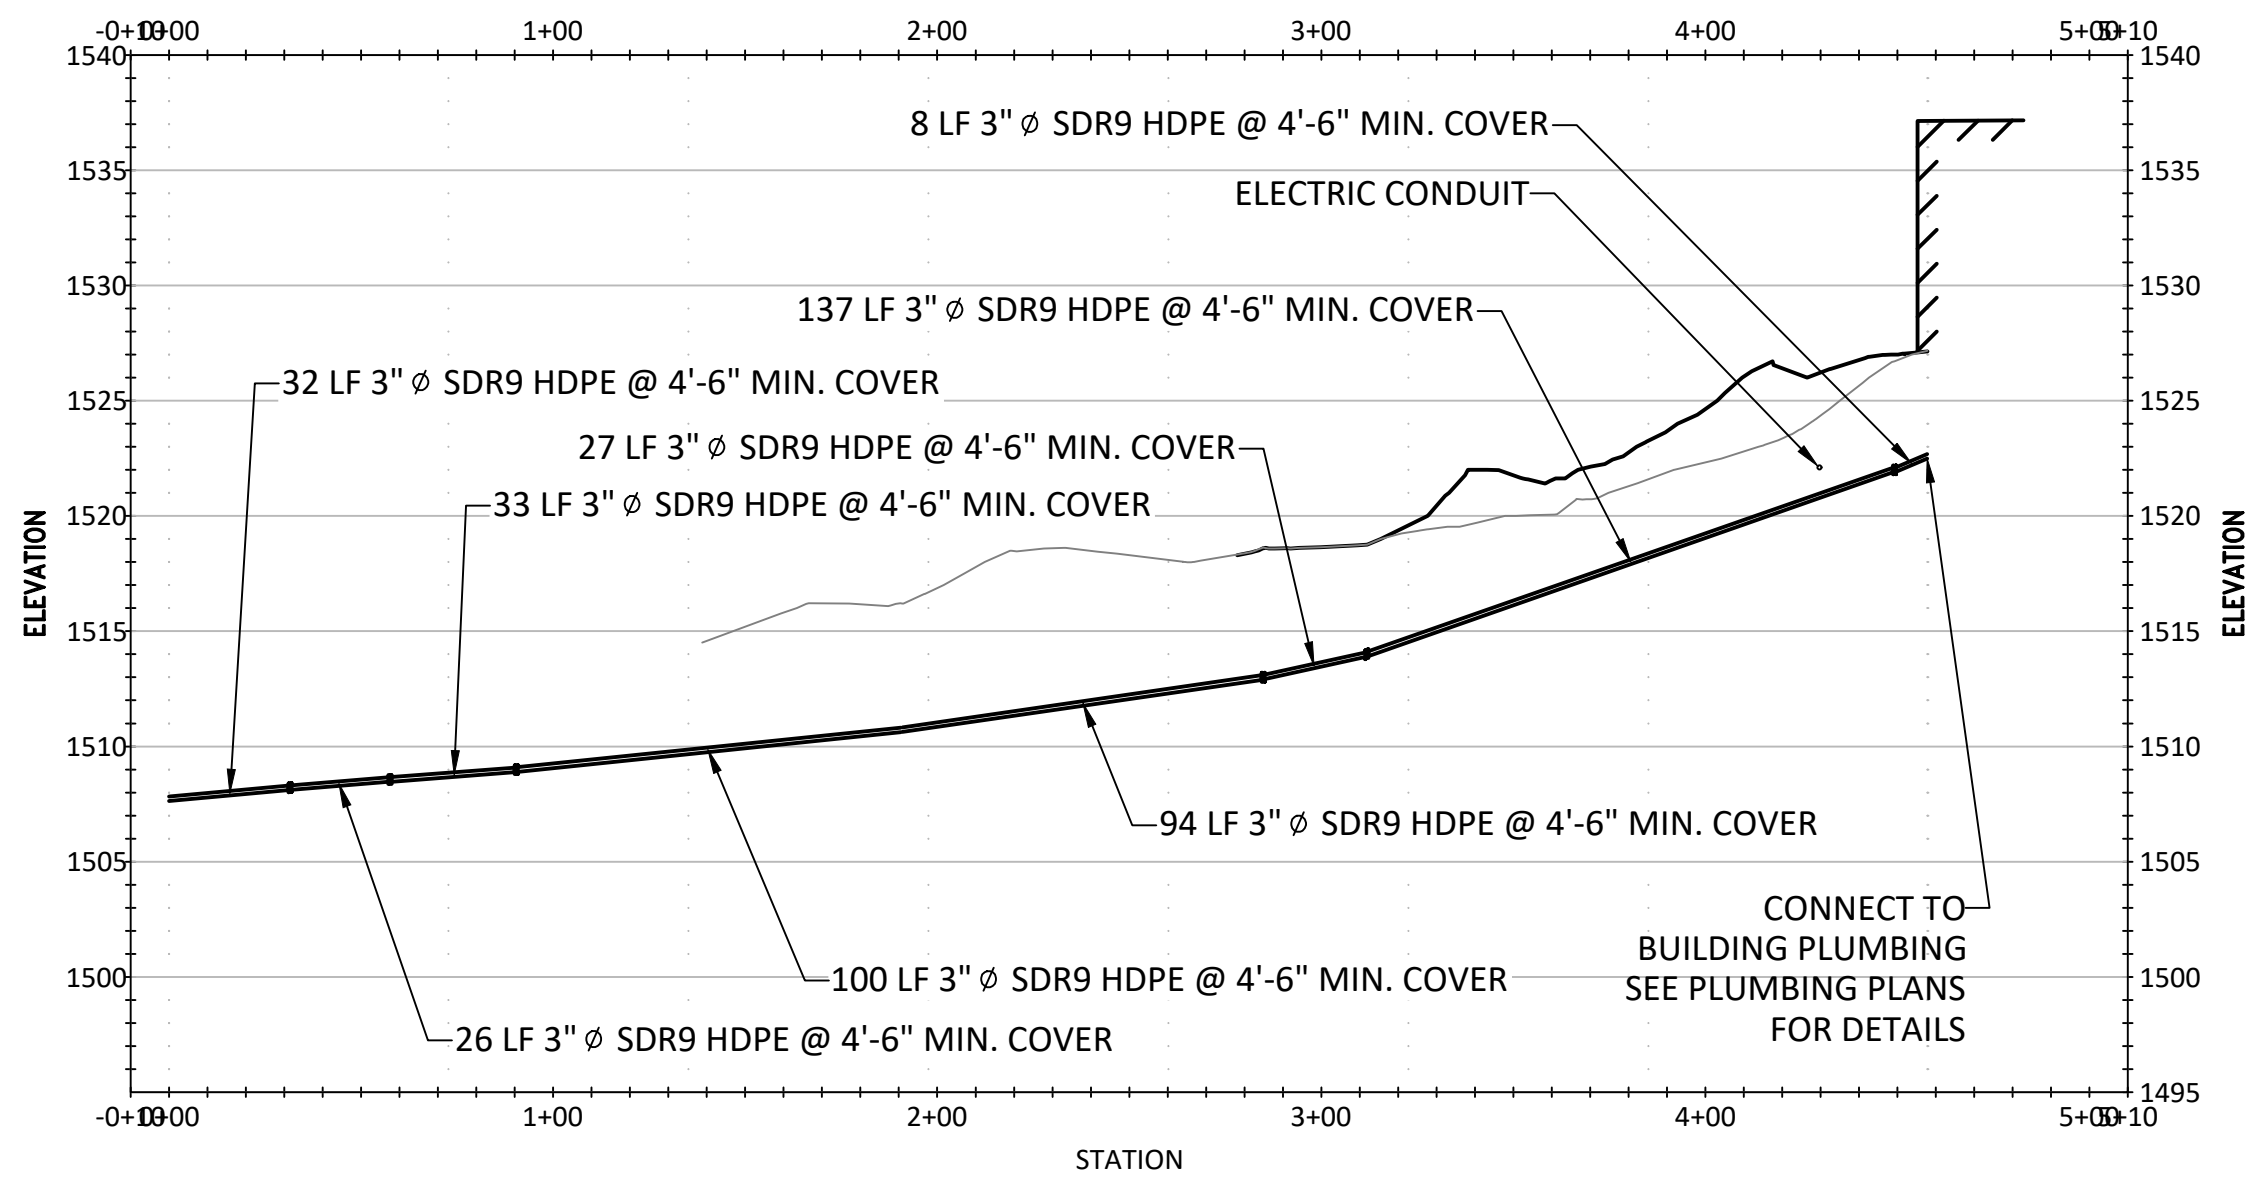

1 PROFILE VIEW
 CPE-24 CAMP DADDY ALLEN - WATER LINE 1"=50' H, 1"=10' V

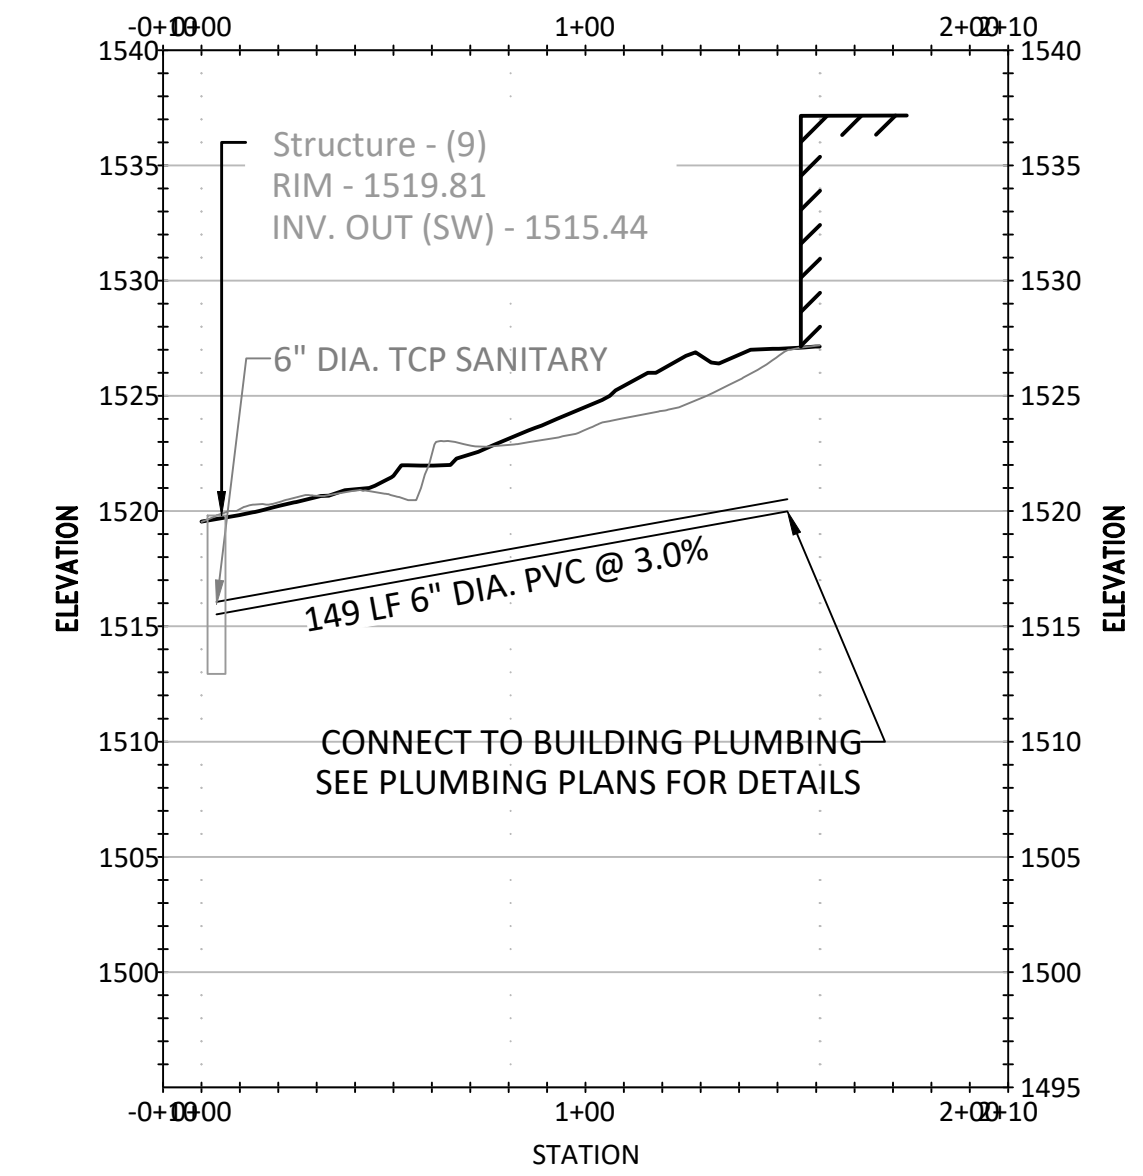

2 PROFILE VIEW
 CPE-24 CAMP DADDY ALLEN - SANITARY SEWER 1"=50' H, 1"=10' V

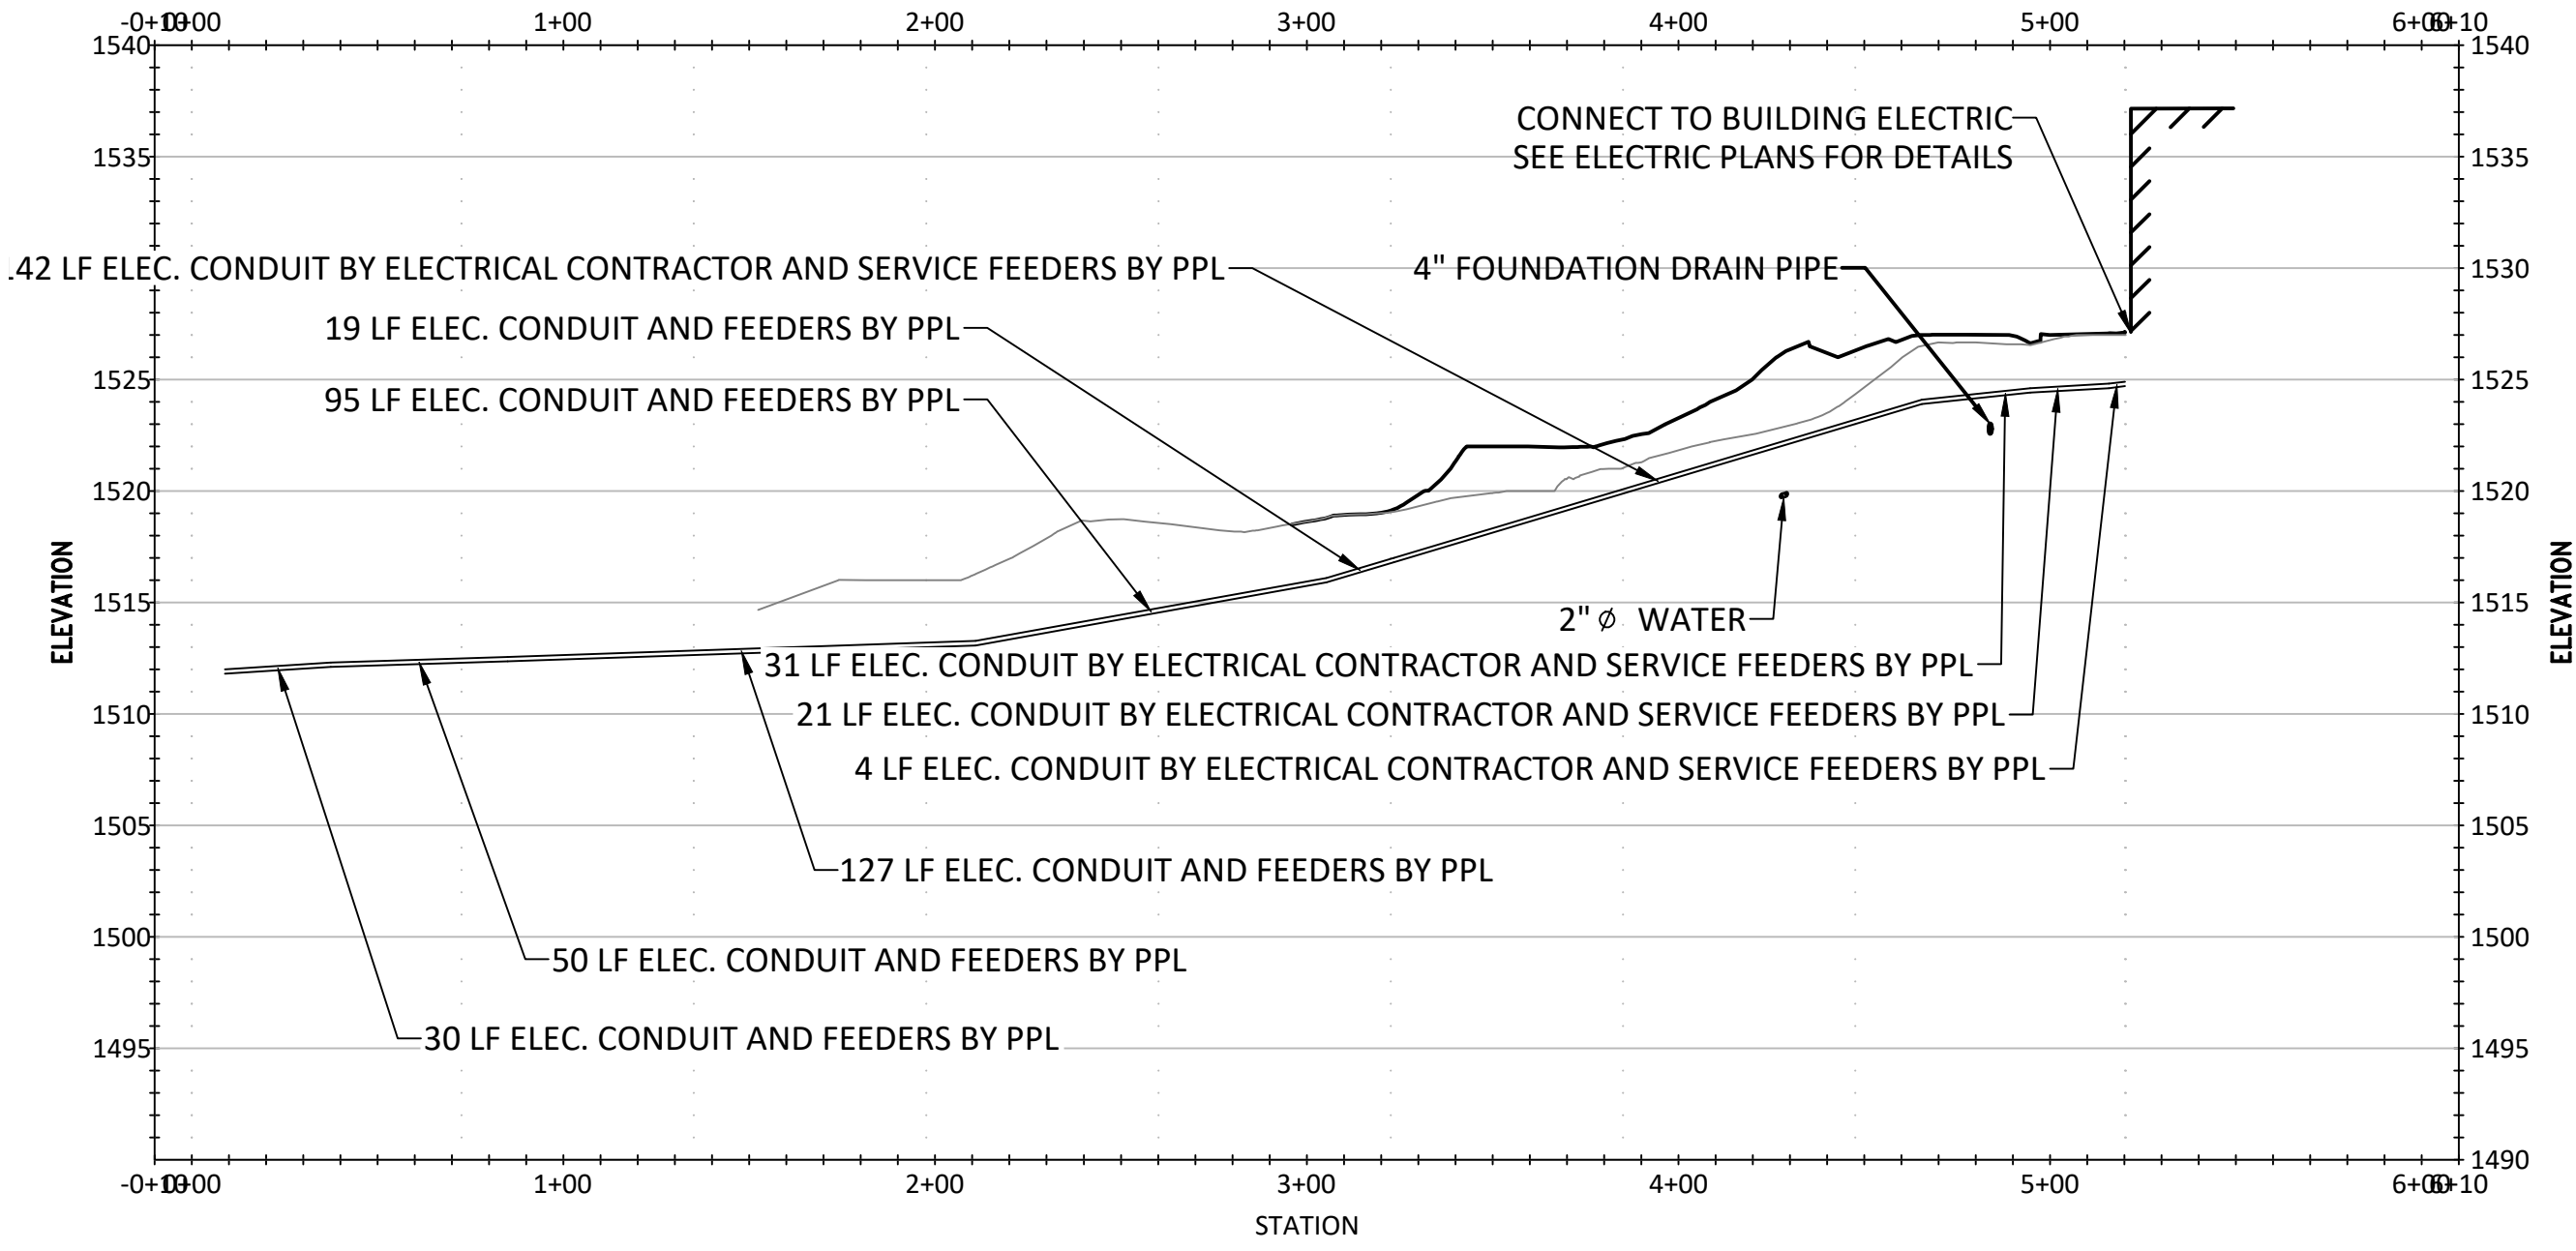

3 PROFILE VIEW
 CPE-24 CAMP DADDY ALLEN - ELECTRIC LINE 1"=50' H, 1"=10' V

- NOTES:
1. WATER AND SEWER LINES TO BE INSTALLED BELOW FROST DEPTH.
 2. ALL WORK ON THIS DRAWING IS TO BE INCLUDED BY THE GENERAL CONTRACTOR EXCEPT WORK NOTED TO BE BY THE PLUMBING CONTRACTOR OR ELECTRICAL CONTRACTOR.

CONSTRUCTION DOCUMENTS



RECORD REVISIONS

SMP ARCHITECTS
 1600 WALNUT STREET, SECOND FLOOR
 PHILADELPHIA, PENNSYLVANIA

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 DEPARTMENT OF GENERAL SERVICES
 HARRISBURG, PENNSYLVANIA

D.G.S. PROJECT No.
C-114-0006 PHASE 1

HICKORY RUN STATE PARK
LATRINE IMPROVEMENTS
 DEPT of CONSERVATION AND NATURAL RESOURCES
 WHITE HAVEN, CARBON COUNTY, PA

UTILITY PROFILES - CAMP DADDY ALLEN

VERIFY SCALE

BAR IS ONE (1) INCH LONG ON ORIGINAL DRAWING:
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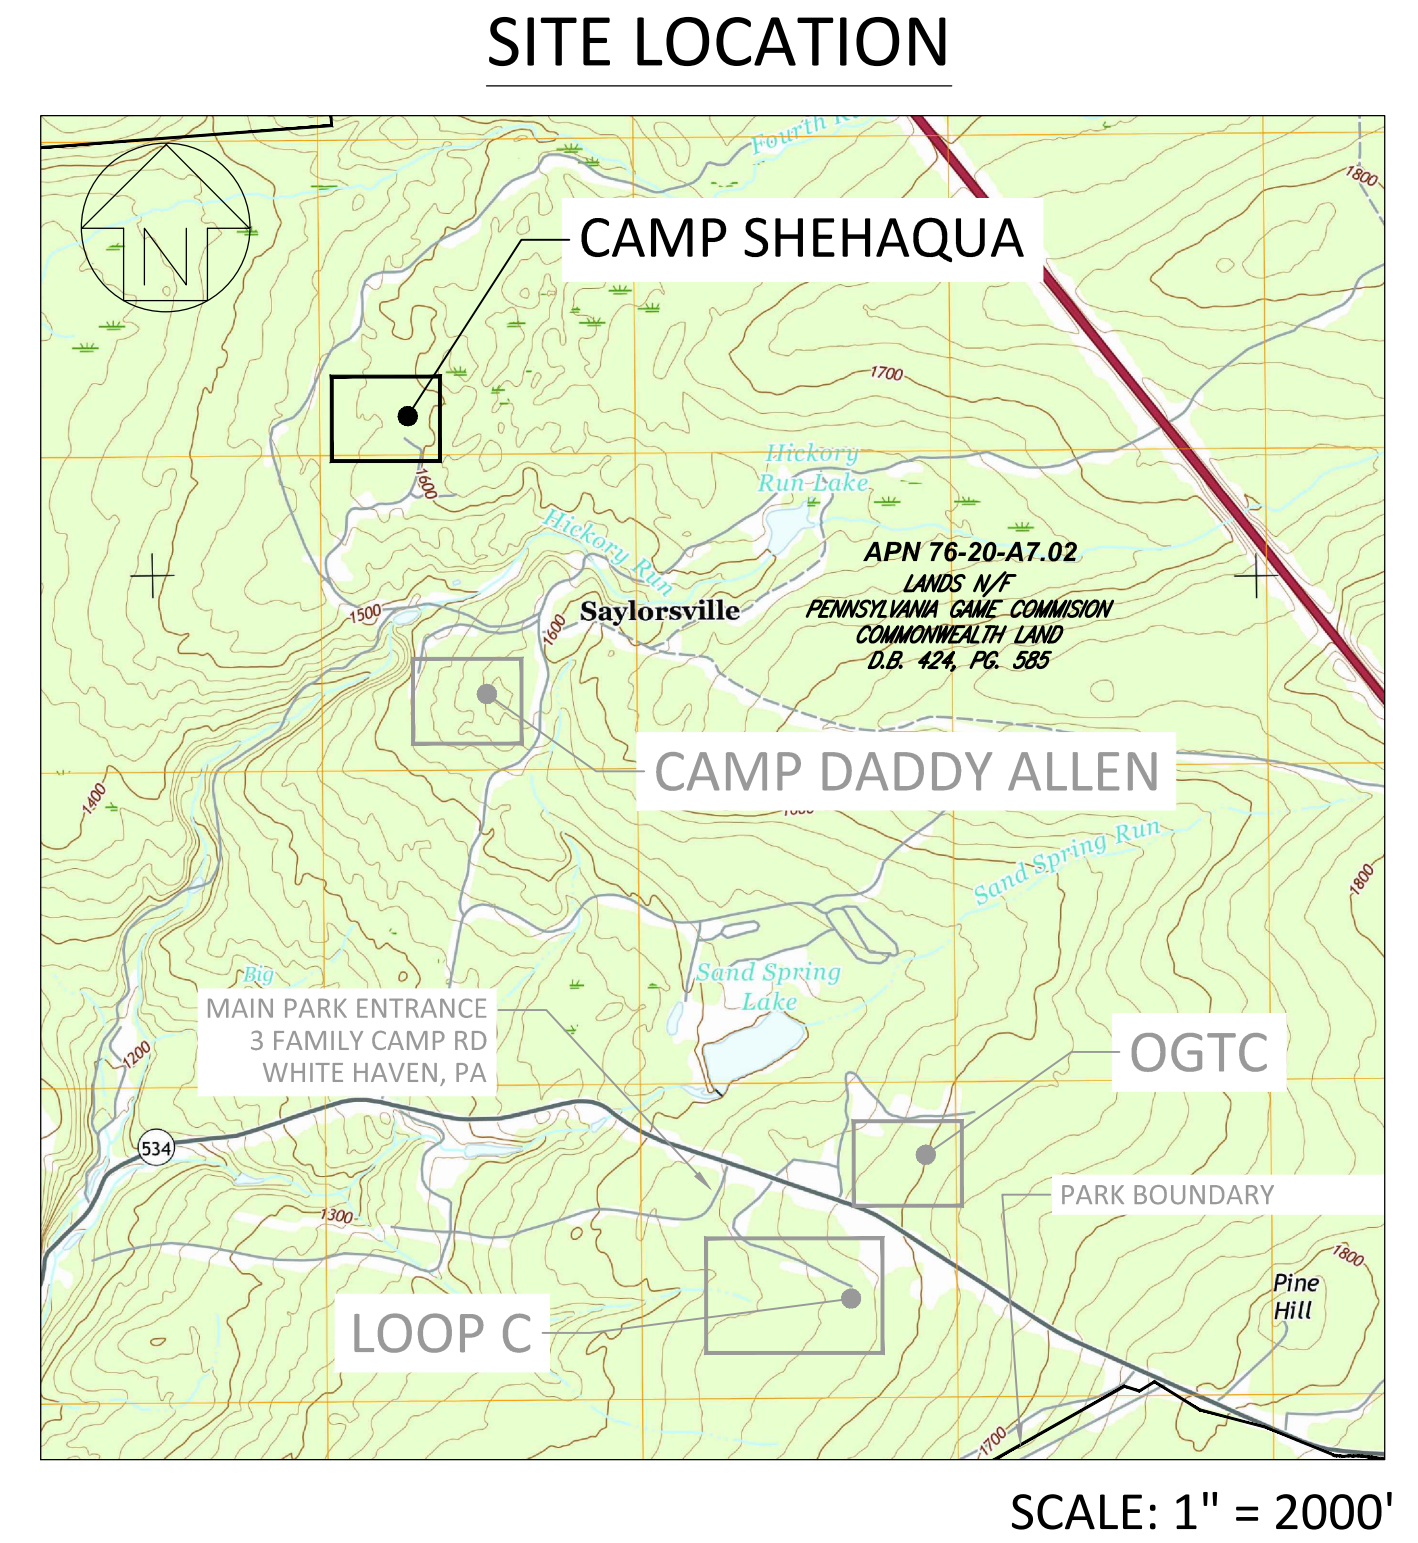
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CONTRACTOR SHALL FIELD VERIFY ALL DIMENSIONS. VARIANCE FROM CONTRACT DOCUMENTS NOT PERMITTED WITHOUT PROFESSIONAL & BUREAU OF CONSTRUCTION APPROVAL.

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CHECKED BY M HENDERSON	SCALE AS NOTED	37 OF 144

FILE PATH: I:\2020\09077 - Hickory Run State Park\CAD Sheets\2022\Utility Profiles.dwg PLOTTED BY: Laura L. Gill
 LAST SAVED: 2022.06.17 04:52 PM

- LEGEND**
- S — EXISTING 6" PVC GRAVITY SEWER
 - W — EXISTING WATER MAIN
 - — EXISTING UTILITY POLE
 - P — EXISTING POWER LINE
 - — EXISTING TREE
 - - - - EXISTING CONTOUR
 - - - - LEGAL RIGHT-OF-WAY LINE
 - - - - EXISTING EDGE OF PAVEMENT
 - Abcde — TEXT FOR EXISTING ITEMS
 - ABCDE — TEXT FOR EXISTING ITEMS
 - ~~~~~ — WOODS LINE
 - - - - EXISTING STORM SEWER
 - ⊙ — EXISTING SANITARY MANHOLE
 - ⊕/B-9 — SOIL TEST PIT (TP) OR BORING (B) LOCATION
 - ▨ — SLOPES 15%-25%
 - ▩ — SLOPES >25%
 - ▧ — WETLAND



CONSTRUCTION DOCUMENTS

meliora

259 MORGAN STREET, PHOENIXVILLE, PA 19460
(610) 933-0123
melioradesign.com

RECORD REVISIONS

Marc B. Henderson 06/15/22
SIGNATURE DATE

SMP ARCHITECTS
1600 WALNUT STREET, SECOND FLOOR
PHILADELPHIA, PENNSYLVANIA

COMMONWEALTH OF PENNSYLVANIA
DEPARTMENT OF GENERAL SERVICES
HARRISBURG, PENNSYLVANIA

D.G.S. PROJECT No.
C-114-0006 PHASE 1
HICKORY RUN STATE PARK
LATRINE IMPROVEMENTS
DEPT of CONSERVATION AND NATURAL RESOURCES
WHITE HAVEN, CARBON COUNTY, PA
EXISTING CONDITIONS PLAN -
CAMP SHEHAQUA

VERIFY SCALE

BAR IS ONE (1) INCH LONG ON ORIGINAL DRAWING.

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IF BAR IS NOT ONE (1) INCH LONG, ADJUST SCALE ACCORDINGLY.



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DRAWN BY	DATE	DRAWING No.
	06/17/2022	C-25
CHECKED BY	SCALE	AS NOTED

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LAYOUT TAB: EXISTING CONDITIONS PLAN - CAMP SHEHAQUA
PLOTTED BY: Laura L. Gill
2022.06.15 04:53 PM


- LEGEND**
- PROJECT BOUNDARY/LIMIT OF DISTURBANCE
 - TREE PROTECTION
 - COMPOST SOCK
 - CONSTRUCTION FENCE
 - ROCK CONSTRUCTION ENTRANCE
 - EROSION CONTROL BLANKET
 - SEDIMENT TRAP
 - INFILTRATION STAKEOUT FENCE

Map Unit Symbol	Map Unit Name	Rating
TuC	Tunkhannock gravelly loam, 8 to 15 percent slopes	Very Limited

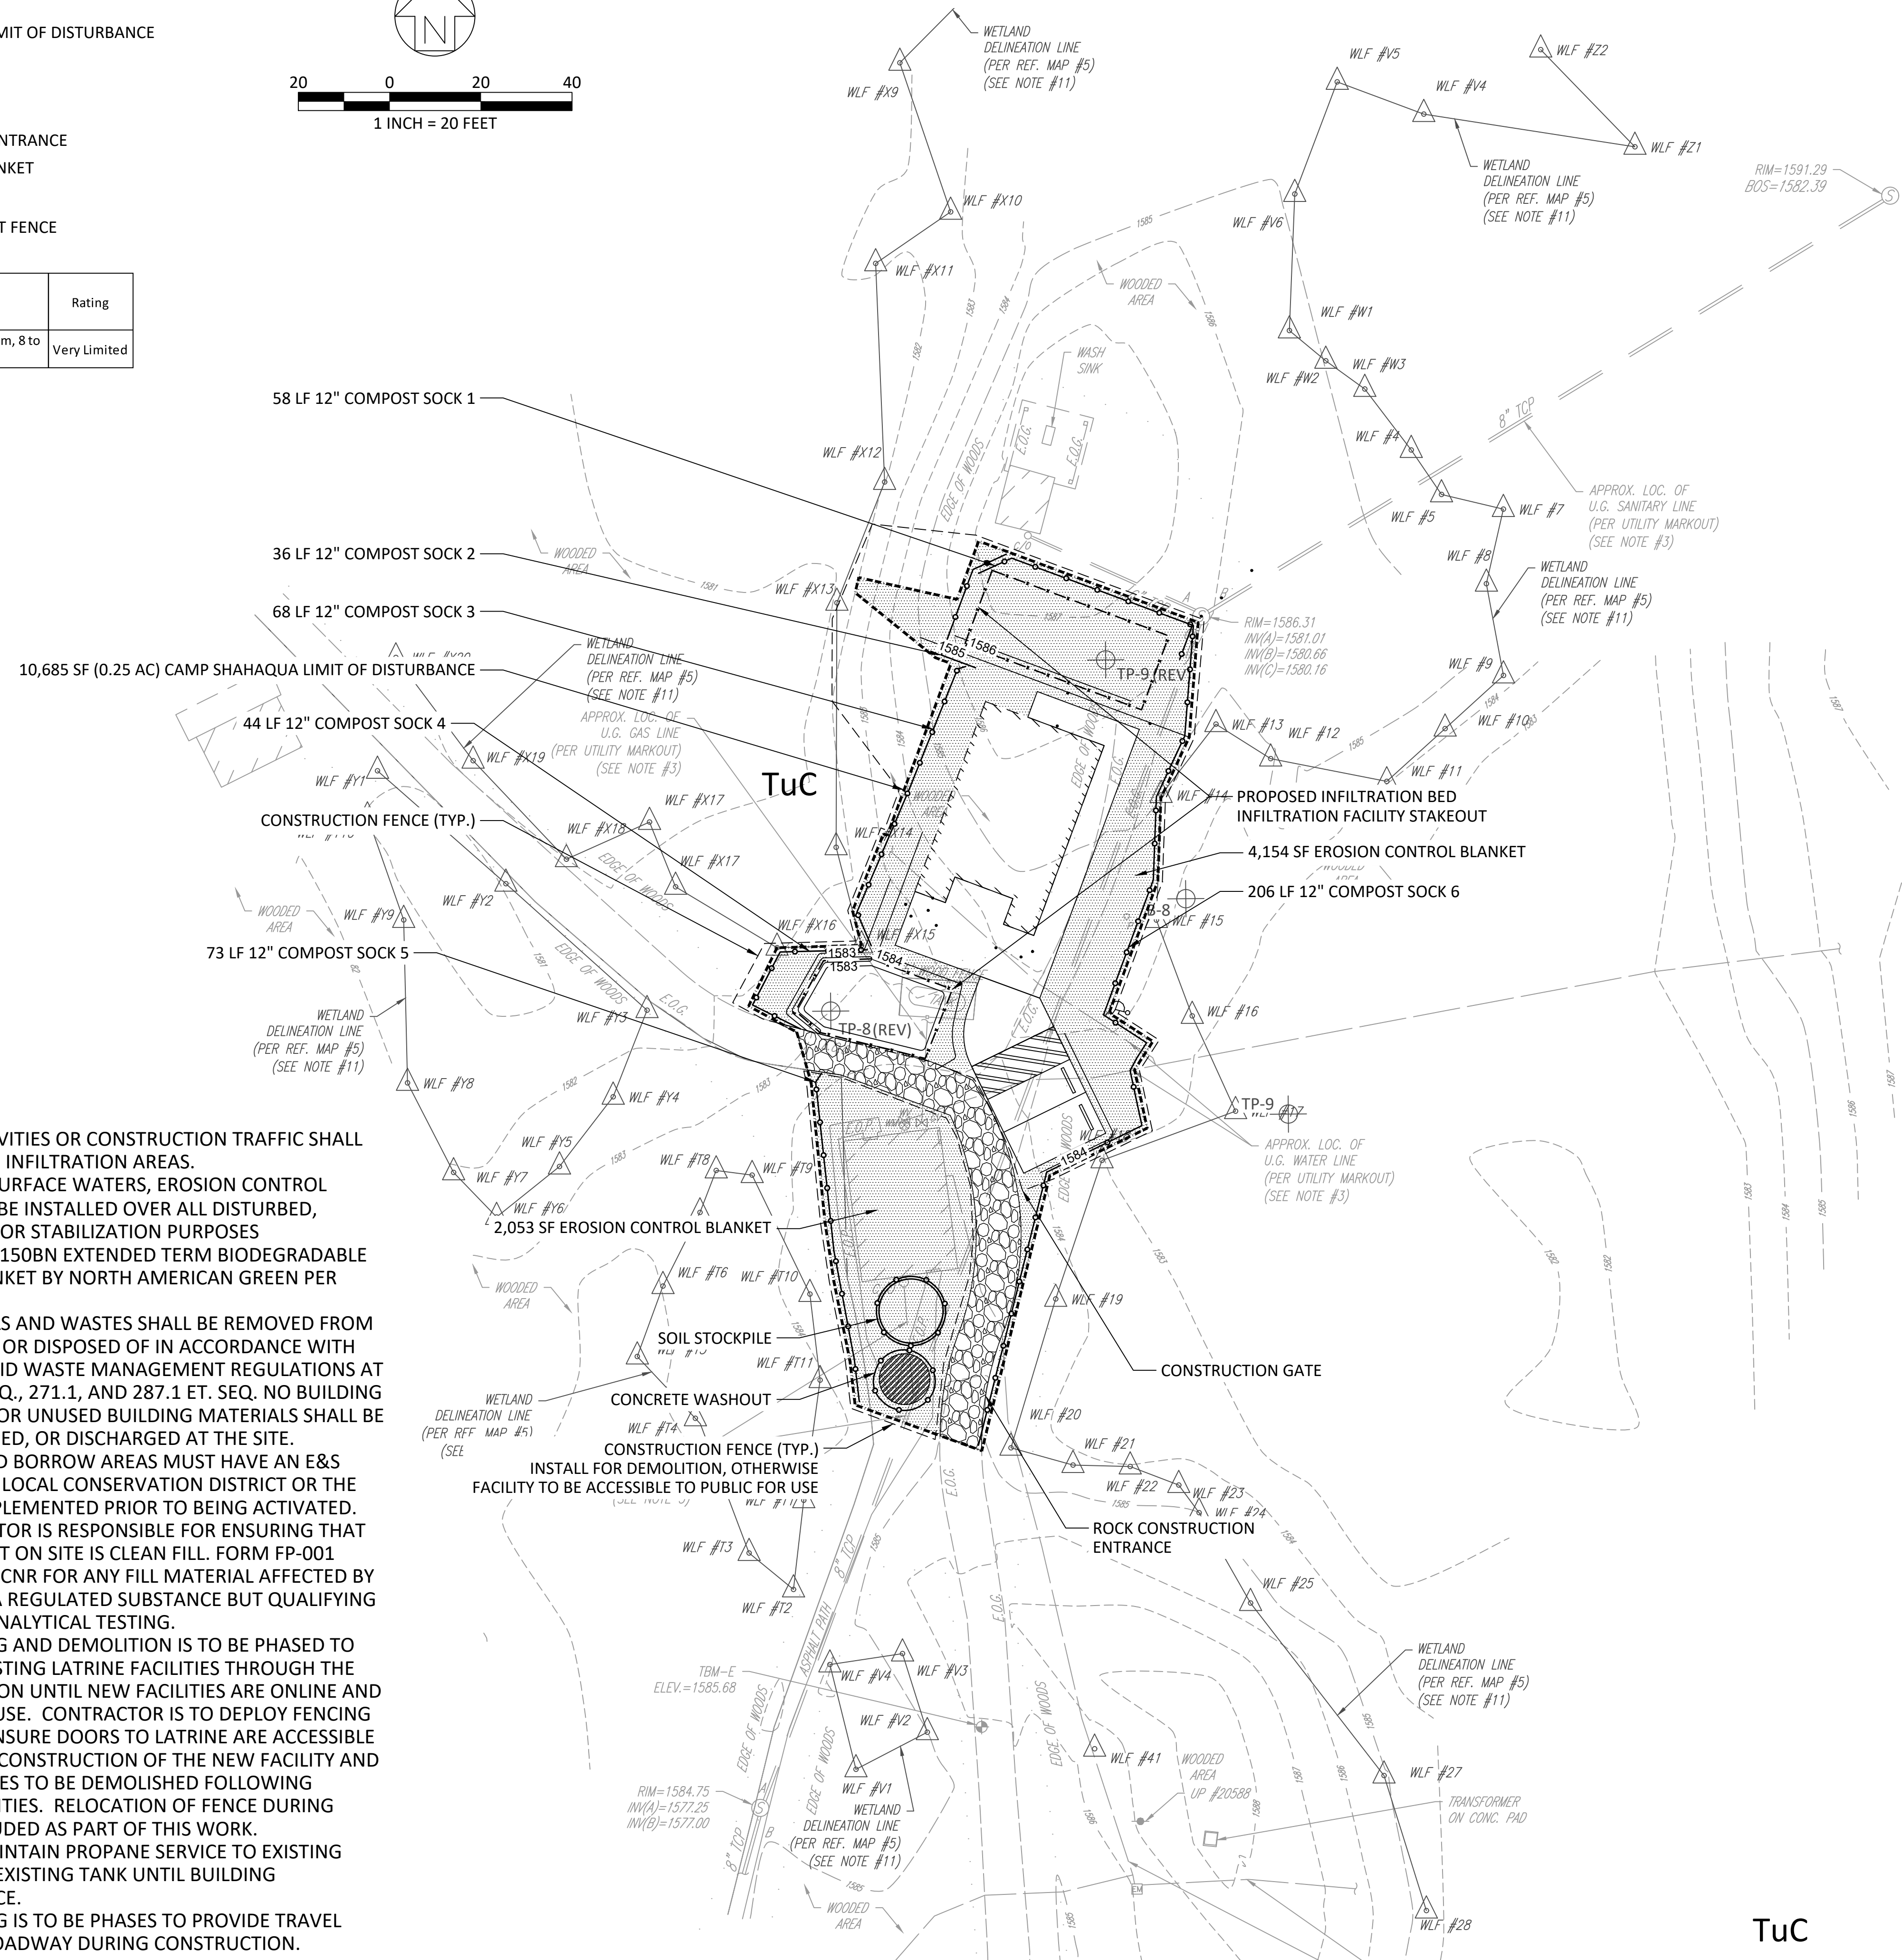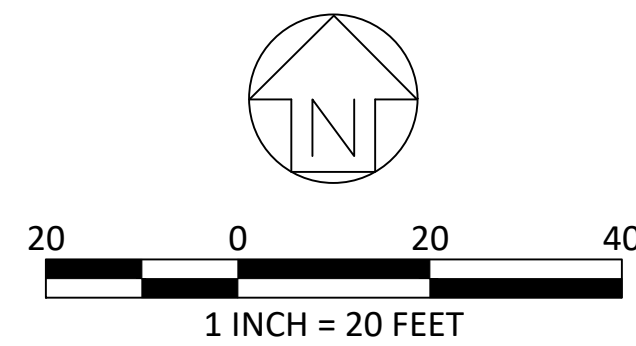

- NOTES:**
- NO EARTHMOVING ACTIVITIES OR CONSTRUCTION TRAFFIC SHALL OCCUR OVER PROPOSED INFILTRATION AREAS.
 - DUE TO PROXIMITY TO SURFACE WATERS, EROSION CONTROL BLANKET (ECB) SHOULD BE INSTALLED OVER ALL DISTURBED, NON-PAVED SURFACES FOR STABILIZATION PURPOSES
 - ECB SHALL BE BIONET SC150BN EXTENDED TERM BIODEGRADABLE EROSION CONTROL BLANKET BY NORTH AMERICAN GREEN PER SPECIFICATIONS
 - ALL BUILDING MATERIALS AND WASTES SHALL BE REMOVED FROM THE SITE AND RECYCLED OR DISPOSED OF IN ACCORDANCE WITH THE DEPARTMENT'S SOLID WASTE MANAGEMENT REGULATIONS AT 25 PA. CODE 260.1 ET SEQ., 271.1, AND 287.1 ET. SEQ. NO BUILDING MATERIALS OR WASTES OR UNUSED BUILDING MATERIALS SHALL BE BURNED, BURIED, DUMPED, OR DISCHARGED AT THE SITE.
 - ALL OFF-SITE WASTE AND BORROW AREAS MUST HAVE AN E&S PLAN APPROVED BY THE LOCAL CONSERVATION DISTRICT OR THE DEPARTMENT FULLY IMPLEMENTED PRIOR TO BEING ACTIVATED.
 - THE GENERAL CONTRACTOR IS RESPONSIBLE FOR ENSURING THAT ANY MATERIAL BROUGHT ON SITE IS CLEAN FILL. FORM FP-001 MUST BE RETAINED BY DCNR FOR ANY FILL MATERIAL AFFECTED BY A SPILL OR RELEASE OF A REGULATED SUBSTANCE BUT QUALIFYING AS CLEAN FILL DUE TO ANALYTICAL TESTING.
 - CONSTRUCTION FENCING AND DEMOLITION IS TO BE PHASED TO PROVIDE ACCESS TO EXISTING LATRINE FACILITIES THROUGH THE EXTENT OF CONSTRUCTION UNTIL NEW FACILITIES ARE ONLINE AND AVAILABLE FOR PUBLIC USE. CONTRACTOR IS TO DEPLOY FENCING IN SUCH A WAY AS TO ENSURE DOORS TO LATRINE ARE ACCESSIBLE TO THE PUBLIC DURING CONSTRUCTION OF THE NEW FACILITY AND ONLY FENCE OFF LATRINES TO BE DEMOLISHED FOLLOWING OPENING OF NEW FACILITIES. RELOCATION OF FENCE DURING CONSTRUCTION IS INCLUDED AS PART OF THIS WORK.
 - CONTRACTOR MUST MAINTAIN PROPANE SERVICE TO EXISTING LATRINE FACILITY WITH EXISTING TANK UNTIL BUILDING DEMOLITION TAKES PLACE.
 - CONSTRUCTION FENCING IS TO BE PHASES TO PROVIDE TRAVEL ACCESS BY PUBLIC TO ROADWAY DURING CONSTRUCTION.

SITE LOCATION

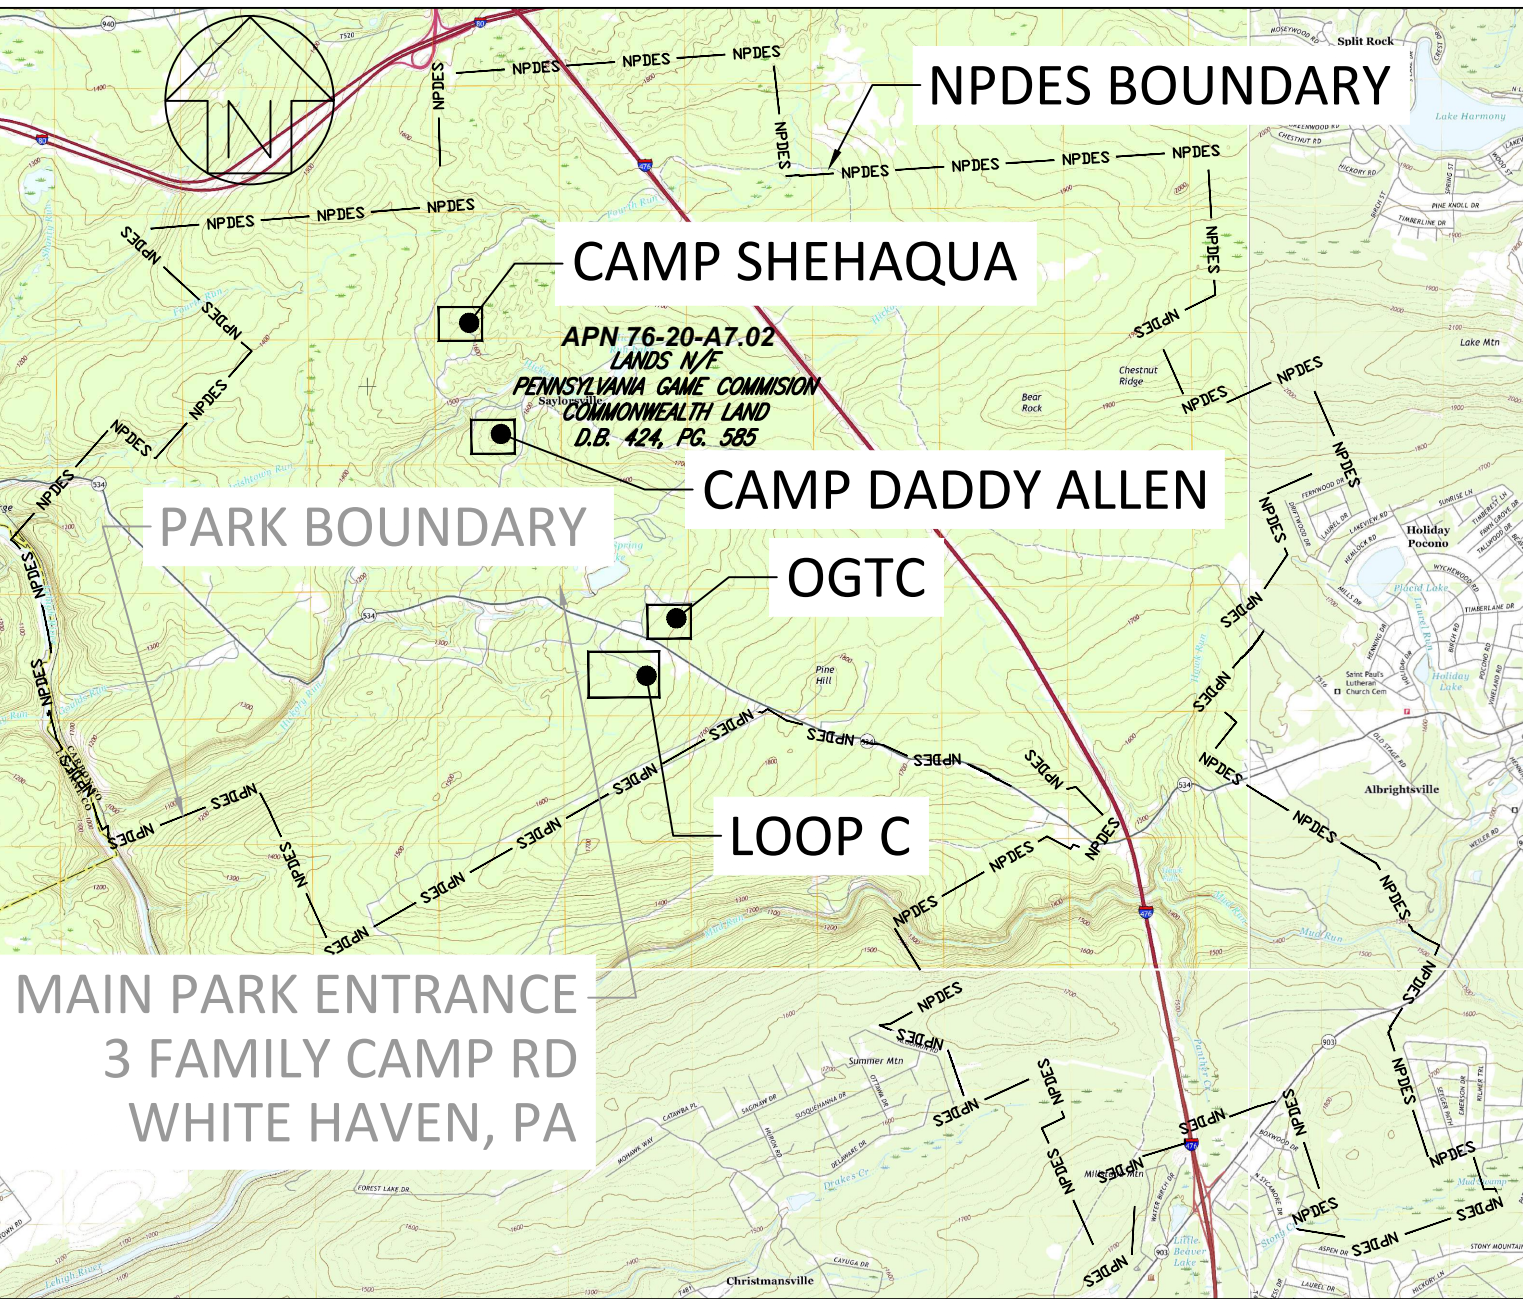

PA ONE CALL SERIAL NUMBER - 20202343070
 ALL LOCATIONS OF EXISTING UTILITIES SHOWN ON THIS PLAN HAVE BEEN DEVELOPED FROM EXISTING UTILITY RECORDS AND/OR ABOVE GROUND EXAMINATION OF THE SITE. COMPLETENESS OR ACCURACY OF LOCATION AND DEPTH OF UNDERGROUND UTILITIES OR STRUCTURES CANNOT BE GUARANTEED. CONTRACTOR MUST VERIFY LOCATION AND DEPTH OF ALL UNDERGROUND UTILITIES AND FACILITIES BEFORE START OF WORK PER PENNSYLVANIA ACT 287 OF 1974 AS AMENDED BY ACT 199 OF 2004 OR LATER.

CONSTRUCTION DOCUMENTS



RECORD REVISIONS

Professional Engineer Seal for Marc B. Henderson, No. 08840, State of Pennsylvania. Signature and date: 06/15/22.

SMP ARCHITECTS
 1600 WALNUT STREET, SECOND FLOOR
 PHILADELPHIA, PENNSYLVANIA

COMMONWEALTH OF PENNSYLVANIA
 DEPARTMENT OF GENERAL SERVICES
 HARRISBURG, PENNSYLVANIA

D.G.S. PROJECT No. C-114-0006 PHASE 1

HICKORY RUN STATE PARK
 LATRINE IMPROVEMENTS
 DEPT of CONSERVATION AND NATURAL RESOURCES
 WHITE HAVEN, CARBON COUNTY, PA

EROSION AND SEDIMENT CONTROL PLAN - CAMP SHEHAQUA

VERIFY SCALE
 BAR IS ONE (1) INCH LONG ON ORIGINAL DRAWING:
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 IF BAR IS NOT ONE (1) INCH LONG, ADJUST SCALE ACCORDINGLY


CONTRACTOR SHALL FIELD VERIFY ALL DIMENSIONS. VARIANCE FROM CONTRACT DOCUMENTS NOT PERMITTED WITHOUT PROFESSIONAL & BUREAU OF CONSTRUCTION APPROVAL.	DRAWN BY L GILL	DATE 06/17/2022	DRAWING No. C-27 of 44
	CHECKED BY M HENDERSON	SCALE AS NOTED	

TuC

FILE PATH: I:\2020\0607 - Hickory Run State Park\CAD\Sheet Files\2022\C-114\0006\114-0006-01.dwg PLOTTED BY: Marc Henderson LST SAVED: 2022.12.05 08:45 AM PLOTTED: 2022.12.05 08:45 AM EROSION AND SEDIMENT CONTROL PLAN - CAMP SHEHAQUA LAYOUT TAB


LEGEND

- PROJECT BOUNDARY/LIMIT OF DISTURBANCE
- ⊗ TREE TO BE REMOVED
- TREE TO BE PROTECTED
- ⊗ TREE TO BE IMPACTED
- ⊗ UTILITY STRUCTURE REMOVAL
- ⊗ UTILITY LINE REMOVAL
- ▨ BUILDING DEMOLITION
- ▨ CONCRETE DEMOLITION

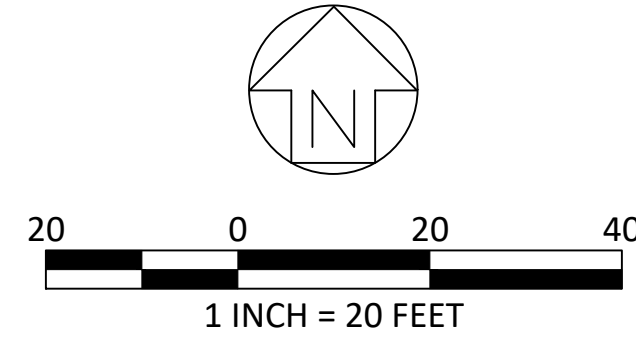


NOTES:

1. GENERAL CONTRACTOR TO DISCONNECT AND CAP ALL UTILITIES TO BUILDING TO BE DEMOLISHED.
2. EXISTING PROPANE TANK TO BE RELOCATED TO SUPPLY FUEL TO EXISTING BATH HOUSE DURING CONSTRUCTION PRIOR TO DEMOLITION. FOLLOWING DEMOLITION OF BUILDING, PROPANE TANK TO BE RETURNED TO THE DEPARTMENT.

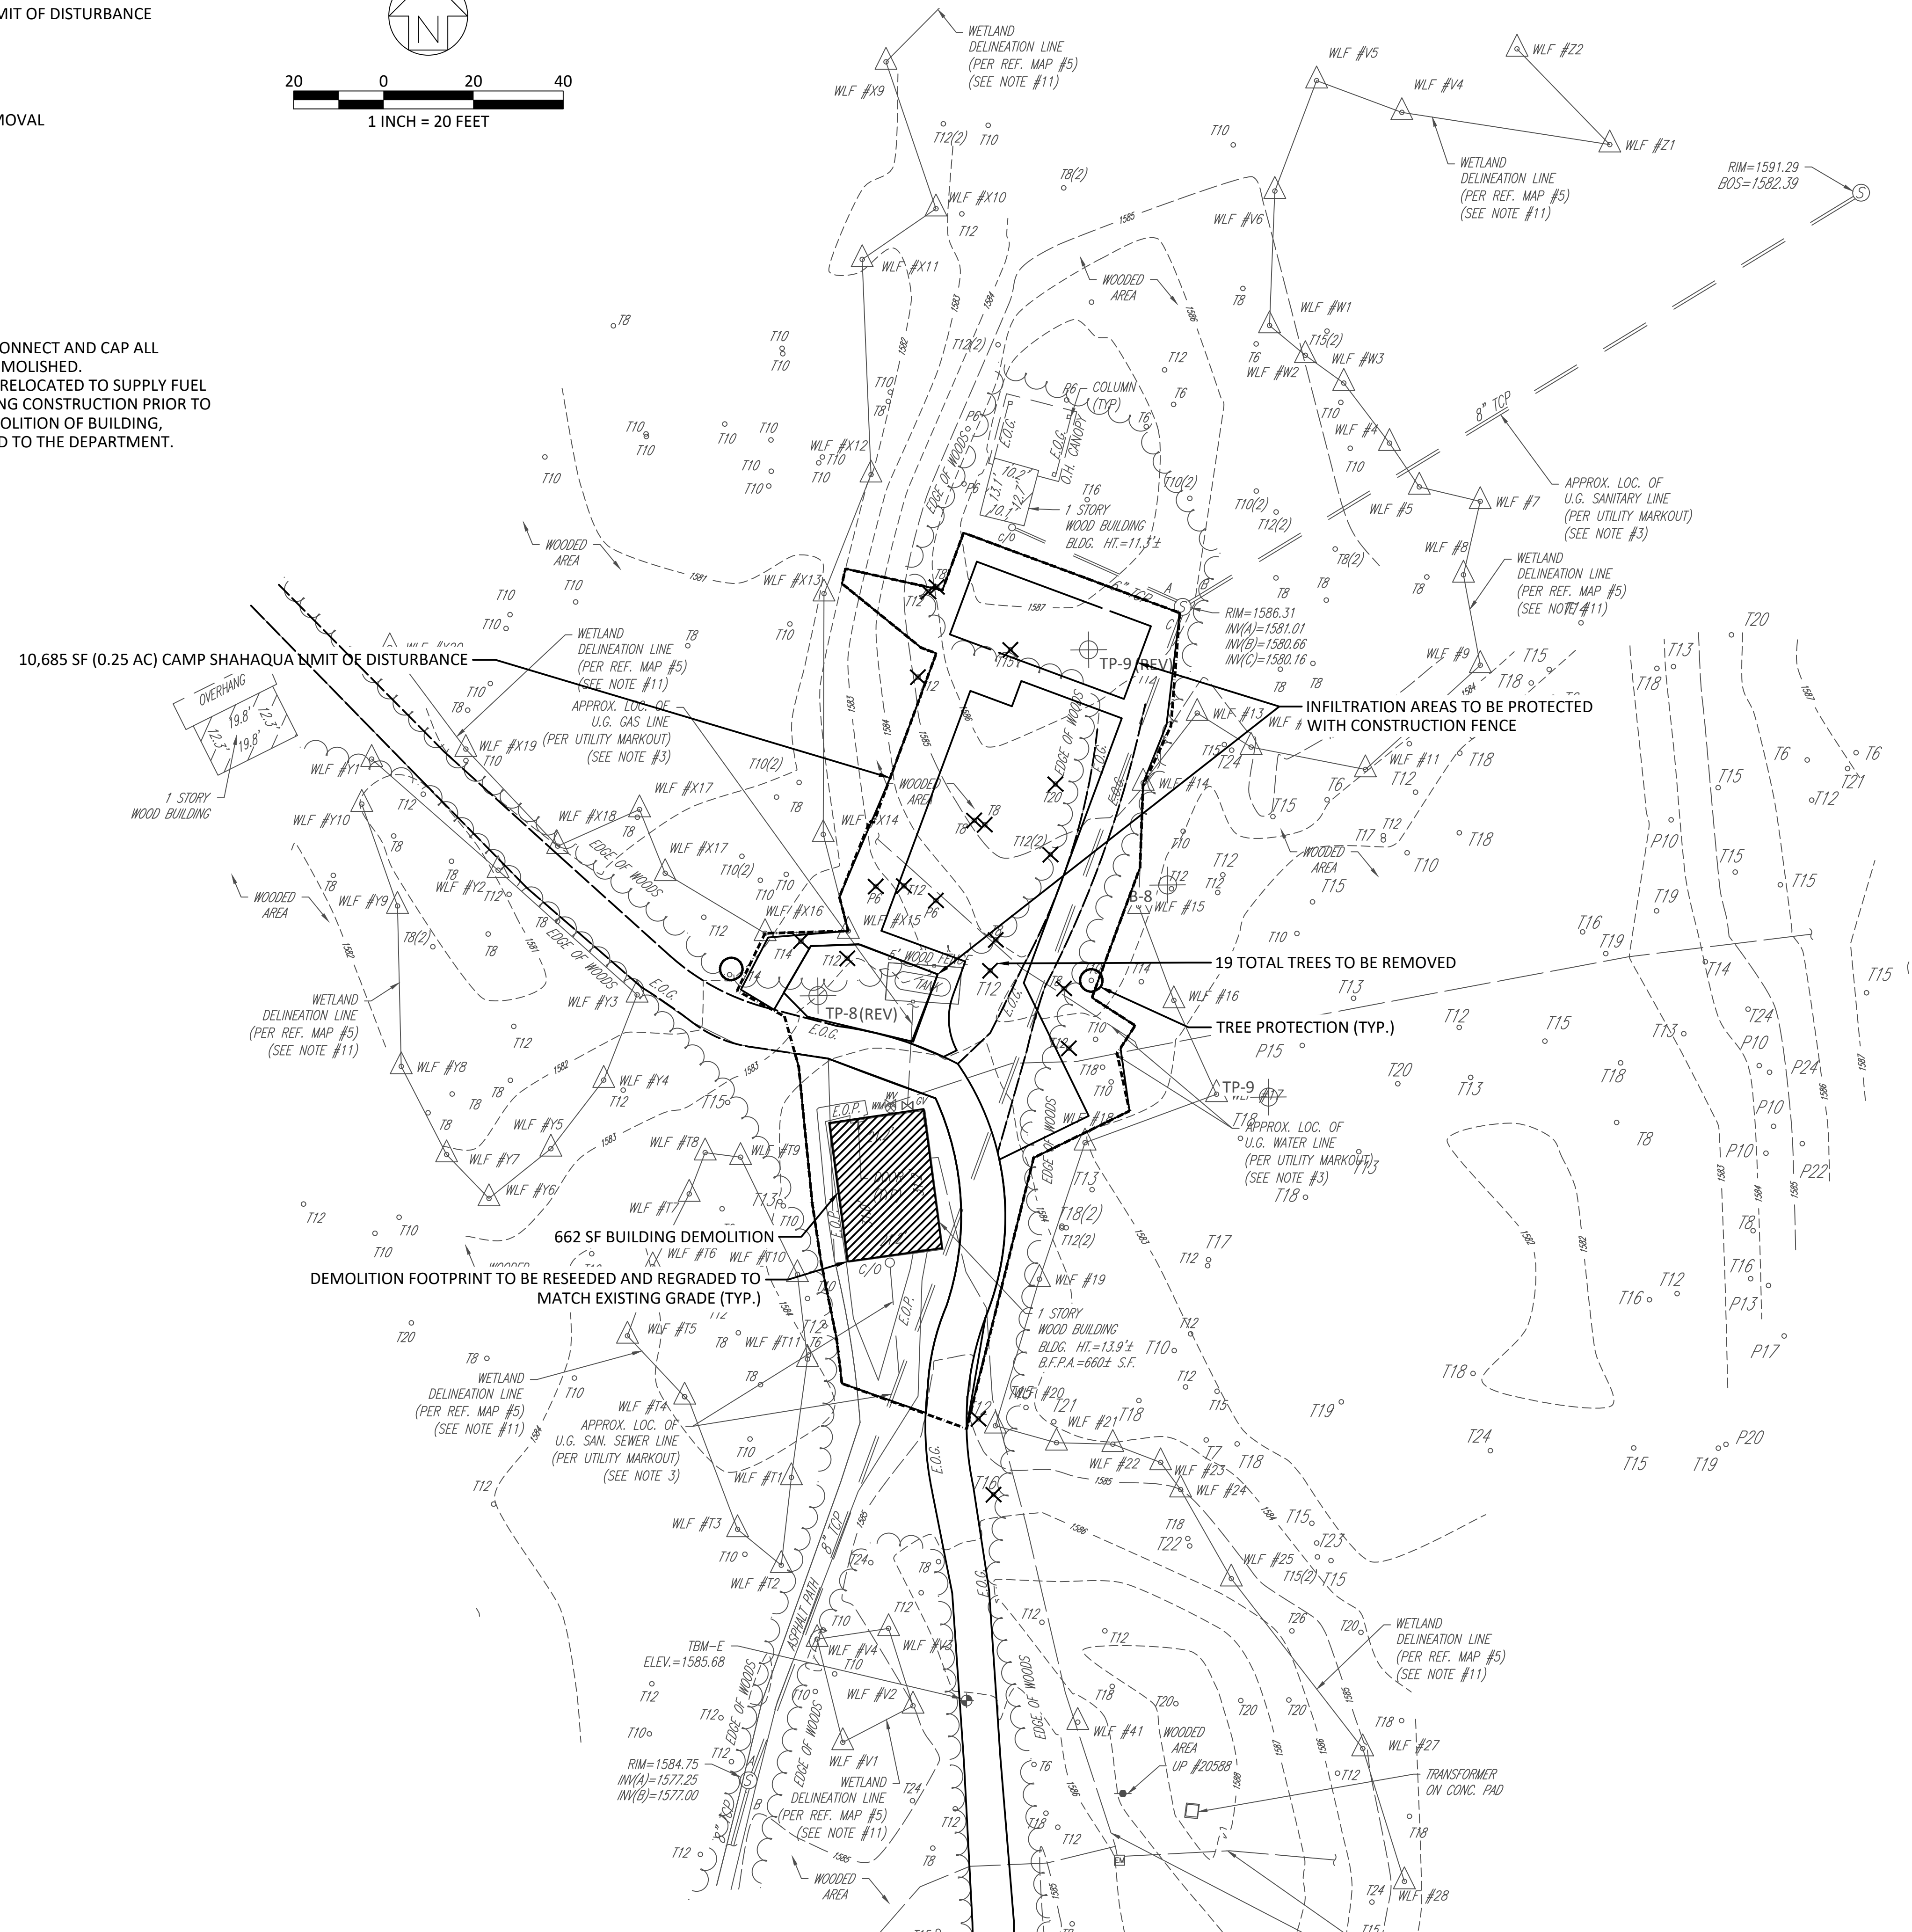

SITE LOCATION

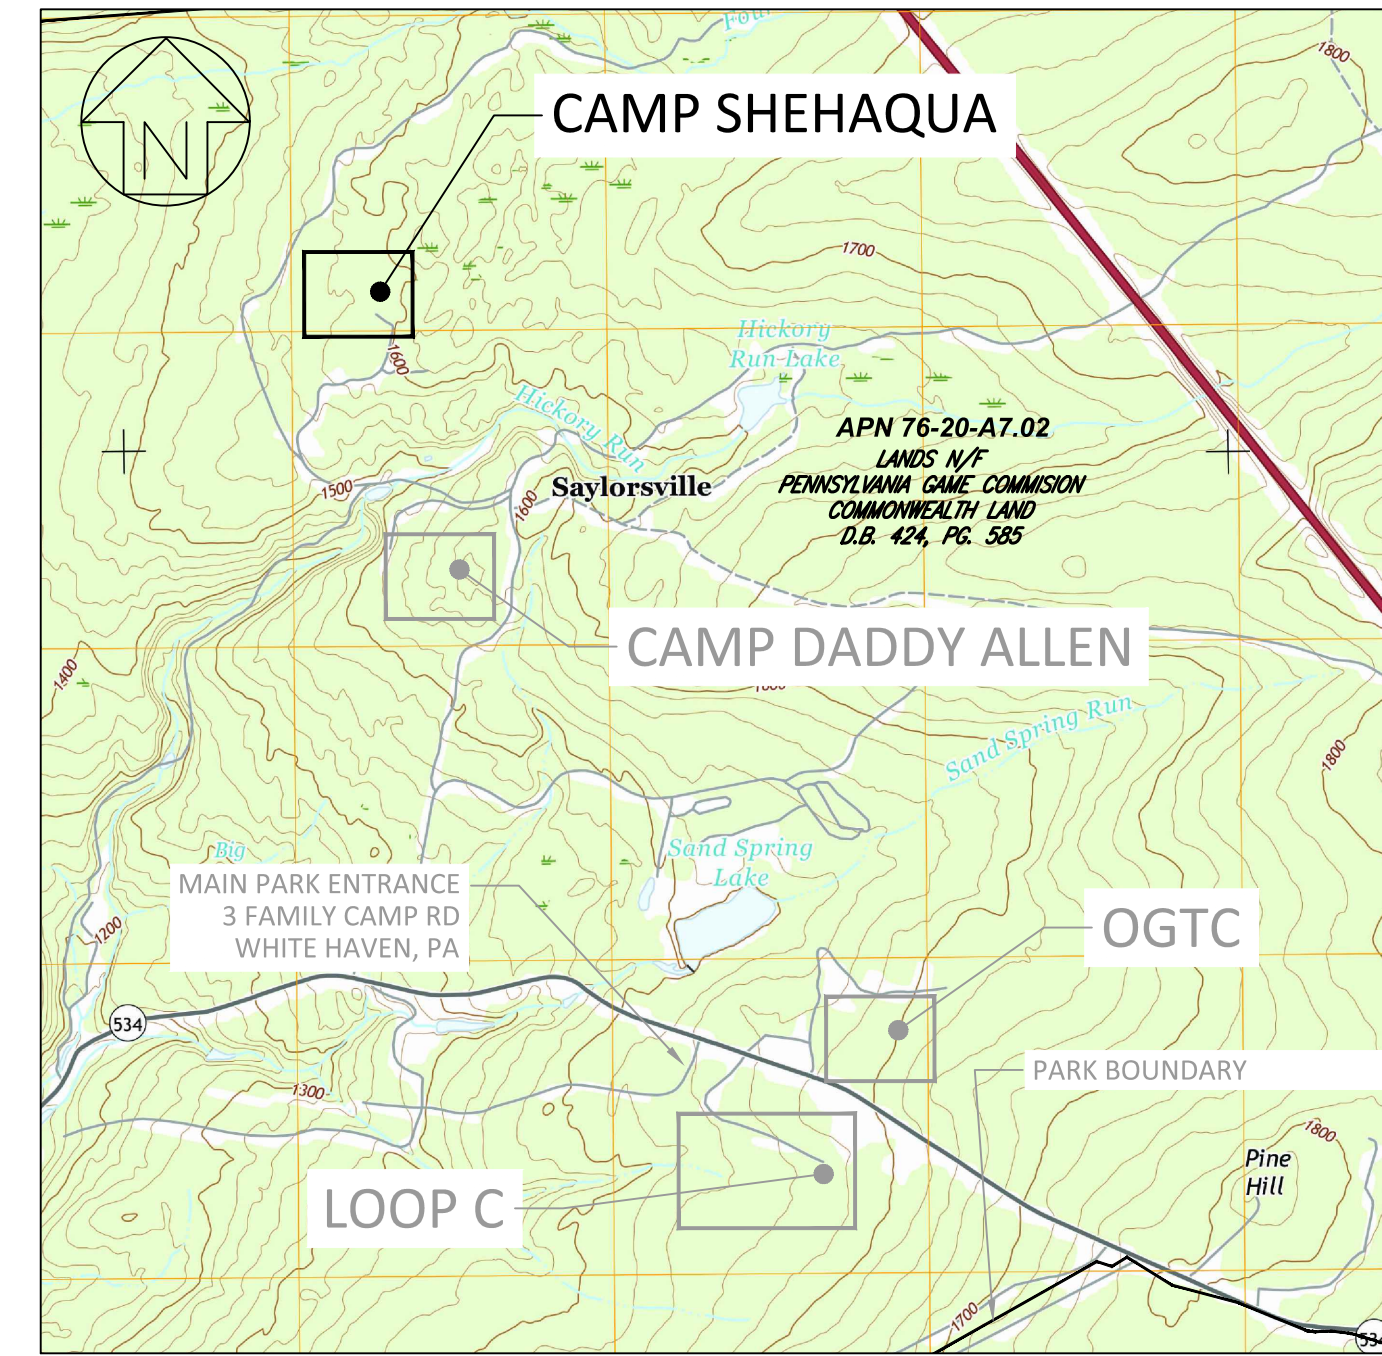

SCALE: 1" = 2000'

CONSTRUCTION DOCUMENTS



RECORD REVISIONS

06/15/22
SIGNATURE DATE

SMP ARCHITECTS
1600 WALNUT STREET, SECOND FLOOR
PHILADELPHIA, PENNSYLVANIA

COMMONWEALTH OF PENNSYLVANIA
DEPARTMENT OF GENERAL SERVICES
HARRISBURG, PENNSYLVANIA

D.G.S. PROJECT No.
C-114-0006 PHASE 1

HICKORY RUN STATE PARK
LATRINE IMPROVEMENTS
DEPT of CONSERVATION AND NATURAL RESOURCES
WHITE HAVEN, CARBON COUNTY, PA

VERIFY SCALE

BAR IS ONE (1) INCH LONG ON ORIGINAL DRAWING:



IF BAR IS NOT ONE (1) INCH LONG, ADJUST SCALE ACCORDINGLY

DEMOLITION PLAN - CAMP SHEHAQUA


CONTRACTOR SHALL FIELD VERIFY ALL DIMENSIONS. VARIANCE FROM CONTRACT DOCUMENTS NOT PERMITTED WITHOUT PROFESSIONAL & BUREAU OF CONSTRUCTION APPROVAL.	DRAWN BY L GILL	DATE 06/17/2022	DRAWING No. C-28
	CHECKED BY M HENDERSON	SCALE AS NOTED	

FILE PATH: I:\2020\20027 - Hickory Run State Park\CAD\Sheet Files\20027 - DEMOLITION PLAN.dwg PLOTTED BY: Laura E. Gill
LAST SAVED: 2022.05.05 10:23 AM PLOTTED: 2022.06.17 04:09 PM LAYOUT TAB: DEMOLITION PLAN - CAMP SHEHAQUA

- LEGEND**
- PROJECT BOUNDARY/LIMIT OF DISTURBANCE
 - PROPOSED BUILDING
 - 1519 CONTOUR
 - STORM PIPE
 - INFILTRATION BED
 - RAIN GARDEN
 - SOIL TEST PIT (TP) OR BORING (B) LOCATION
 - FLARED END SECTION
 - SPLASH BLOCK
 - OBSERVATION WELL

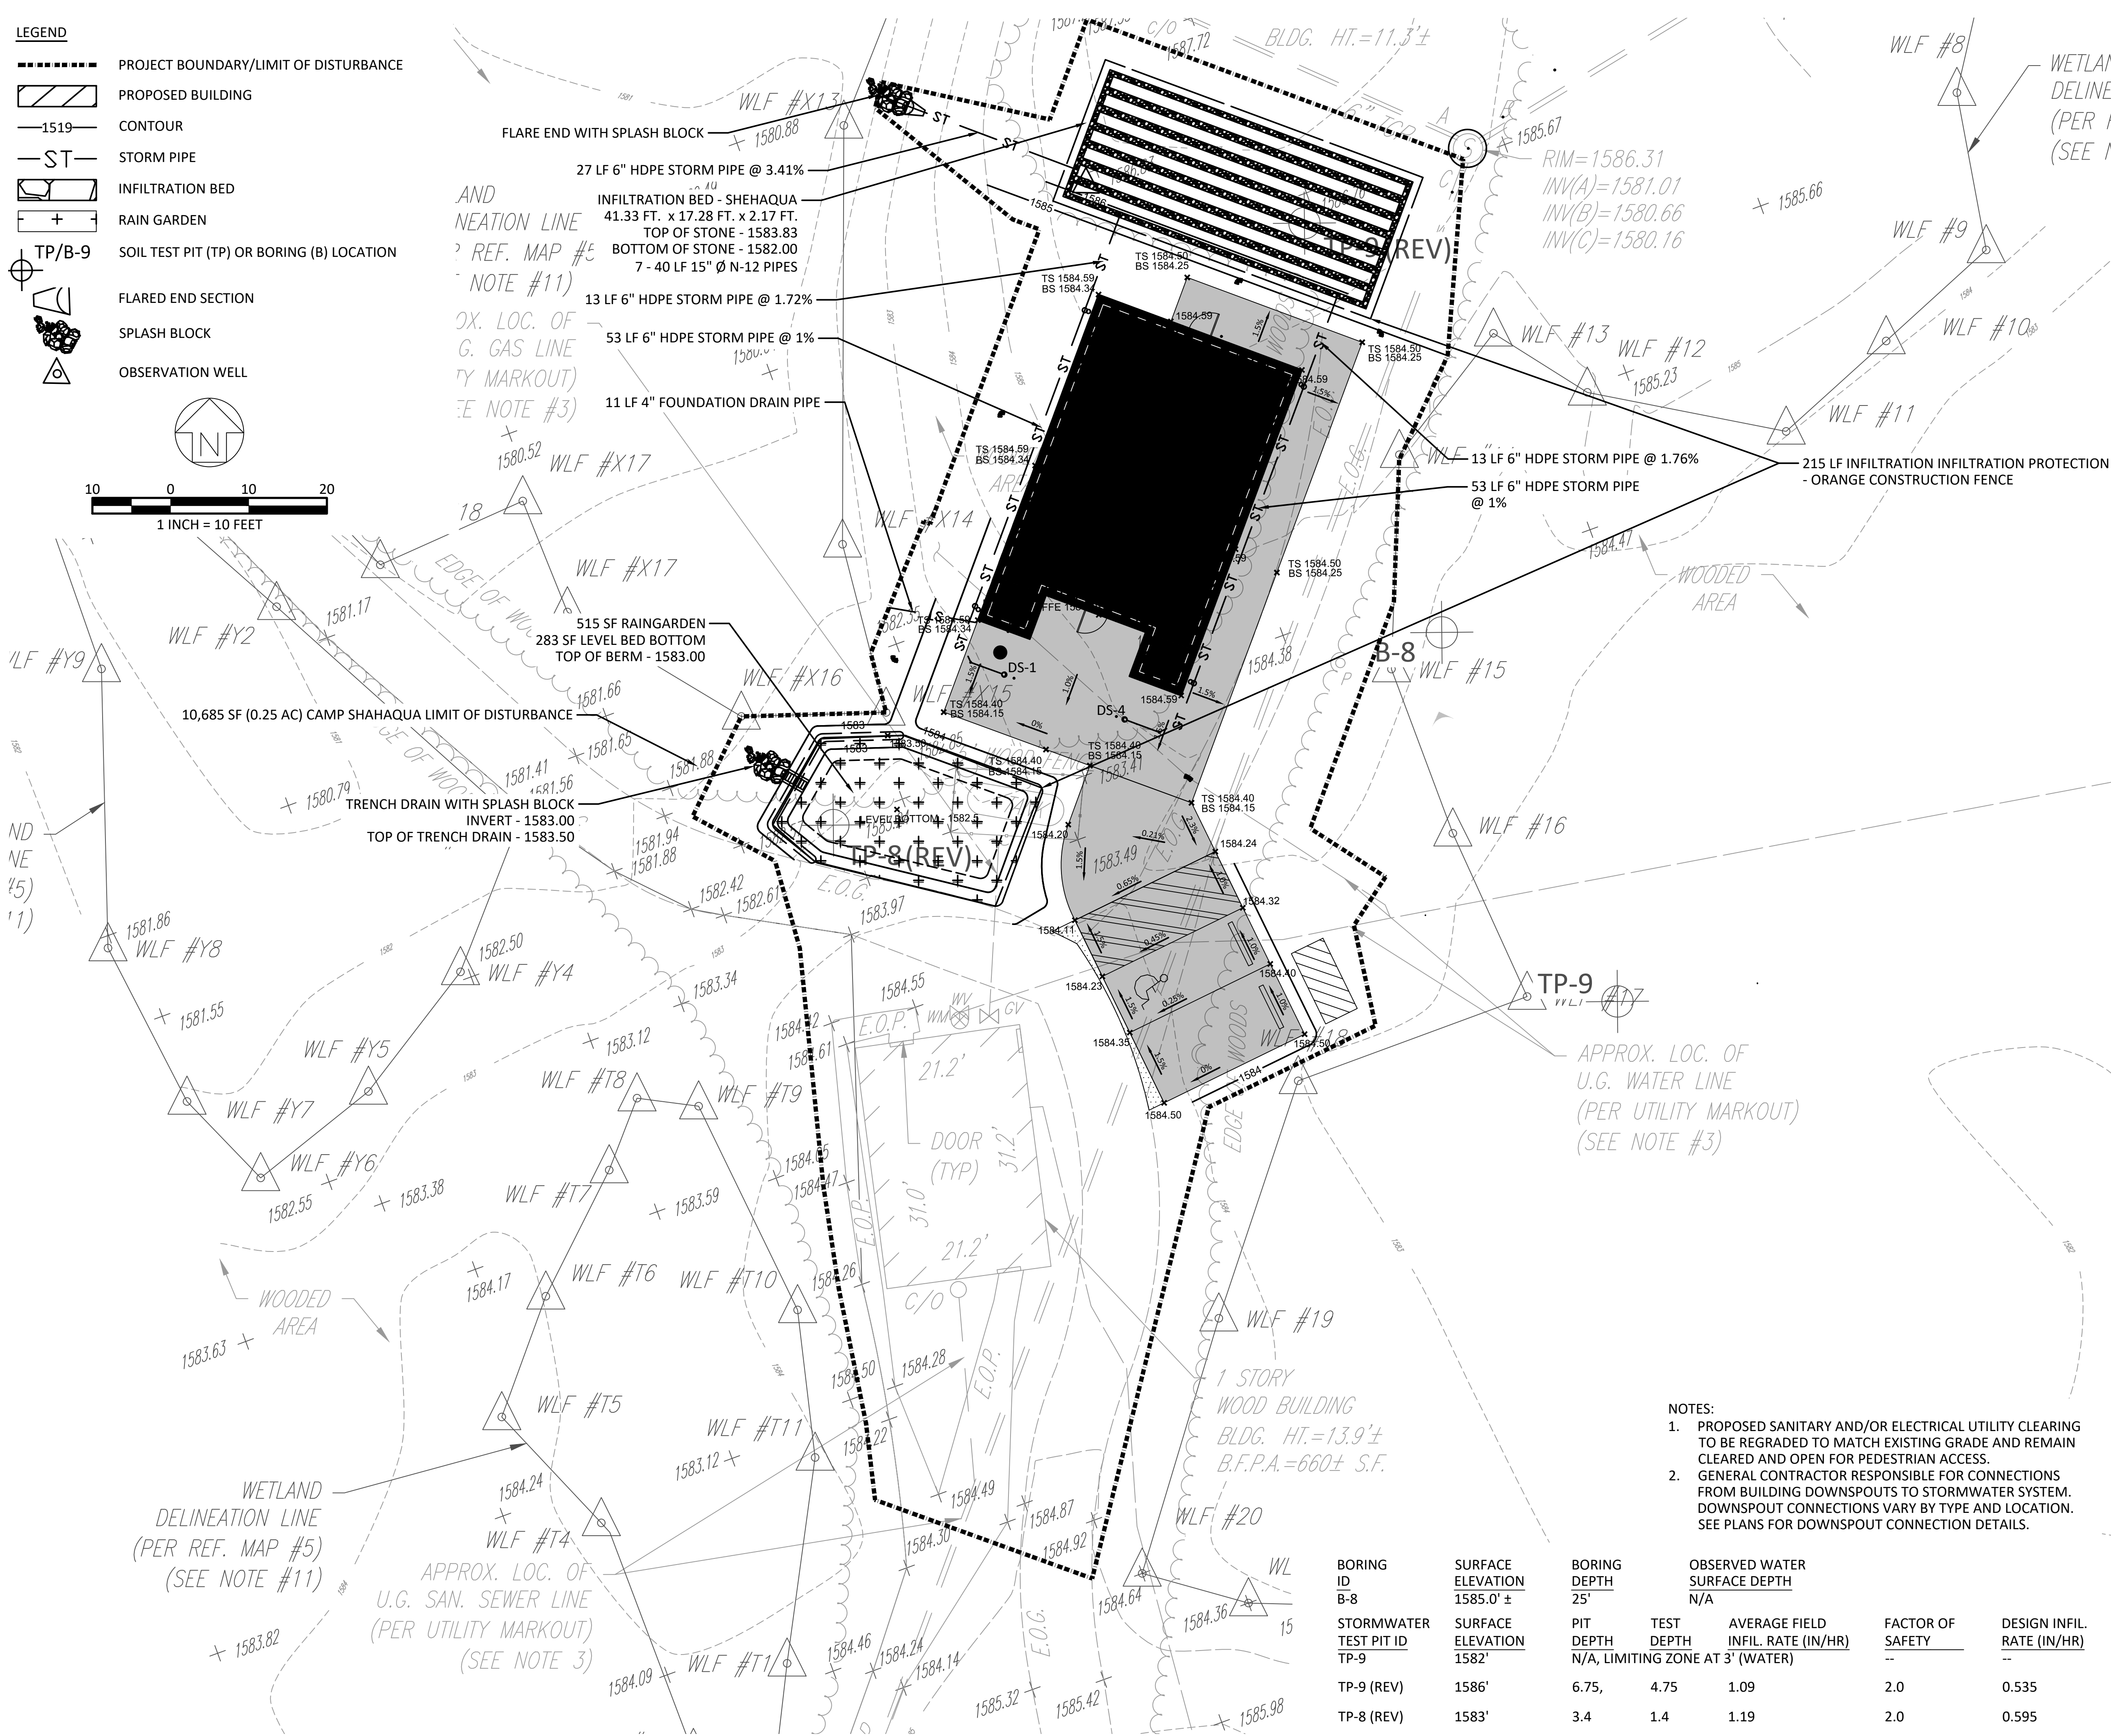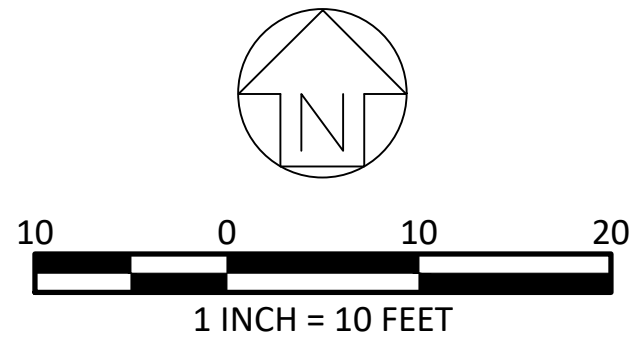

SITE LOCATION

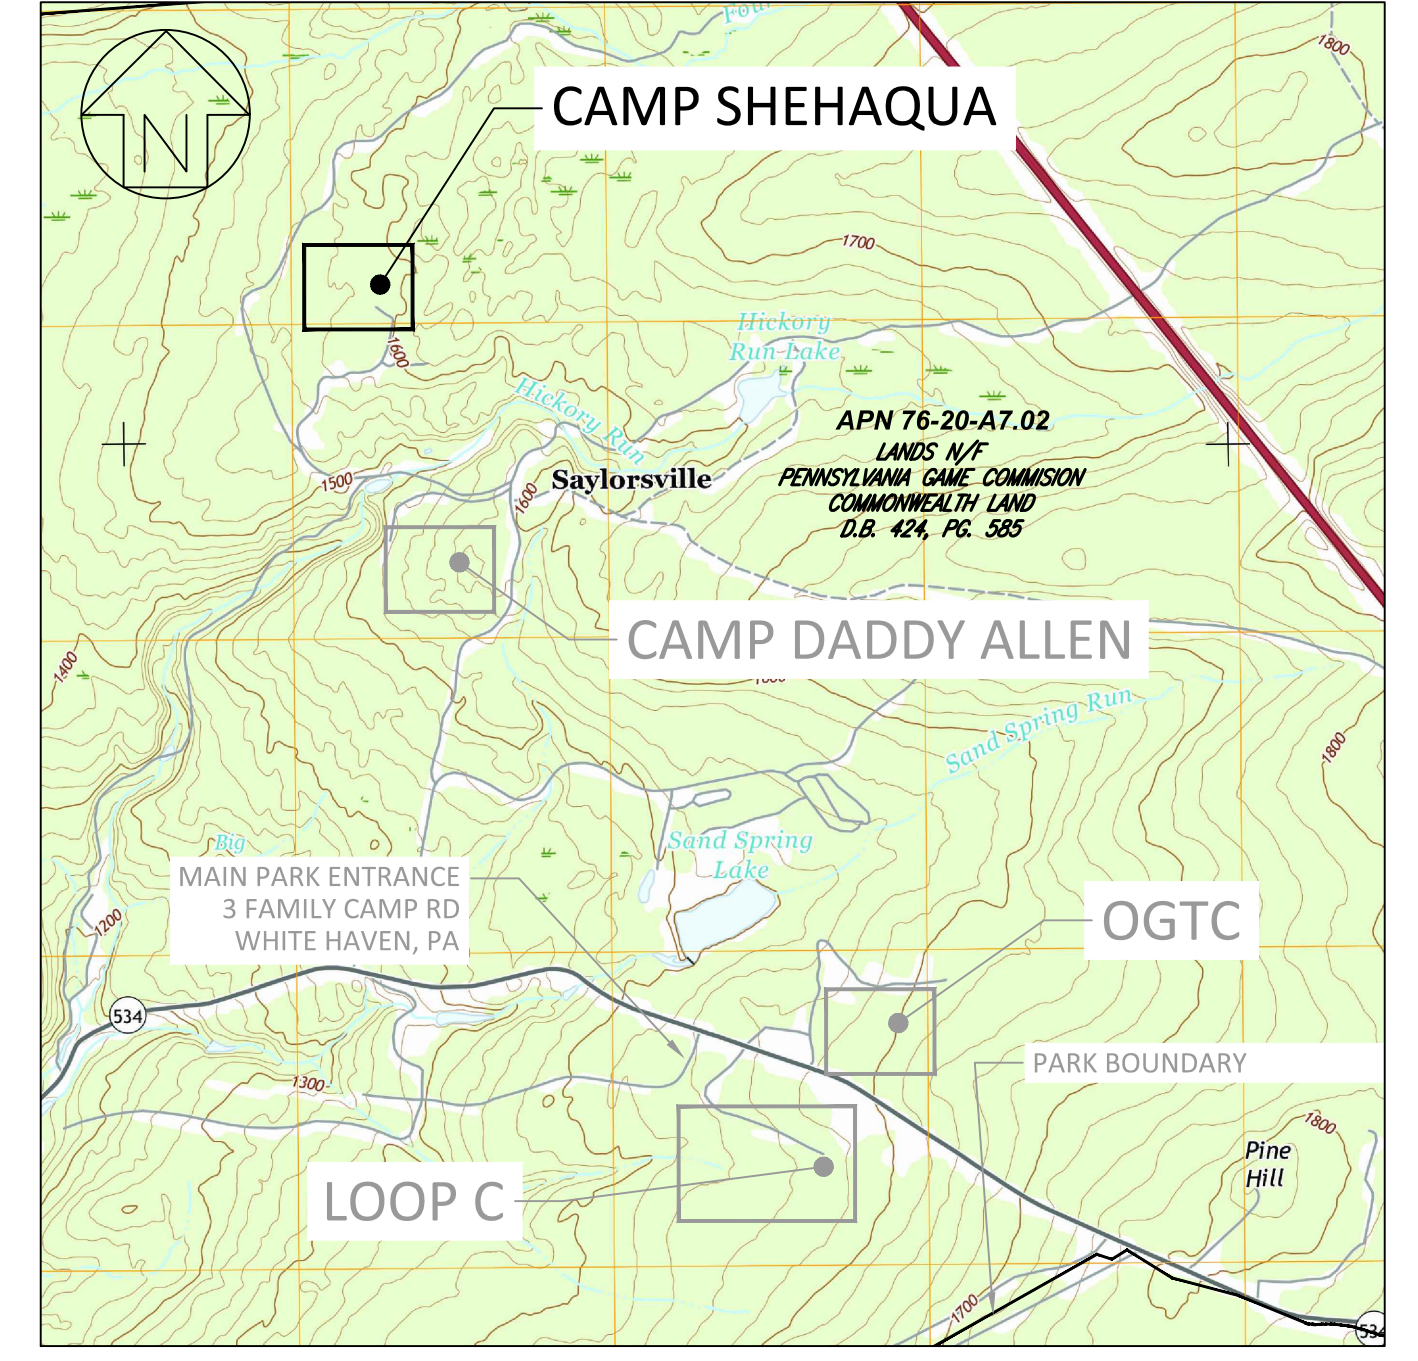

PA ONE CALL SERIAL NUMBER - 20202343070

ALL LOCATIONS OF EXISTING UTILITIES SHOWN ON THIS PLAN HAVE BEEN DEVELOPED FROM EXISTING UTILITY RECORDS AND/OR ABOVE GROUND EXAMINATION OF THE SITE. COMPLETENESS OR ACCURACY OF LOCATION AND DEPTH OF UNDERGROUND UTILITIES OR STRUCTURES CANNOT BE GUARANTEED. CONTRACTOR MUST VERIFY LOCATION AND DEPTH OF ALL UNDERGROUND UTILITIES AND FACILITIES BEFORE START OF WORK PER PENNSYLVANIA ACT 287 OF 1974 AS AMENDED BY ACT 199 OF 2004 OR LATER.

CONSTRUCTION DOCUMENTS

meliora

259 MORGAN STREET, PHOENIXVILLE, PA 19460
(610) 933-0123
melioradesign.com

RECORD REVISIONS

SIGNATURE: *Marc B. Henderson* DATE: 06/15/22

SMP ARCHITECTS
1600 WALNUT STREET, SECOND FLOOR
PHILADELPHIA, PENNSYLVANIA

COMMONWEALTH OF PENNSYLVANIA
DEPARTMENT OF GENERAL SERVICES
HARRISBURG, PENNSYLVANIA

D.G.S. PROJECT No. C-114-0006 PHASE 1

HICKORY RUN STATE PARK
LATRINE IMPROVEMENTS
DEPT of CONSERVATION AND NATURAL RESOURCES
WHITE HAVEN, CARBON COUNTY, PA

STORMWATER AND GRADING PLAN -
CAMP SHEHAQUA

CONTRACTOR SHALL FIELD VERIFY ALL DIMENSIONS. VARIANCE FROM CONTRACT DOCUMENTS NOT PERMITTED WITHOUT PROFESSIONAL & BUREAU OF CONSTRUCTION APPROVAL.

DRAWN BY: L GILL
CHECKED BY: M HENDERSON

DATE: 06/17/2022
SCALE: AS NOTED

DRAWING No. C-29

42 OF 144

- NOTES:**
- PROPOSED SANITARY AND/OR ELECTRICAL UTILITY CLEARING TO BE REGRADED TO MATCH EXISTING GRADE AND REMAIN CLEARED AND OPEN FOR PEDESTRIAN ACCESS.
 - GENERAL CONTRACTOR RESPONSIBLE FOR CONNECTIONS FROM BUILDING DOWNSPOUTS TO STORMWATER SYSTEM. DOWNSPOUT CONNECTIONS VARY BY TYPE AND LOCATION. SEE PLANS FOR DOWNSPOUT CONNECTION DETAILS.

BORING ID	SURFACE ELEVATION	BORING DEPTH	OBSERVED WATER SURFACE DEPTH			FACTOR OF SAFETY	DESIGN INFIL. RATE (IN/HR)
STORMWATER TEST PIT ID	SURFACE ELEVATION	PIT DEPTH	TEST DEPTH	AVERAGE FIELD INFIL. RATE (IN/HR)			
B-8	1585.0'±	25'	N/A	N/A			
TP-9	1582'	N/A, LIMITING ZONE AT 3' (WATER)					
TP-9 (REV)	1586'	6.75,	4.75	1.09	2.0	0.535	
TP-8 (REV)	1583'	3.4	1.4	1.19	2.0	0.595	


VERIFY SCALE

BAR IS ONE (1) INCH LONG ON ORIGINAL DRAWING:

IF BAR IS NOT ONE (1) INCH LONG, ADJUST SCALE ACCORDINGLY

FILE PATH: I:\2020\20027 - Hickory Run State Park\CD\sheet files\20027 - STORMWATER AND GRADING PLAN - CAMP SHEHAQUA LAYOUT TAB: STORMWATER AND GRADING PLAN - CAMP SHEHAQUA PLOTTED BY: Laura L. Gill

- LEGEND**
- PROJECT BOUNDARY/LIMIT OF DISTURBANCE
 - ▒ PROPOSED CONCRETE
 - ▒ PROPOSED DRIVING SURFACE AGGREGATE
 - ▒ PROPOSED LANDSCAPE RESTORATION

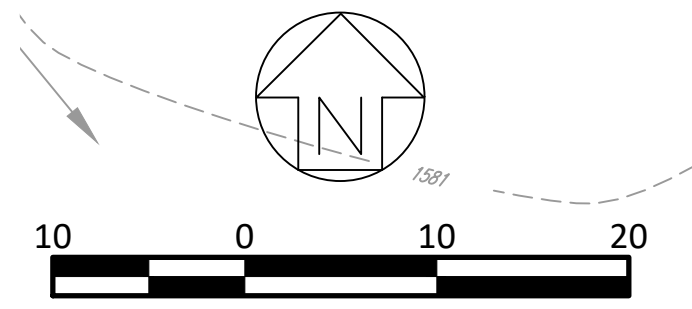

VEGETATION LINE
REF. MAP #5)
NOTE #11)

APPROX. LOC. OF
U.G. GAS LINE
(PER UTILITY MARKOUT)
(SEE NOTE #3)


4,154 SF ERNST PARTIAL SHADED ROADSIDE MIX
VEHICULAR SLAB
SEE STRUCTURAL PLANS FOR DETAILS
2,060 SF ERNST PARTIAL SHADED ROADSIDE MIX

GENERAL CONTRACTOR TO RESTORE DRIVING SURFACE
AGGREGATE WHERE CONSTRUCTION HAS IMPACTED THE SURFACE


26 SF DRIVING SURFACE AGGREGATE (DSA)

APPROX. LOC. OF
U.G. SAN. SEWER LINE
(PER UTILITY MARKOUT)
(SEE NOTE 3)

WETLAND
DELINEATION LINE
(PER REF. MAP #5)
(SEE NOTE #11)

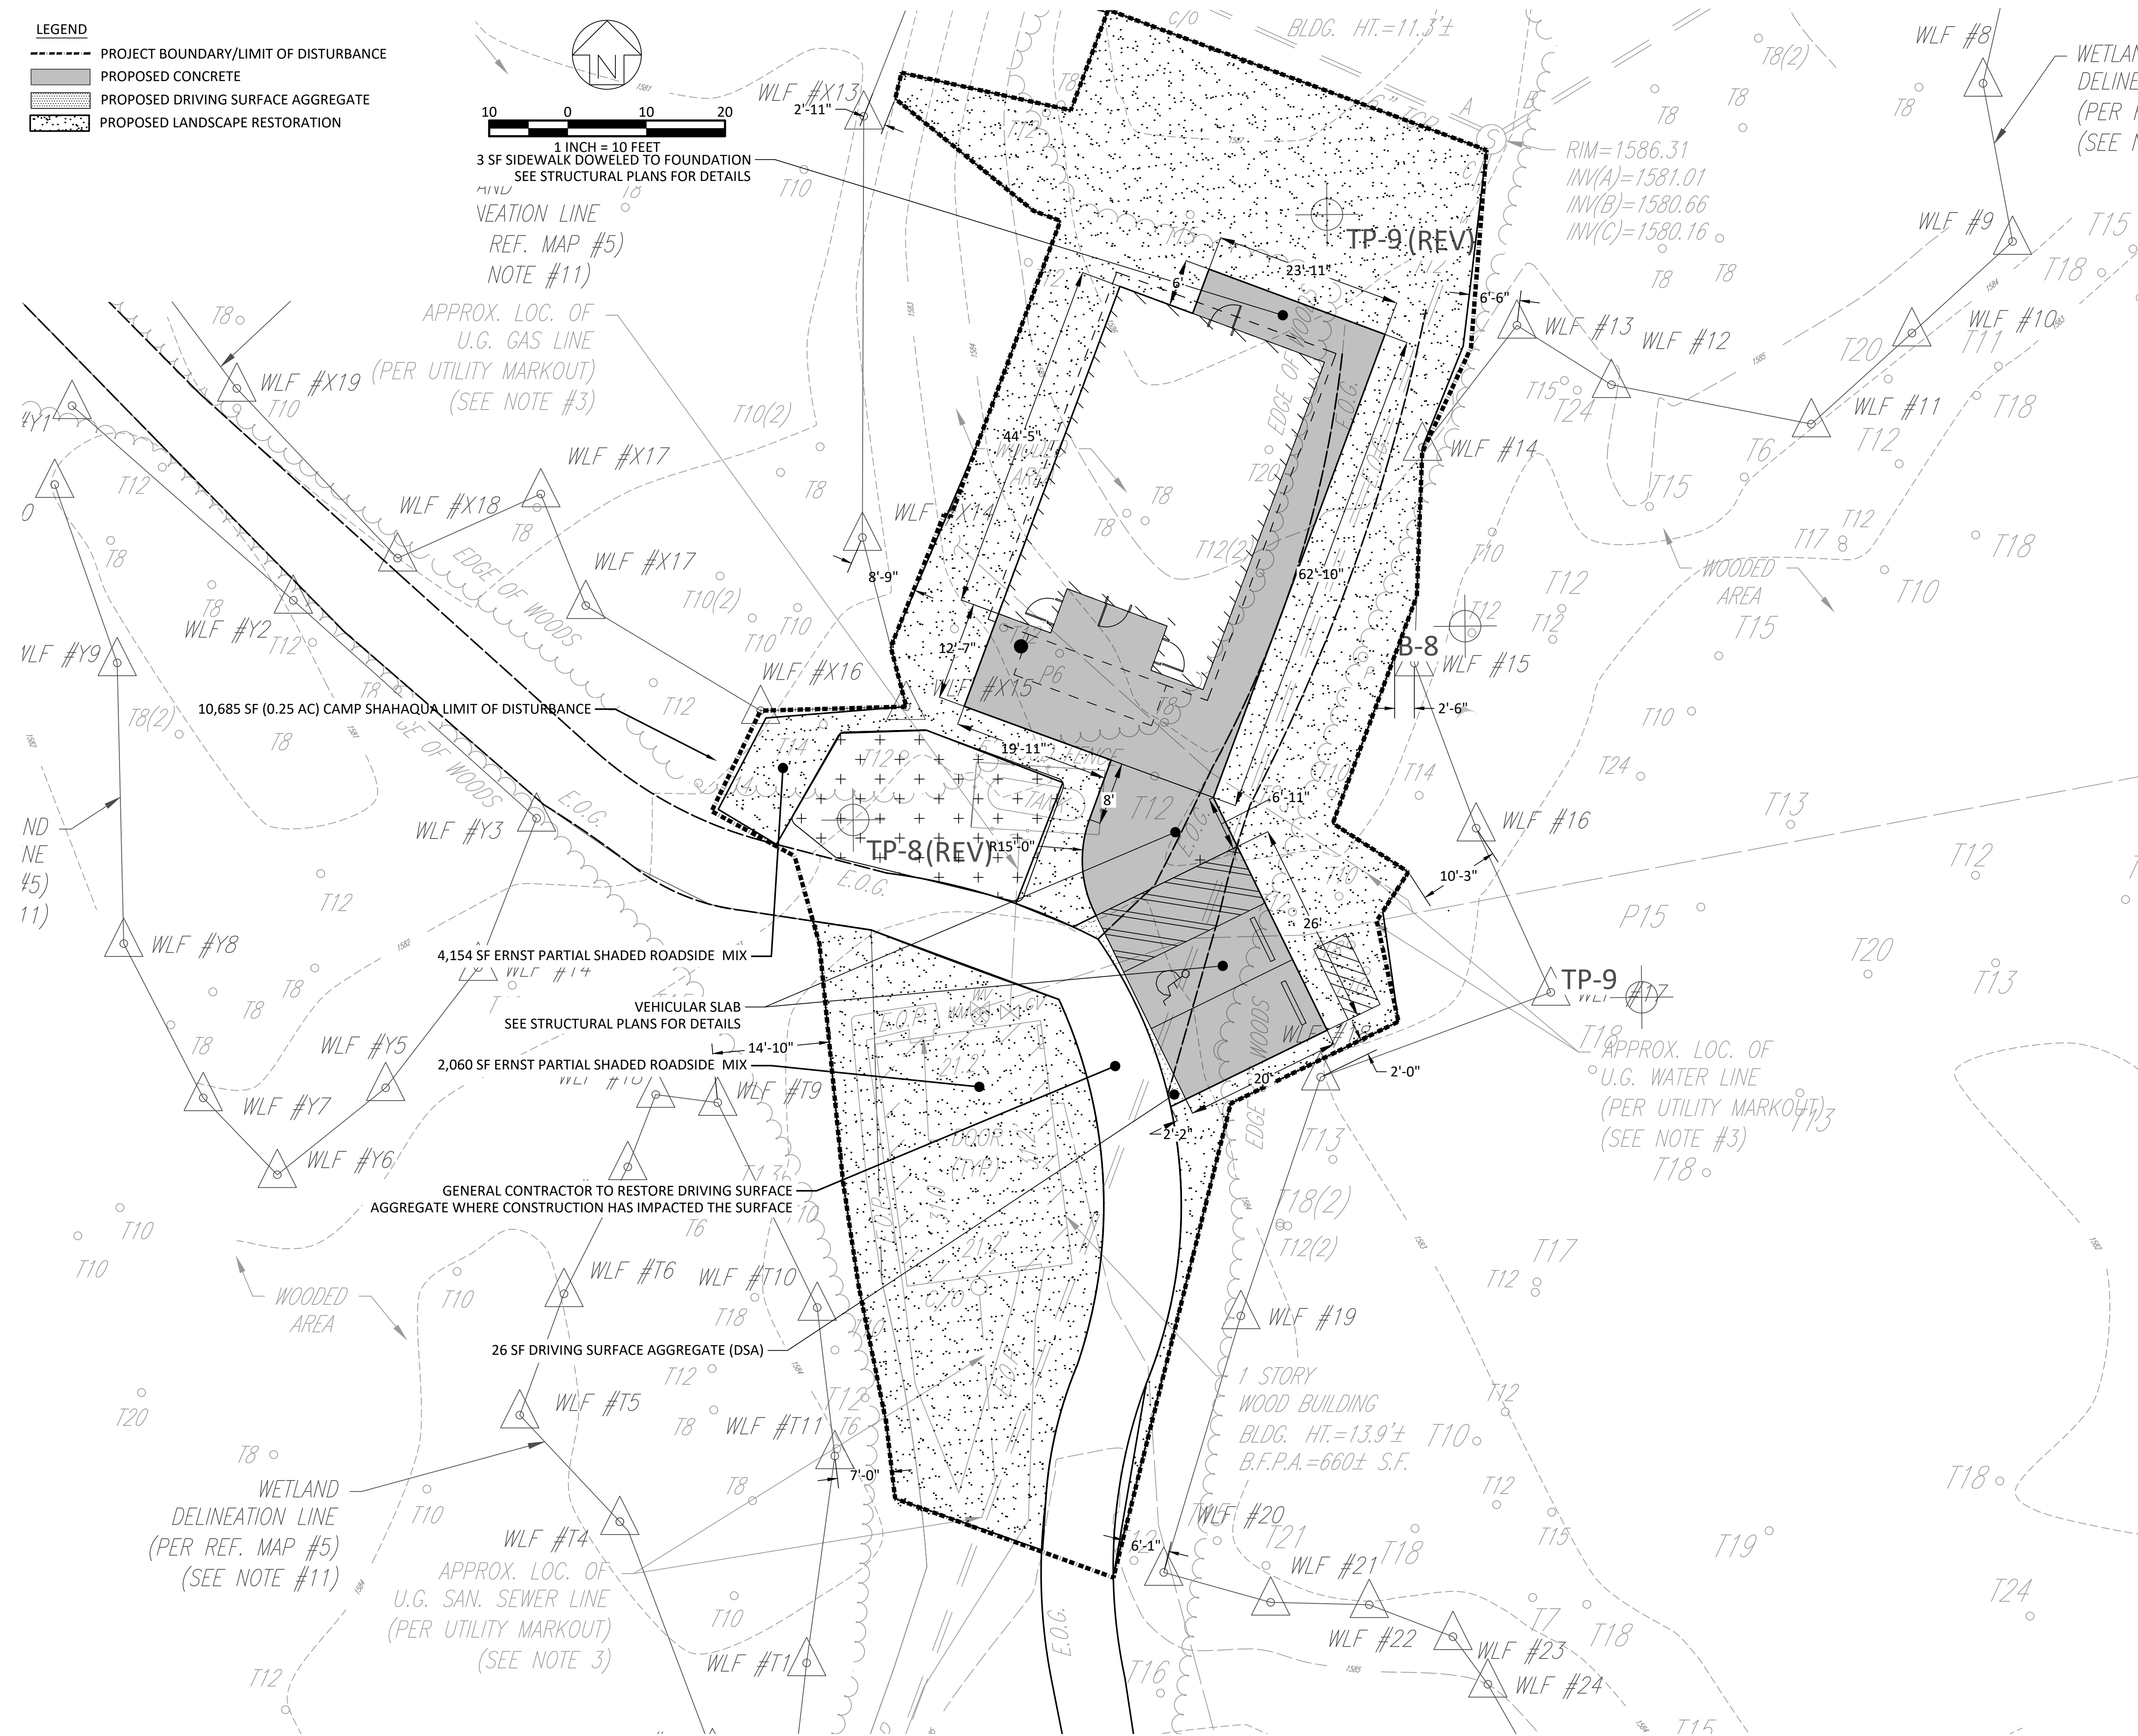

SITE LOCATION

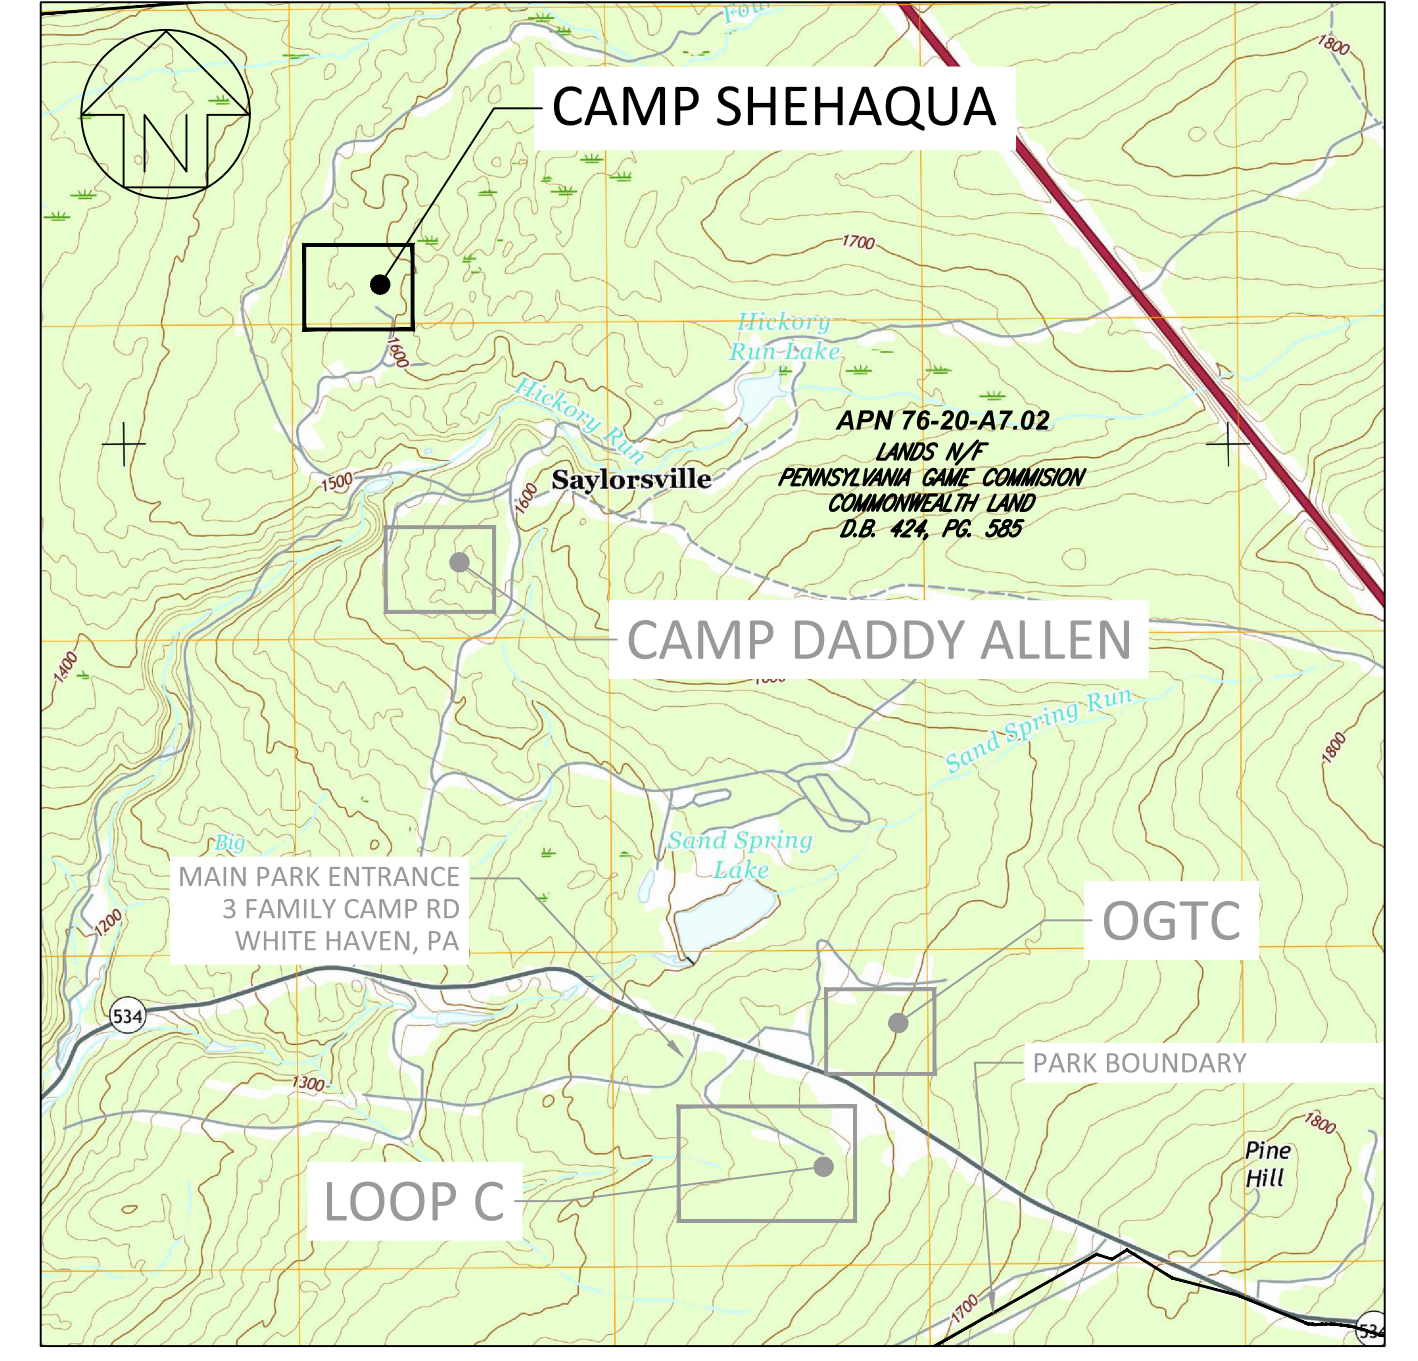

SCALE: 1" = 2000'

CONSTRUCTION DOCUMENTS



RECORD REVISIONS

SIGNATURE: *Marc B. Henderson* DATE: 06/15/22

SMP ARCHITECTS
1600 WALNUT STREET, SECOND FLOOR
PHILADELPHIA, PENNSYLVANIA

COMMONWEALTH OF PENNSYLVANIA
DEPARTMENT OF GENERAL SERVICES
HARRISBURG, PENNSYLVANIA

D.G.S. PROJECT No. C-114-0006 PHASE 1

HICKORY RUN STATE PARK
LATRINE IMPROVEMENTS
DEPT of CONSERVATION AND NATURAL RESOURCES
WHITE HAVEN, CARBON COUNTY, PA

SITE PLAN - CAMP SHEHAQUA

VERIFY SCALE

BAR IS ONE (1) INCH LONG
ON ORIGINAL DRAWING.



IF BAR IS NOT ONE (1) INCH LONG,
ADJUST SCALE ACCORDINGLY

CONTRACTOR SHALL FIELD VERIFY
ALL DIMENSIONS.
VARIANCE FROM CONTRACT
DOCUMENTS NOT PERMITTED
WITHOUT PROFESSIONAL & BUREAU
OF CONSTRUCTION APPROVAL.

DRAWN BY L GILL	DATE 06/17/2022	DRAWING No. C-30
CHECKED BY M HENDERSON	SCALE AS NOTED	43 OF 144

FILE PATH: I:\2020\20027 - Hickory Run State Park\CAD\Sheet Files\20027 - LANDSCAPE PLAN.dwg
LAST SAVED: 2022.05.05 11:02 AM PLOTTED: 2022.06.17 04:13 PM PLOTTED BY: Laura L. Gill LAYOUT TAB: SITE PLAN - CAMP SHEHAQUA


- LEGEND**
- PROJECT BOUNDARY/LIMIT OF DISTURBANCE
 - ▒ PROPOSED CONCRETE
 - ▒ PROPOSED DRIVING SURFACE AGGREGATE
 - ⊙ SEWER MANHOLE
 - SEWER CLEANOUT
 - - - PROPOSED WATER LINE
 - - - PROPOSED SANITARY SEWER LINE
 - - - PROPOSED ELECTRIC LINE
 - ST STORM PIPE

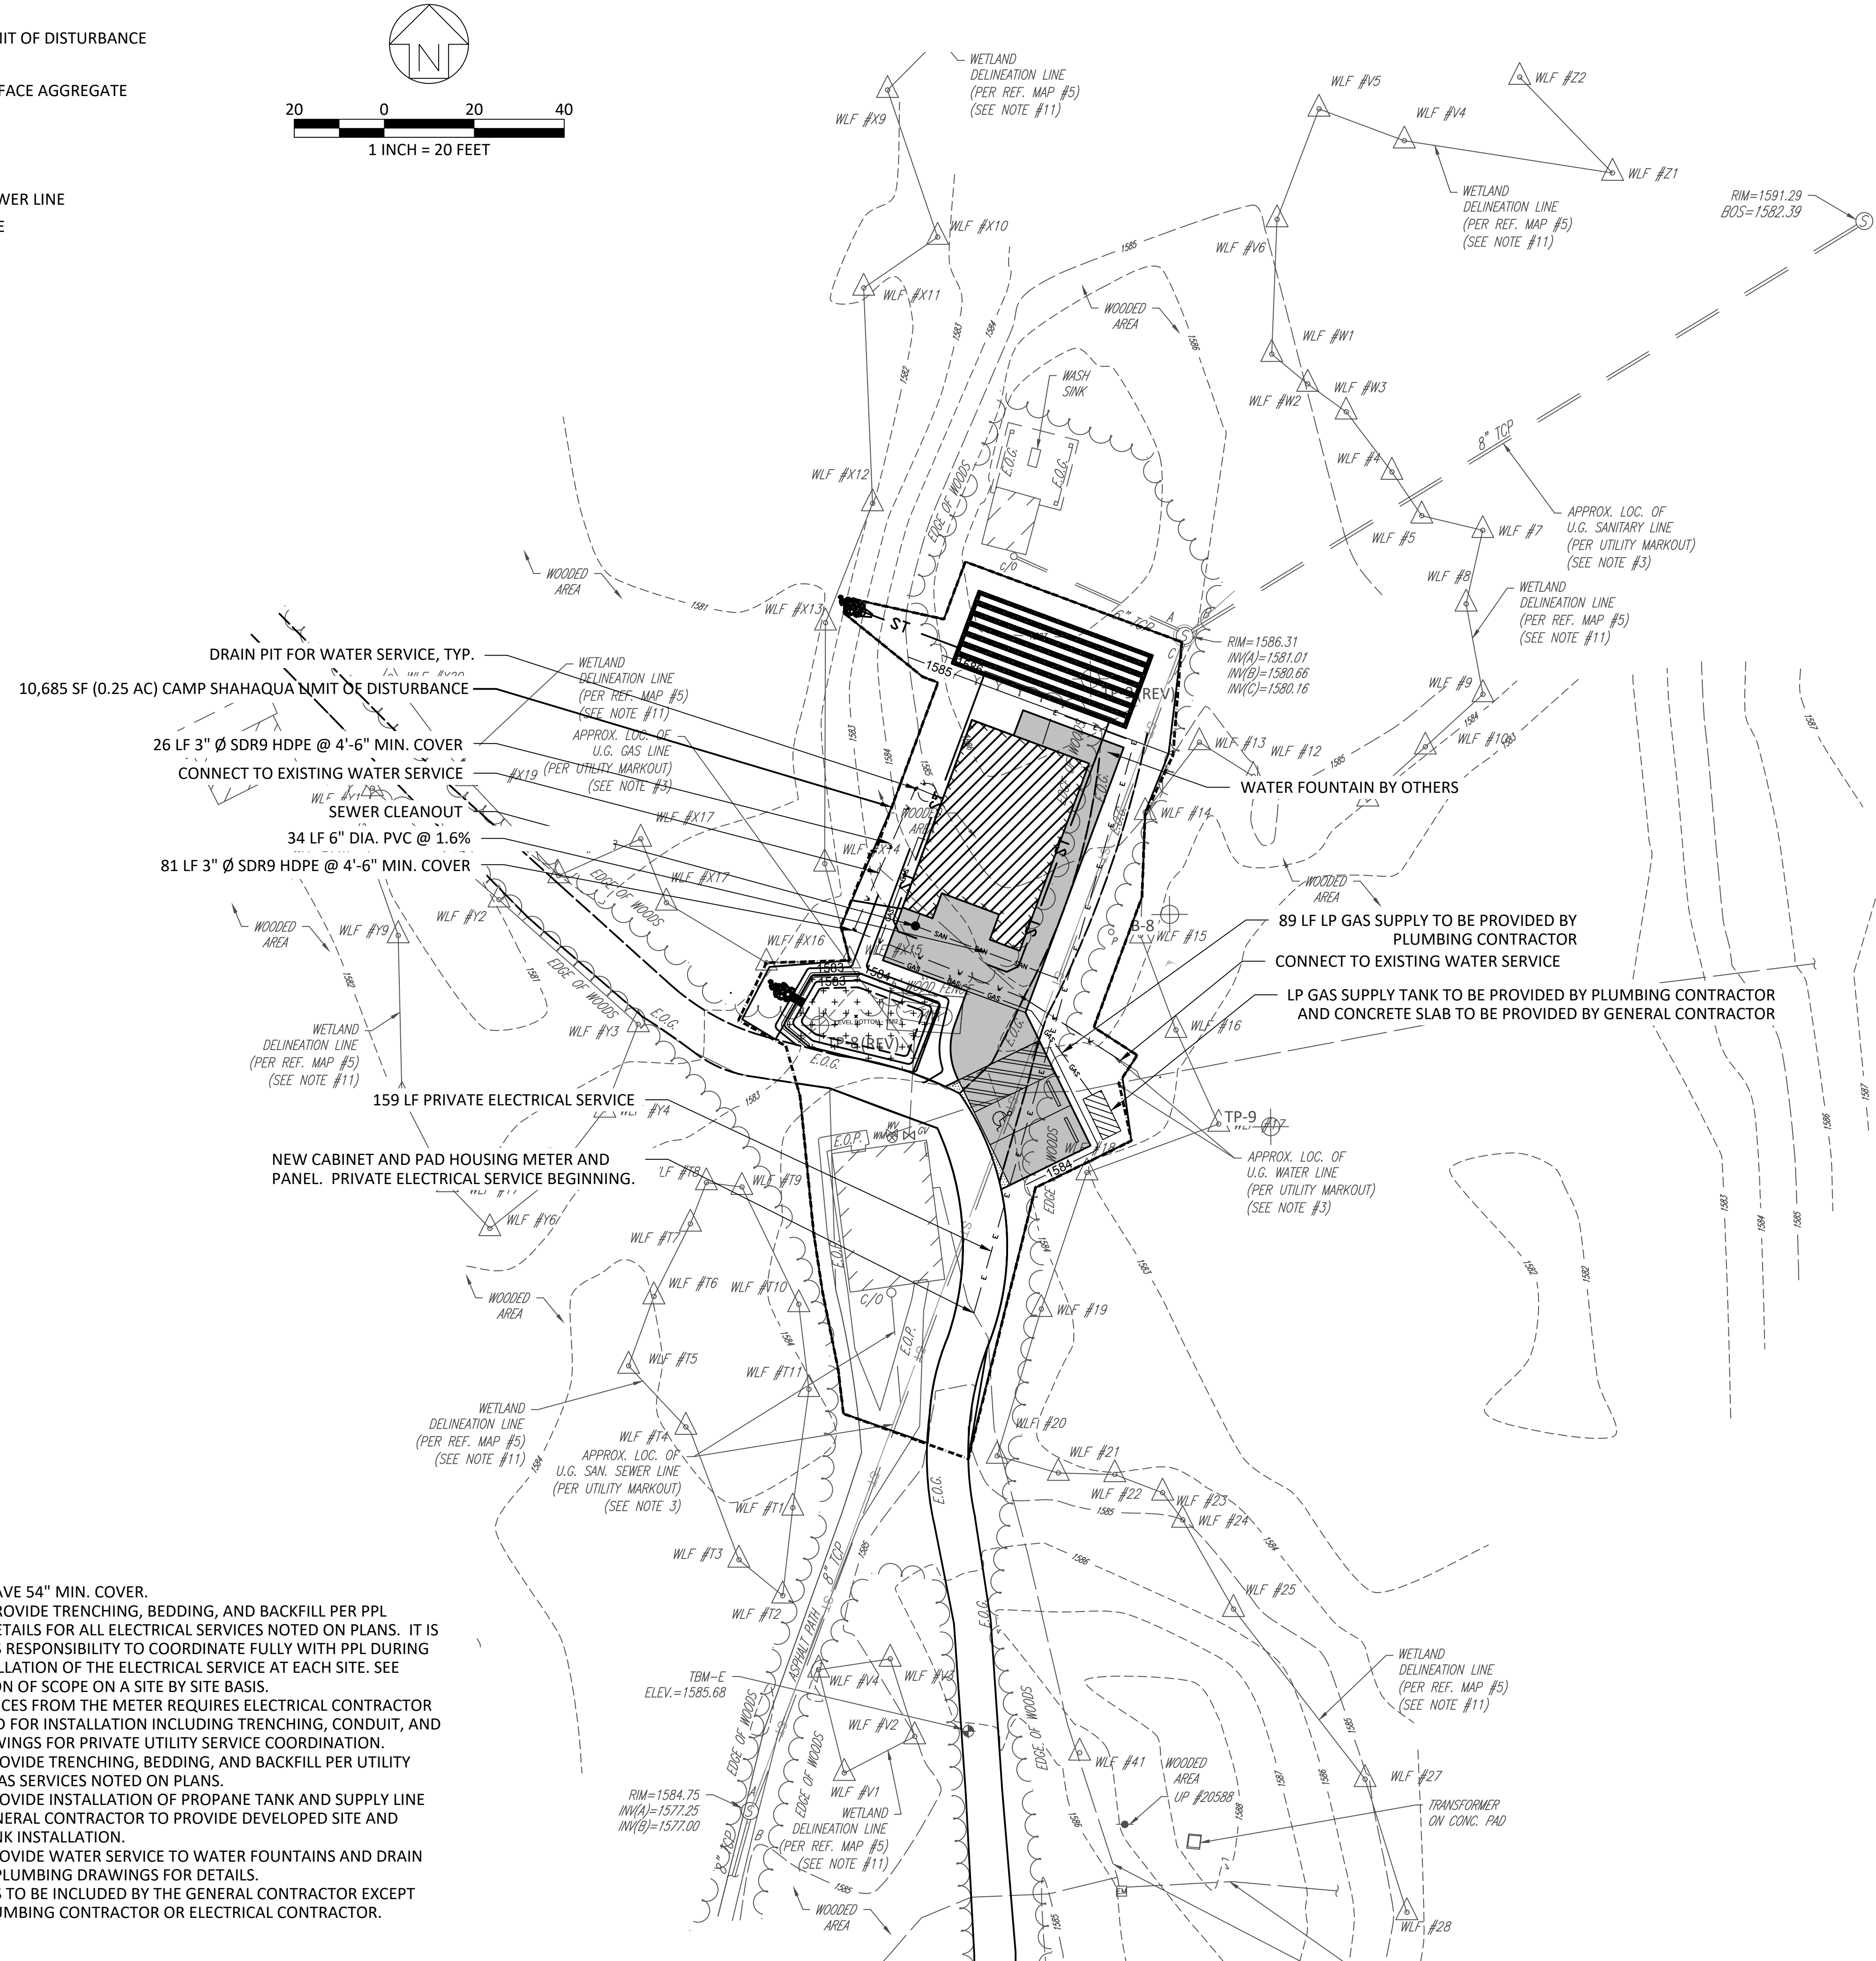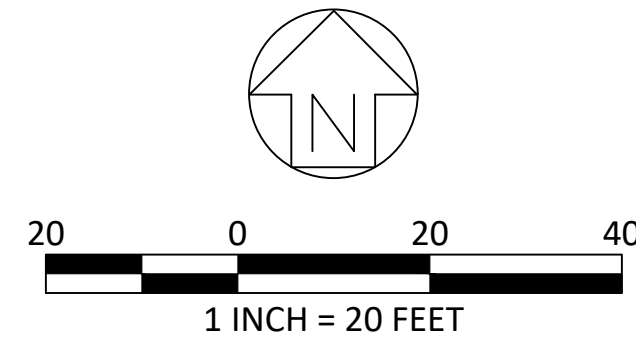

Notes

1. ALL NEW WATER SERVICE TO HAVE 54" MIN. COVER.
2. ELECTRICAL CONTRACTOR TO PROVIDE TRENCHING, BEDDING, AND BACKFILL PER PPL SPECIFICATIONS AND UTILITY DETAILS FOR ALL ELECTRICAL SERVICES NOTED ON PLANS. IT IS THE ELECTRICAL CONTRACTOR'S RESPONSIBILITY TO COORDINATE FULLY WITH PPL DURING CONSTRUCTION FOR THE INSTALLATION OF THE ELECTRICAL SERVICE AT EACH SITE. SEE NOTES FOR EXTRA CLARIFICATION OF SCOPE ON A SITE BY SITE BASIS.
3. PRIVATE ELECTRIC UTILITY SERVICES FROM THE METER REQUIRES ELECTRICAL CONTRACTOR TO SUPPLY ALL WORK REQUIRED FOR INSTALLATION INCLUDING TRENCHING, CONDUIT, AND FEEDERS. SEE ELECTRICAL DRAWINGS FOR PRIVATE UTILITY SERVICE COORDINATION.
4. PLUMBING CONTRACTOR TO PROVIDE TRENCHING, BEDDING, AND BACKFILL PER UTILITY DETAILS FOR ALL WATER AND GAS SERVICES NOTED ON PLANS.
5. PLUMBING CONTRACTOR TO PROVIDE INSTALLATION OF PROPANE TANK AND SUPPLY LINE TO CONNECT GAS SERVICE. GENERAL CONTRACTOR TO PROVIDE DEVELOPED SITE AND ENCLOSURE PER PLANS FOR TANK INSTALLATION.
6. PLUMBING CONTRACTOR TO PROVIDE WATER SERVICE TO WATER FOUNTAINS AND DRAIN PITS FOR WATER SERVICE. SEE PLUMBING DRAWINGS FOR DETAILS.
7. ALL WORK ON THIS DRAWING IS TO BE INCLUDED BY THE GENERAL CONTRACTOR EXCEPT WORK NOTED TO BE BY THE PLUMBING CONTRACTOR OR ELECTRICAL CONTRACTOR.

SITE LOCATION

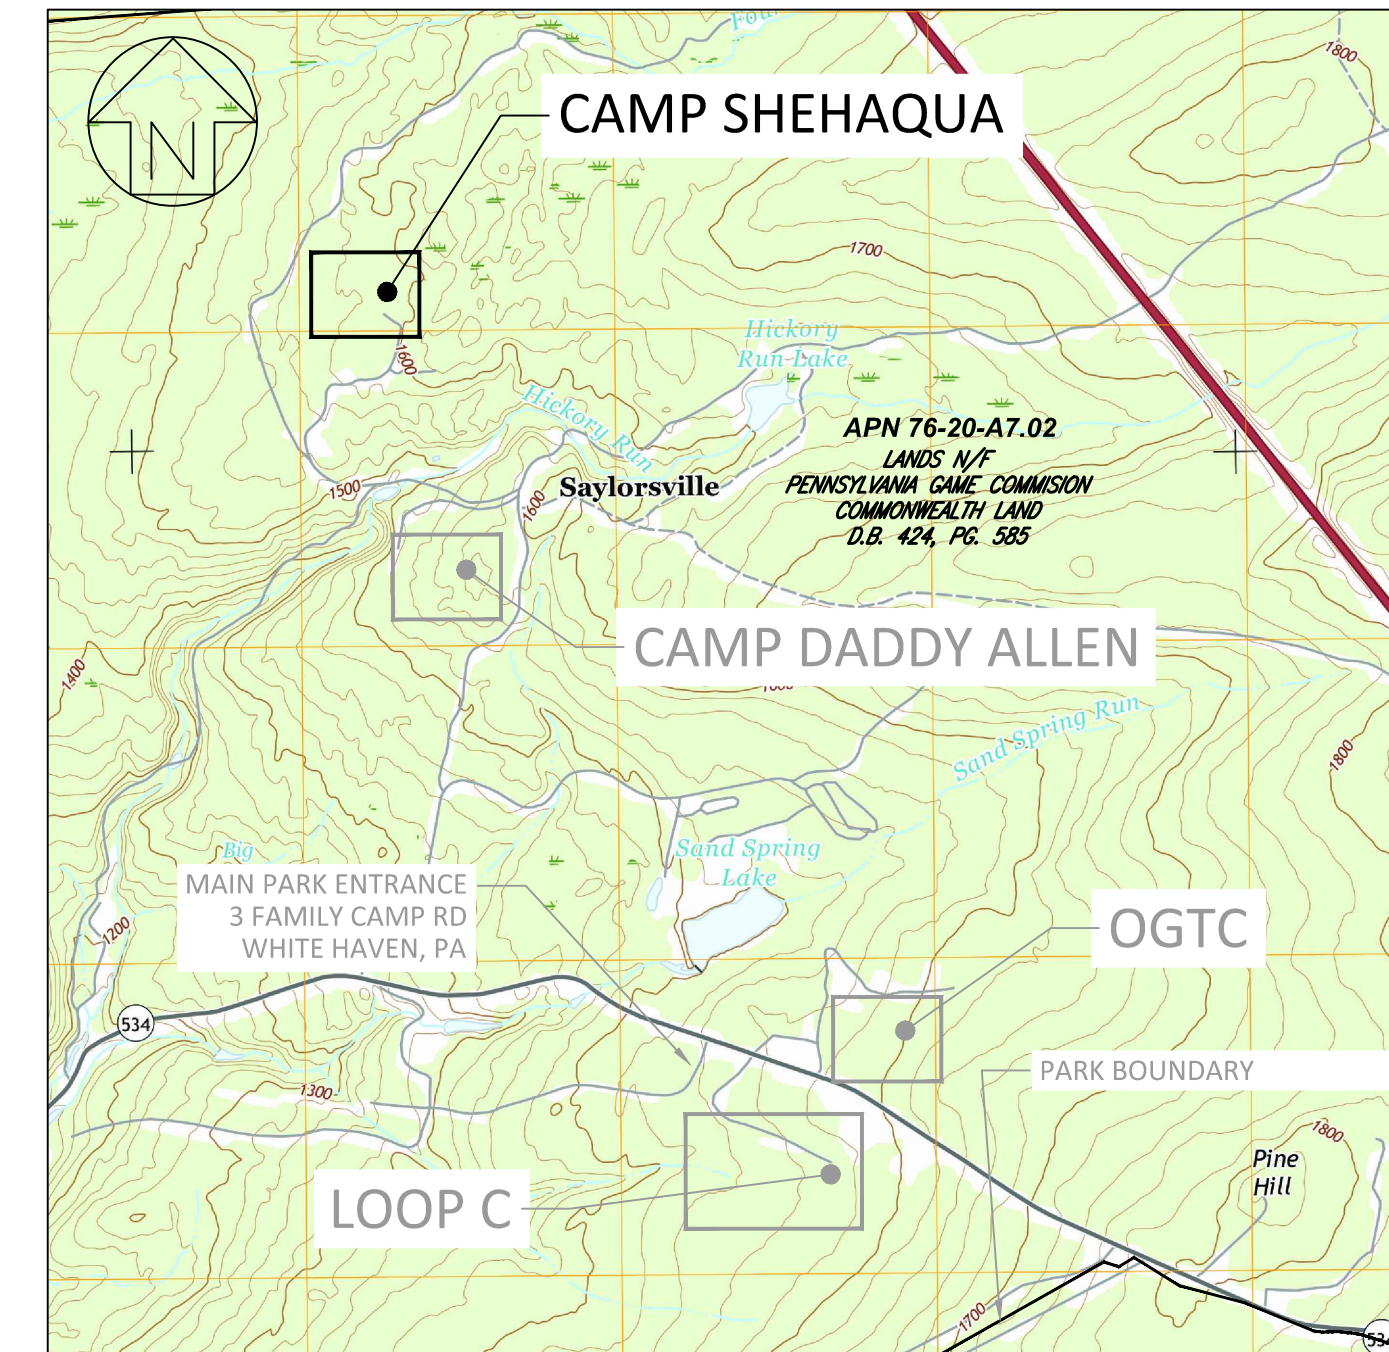


SCALE: 1" = 2000'

CONSTRUCTION DOCUMENTS



RECORD REVISIONS

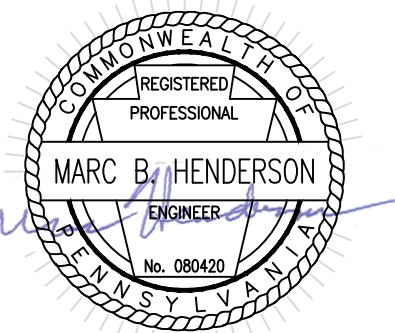

06/15/22
SIGNATURE DATE

SMP ARCHITECTS
1600 WALNUT STREET, SECOND FLOOR
PHILADELPHIA, PENNSYLVANIA

COMMONWEALTH OF PENNSYLVANIA
DEPARTMENT OF GENERAL SERVICES
HARRISBURG, PENNSYLVANIA

D.G.S. PROJECT No.
C-114-0006 PHASE 1

HICKORY RUN STATE PARK
LATRINE IMPROVEMENTS
DEPT of CONSERVATION AND NATURAL RESOURCES
WHITE HAVEN, CARBON COUNTY, PA

UTILITY PLAN -
CAMP SHEHAQUA

VERIFY SCALE


BAR IS ONE (1) INCH LONG ON ORIGINAL DRAWING:
0 1
IF BAR IS NOT ONE (1) INCH LONG, ADJUST SCALE ACCORDINGLY

CONTRACTOR SHALL FIELD VERIFY ALL DIMENSIONS. VARIANCE FROM CONTRACT DOCUMENTS NOT PERMITTED WITHOUT PROFESSIONAL & BUREAU OF CONSTRUCTION APPROVAL.


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CHECKED BY M HENDERSON	SCALE AS NOTED	44 OF 144

BASE BID #2 - CAMP SHEHAQUA


FILE PATH: U:\2020\090927 - Hickory Run State Park\CAD Shehaqua\2022\CPE-31.dwg PLOTTED BY: Laura L. Gill LAYOUT TAB: UTILITY PLAN - CAMP SHEHAQUA

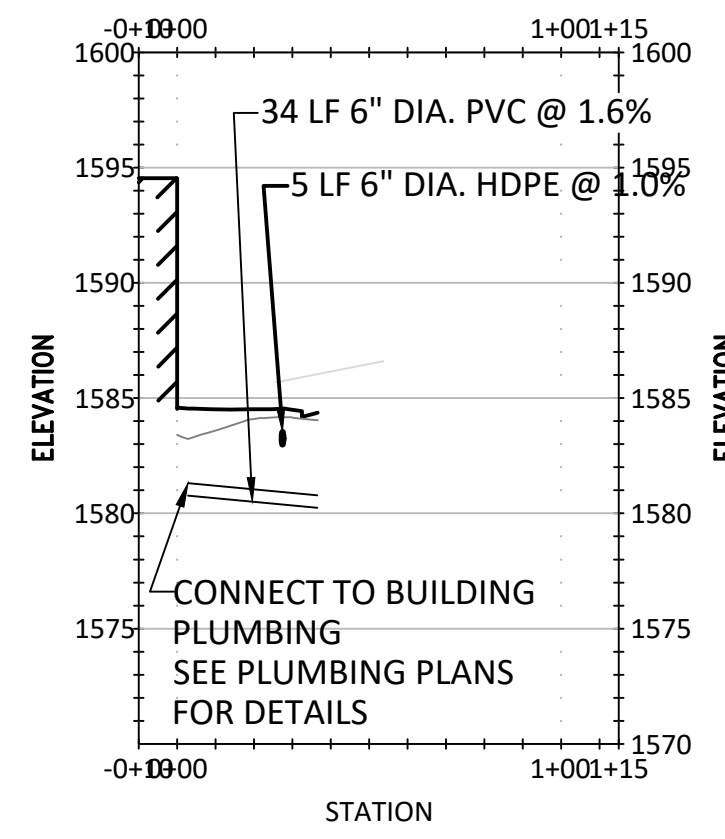

1 PROFILE VIEW
CPE-32 CAMP SHEHAQUA - SANITARY SEWER 1"=50' H, 1"=10' V

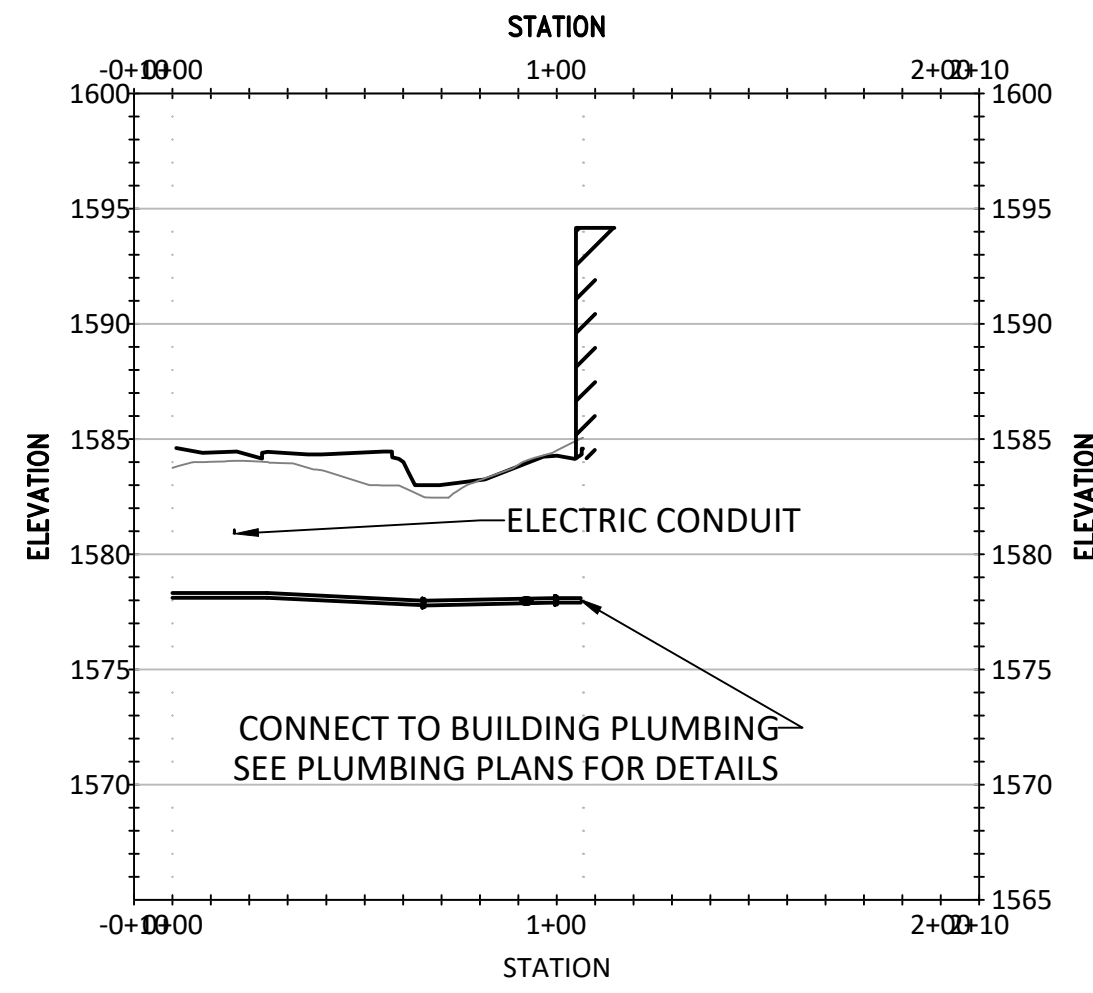

2 PROFILE VIEW
CPE-32 CAMP SHEHAQUA - WATER LINE 1"=50' H, 1"=10' V

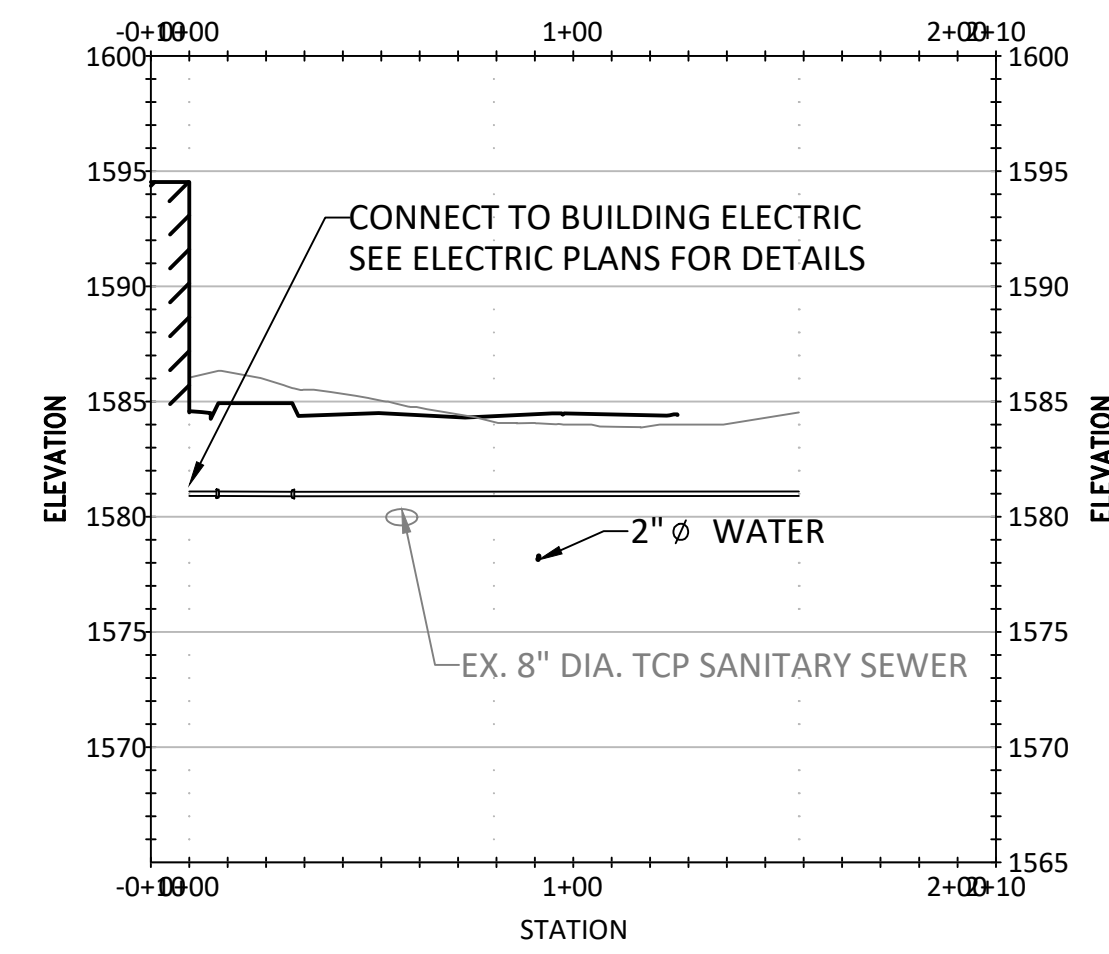

3 PROFILE VIEW
CPE-32 CAMP SHEHAQUA - ELECTRIC LINE 1"=50' H, 1"=10' V

NOTES:


1. WATER AND SEWER LINES TO BE INSTALLED BELOW FROST DEPTH.
2. ALL WORK ON THIS DRAWING IS TO BE INCLUDED BY THE GENERAL CONTRACTOR EXCEPT WORK NOTED TO BE BY THE PLUMBING CONTRACTOR OR ELECTRICAL CONTRACTOR.

VERIFY SCALE		
BAR IS ONE (1) INCH LONG ON ORIGINAL DRAWING: 0 1		
IF BAR IS NOT ONE (1) INCH LONG, ADJUST SCALE ACCORDINGLY		
CONTRACTOR SHALL FIELD VERIFY ALL DIMENSIONS. VARIANCE FROM CONTRACT DOCUMENTS NOT PERMITTED WITHOUT PROFESSIONAL & BUREAU OF CONSTRUCTION APPROVAL.		
DRAWN BY L GILL	DATE 06/17/2022	DRAWING No. CPE-32
CHECKED BY M HENDERSON	SCALE AS NOTED	45 OF 144

CONSTRUCTION DOCUMENTS



RECORD REVISIONS

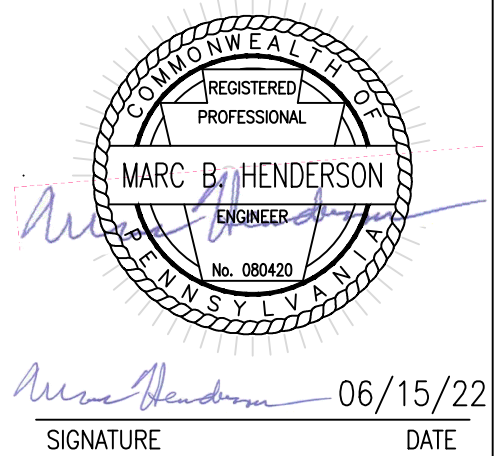


SMP ARCHITECTS
1600 WALNUT STREET, SECOND FLOOR
PHILADELPHIA, PENNSYLVANIA

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DEPARTMENT OF GENERAL SERVICES
HARRISBURG, PENNSYLVANIA

D.G.S. PROJECT No.
C-114-0006 PHASE 1


HICKORY RUN STATE PARK
LATRINE IMPROVEMENTS
DEPT of CONSERVATION AND NATURAL RESOURCES
WHITE HAVEN, CARBON COUNTY, PA

UTILITY PROFILES - CAMP SHEHAQUA

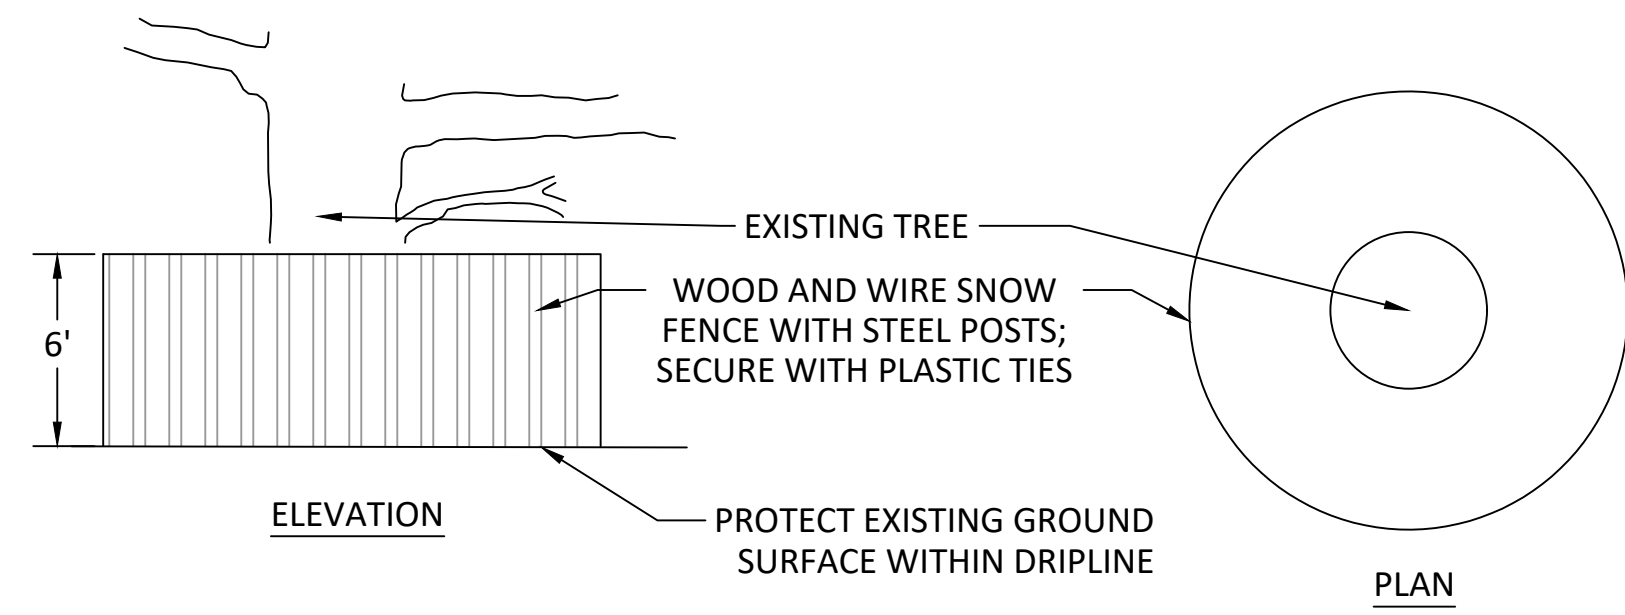


- NOTES:
- TREE PROTECTION FENCE SHALL BE INSTALLED PRIOR TO ANY SITE ACTIVITY.
 - ORANGE CONSTRUCTION FENCE CAN BE USED FOR TREE PROTECTION ONLY OUTSIDE LIMITS OF DISTURBANCE.

1 TREE PROTECTION FENCE
C-34 NTS

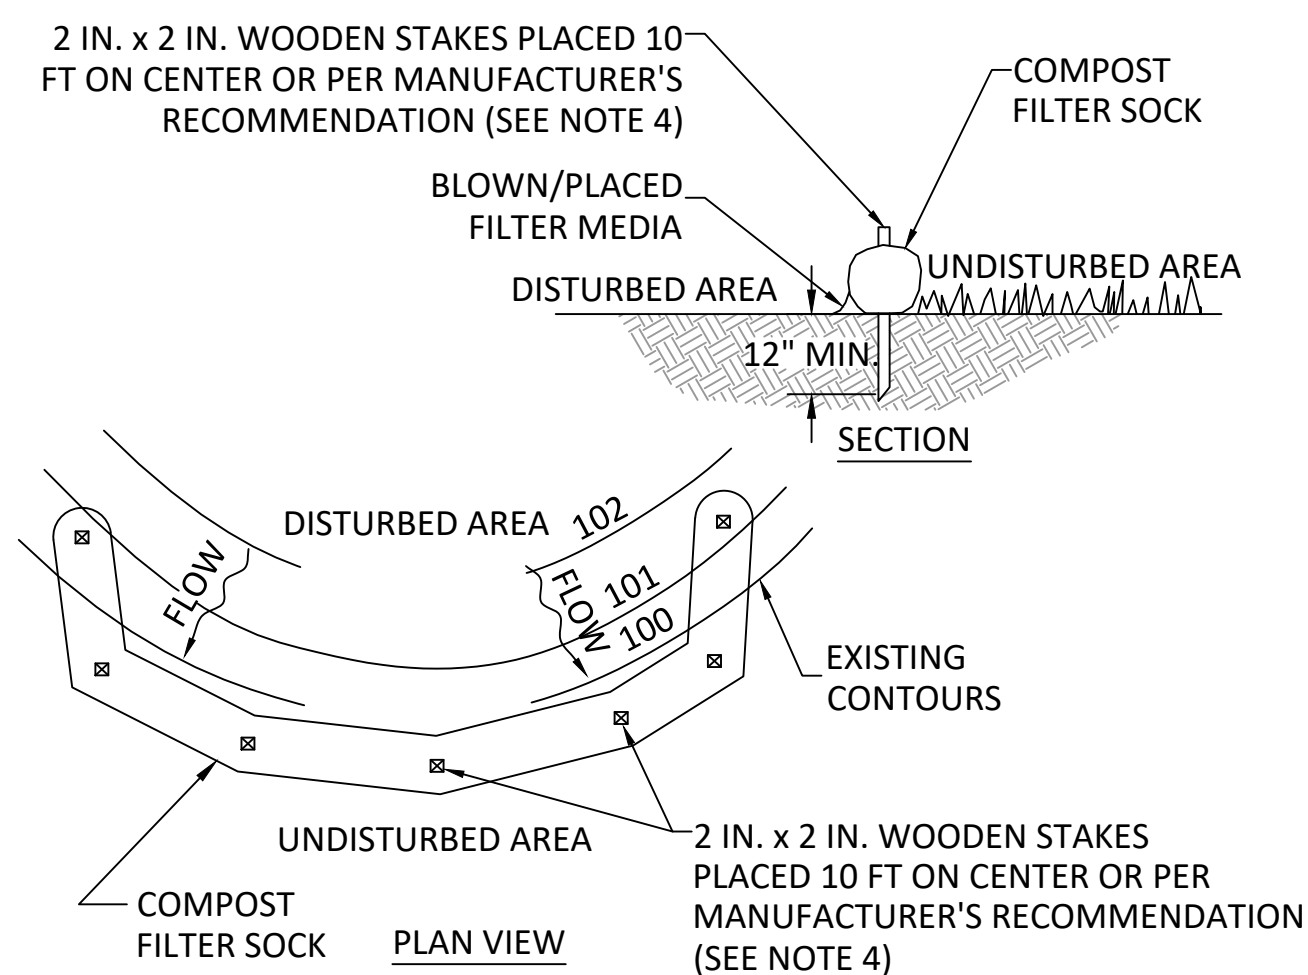

- NOTES:
- SOCK FABRIC SHALL MEET STANDARDS OF TABLE 4.1 OF THE PA DEP EROSION CONTROL MANUAL. COMPOST SHALL MEET THE STANDARDS OF TABLE 4.2 OF THE PA DEP EROSION CONTROL MANUAL.
 - COMPOST FILTER SOCK SHALL BE PLACED AT EXISTING LEVEL GRADE. BOTH ENDS OF THE BARRIER SHALL BE EXTENDED AT LEAST 8 FEET UP SLOPE AT 45 DEGREES TO THE MAIN BARRIER ALIGNMENT. MAXIMUM SLOPE LENGTH ABOVE ANY BARRIER SHALL NOT EXCEED THAT SPECIFIED FOR THE SIZE OF THE SOCK AND THE SLOPE OF ITS TRIBUTARY AREA.
 - TRAFFIC SHALL NOT BE PERMITTED TO CROSS COMPOST FILTER SOCKS.
 - FOR PAVED SURFACE APPLICATIONS, OBJECTS OF CONSIDERABLE MASS (I.E. CONCRETE BLOCKS, SAND BAGS, ETC.) SHALL BE USED IMMEDIATELY DOWNSLOPE OF COMPOST FILTER SOCKS IN LIEU OF STAKES. MAXIMUM SPACING OF STABILIZING OBJECTS SHALL BE EQUAL TO THE MANUFACTURER'S RECOMMENDATION FOR STAKE SPACING.
 - ACCUMULATED SEDIMENT SHALL BE REMOVED WHEN IT REACHES 1/2 THE ABOVE GROUND HEIGHT OF THE BARRIER AND DISPOSED IN THE MANNER DESCRIBED ELSEWHERE IN THE PLAN.
 - COMPOST FILTER SOCKS SHALL BE INSPECTED WEEKLY AND AFTER EACH RUNOFF EVENT. DAMAGED SOCKS SHALL BE REPAIRED ACCORDING TO MANUFACTURER'S SPECIFICATIONS OR REPLACED WITHIN 24 HOURS OF INSPECTION.
 - BIODEGRADABLE COMPOST FILTER SOCKS SHALL BE REPLACED AFTER 6 MONTHS; PHOTODEGRADABLE SOCKS AFTER 1 YEAR.
 - UPON STABILIZATION OF THE AREA TRIBUTARY TO THE SOCK, STAKES SHALL BE REMOVED. THE SOCK MAY BE LEFT IN PLACE AND VEGETATED OR REMOVED. IN THE LATTER CASE, THE MESH SHALL BE CUT OPEN AND THE MULCH SPREAD AS A SOIL SUPPLEMENT.

4 COMPOST SOCK
C-34 TYPICAL N.T.S.

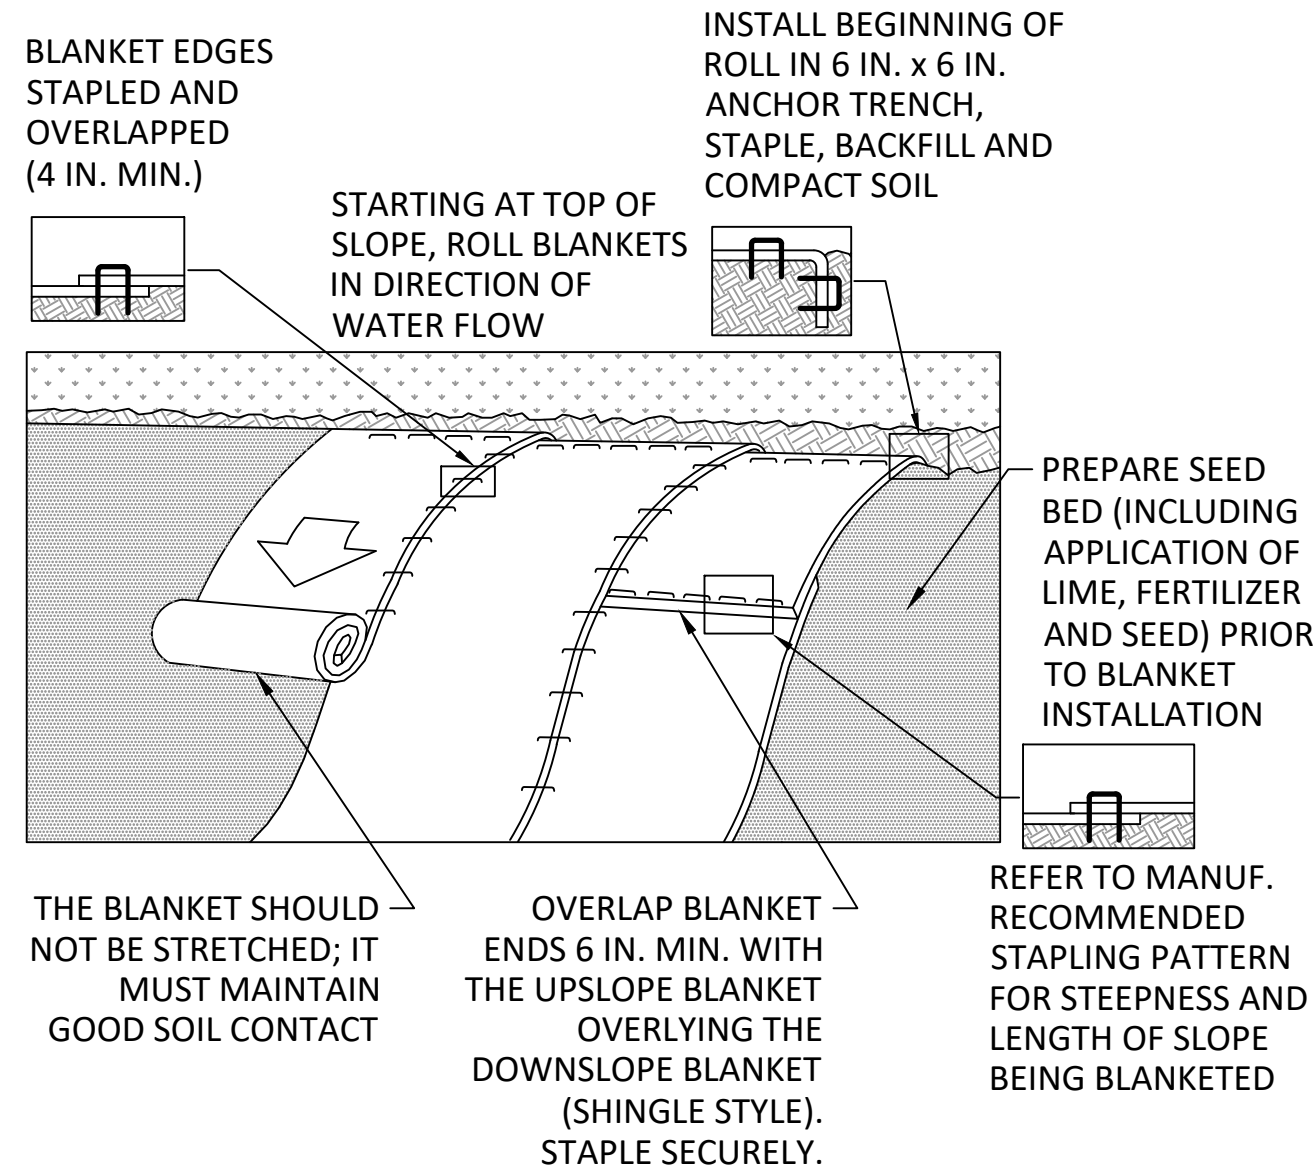

NOTES:

SEED AND SOIL AMENDMENTS SHALL BE APPLIED ACCORDING TO THE RATES IN THE PLAN DRAWINGS PRIOR TO INSTALLING THE BLANKET.

PROVIDE ANCHOR TRENCH AT TOE OF SLOPE IN SIMILAR FASHION AS AT TOP OF SLOPE.

SLOPE SURFACE SHALL BE FREE OF ROCKS, CLODS, STICKS, AND GRASS.

BLANKET SHALL HAVE GOOD CONTINUOUS CONTACT WITH UNDERLYING SOIL THROUGHOUT ENTIRE LENGTH. LAY BLANKET LOOSELY AND STAKE OR STAPLE TO MAINTAIN DIRECT CONTACT WITH SOIL. DO NOT STRETCH BLANKET.

THE BLANKET SHALL BE STAPLED IN ACCORDANCE WITH THE MANUFACTURER'S RECOMMENDATIONS.

BLANKETED AREAS SHALL BE INSPECTED WEEKLY AND AFTER EACH RUNOFF EVENT UNTIL PERENNIAL VEGETATION IS ESTABLISHED TO A MINIMUM UNIFORM 70% COVERAGE THROUGHOUT THE BLANKETED AREA. DAMAGED OR DISPLACED BLANKETS SHALL BE RESTORED OR REPLACED WITHIN 4 CALENDAR DAYS.

BLANKET EDGES STAPLED AND OVERLAPPED (4 IN. MIN.)

INSTALL BEGINNING OF ROLL IN 6 IN. x 6 IN. ANCHOR TRENCH, STAPLE, BACKFILL AND COMPACT SOIL

STARTING AT TOP OF SLOPE, ROLL BLANKETS IN DIRECTION OF WATER FLOW


PREPARE SEED BED (INCLUDING APPLICATION OF LIME, FERTILIZER AND SEED) PRIOR TO BLANKET INSTALLATION

THE BLANKET SHOULD NOT BE STRETCHED; IT MUST MAINTAIN GOOD SOIL CONTACT

OVERLAP BLANKET ENDS 6 IN. MIN. WITH THE UPSLOPE BLANKET OVERLYING THE DOWNSLOPE BLANKET (SHINGLE STYLE). STAPLE SECURELY.

REFER TO MANUF. RECOMMENDED STAPLING PATTERN FOR STEEPNESS AND LENGTH OF SLOPE BEING BLANKETED

2 EROSION CONTROL BLANKET INSTALLATION
C-34 NTS

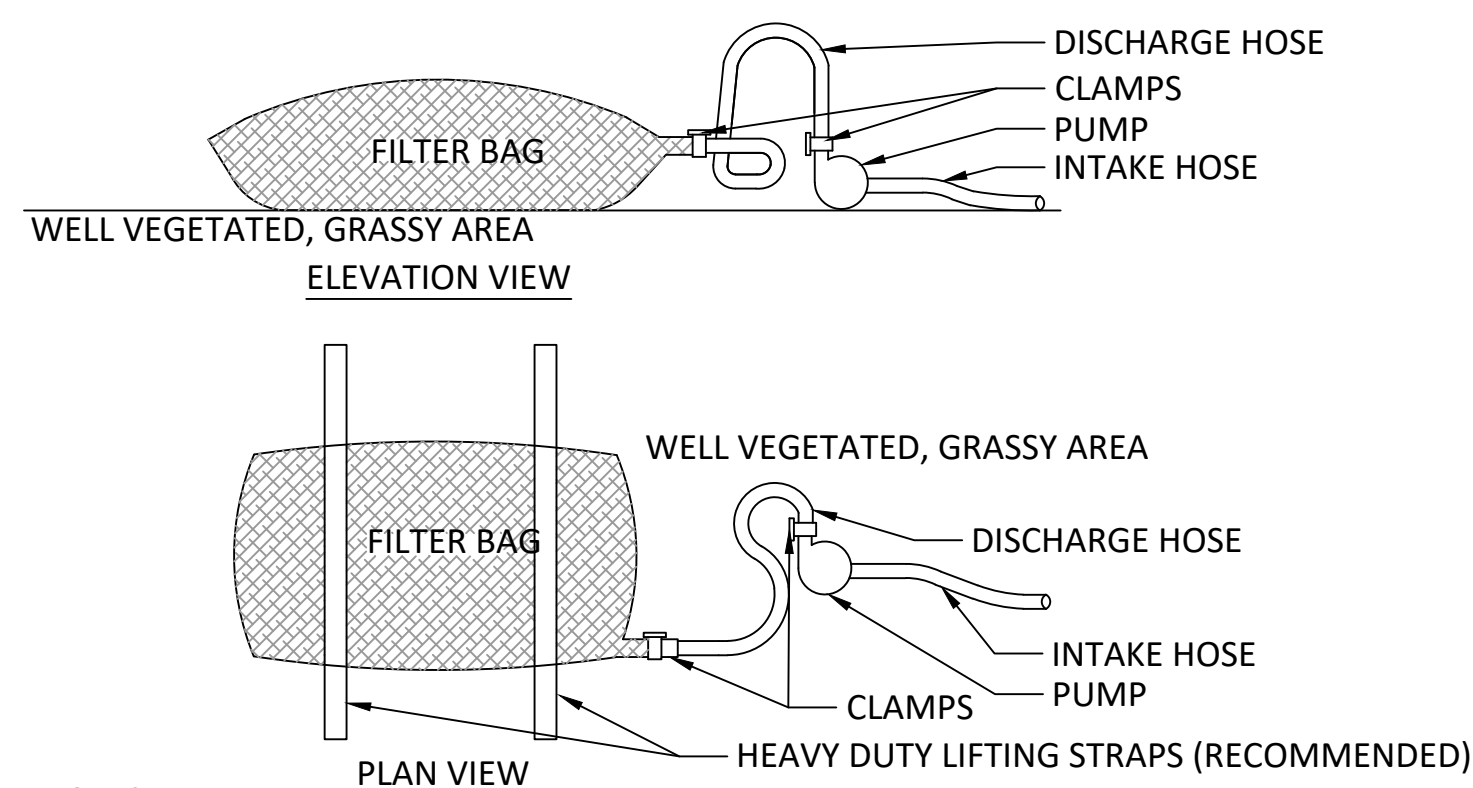


NOTES:

- LOW VOLUME FILTER BAGS SHALL BE MADE FROM NON-WOVEN GEOTEXTILE MATERIAL SEWN WITH HIGH STRENGTH, DOUBLE STITCHED "J" TYPE SEAMS. THEY SHALL BE CAPABLE OF TRAPPING PARTICLES LARGER THAN 150 MICRONS. HIGH VOLUME FILTER BAGS SHALL BE MADE FROM WOVEN GEOTEXTILES THAT MEET THE FOLLOWING STANDARDS:

PROPERTY	TEST METHOD	MINIMUM STANDARD
M	ASTM D-4884	60 LB/IN
GRAB TENSILE	ASTM D-4632	205 LB
PUNCTURE	ASTM D-4833	110 LB
MULLEN BURST	ASTM D-3786	350 PSI
UV RESISTANCE	ASTM D-4355	70%
AOS % RETAINED	ASTM D-4751	80 SIEVE

- A SUITABLE MEANS OF ACCESSING THE BAG WITH MACHINERY REQUIRED FOR DISPOSAL PURPOSES SHALL BE PROVIDED. FILTER BAGS SHALL BE REPLACED WHEN THEY BECOME 1/2 FULL OF SEDIMENT. SPARE BAGS SHALL BE KEPT AVAILABLE FOR REPLACEMENT OF THOSE THAT HAVE FAILED OR ARE FILLED. BAGS SHALL BE PLACED ON STRAPS TO FACILITATE REMOVAL UNLESS BAGS COME WITH LIFTING STRAPS ALREADY ATTACHED.
- BAGS SHALL BE LOCATED IN WELL-VEGETATED (GRASSY) AREA, AND DISCHARGE ONTO STABLE, EROSION RESISTANT AREAS. WHERE THIS IS NOT POSSIBLE, A GEOTEXTILE UNDERLAYMENT AND FLOW PATH SHALL BE PROVIDED. BAGS MAY BE PLACED ON FILTER STONE TO INCREASE DISCHARGE CAPACITY. BAGS SHALL NOT BE PLACED ON SLOPES GREATER THAN 5%. FOR SLOPES EXCEEDING 5%, CLEAN ROCK OR OTHER NON-ERODIBLE AND NON-POLLUTING MATERIAL MAY BE PLACED UNDER THE BAG TO REDUCE SLOPE STEEPNESS.
- DOWNSLOPE SEDIMENT BARRIER IS REQUIRED. COMPOST FILTER SOCK SHALL BE INSTALLED AROUND BAGS.**
- THE PUMP DISCHARGE HOSE SHALL BE INSERTED INTO THE BAGS IN THE MANNER SPECIFIED BY THE MANUFACTURER AND SECURELY CLAMPED. A PIECE OF PVC PIPE IS RECOMMENDED FOR THIS PURPOSE.
- THE PUMPING RATE SHALL BE NO GREATER THAN 750 GPM OR 1/2 THE MAXIMUM SPECIFIED BY THE MANUFACTURER, WHICHEVER IS LESS. PUMP INTAKES SHALL BE FLOATING AND SCREENED.
- FILTER BAGS SHALL BE INSPECTED DAILY. IF ANY PROBLEM IS DETECTED, PUMPING SHALL CEASE IMMEDIATELY AND NOT RESUME UNTIL THE PROBLEM IS CORRECTED.

5 PUMPED WATER FILTER BAG
C-34 TYPICAL N.T.S.

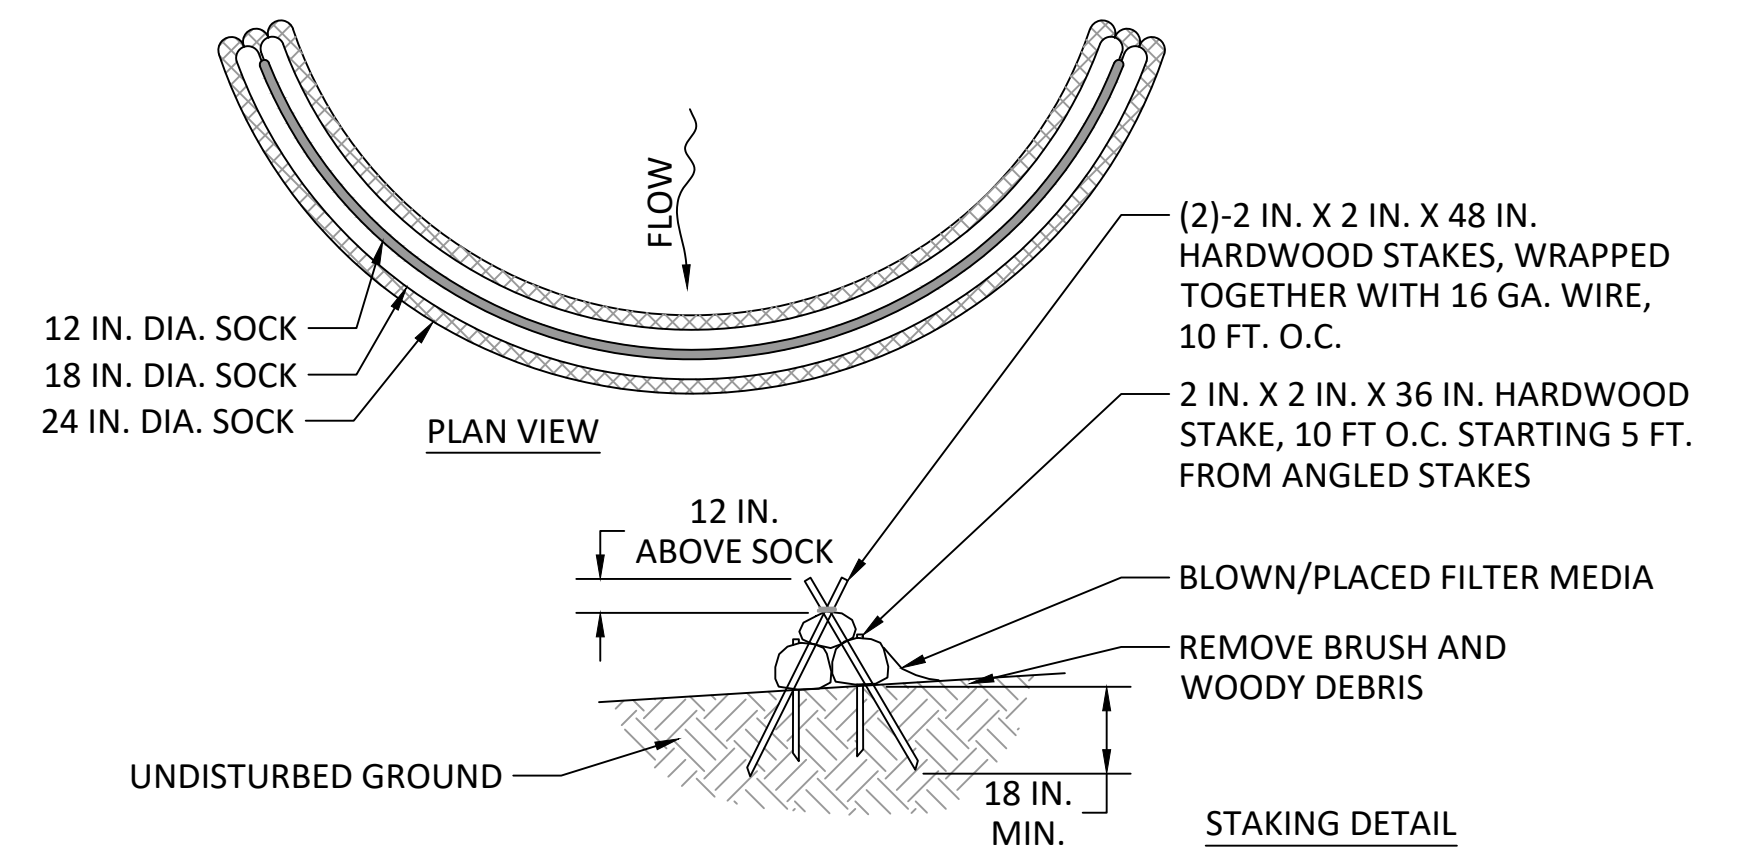


DESIGN NOTES:

- COMPOST SOCK SEDIMENT TRAP SHALL BE SIZED TO PROVIDE 2000 CUBIC FEET OF STORAGE CAPACITY FOR EACH ACRE TRIBUTARY TO THE TRAP.
- MINIMUM BASE WIDTH IS EQUAL TO THE HEIGHT.
- SEDIMENT ACCUMULATION SHALL NOT EXCEED 1/3 THE TOTAL HEIGHT OF THE TRAP.
- SOCKS SHALL BE OF LARGER DIAMETER AT THE BASE OF THE TRAP AND DECREASE IN DIAMETER FOR SUCCESSIVE LAYERS AS SHOWN ON THE PLAN VIEW.
- ENDS OF THE TRAP SHALL BE A MINIMUM OF 1 FOOT HIGHER IN ELEVATION THAN THE MID-SECTION, WHICH SHALL BE LOCATED AT THE POINT OF DISCHARGE.

NOTES:

- SOCK MATERIAL SHALL MEET THE STANDARDS OF TABLE 4.1 OF THE PA DEP EROSION CONTROL MANUAL. COMPOST SHALL MEET THE STANDARDS OF TABLE 4.2 OF THE PA DEP EROSION CONTROL MANUAL.
- COMPOST SOCK SEDIMENT TRAPS SHALL NOT EXCEED THREE SOCKS IN HEIGHT AND SHALL BE STACKED IN PYRAMIDAL FORM AS SHOWN ABOVE. MINIMUM TRAP HEIGHT IS ONE 24" DIAMETER SOCK. ADDITIONAL STORAGE MAY BE PROVIDED BY MEANS OF AN EXCAVATED SUMP 12" DEEP EXTENDING 1 TO 3 FEET UPSLOPE OF THE SOCKS ALONG THE LOWER SIDE OF THE TRAP.
- COMPOST SOCK SEDIMENT TRAPS SHALL PROVIDE 2,000 CUBIC FEET STORAGE CAPACITY WITH 12" FREEBOARD FOR EACH TRIBUTARY DRAINAGE ACRE. (SEE MANUFACTURER FOR ANTICIPATED SETTLEMENT.)
- THE MAXIMUM TRIBUTARY DRAINAGE AREA IS 5.0 ACRES. SINCE COMPOST SOCKS ARE "FLOW-THROUGH," NO SPILLWAY IS REQUIRED.
- COMPOST SOCK SEDIMENT TRAPS SHALL BE INSPECTED WEEKLY AND AFTER EACH RUNOFF EVENT. SEDIMENT SHALL BE REMOVED WHEN IT REACHES 1/3 THE HEIGHT OF THE SOCKS.
- PHOTODEGRADABLE AND BIODEGRADABLE SOCKS SHALL NOT BE USED FOR MORE THAN 1 YEAR.

3 COMPOST SOCK SEDIMENT TRAP
C-34 TYPICAL N.T.S.

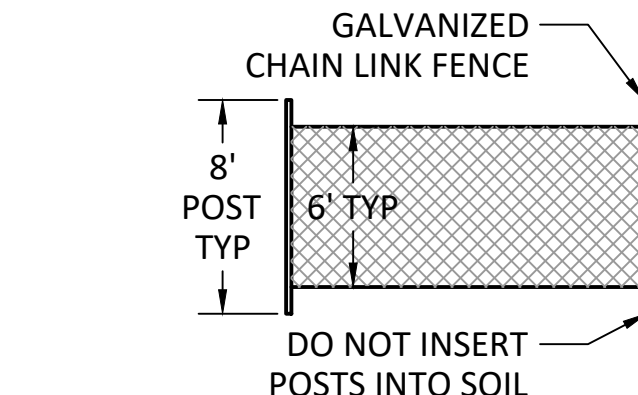

6 CONSTRUCTION FENCE
C-34 NTS

CONSTRUCTION DOCUMENTS

meliora
259 MORGAN STREET, PHOENIXVILLE, PA 19460
(610) 933-0123
melioradesign.com

NO.	DESCRIPTION	DATE

RECORD REVISIONS

SIGNATURE: *Marc B. Henderson* DATE: 06/15/22

SMP ARCHITECTS
1600 WALNUT STREET, SECOND FLOOR
PHILADELPHIA, PENNSYLVANIA

COMMONWEALTH OF PENNSYLVANIA
DEPARTMENT OF GENERAL SERVICES
HARRISBURG, PENNSYLVANIA

D.G.S. PROJECT No. C-114-0006 PHASE 1

HICKORY RUN STATE PARK
LATRINE IMPROVEMENTS
DEPT OF CONSERVATION AND NATURAL RESOURCES
WHITE HAVEN, CARBON COUNTY, PA

EROSION & SEDIMENT CONTROL DETAILS - SHEET 1

VERIFY SCALE

BAR IS ONE (1) INCH LONG ON ORIGINAL DRAWING:


0 1

IF BAR IS NOT ONE (1) INCH LONG, ADJUST SCALE ACCORDINGLY

CONTRACTOR SHALL FIELD VERIFY ALL DIMENSIONS. VARIANCE FROM CONTRACT DOCUMENTS NOT PERMITTED WITHOUT PROFESSIONAL & BUREAU OF CONSTRUCTION APPROVAL.

DRAWN BY L GILL	DATE 06/17/2022	DRAWING No. C-34
CHECKED BY M HENDERSON	SCALE AS NOTED	

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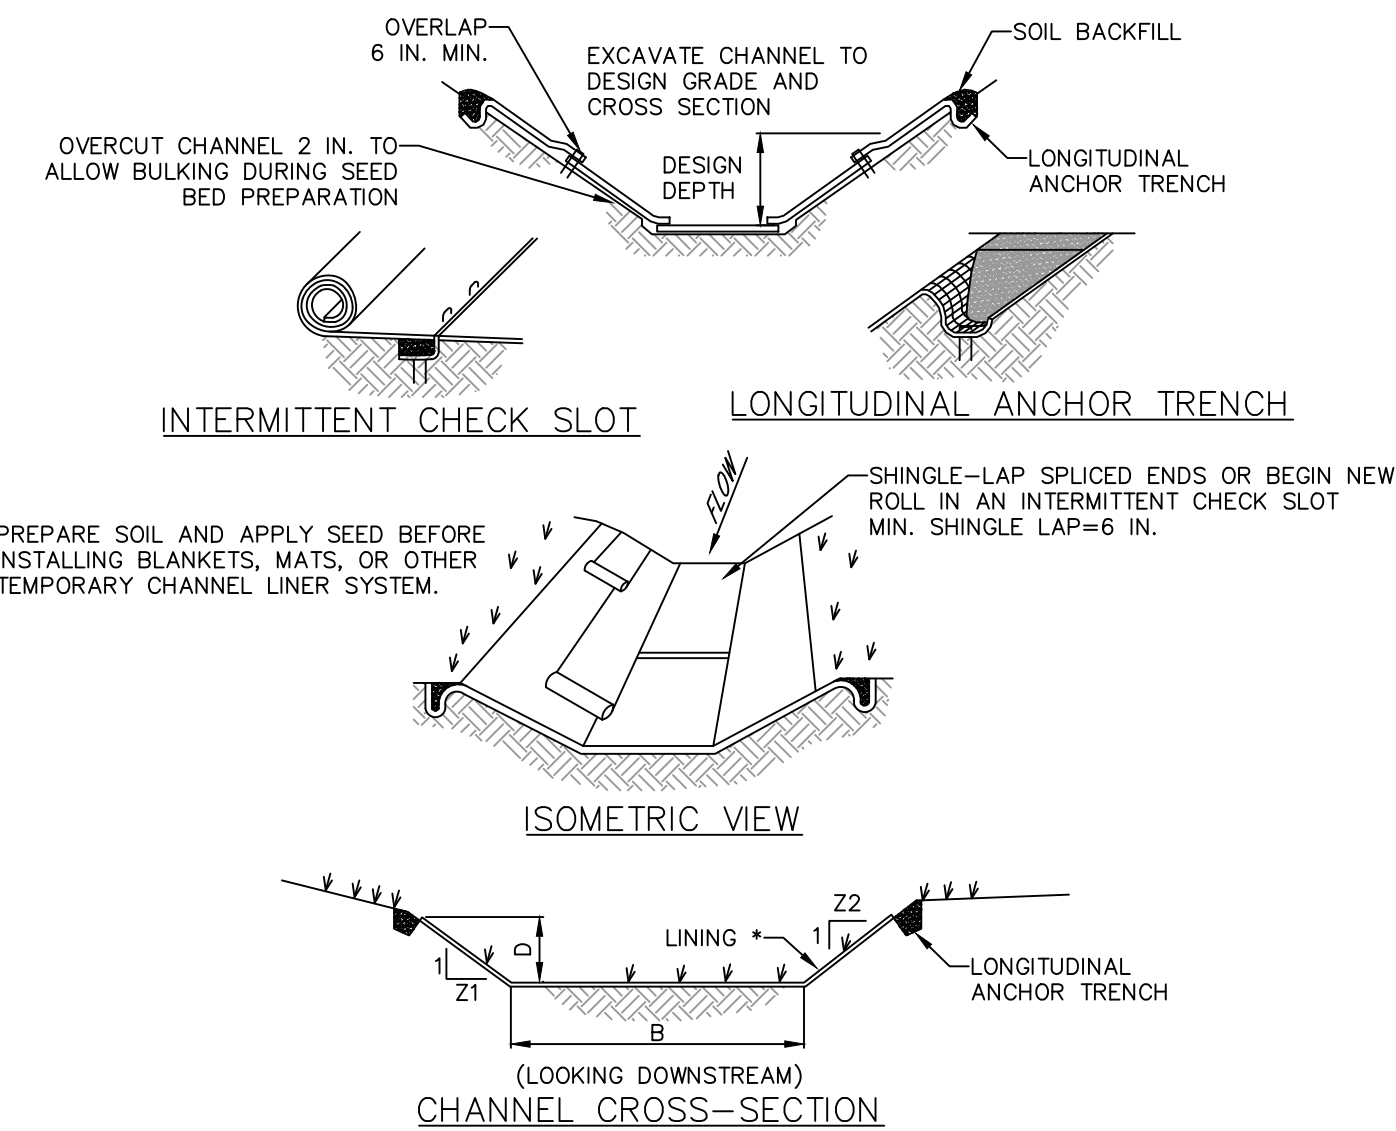


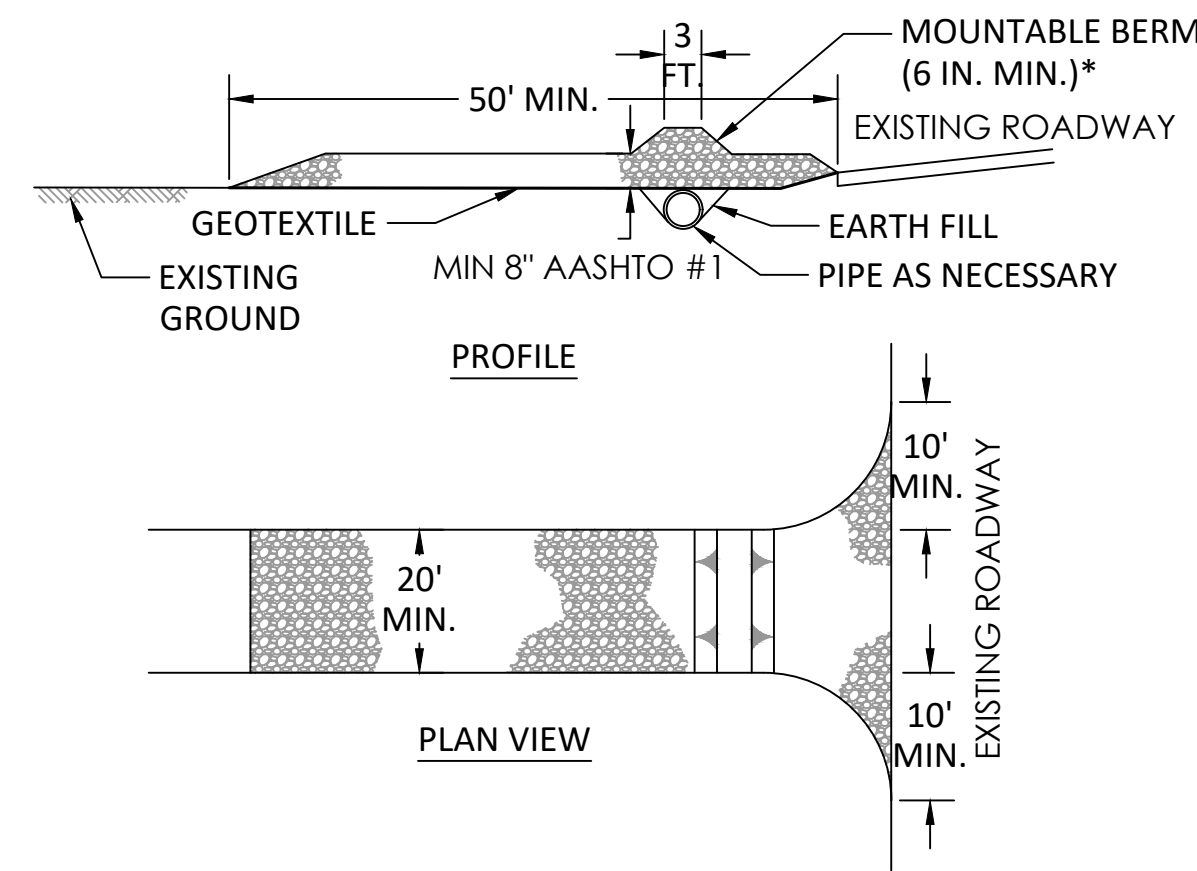* MOUNTABLE BERM USED TO PROVIDE PROPER COVER FOR PIPE

NOTES:

1. REMOVE TOPSOIL PRIOR TO INSTALLATION OF ROCK CONSTRUCTION ENTRANCE. EXTEND ROCK OVER FULL WIDTH OF ENTRANCE.
2. RUNOFF SHALL BE DIVERTED FROM ROADWAY TO A SUITABLE SEDIMENT REMOVAL BMP PRIOR TO ENTERING ROCK CONSTRUCTION ENTRANCE.
3. MOUNTABLE BERM SHALL BE INSTALLED WHEREVER OPTIONAL CULVERT PIPE IS USED AND PROPER PIPE COVER AS SPECIFIED BY MANUFACTURER IS NOT OTHERWISE PROVIDED. PIPE SHALL BE SIZED APPROPRIATELY FOR SIZE OF DITCH BEING CROSSED.
4. MAINTENANCE: ROCK CONSTRUCTION ENTRANCE THICKNESS SHALL BE CONSTANTLY MAINTAINED TO THE SPECIFIED DIMENSIONS BY ADDING ROCK. A STOCKPILE SHALL BE MAINTAINED ON SITE FOR THIS PURPOSE. ALL SEDIMENT DEPOSITED ON PAVED ROADWAYS SHALL BE REMOVED AND RETURNED TO THE CONSTRUCTION SITE IMMEDIATELY. IF EXCESSIVE AMOUNTS OF SEDIMENT ARE BEING DEPOSITED ON ROADWAY, EXTEND LENGTH OF ROCK CONSTRUCTION ENTRANCE BY 50 FOOT INCREMENTS UNTIL CONDITION IS ALLEVIATED OR INSTALL WASH RACK. WASHING THE ROADWAY OR SWEEPING THE DEPOSITS INTO ROADWAY DITCHES, SEWERS, CULVERTS, OR OTHER DRAINAGE COURSES IS NOT ACCEPTABLE.
5. PUBLIC STREET SWEEPING WITH A VACUUM SWEEPER AND ROLLING OF DIRT AND GRAVEL ROADS SHALL OCCUR AT THE END OF EACH WORK DAY (OR MORE FREQUENTLY AS NEEDED); MANUAL CLEANING OF TIRES PRIOR TO SITE EGRESS.

1
C-35 **ROCK CONSTRUCTION ENTRANCE**
WITH STREET SWEEPING NTS



* SEE MANUFACTURER'S LINING INSTALLATION DETAIL FOR STAPLE PATTERNS, VEGETATIVE STABILIZATION FOR SOIL AMENDMENTS, SEED MIXTURES AND MULCHING INFORMATION

CHANNEL NO.	BOTTOM WIDTH B (FT)	DEPTH D (FT)	TOP WIDTH W (FT)	Z1 (FT)	Z2 (FT)	LINING *
1	2	0.5	6	4	4	NAG C125BN
2	1	0.5	4	3	3	NAG C125BN

NOTES:


ANCHOR TRENCHES SHALL BE INSTALLED AT BEGINNING AND END OF CHANNEL IN THE SAME MANNER AS LONGITUDINAL ANCHOR TRENCHES.

CHANNEL DIMENSIONS SHALL BE CONSTANTLY MAINTAINED. CHANNEL SHALL BE CLEANED WHENEVER TOTAL CHANNEL DEPTH IS REDUCED BY 25% AT ANY LOCATION.

SEDIMENT DEPOSITS SHALL BE REMOVED WITHIN 24 HOURS OF DISCOVERY OR AS SOON AS SOIL CONDITIONS PERMIT ACCESS TO CHANNEL WITHOUT FURTHER DAMAGE. DAMAGED LINING SHALL BE REPAIRED OR REPLACED WITHIN 48 HOURS OF DISCOVERY.

NO MORE THAN ONE THIRD OF THE SHOOT (GRASS LEAF) SHALL BE REMOVED IN ANY MOWING. GRASS HEIGHT SHALL BE MAINTAINED BETWEEN 2 AND 3 INCHES UNLESS OTHERWISE SPECIFIED. EXCESS VEGETATION SHALL BE REMOVED FROM PERMANENT CHANNELS TO ENSURE SUFFICIENT CHANNEL CAPACITY.


4
C-35 **VEGETATED CHANNEL**
TYPICAL NTS

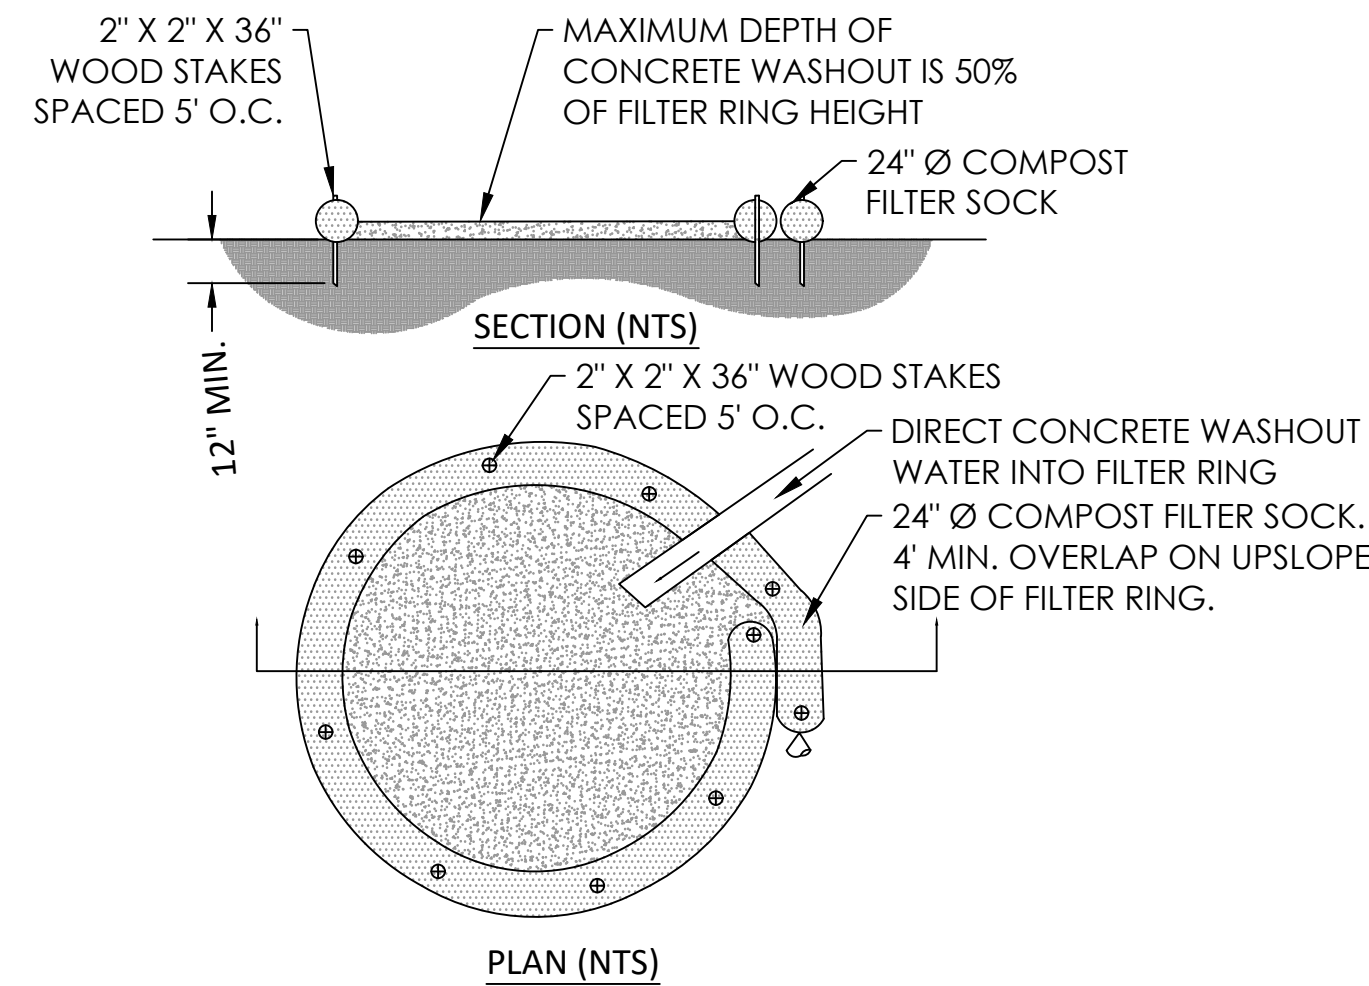

NOTES:

1. INSTALL ON FLAT GRADE FOR OPTIMUM PERFORMANCE.
2. 18" Ø FILTER SOCK MAY BE STACKED ONTO DOUBLE 24" Ø SOCKS IN PYRAMIDAL CONFIGURATION FOR ADDED HEIGHT.
3. A SUITABLE IMPERVIOUS GEOMEMBRANE SHALL BE PLACED AT THE LOCATION OF THE WASHOUT PRIOR TO INSTALLING THE SOCKS.

2
C-35 **CONCRETE WASHOUT**
NTS

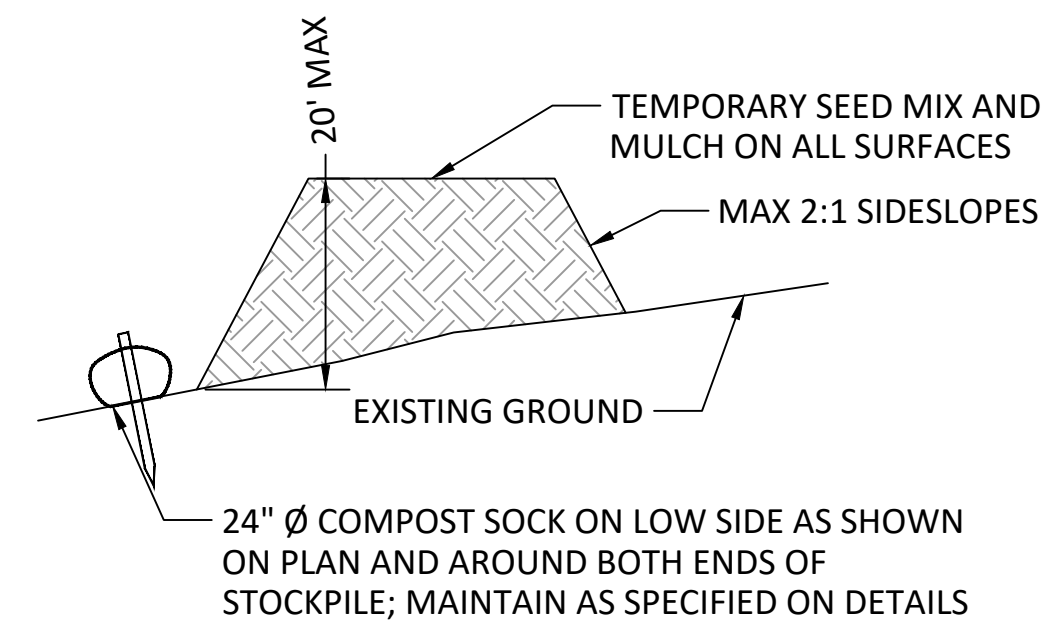

MAINTENANCE NOTES:


1. TEMPORARILY STOCKPILE TOPSOIL OR EXCAVATED SOIL MATERIAL AS NEEDED AT LOCATIONS SHOWN FOR EACH PHASE OF CONSTRUCTION. EXCESS EXCAVATED MATERIAL SHALL BE PERMANENTLY REMOVED FROM THE SITE.
2. HEIGHT AND SIDESLOPES SHALL NOT EXCEED MAXIMUM VALUES SHOWN ON DETAIL.
3. INSTALL COMPOST SOCK PRIOR TO STOCKPILING OF MATERIAL. REPLACE ANY COMPOST SOCK REMOVED FOR VEHICULAR ACCESS AFTER EACH WORK DAY.
4. APPLY SEED AND MULCH WHEN PILE IS NOT SUBJECT TO VEHICULAR ACCESS FOR SEVEN DAYS OR MORE.

3
C-35 **TEMPORARY SOIL STOCKPILE**
TYPICAL NTS

CONSTRUCTION DOCUMENTS



RECORD REVISIONS

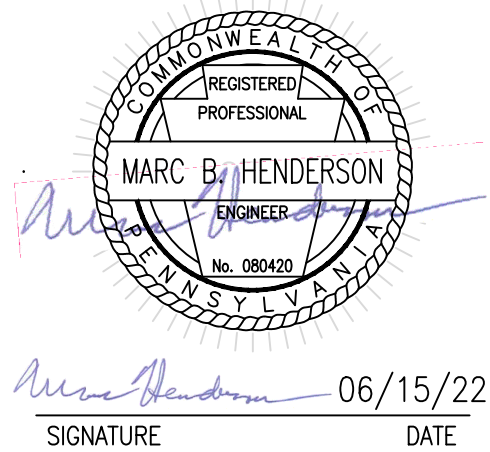

SMP ARCHITECTS
1600 WALNUT STREET, SECOND FLOOR
PHILADELPHIA, PENNSYLVANIA

COMMONWEALTH OF PENNSYLVANIA
DEPARTMENT OF GENERAL SERVICES
HARRISBURG, PENNSYLVANIA


D.G.S. PROJECT No.
C-114-0006 PHASE 1

HICKORY RUN STATE PARK
LATRINE IMPROVEMENTS
DEPT of CONSERVATION AND NATURAL RESOURCES
WHITE HAVEN, CARBON COUNTY, PA

EROSION & SEDIMENT CONTROL DETAILS - SHEET 2


VERIFY SCALE
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IF BAR IS NOT ONE (1) INCH LONG, ADJUST SCALE ACCORDINGLY
CONTRACTOR SHALL FIELD VERIFY ALL DIMENSIONS. VARIANCE FROM CONTRACT DOCUMENTS NOT PERMITTED WITHOUT PROFESSIONAL & BUREAU OF CONSTRUCTION APPROVAL.

DRAWN BY L GILL	DATE 06/17/2022	DRAWING No. C-35
CHECKED BY M HENDERSON	SCALE AS NOTED	

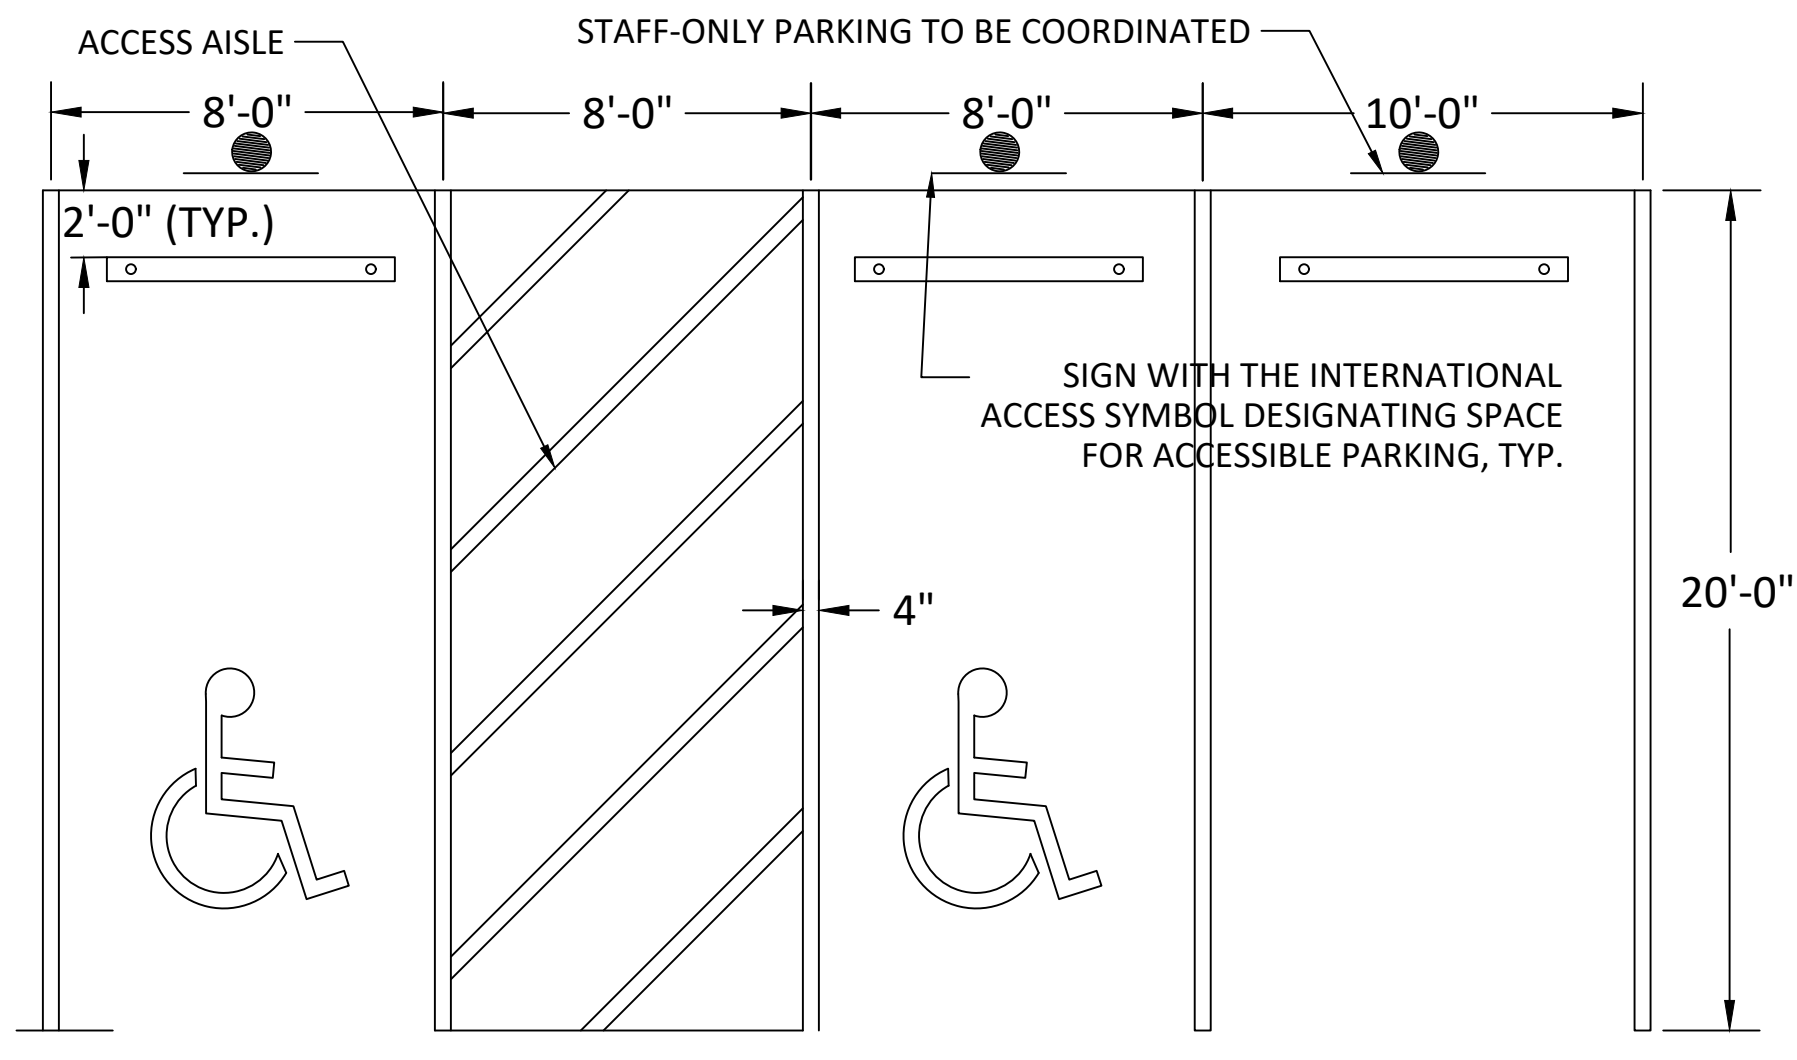


- NOTES:
1. ALL SIGNS, SYMBOLS AND MARKINGS SHALL MEET ALL APPLICABLE REGULATIONS.
2. SEE SITE PLANS FOR PARKING LANE LAYOUT AND ORIENTATION AT EACH SITE.

1 PARKING AND ADA ACCESS STRIPING - GENERAL
C-36 NTS

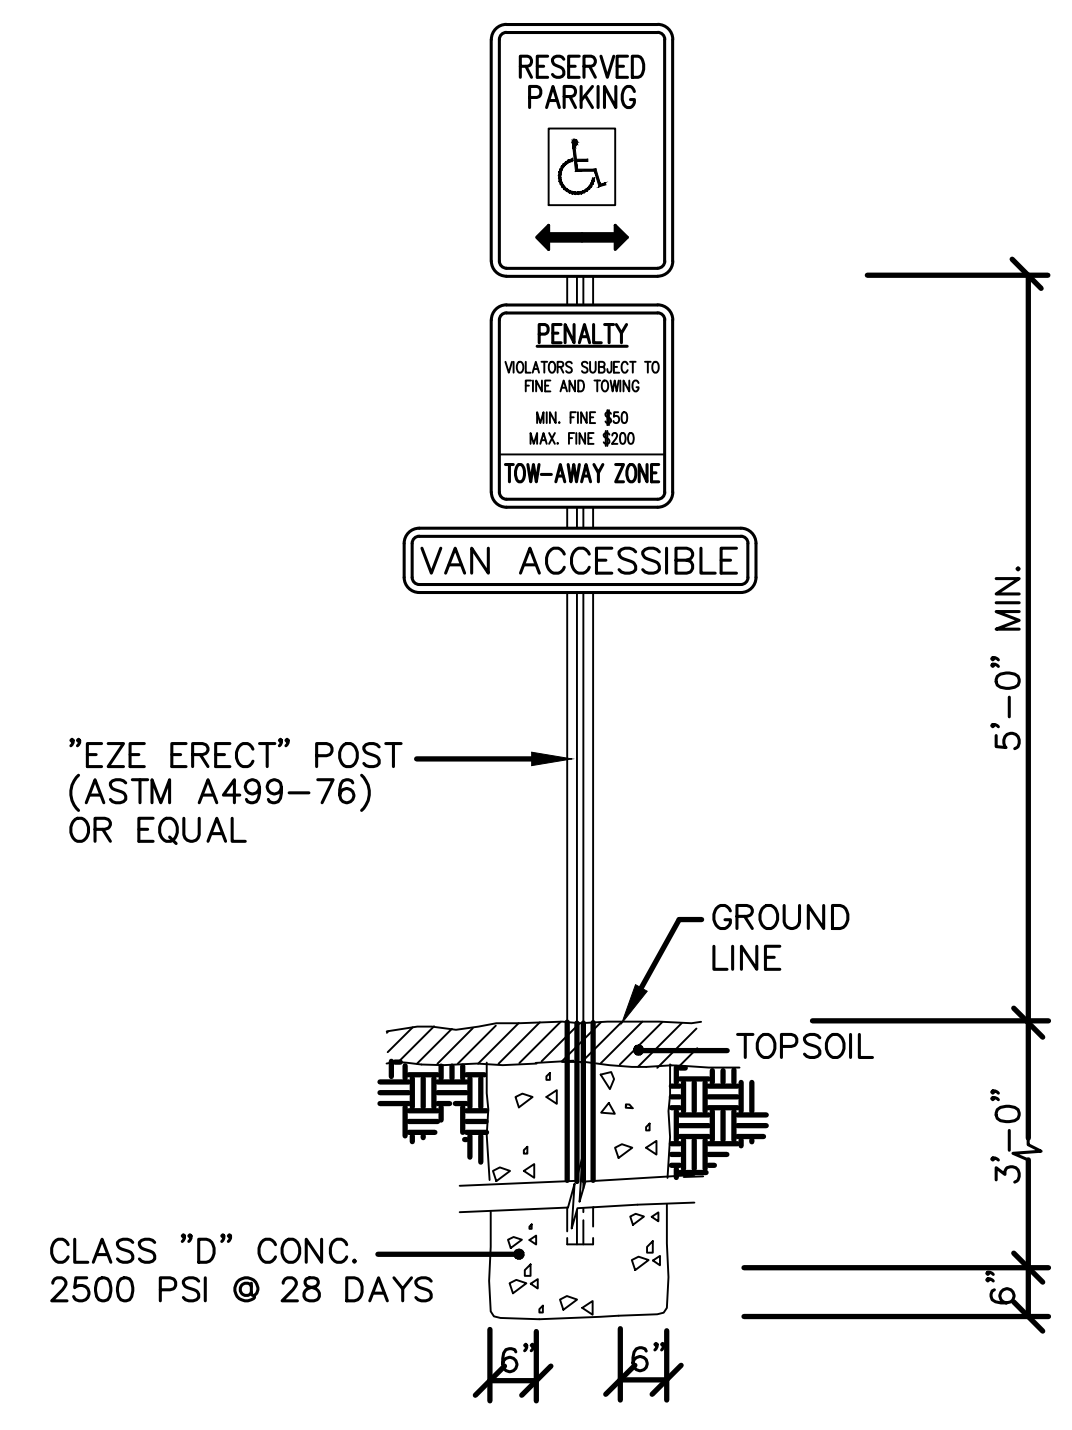


2 HANDICAP PARKING SIGN
C-36 1"=1'-0"

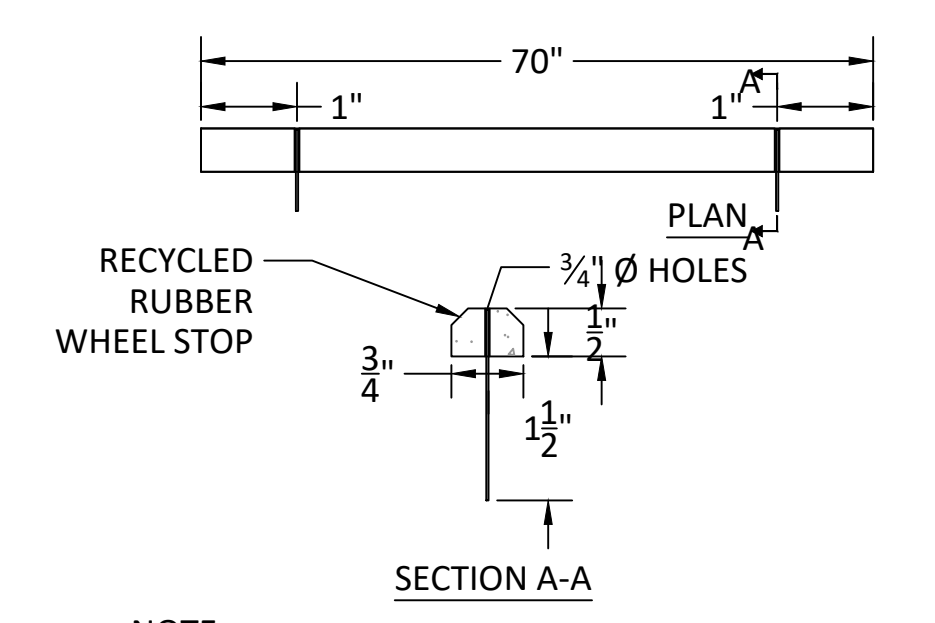


NOTE:
ANCHOR PARKING BLOCK AT EACH END WITH A 1/2" x 24", No. 4 REINFORCING BAR


3 WHEEL STOP DETAIL
C-36 1:1

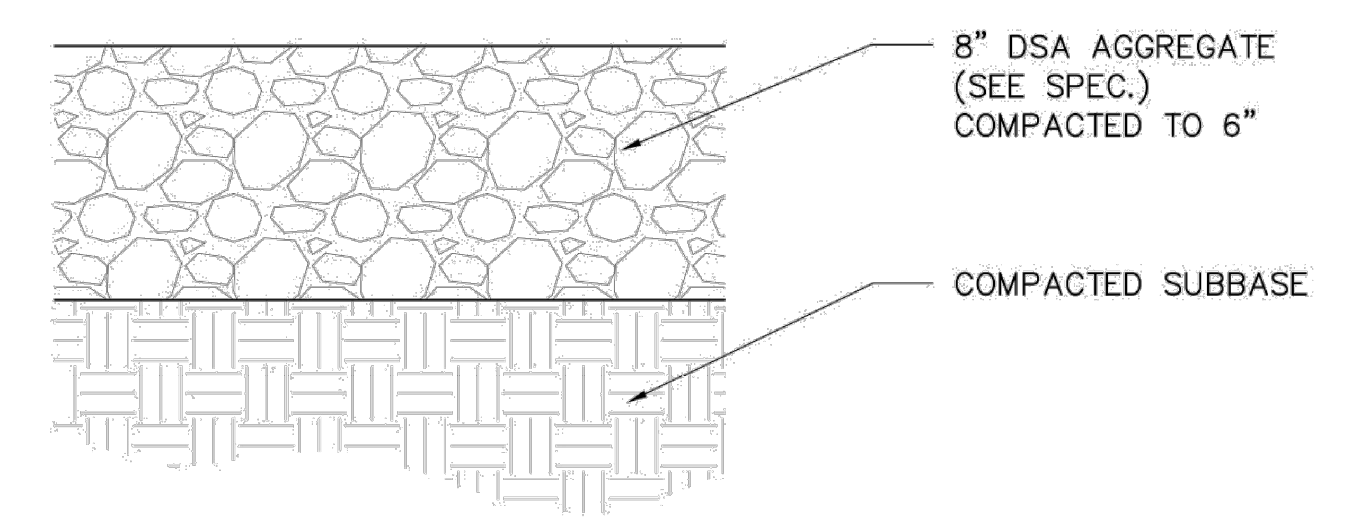

4 DRIVING SURFACE AGGREGATE
C-36 N.T.S.

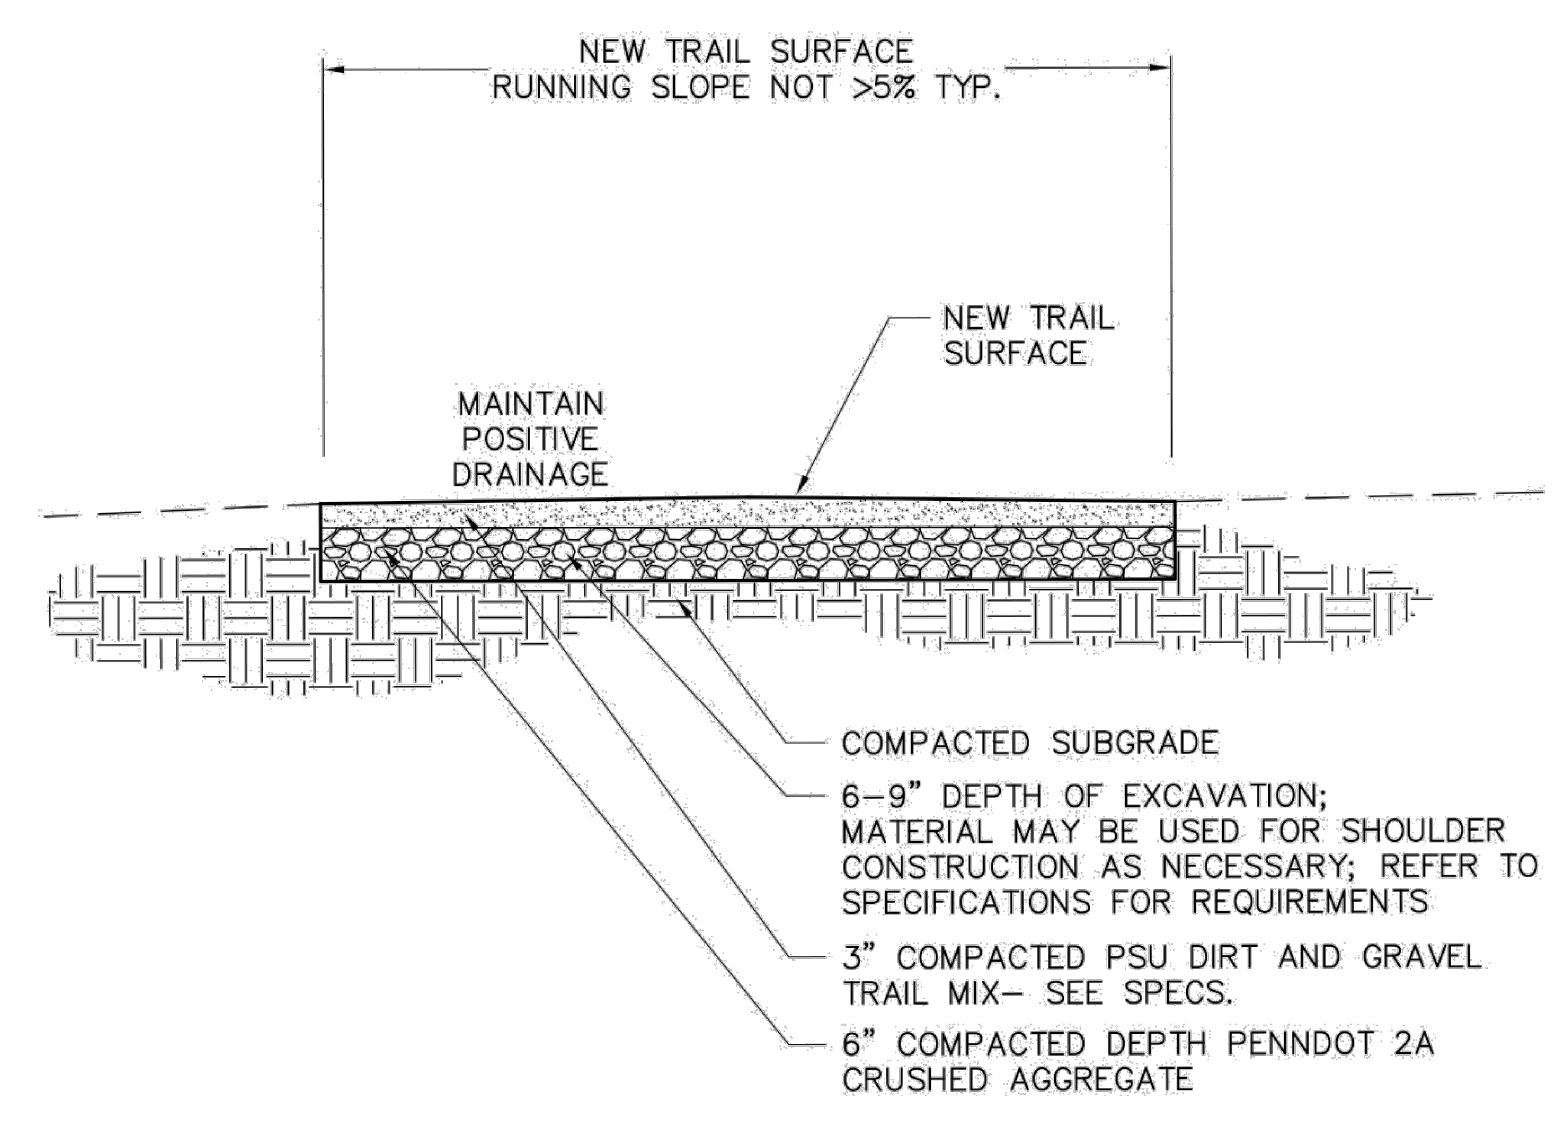

5 TYPICAL TRAIL SURFACE AGGREGATE
C-36 N.T.S.

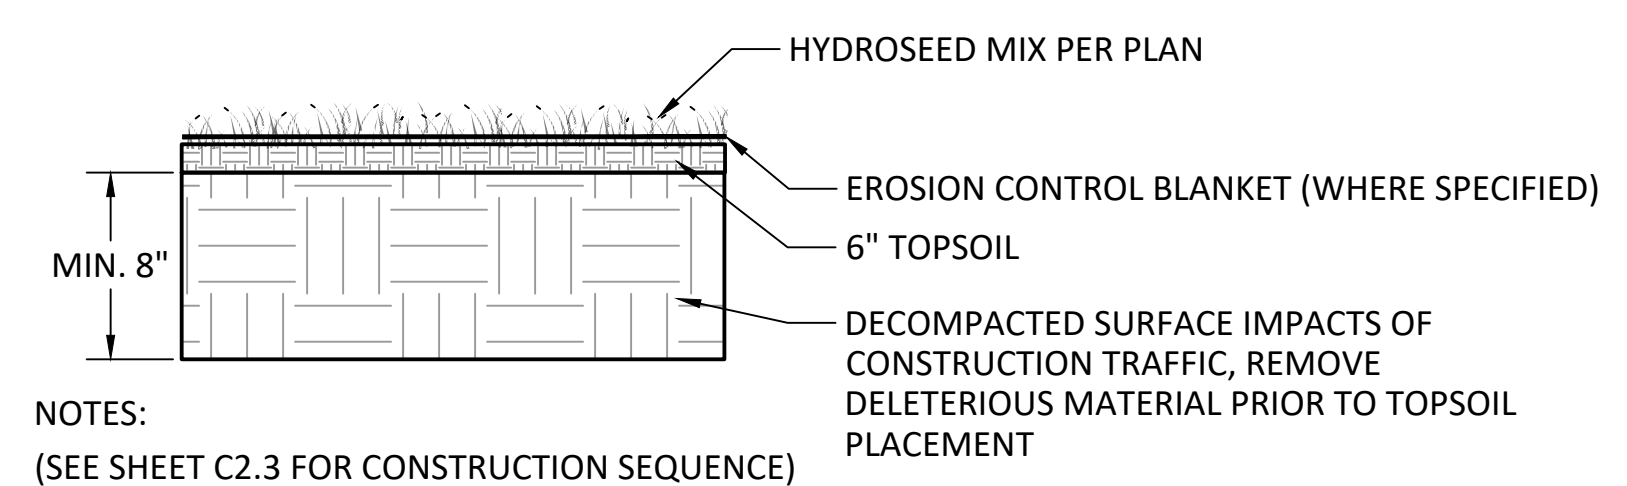


- NOTES:
(SEE SHEET C2.3 FOR CONSTRUCTION SEQUENCE)
1. PREPARE THE SITE FOR SEEDING BY REMOVING WEEDS, INVASIVE SPECIES AND OTHER UNDESIRABLE VEGETATION.
2. RESTORE AND DECOMPACT SOILS TO BE SEEDED. ROTOTILL, OR RIP THE SUBGRADE, REMOVE ROCKS.
3. REPLACE STOCKPILES TOPSOIL. CONTRACTOR TO SUPPLEMENT WITH IMPORTED TOPSOIL ONLY AS NECESSARY TO ACHIEVE CONSISTENT DEPTH PER PLAN.
4. SEED MIX SHALL BE PER PLAN. SEEDING RATE SHOULD BE 20 LB PER ACRE, OR 1/2 LB PER 1,000 SQ. FT.
5. RAKE SEED LIGHTLY INTO TOP 1/8 INCH OF SOIL, ROLL LIGHTLY, AND WATER WITH FINE SPRAY.
6. APPLY EROSION CONTROL BLANKET PER PLAN.

6 LANDSCAPE RESTORATION
C-36 NTS

CONSTRUCTION DOCUMENTS



RECORD REVISIONS

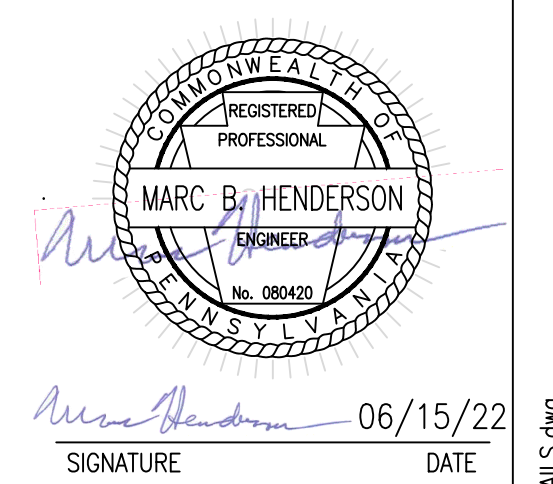

SMP ARCHITECTS
1600 WALNUT STREET, SECOND FLOOR
PHILADELPHIA, PENNSYLVANIA

COMMONWEALTH OF PENNSYLVANIA
DEPARTMENT OF GENERAL SERVICES
HARRISBURG, PENNSYLVANIA

D.G.S. PROJECT No.
C-114-0006 PHASE 1


HICKORY RUN STATE PARK
LATRINE IMPROVEMENTS
DEPT of CONSERVATION AND NATURAL RESOURCES
WHITE HAVEN, CARBON COUNTY, PA

VERIFY SCALE
BAR IS ONE (1) INCH LONG ON ORIGINAL DRAWING:
0 1
IF BAR IS NOT ONE (1) INCH LONG, ADJUST SCALE ACCORDINGLY


SITE DETAILS

CONTRACTOR SHALL FIELD VERIFY ALL DIMENSIONS. VARIANCE FROM CONTRACT DOCUMENTS NOT PERMITTED WITHOUT PROFESSIONAL & BUREAU OF CONSTRUCTION APPROVAL.	DRAWN BY L GILL	DATE 06/17/2022	DRAWING No. C-36
	CHECKED BY M HENDERSON	SCALE AS NOTED	

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LAST SAVED: 2022.06.15 04:20 PM PLOTTED BY: Laura L. Gill LAYOUT TAB: SITE DETAILS

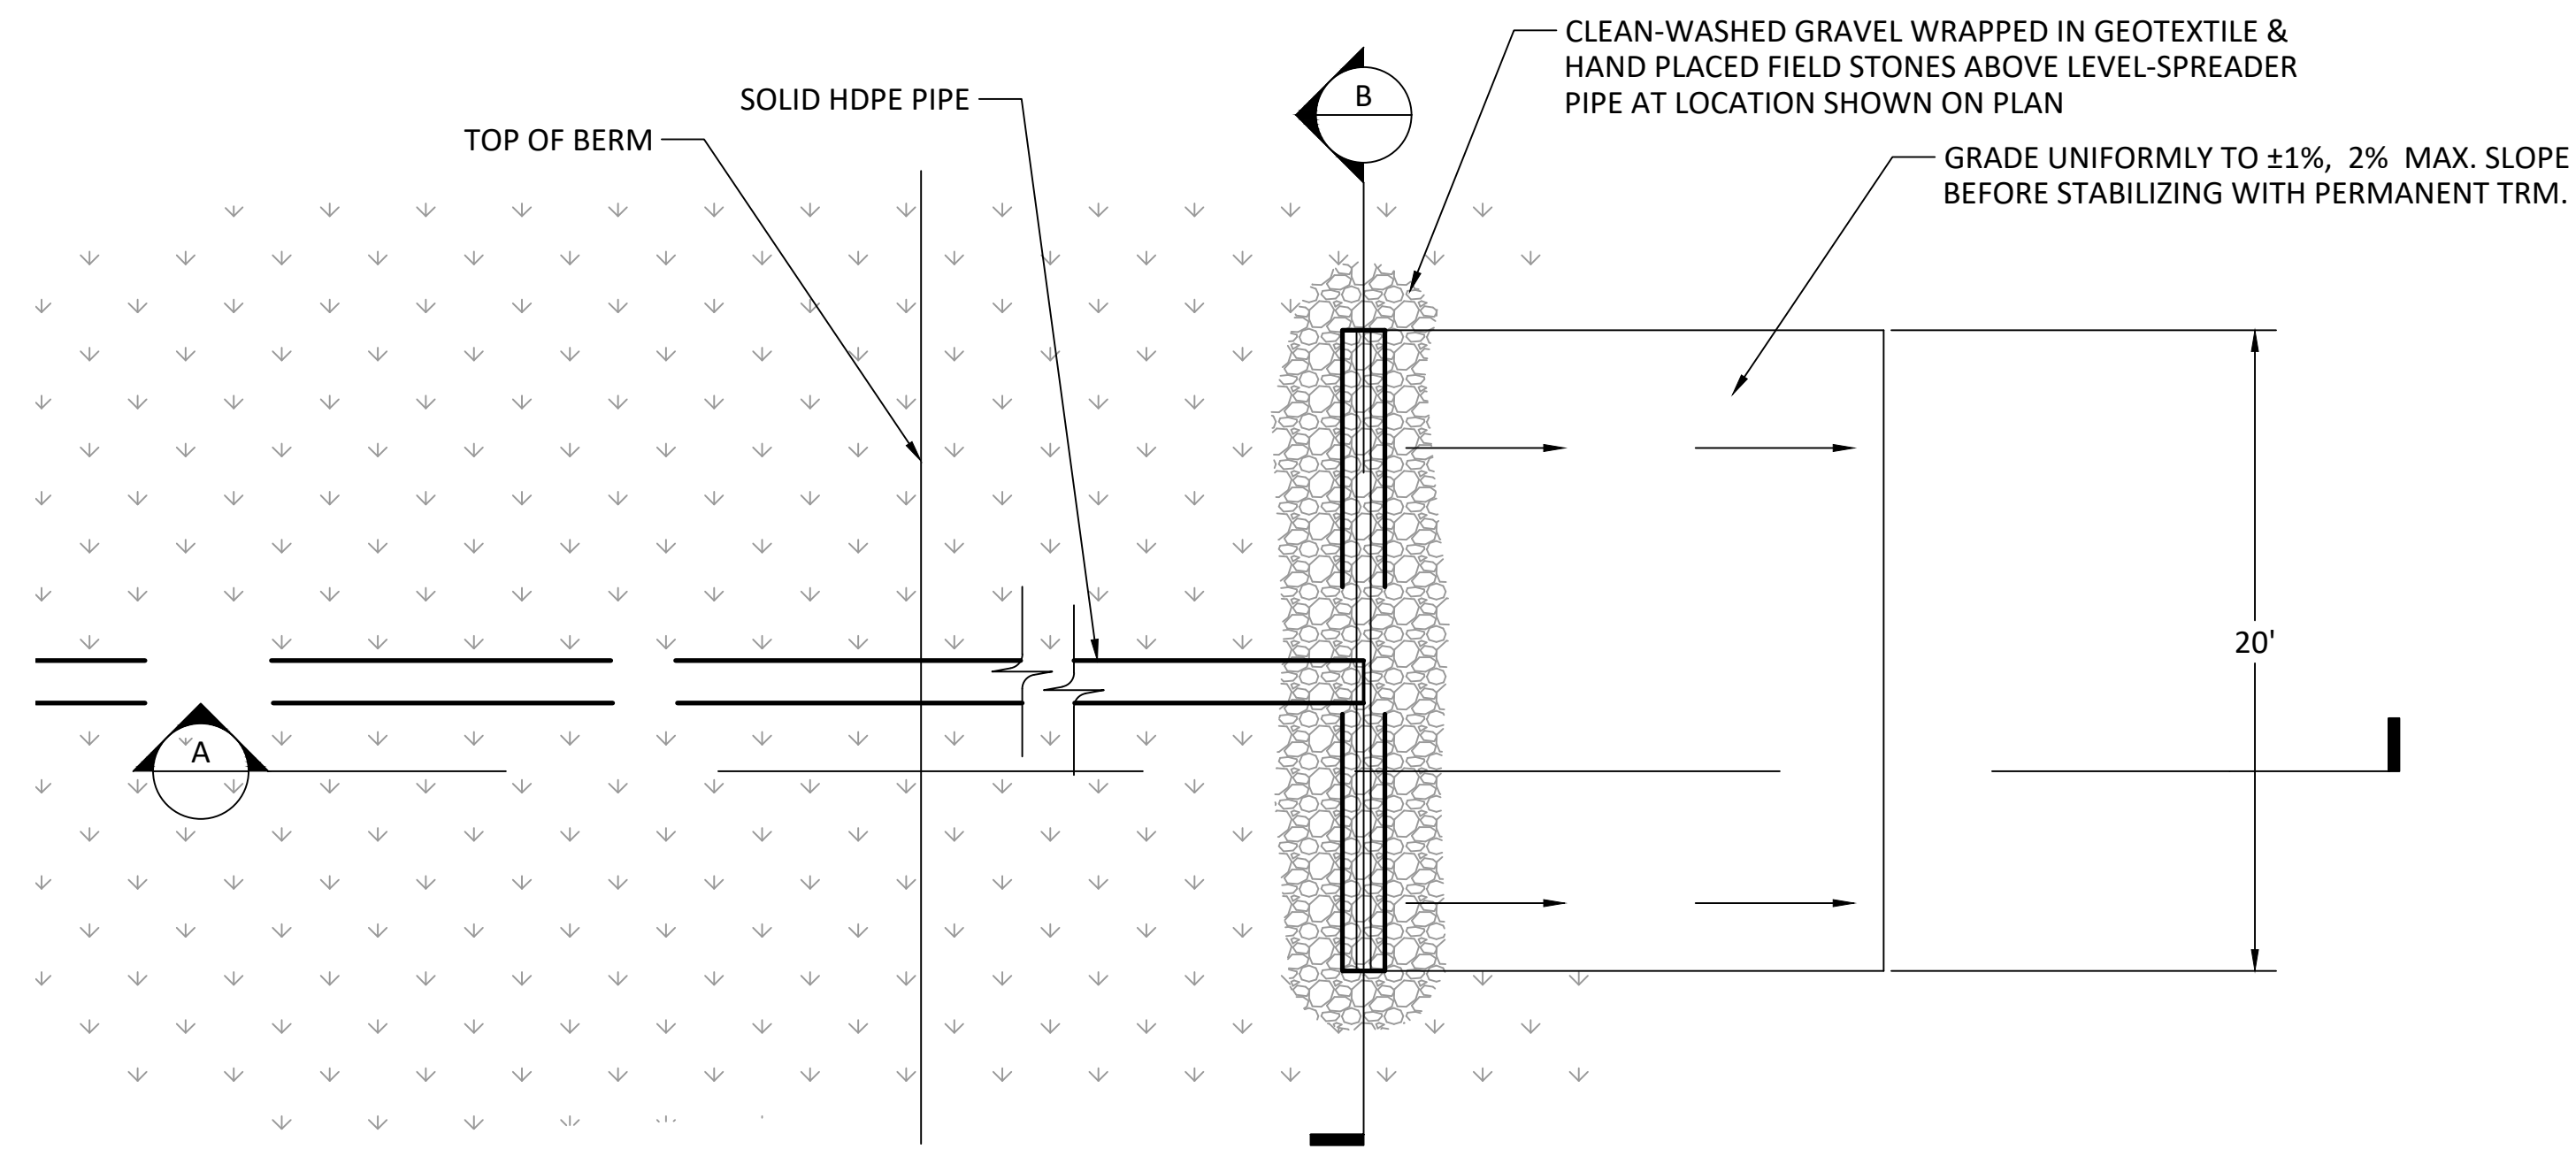


1 LEVEL SPREADER DETAIL
1/2"=1'-0"
NOTE: PROVIDE TEMPORARY STABILIZATION OF ALL DISTURBED AREAS DOWN GRADIENT OF LEVEL SPREADERS AS INDICATED ON PLANS.

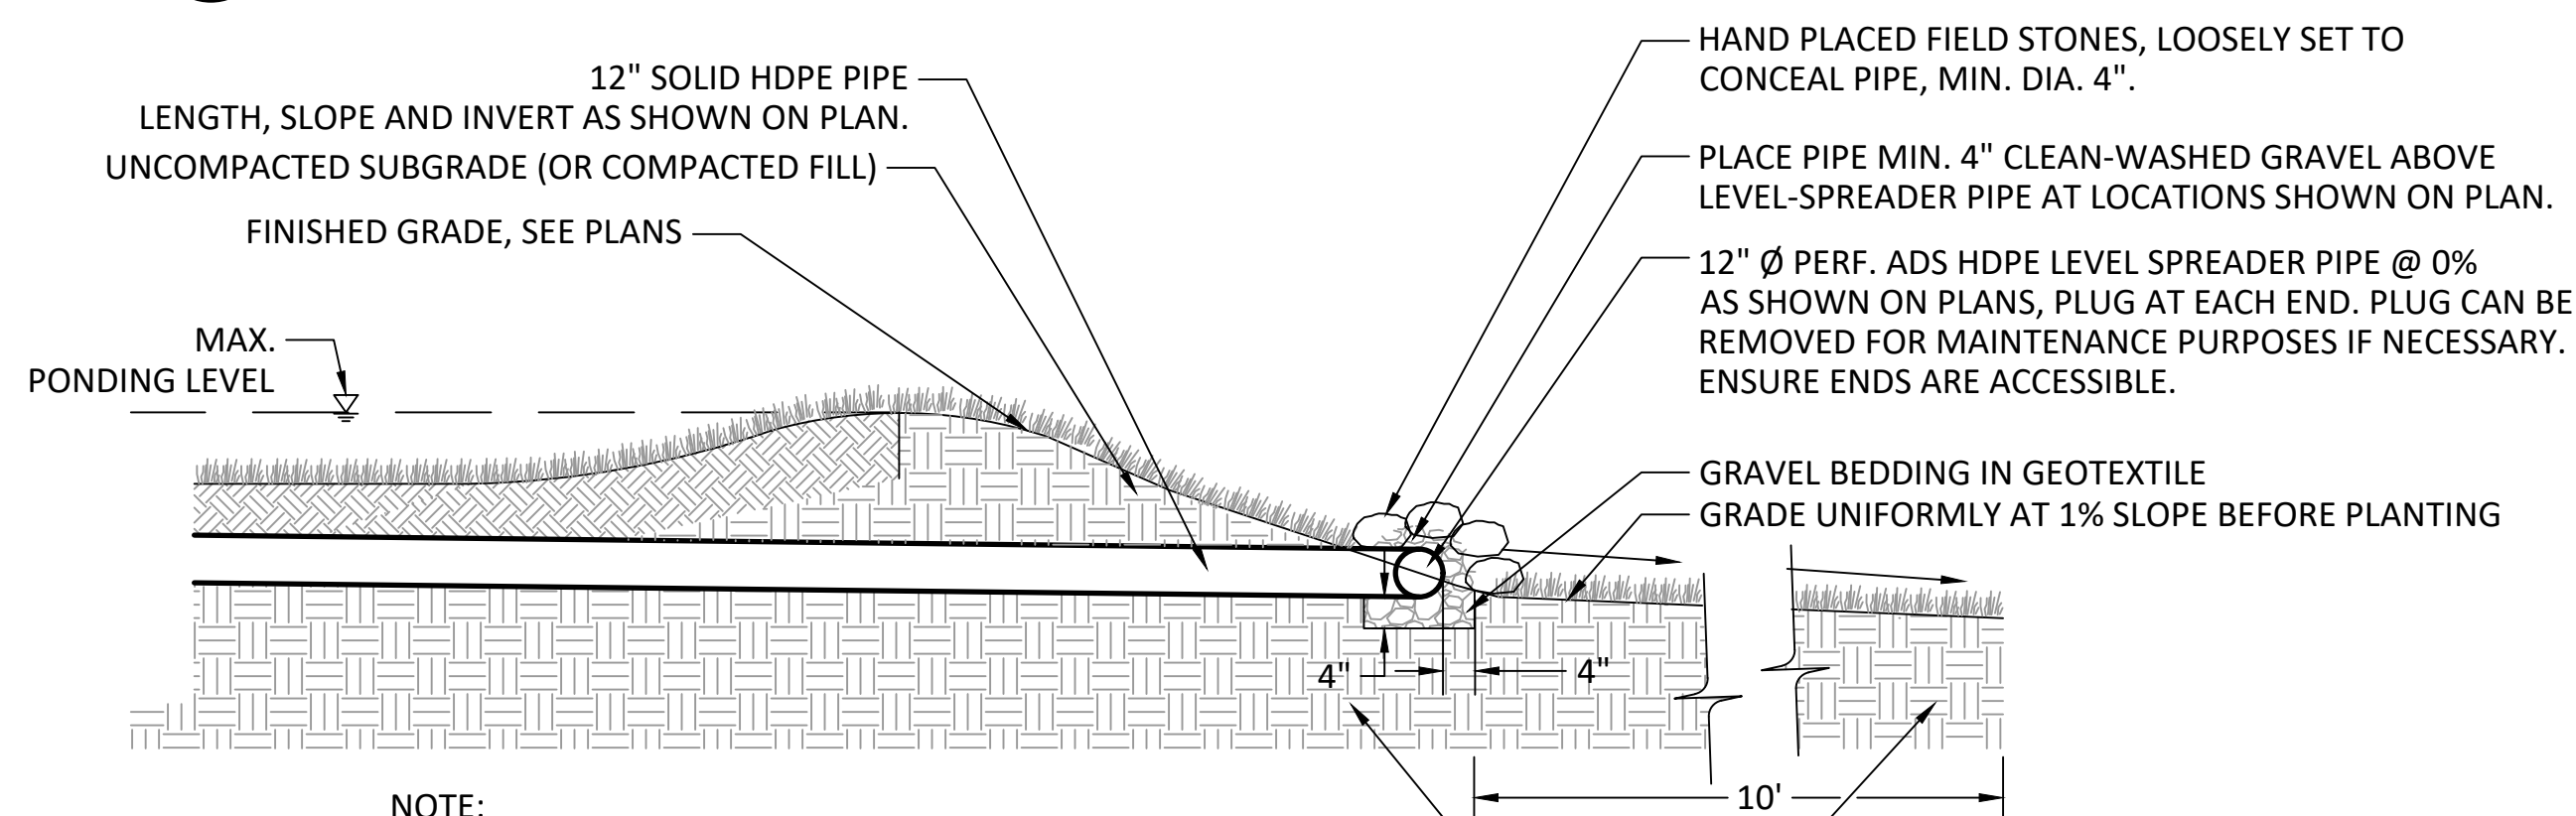

- NOTE:
1. LEVEL SPREADER EXCAVATED SUBGRADE MUST BE LEVEL AND UNCOMPACTED.
2. TEST PIPE PLACEMENT TO CONFIRM LEVEL INSTALLATION PRIOR TO PLACING GRAVEL ABOVE PIPE.

A LEVEL SPREADER PROFILE A-A
1/2"=1'-0"

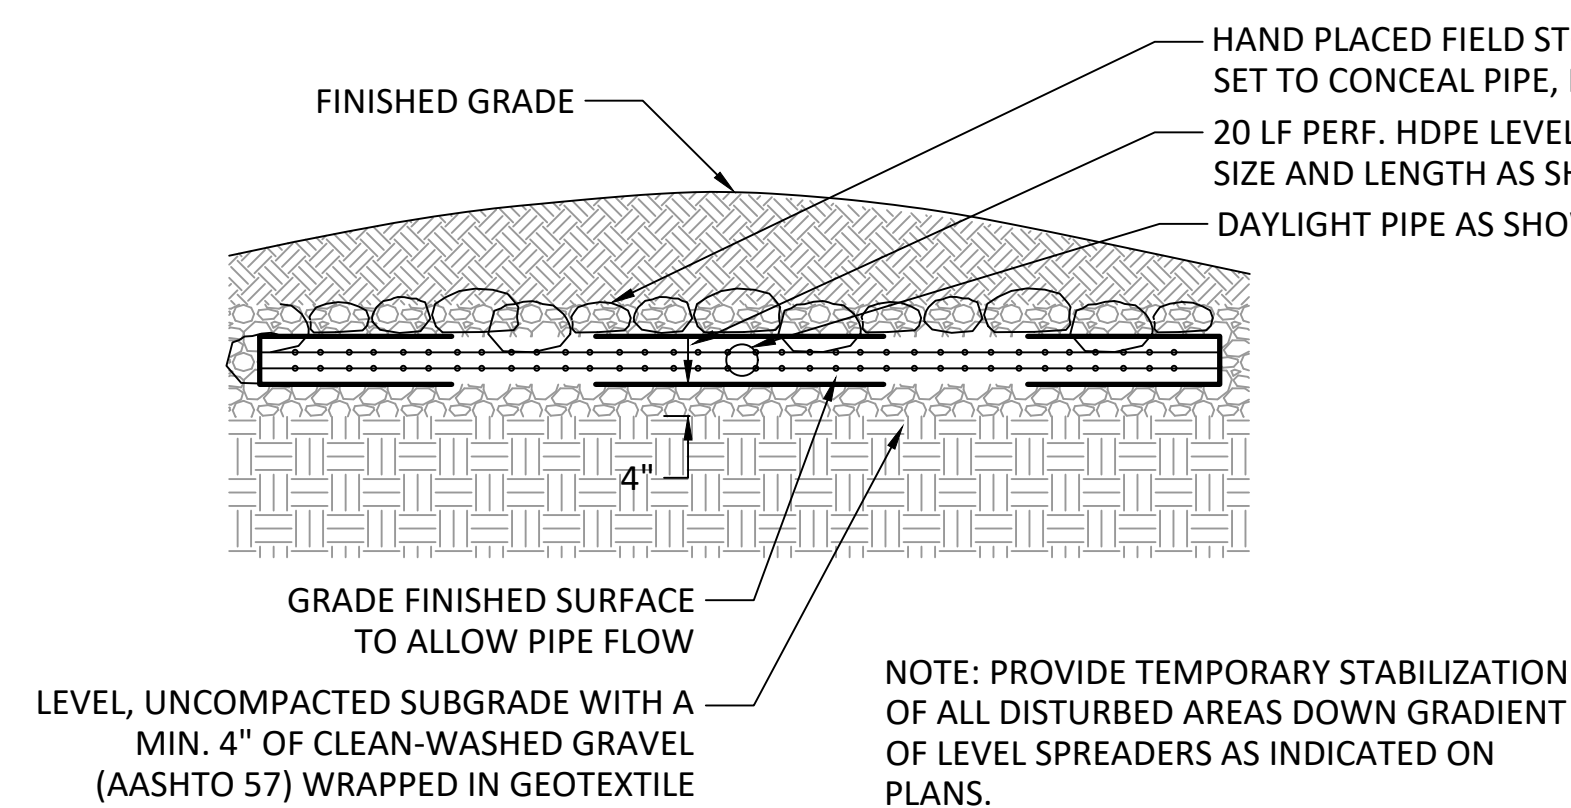


- NOTES:
1. ALL AGGREGATES WITHIN THE STONE STORAGE BED SHALL BE CLEAN-WASHED, DEFINED AS HAVING LESS THAN 0.5% WASH LOSS, BY MASS, WHEN TESTED PER THE AASHTO T-11 WASH LOSS TEST.
2. GEOTEXTILE SHALL CONSIST OF POLYPROPYLENE FIBERS AND MEET THE FOLLOWING SPECIFICATIONS:

GRAB TENSILE STRENGTH (ASTM-D4632) > OR = 120 LBS.
MULLEN BURST STRENGTH (ASTM-D3786) > OR = 225 LBS.
FLOW RATE (ASTM-D4491) > OR = 95 GAL./MIN./FT²
UV RESISTANCE AFTER 500 HRS. (ASTM-D4355) > OR = 70%
HEAT-SET OR HEAT CALENDARED FABRICS ARE NOT PERMITTED


B LEVEL SPREADER PROFILE B-B
1/2"=1'-0"

SITE	LENGTH (FT)	DOWNSTREAM DISTANCE TO DRAINAGE COURSE (FT.)	DOWNSTREAM SLOPE (%)	DRAINAGE AREA (AC.)
LOOP C	20	308	4.3%	0.27
OGTC	20	530	5.7%	0.16
DADDY ALLEN	20	110	7.2%	0.37

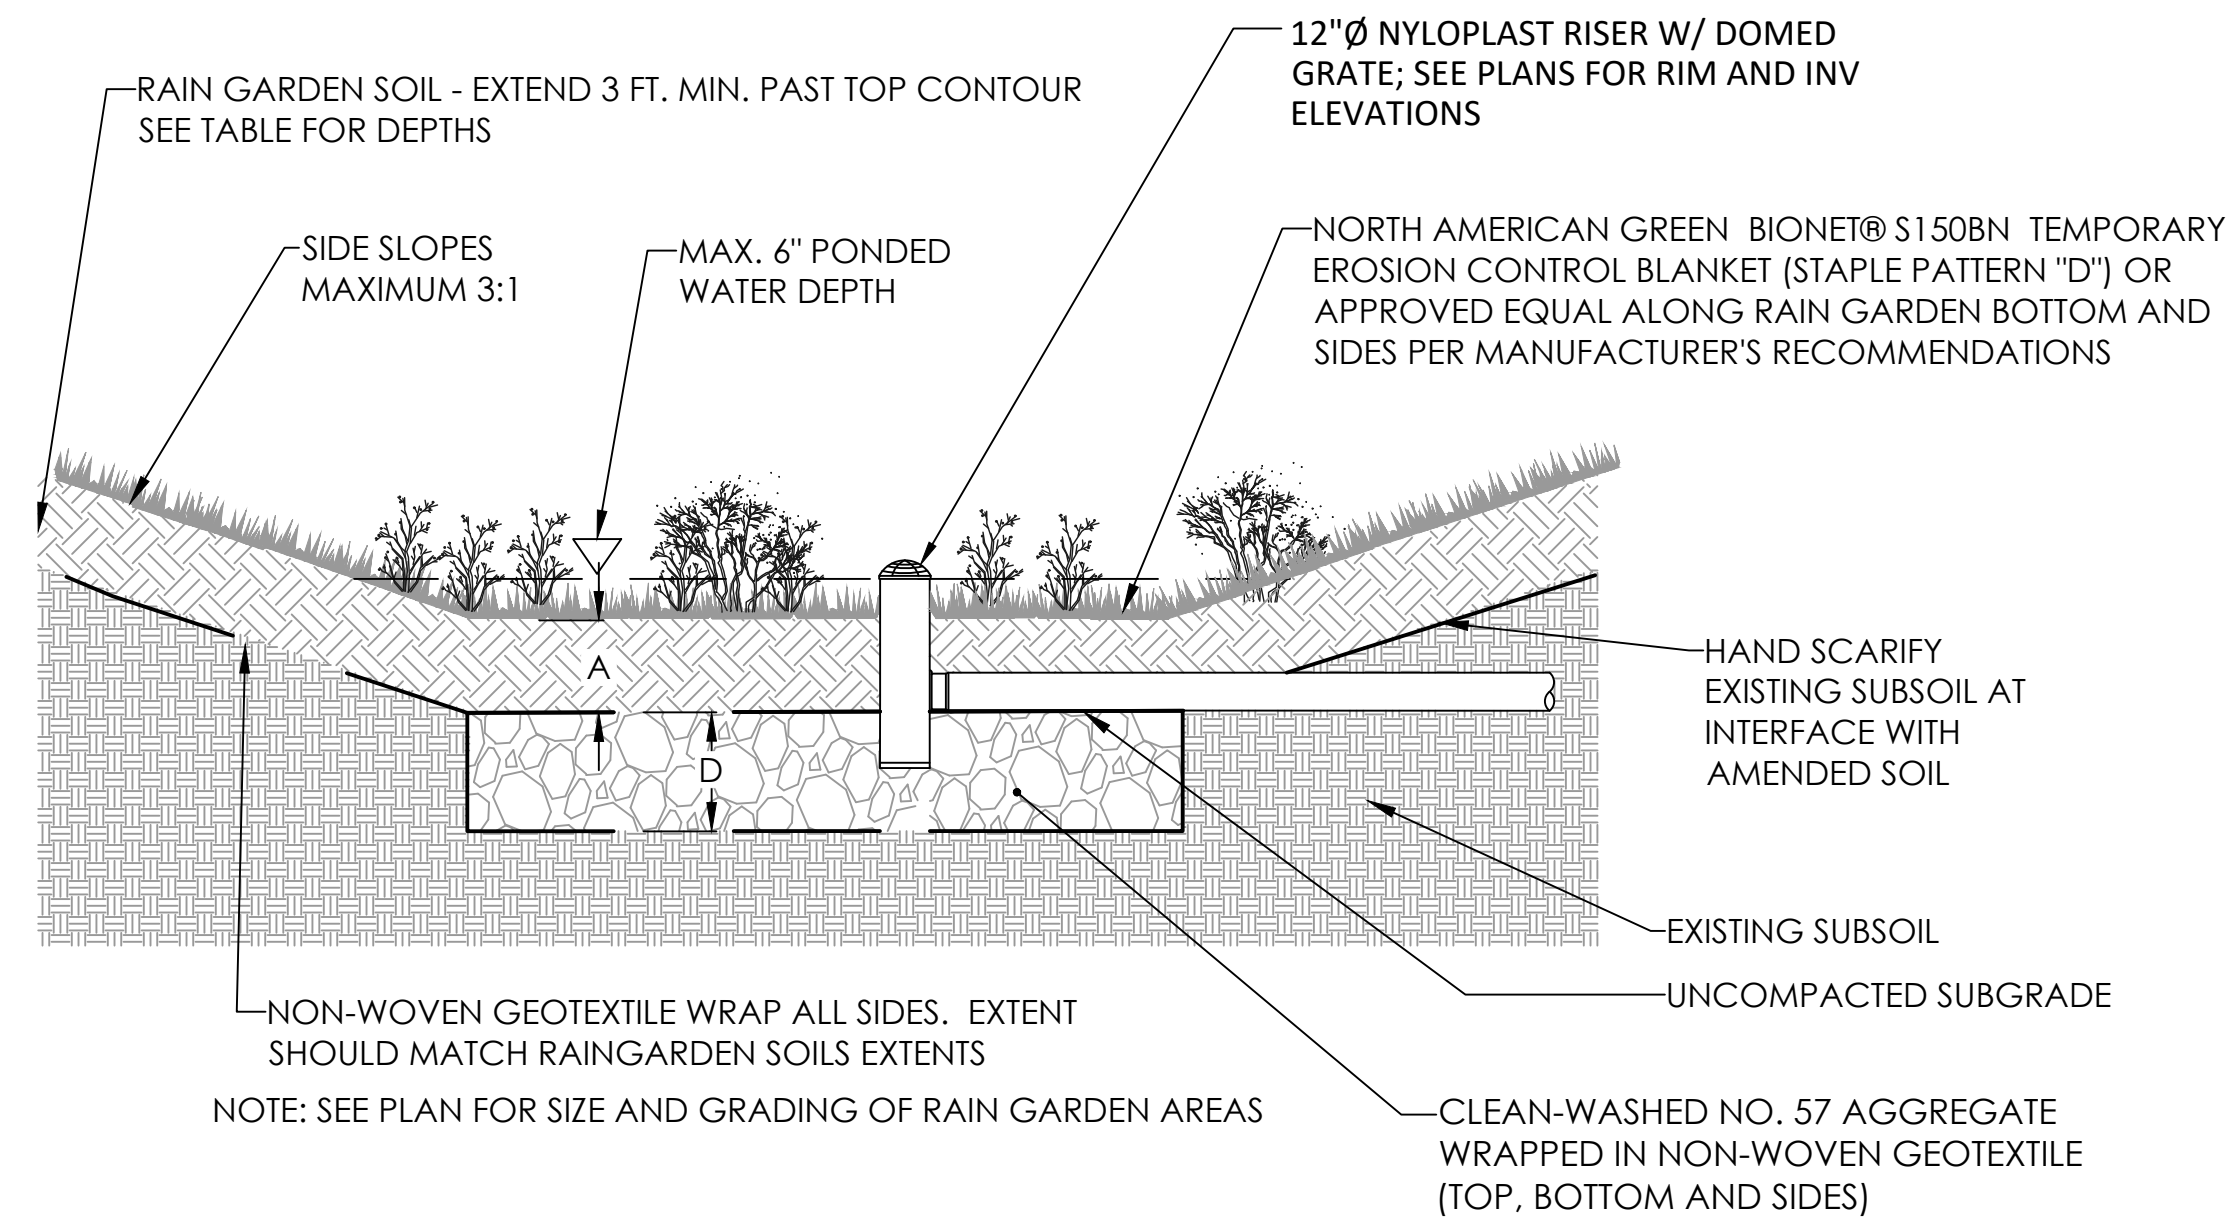

SITE	RAIN GARDEN STONE DEPTH, D (IN.)	RAIN GARDEN SOIL DEPTH, A (IN.)
OGTC	24	24
DADDY ALLEN	24	24
SHEHAQUA	0	12

2 RAIN GARDEN
NTS


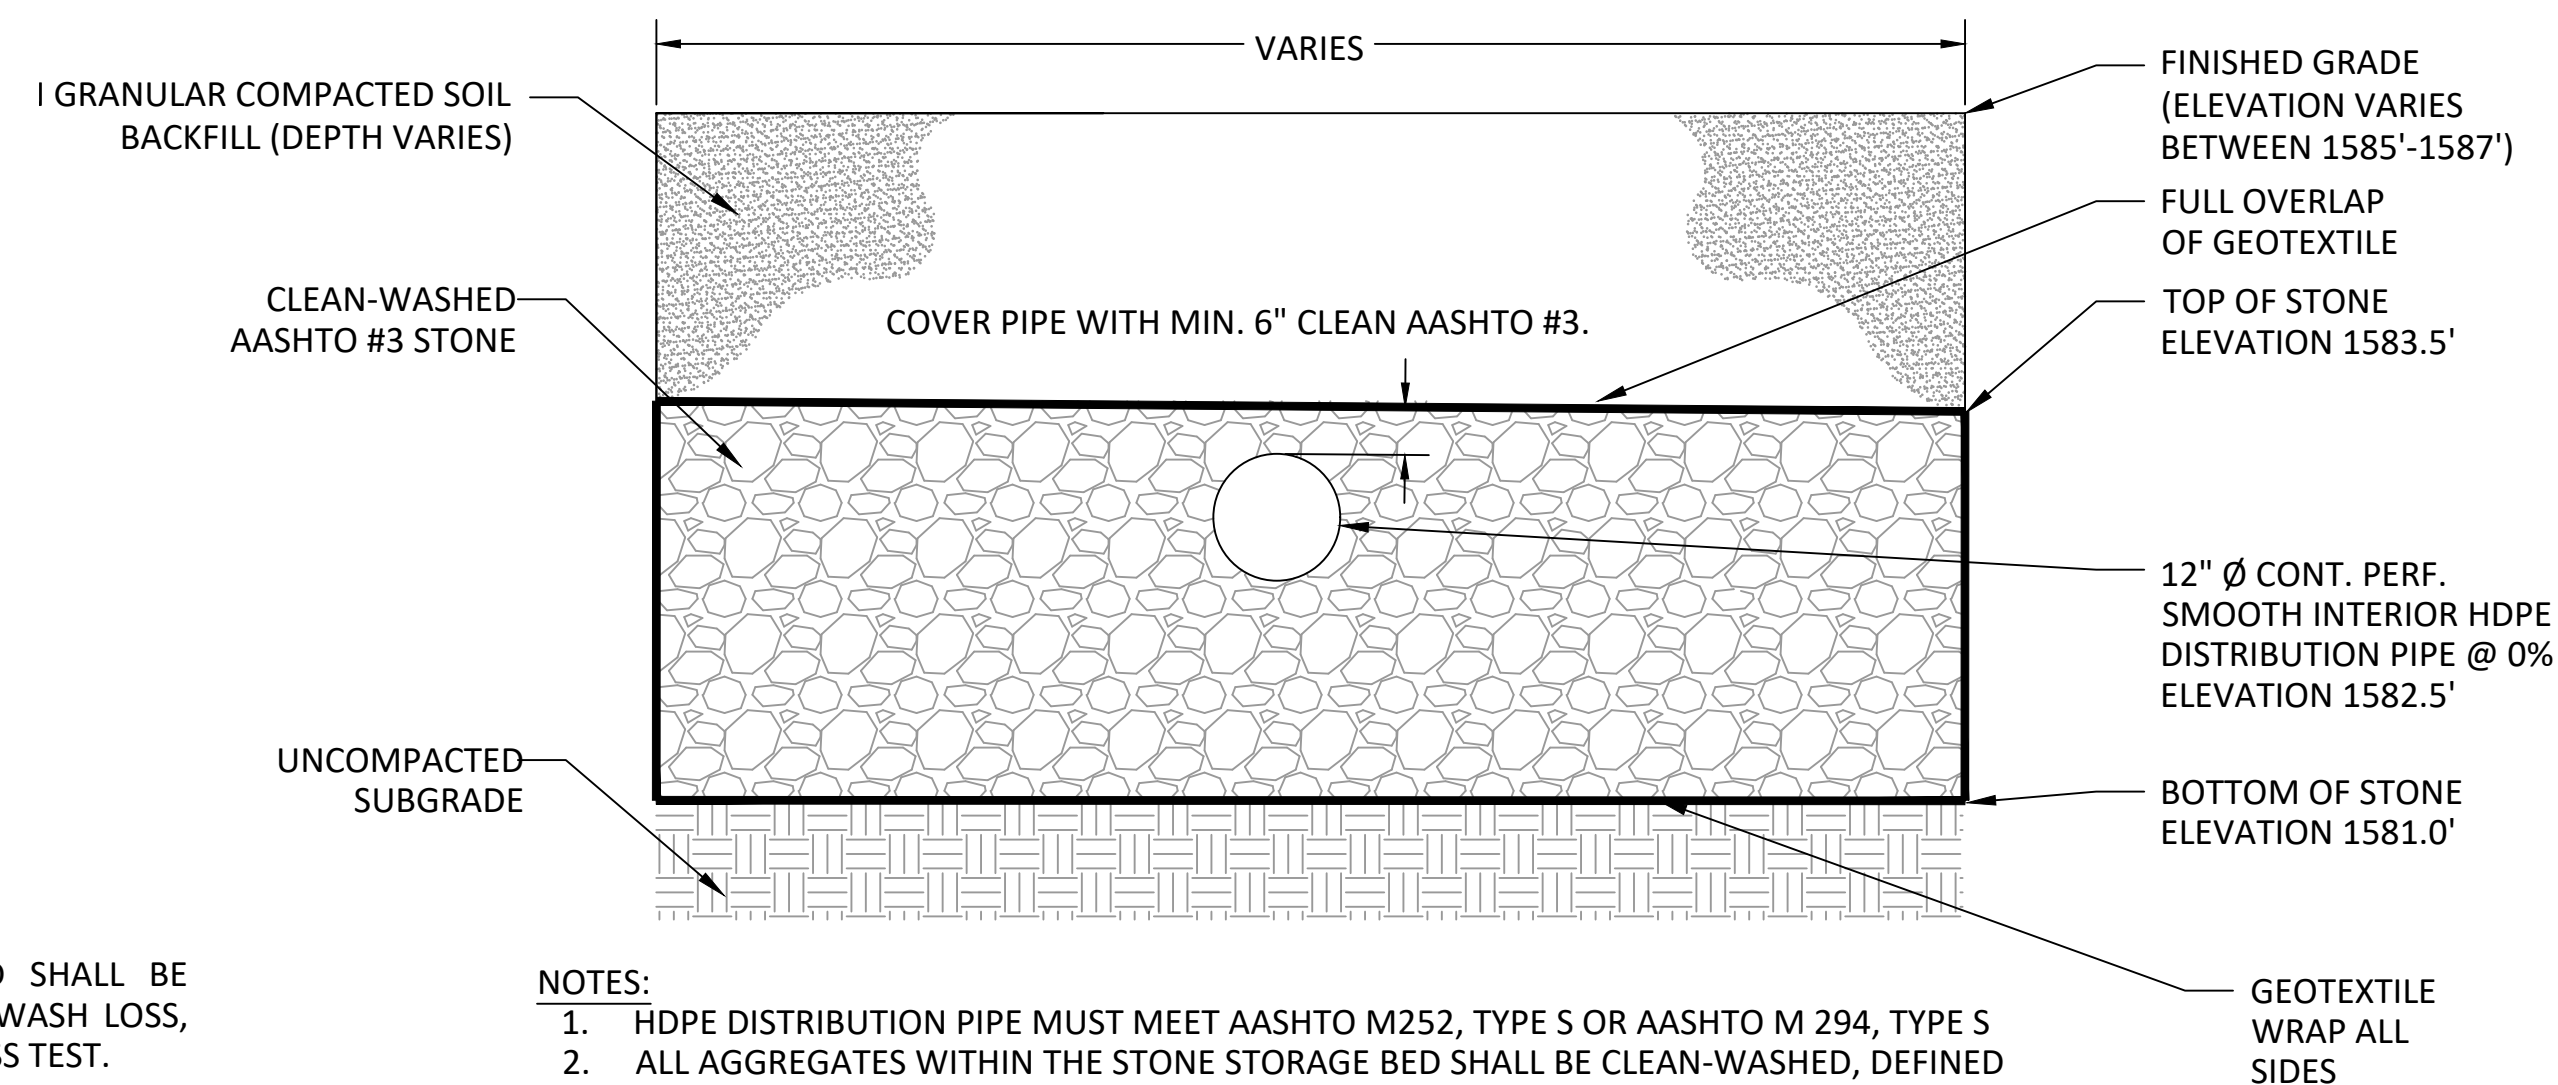


- NOTES:
1. HDPE DISTRIBUTION PIPE MUST MEET AASHTO M252, TYPE S OR AASHTO M 294, TYPE S
2. ALL AGGREGATES WITHIN THE STONE STORAGE BED SHALL BE CLEAN-WASHED, DEFINED AS HAVING LESS THAN 0.5% WASH LOSS, BY MASS, WHEN TESTED PER THE AASHTO T-11 WASH LOSS TEST.
3. GEOTEXTILE SHALL CONSIST OF POLYPROPYLENE FIBERS AND MEET THE FOLLOWING SPECIFICATIONS:


GRAB TENSILE STRENGTH (ASTM-D4632) > OR = 120 LBS.
MULLEN BURST STRENGTH (ASTM-D3786) > OR = 225 LBS.
FLOW RATE (ASTM-D4491) > OR = 95 GAL./MIN./FT²
UV RESISTANCE AFTER 500 HRS. (ASTM-D4355) > OR = 70%
HEAT-SET OR HEAT CALENDARED FABRICS ARE NOT PERMITTED

SITE	INFILTRATION BED STONE DEPTH, D (IN.)
LOOP C	30

3 INFILTRATION BED - LOOP C
NTS

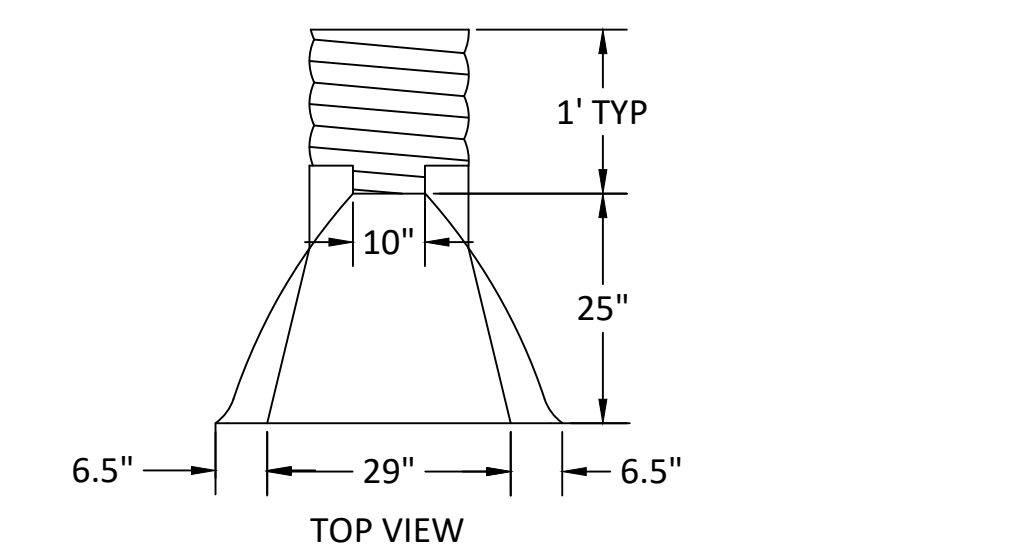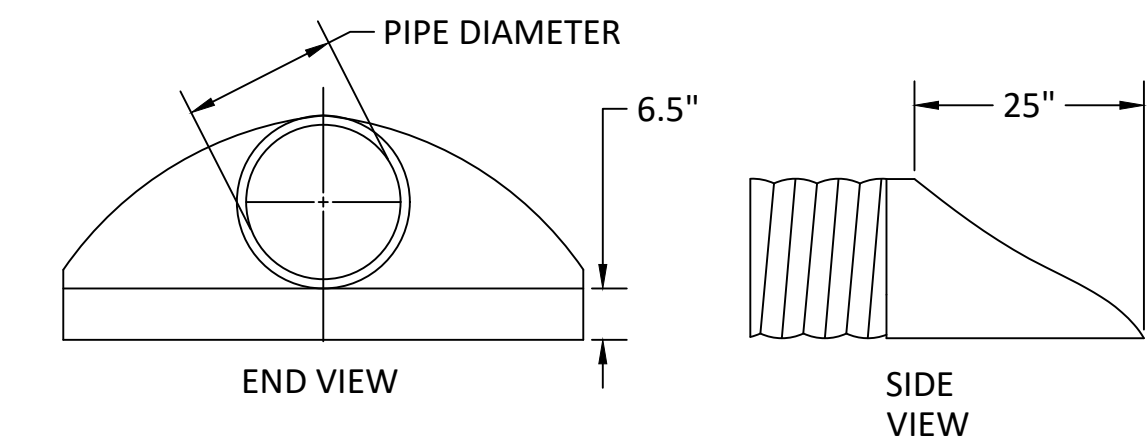

5 HDPE FLARED END SECTION
NTS

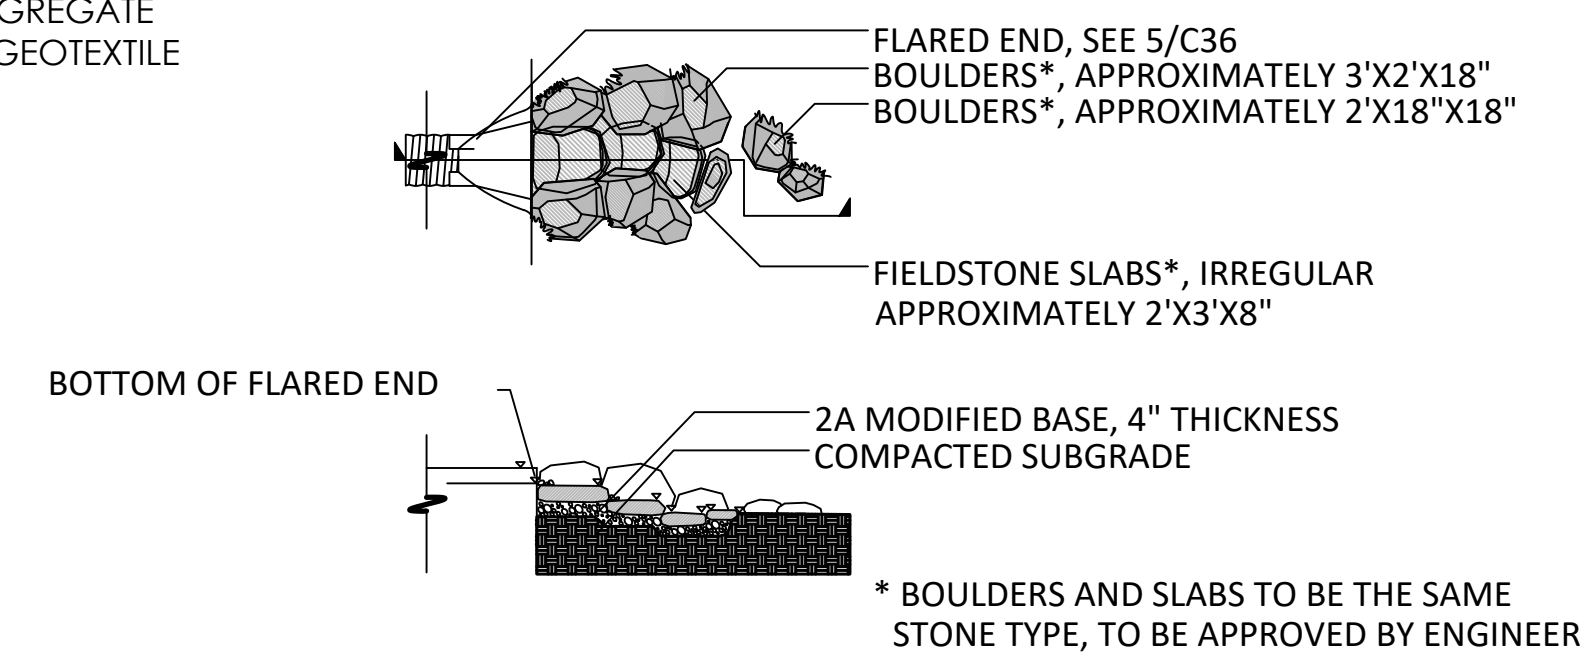


6 SPLASH BLOCK FLARED END
NTS

CONSTRUCTION DOCUMENTS



NO.	REVISION

RECORD REVISIONS

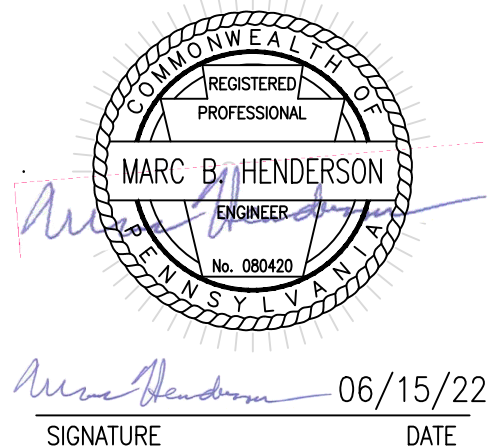

SMP ARCHITECTS
1600 WALNUT STREET, SECOND FLOOR
PHILADELPHIA, PENNSYLVANIA

COMMONWEALTH OF PENNSYLVANIA
DEPARTMENT OF GENERAL SERVICES
HARRISBURG, PENNSYLVANIA







D.G.S. PROJECT No.
C-114-0006 PHASE 1

HICKORY RUN STATE PARK
LATRINE IMPROVEMENTS
DEPT of CONSERVATION AND NATURAL RESOURCES
WHITE HAVEN, CARBON COUNTY, PA


STORMWATER DETAILS - SHEET 1

VERIFY SCALE
BAR IS ONE (1) INCH LONG ON ORIGINAL DRAWING:
0 1
IF BAR IS NOT ONE (1) INCH LONG, ADJUST SCALE ACCORDINGLY
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DRAWN BY L GILL	DATE 06/17/2022	DRAWING No. C-37
CHECKED BY M HENDERSON	SCALE AS NOTED	

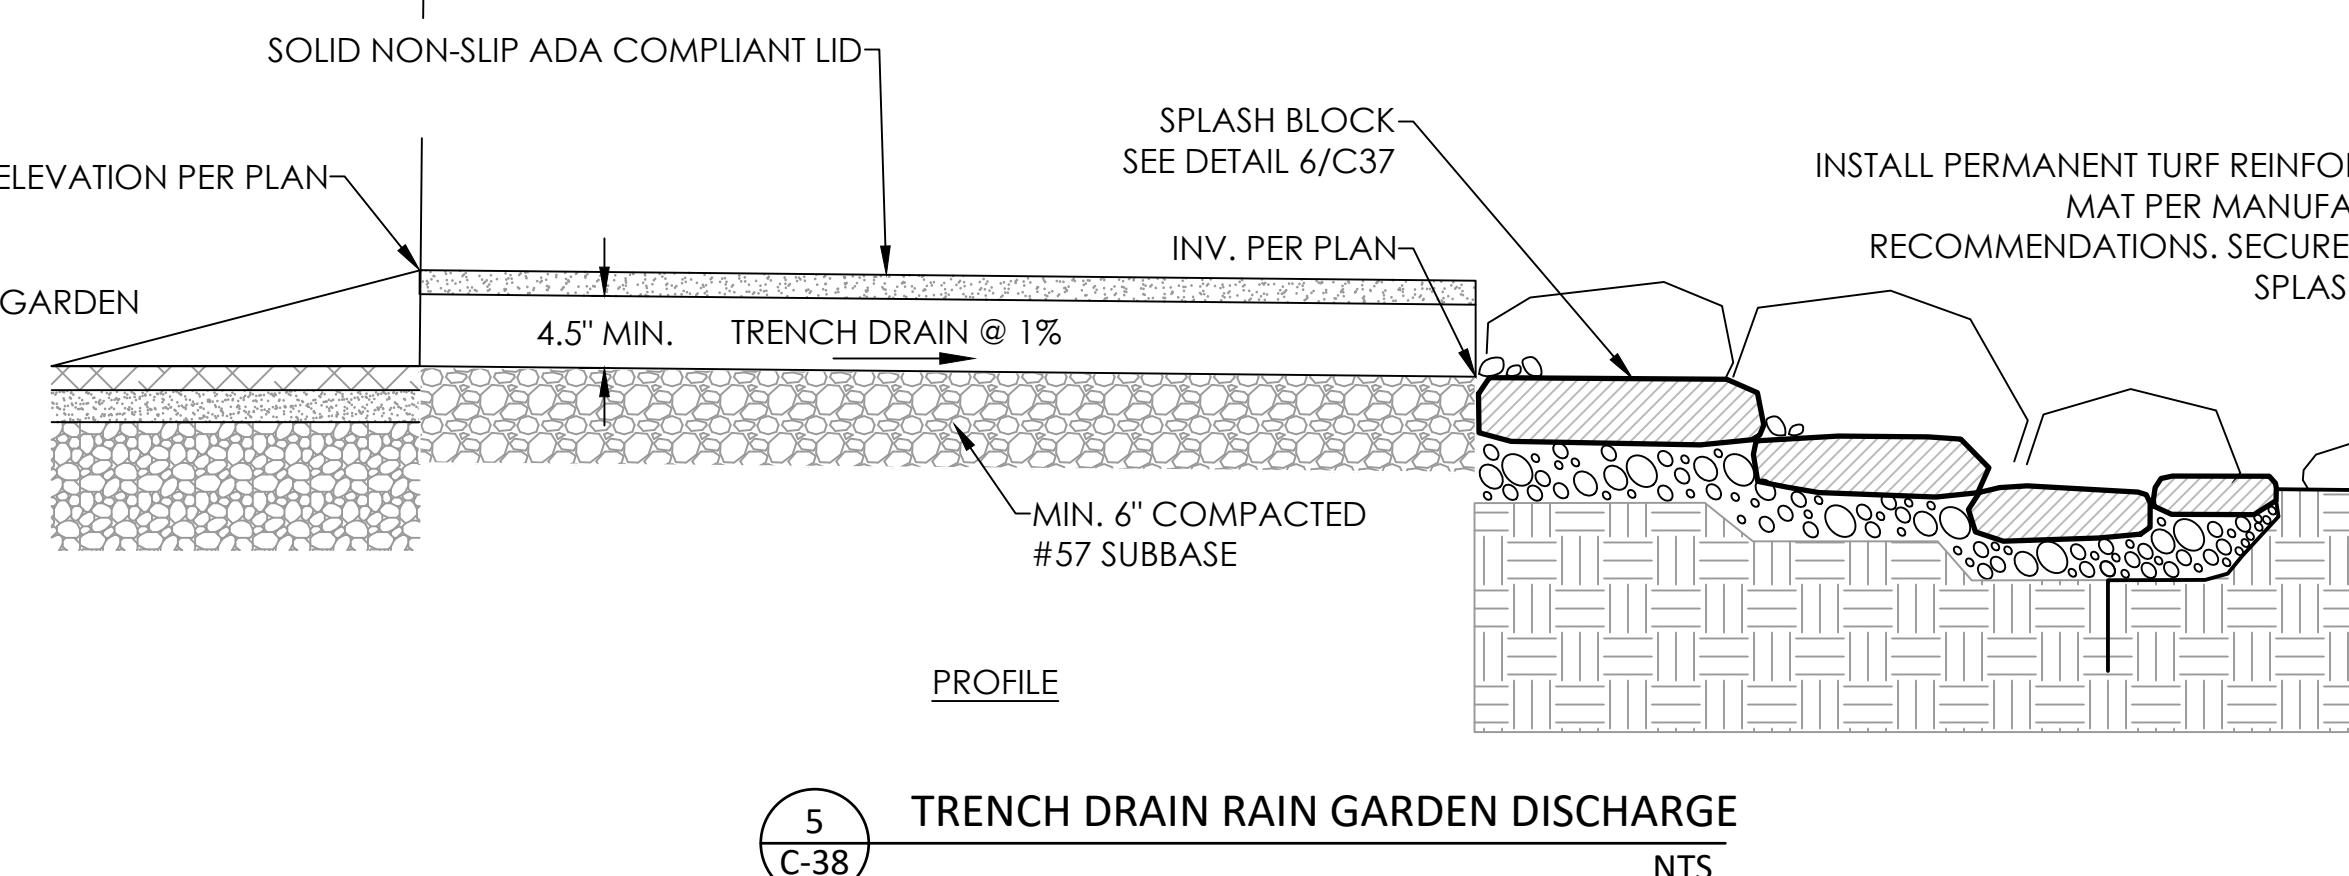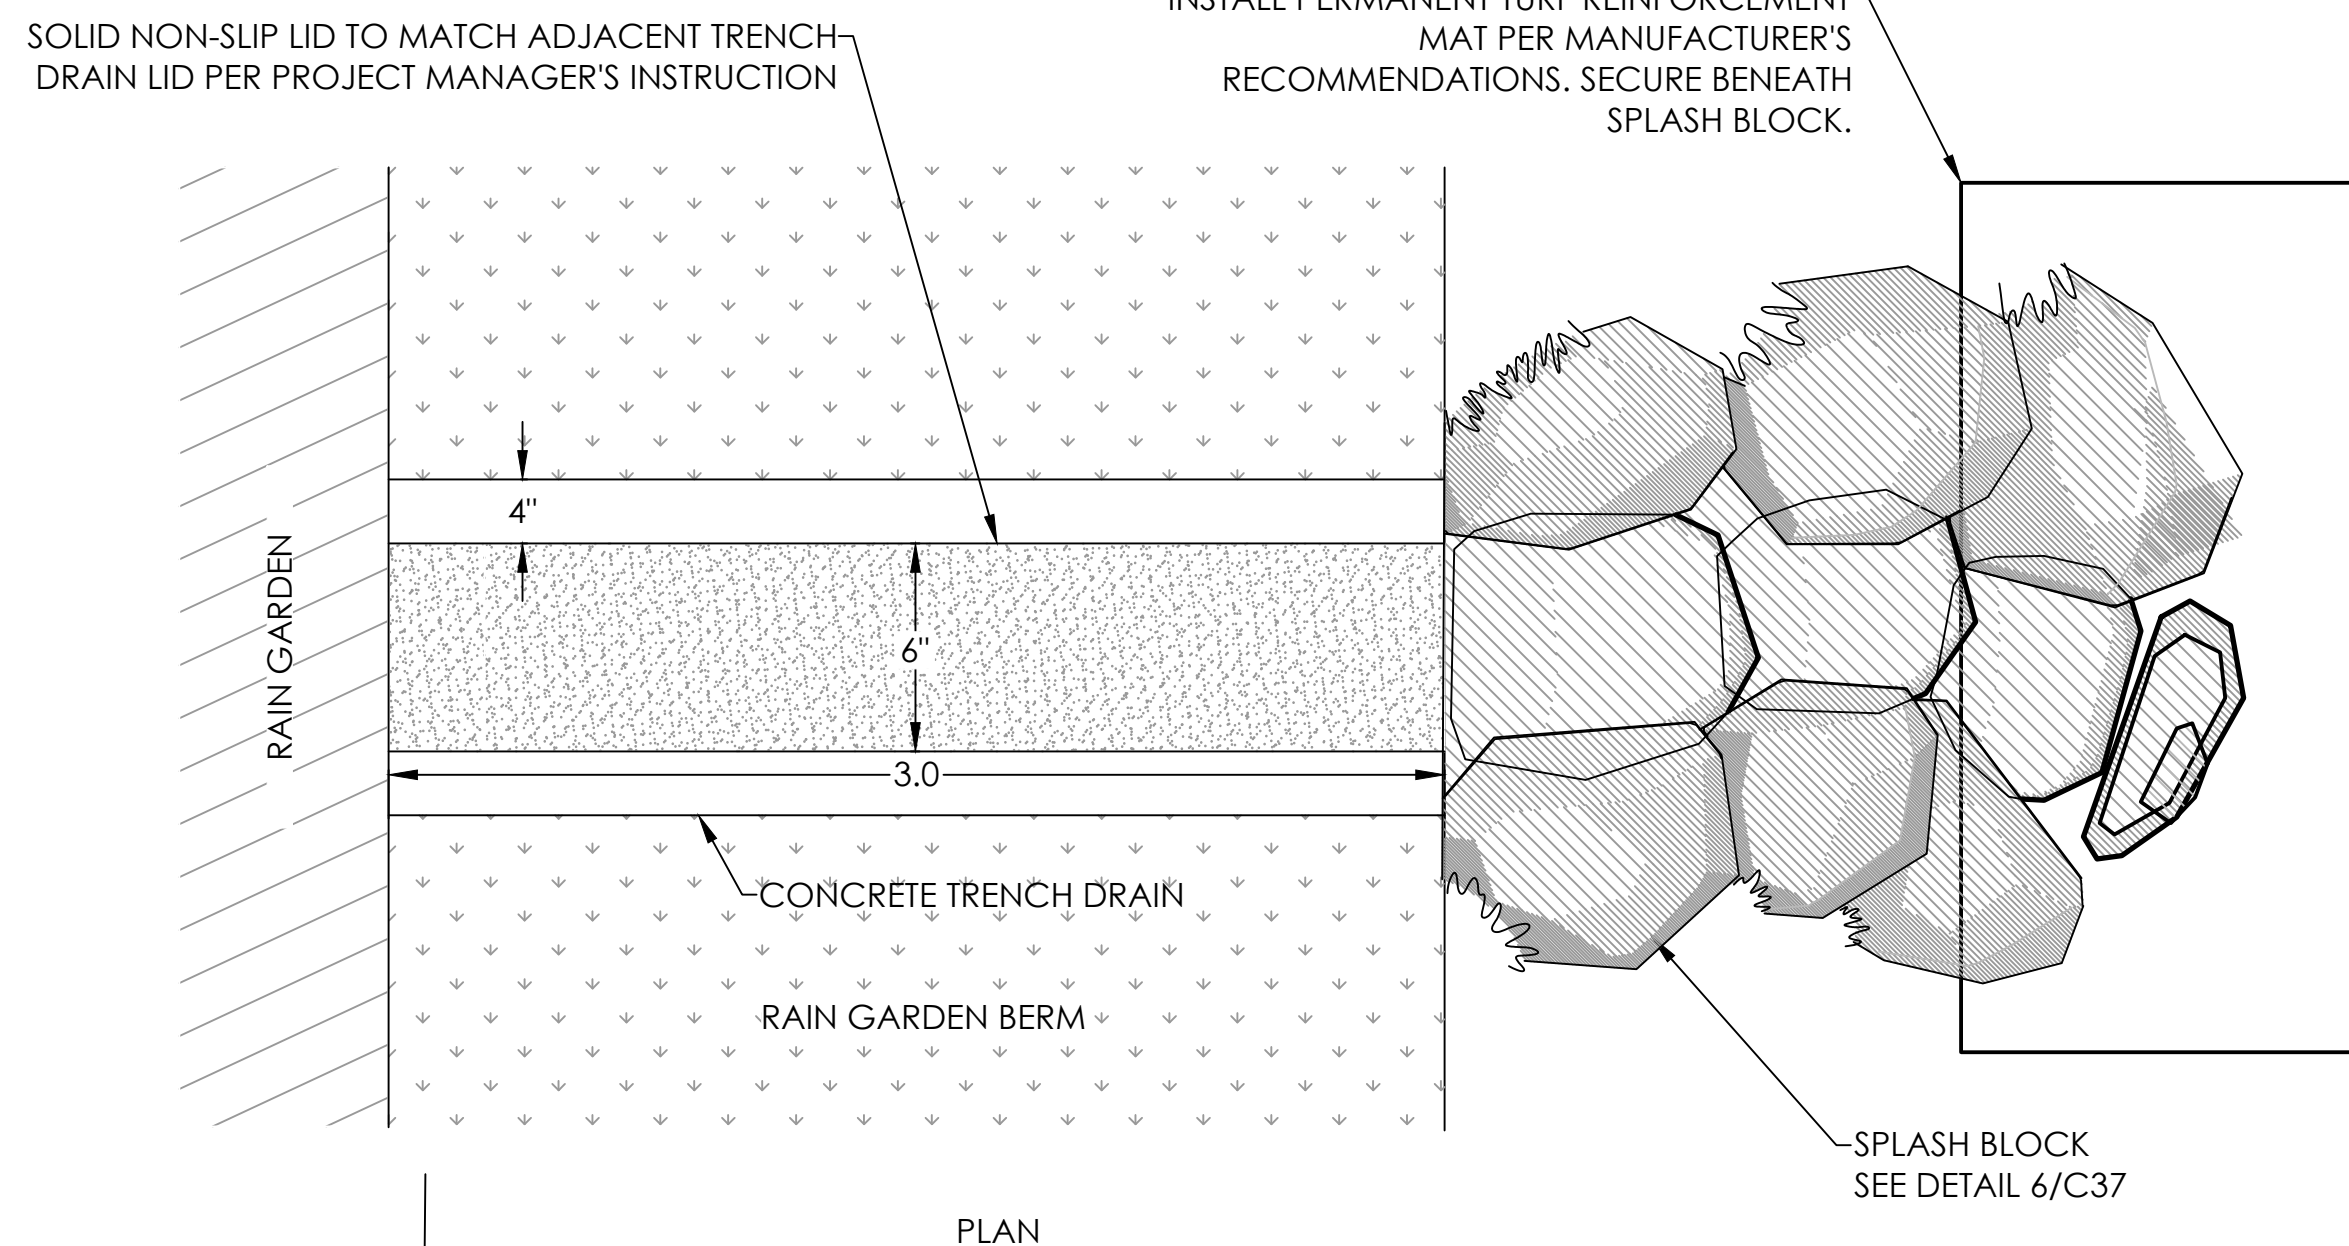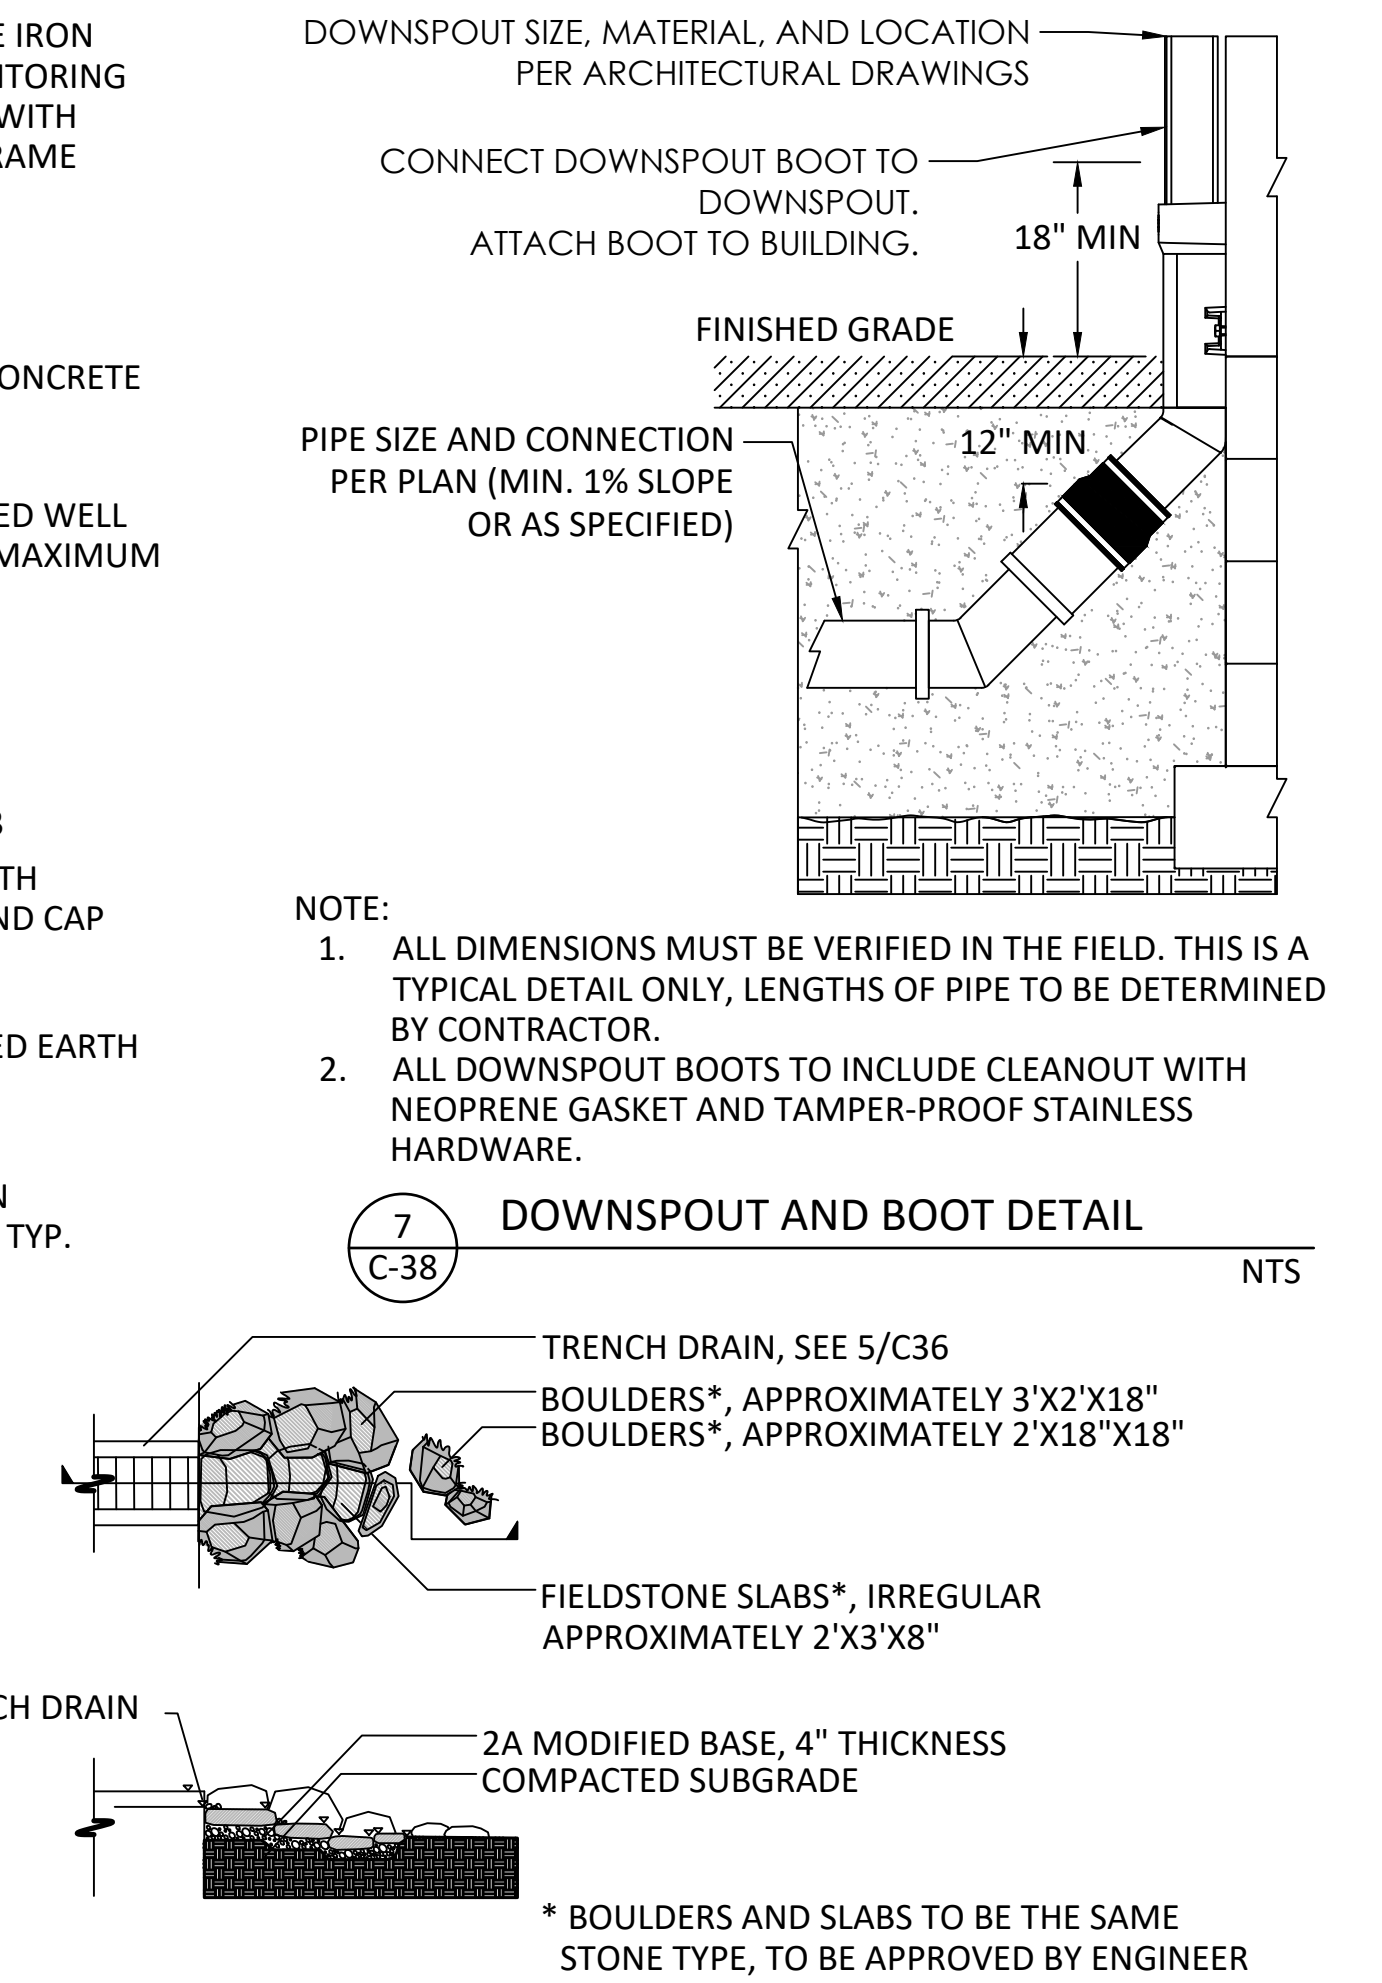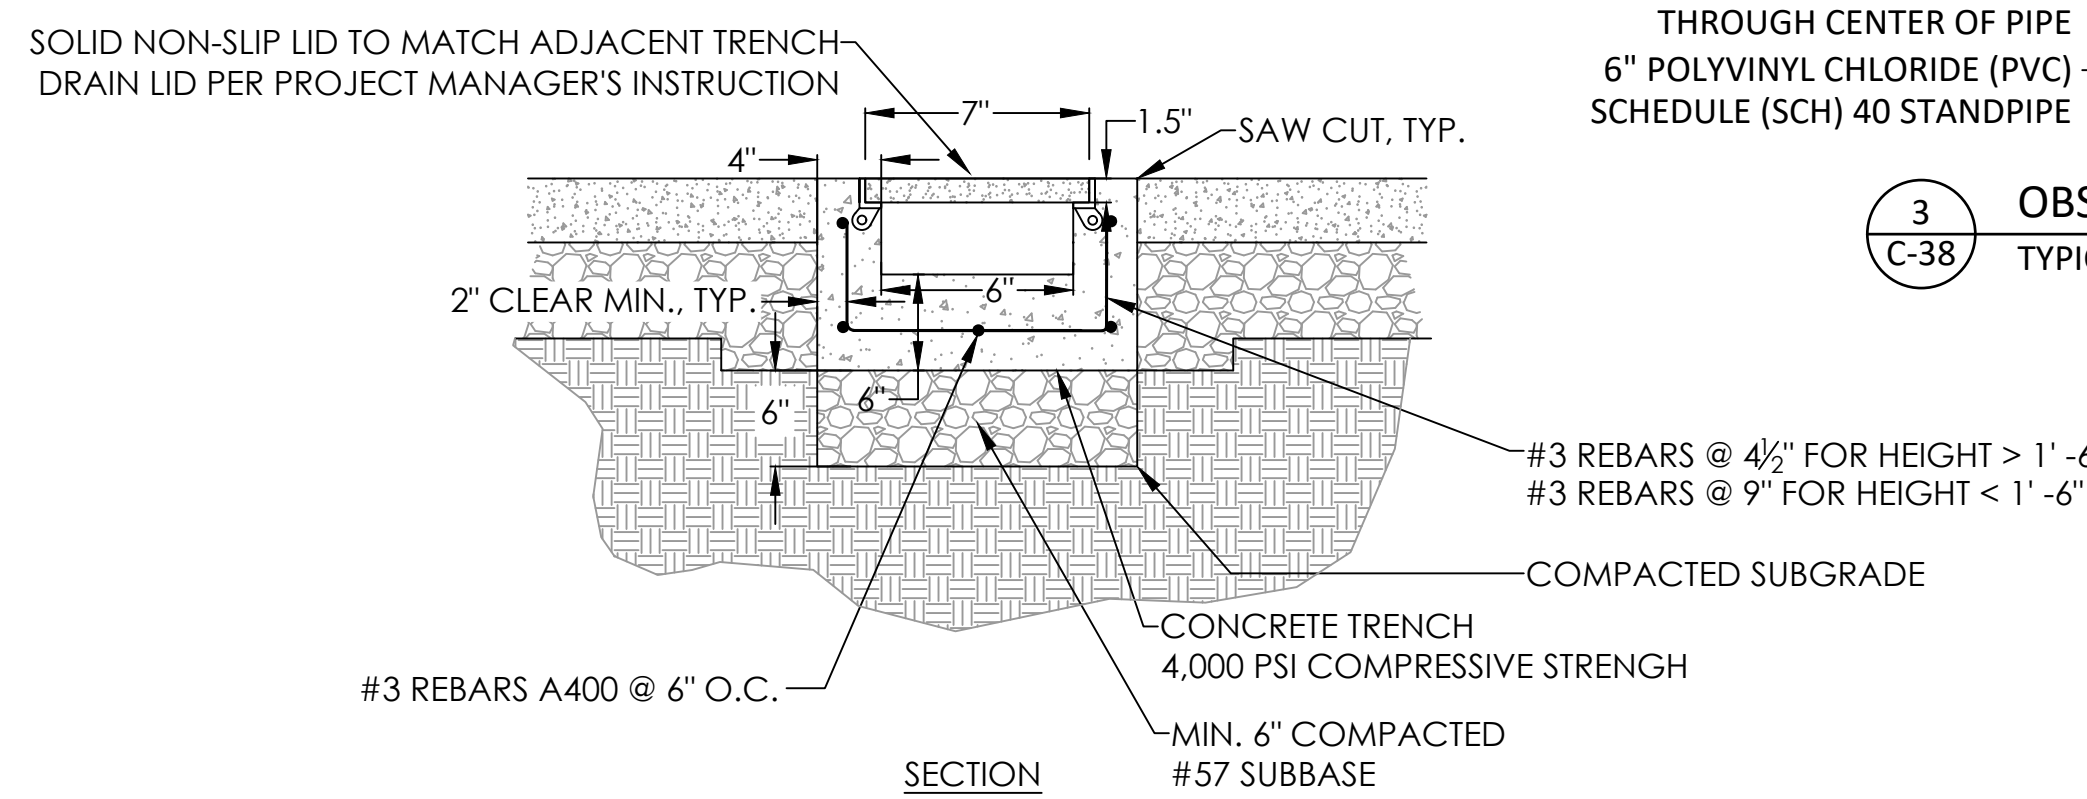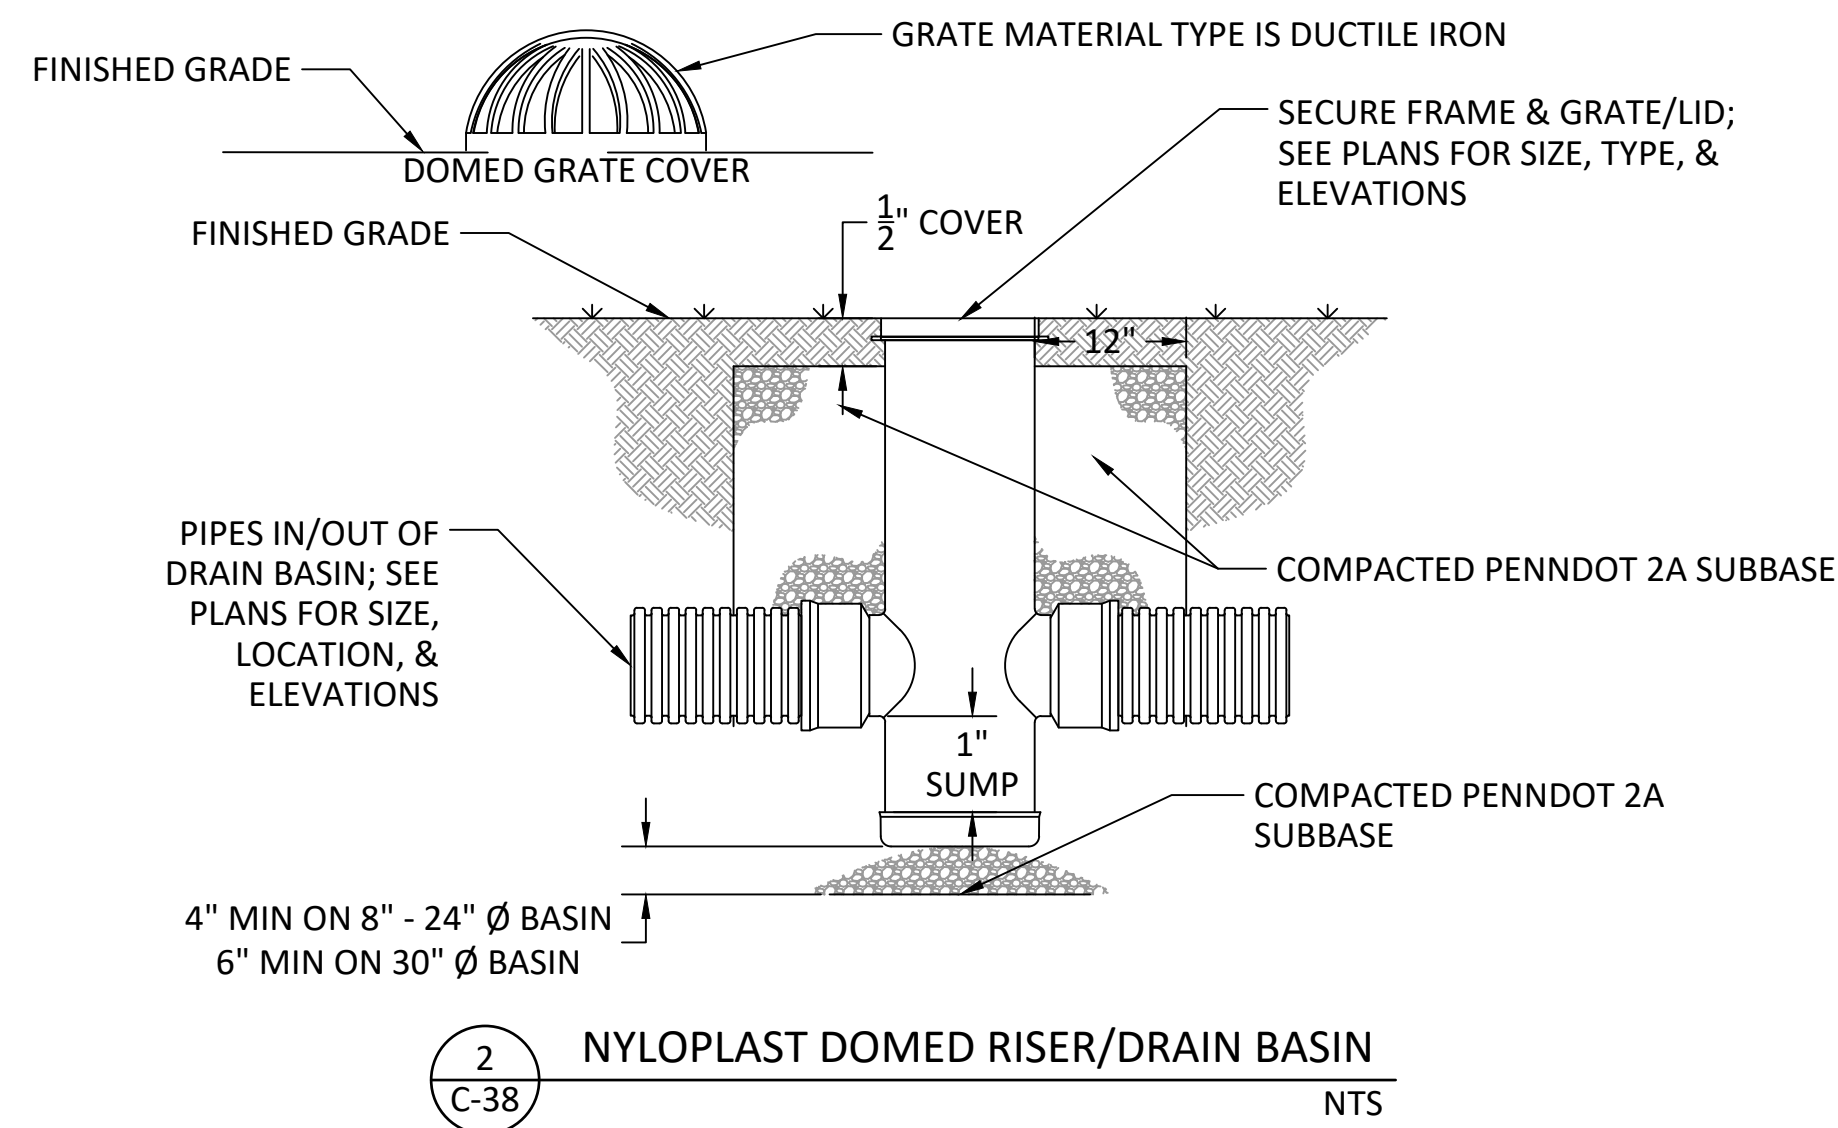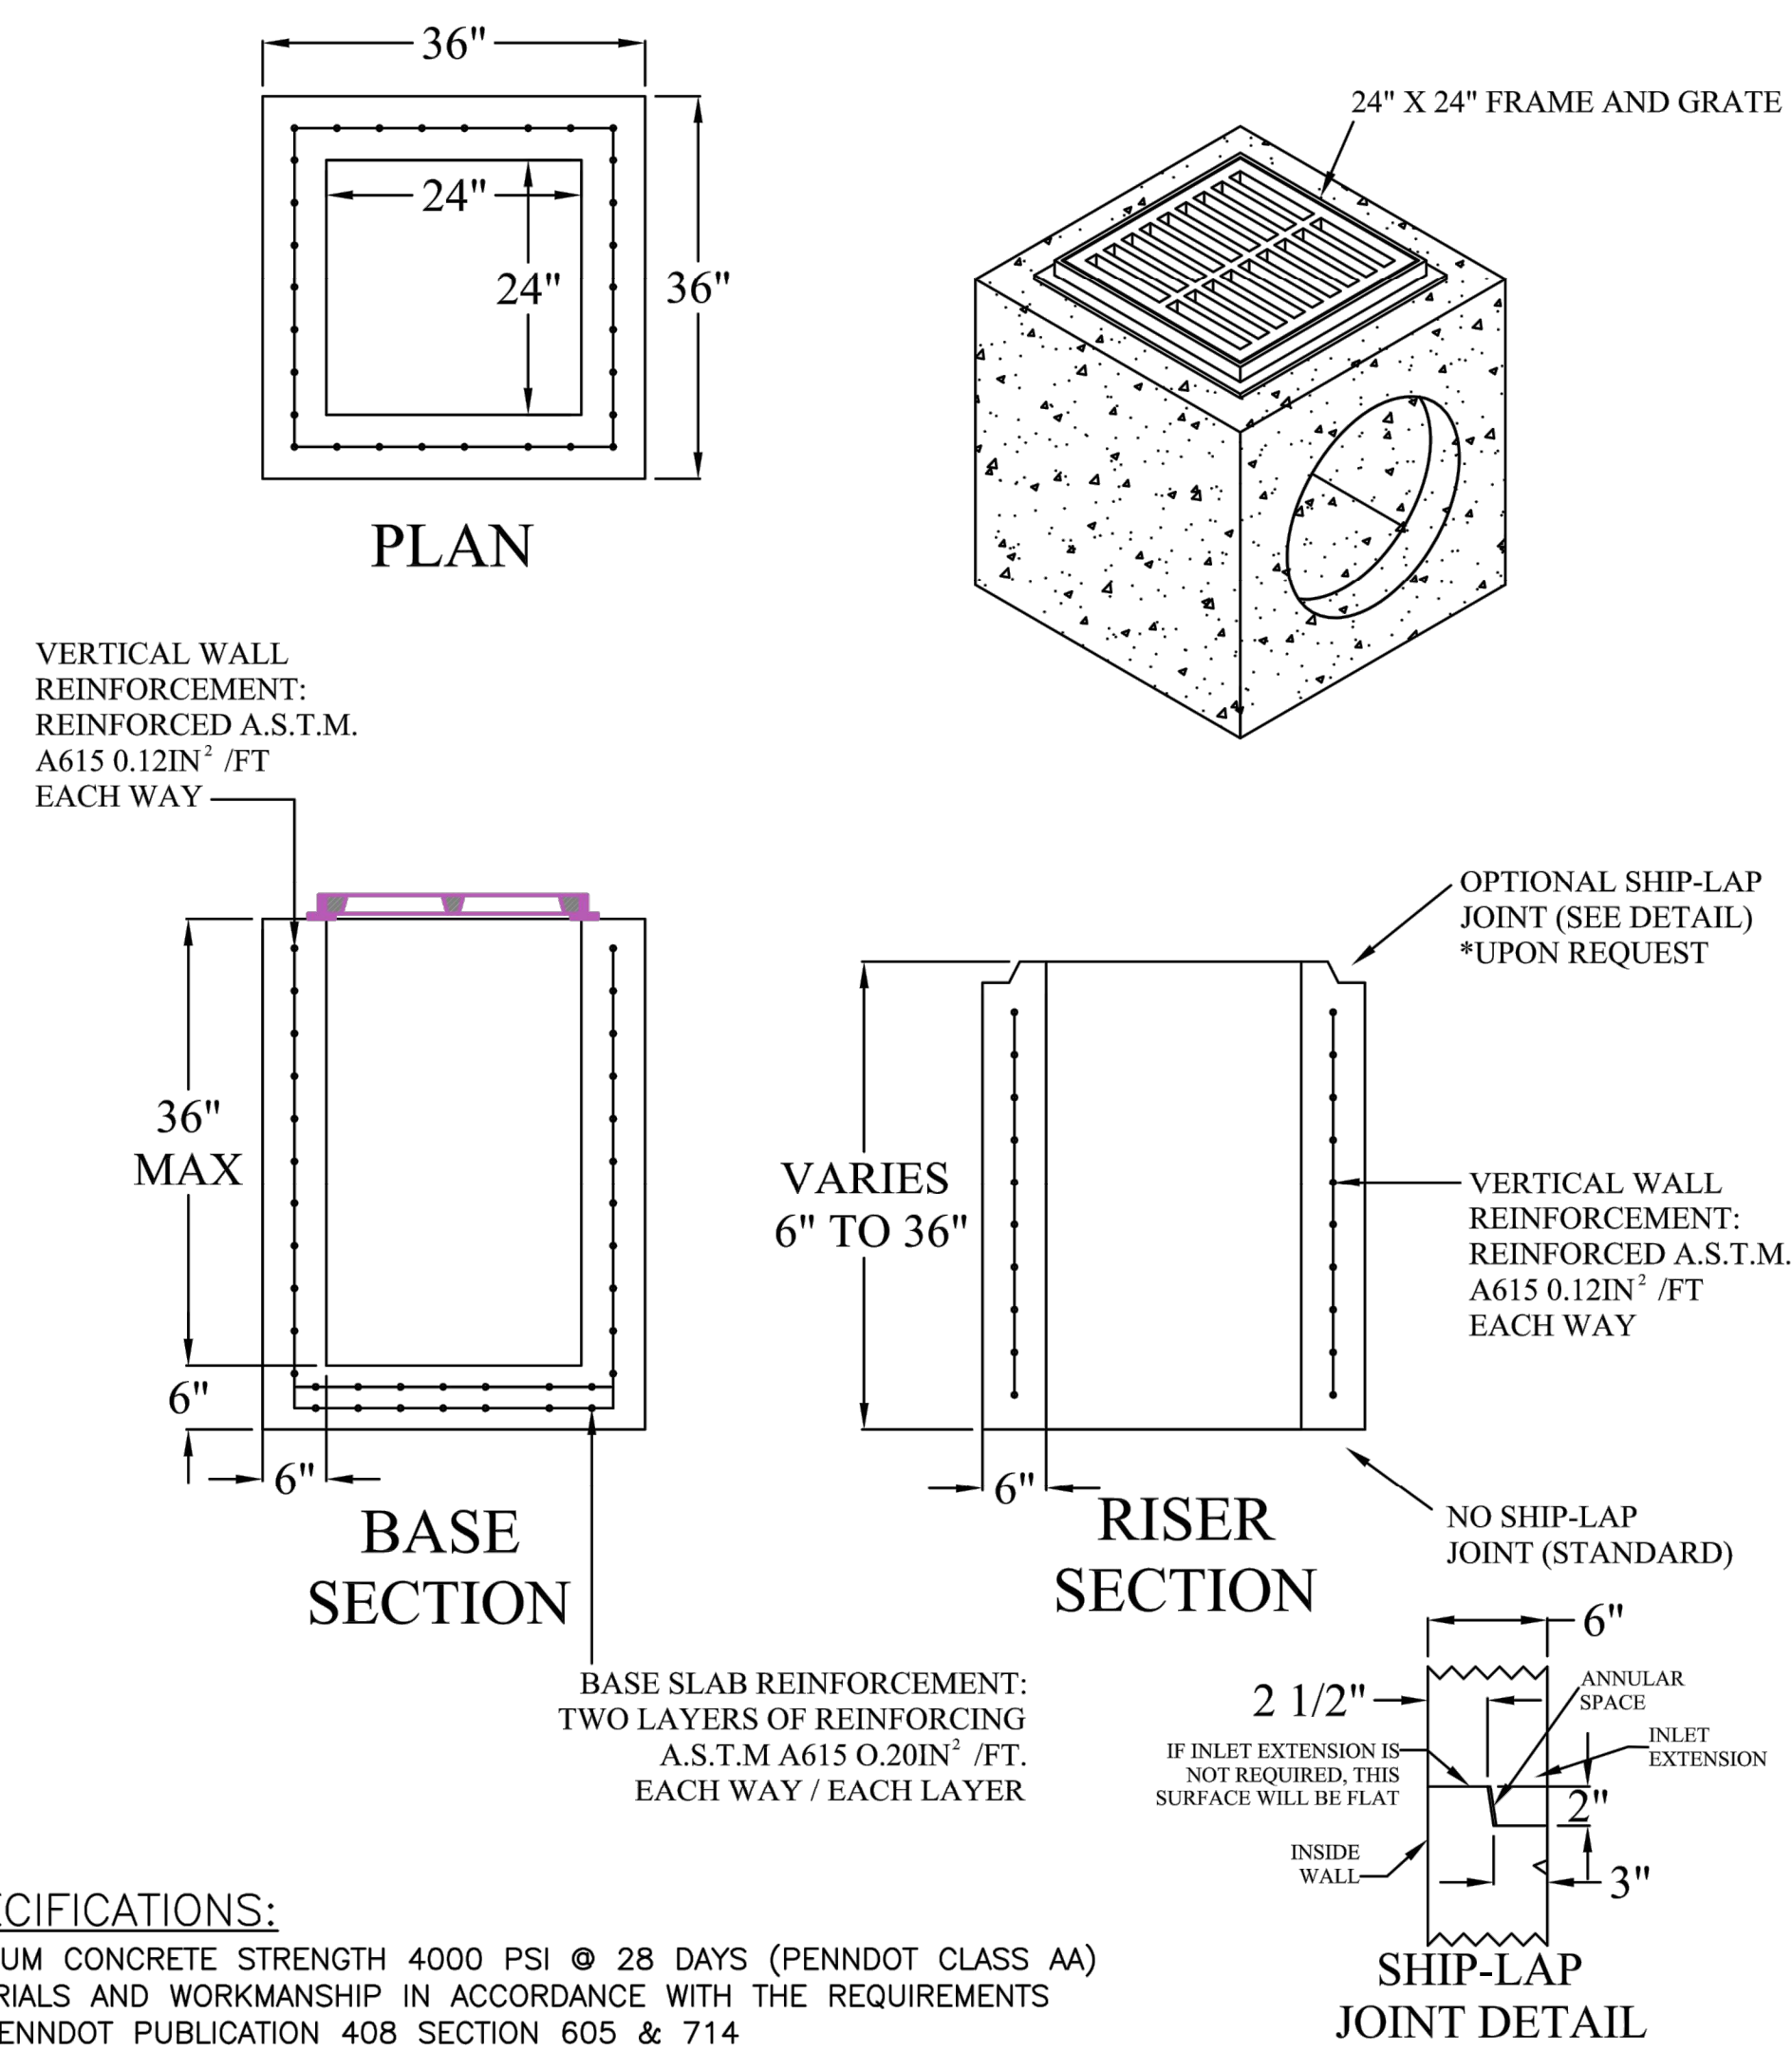

1 24" x 24" INLET BOX AND RISER NTS

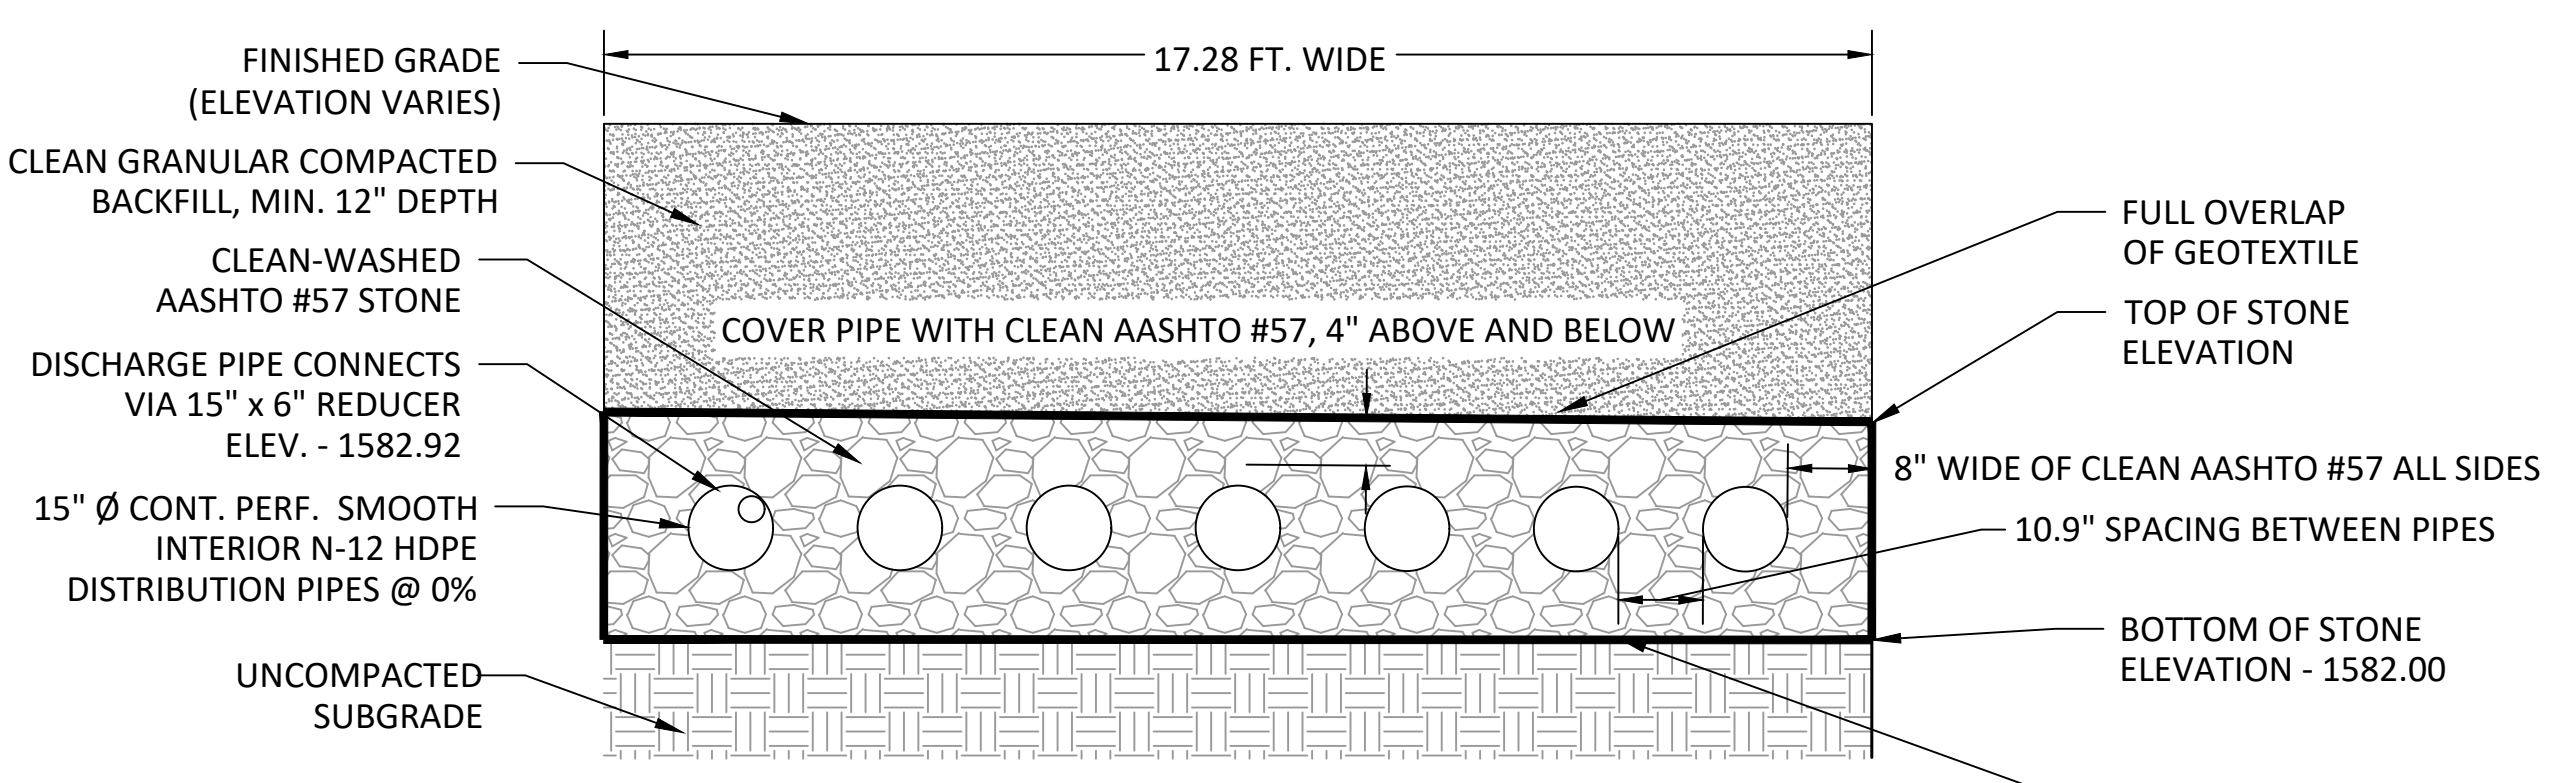

- NOTES:**
1. HDPE DISTRIBUTION PIPE MUST MEET AASHTO M252, TYPE S OR AASHTO M 294, TYPE S
 2. ALL AGGREGATES WITHIN THE STONE STORAGE BED SHALL BE CLEAN-WASHED, DEFINED AS HAVING LESS THAN 0.5% WASH LOSS, BY MASS, WHEN TESTED PER THE AASHTO T-11 WASH LOSS TEST.
 3. CHAMBERS WITH PIPE CONNECTIONS SHALL INCLUDE A MINIMUM OF 3 CLEANOUTS ACCESSIBLE AT SURFACE WITH 6" INSERT-A-TEE CONNECTIONS TO PIPE CROWN.
 4. SEAL ALL PIPE CHAMBERS WITH SOLID, WATER TIGHT CAPS.
 5. DISCHARGE PIPE SHALL CONNECTED VIA A REDUCER OF THE APPROPRIATE SIZE TO A PIPE NOT CONNECTED TO INCOMING STORM PIPES.
 6. ONE INSPECTION PORT SHALL BE INCLUDED WITHIN THE STONE.
 7. GEOTEXTILE SHALL CONSIST OF POLYPROPYLENE FIBERS AND MEET THE FOLLOWING SPECIFICATIONS:

GRAB TENSILE STRENGTH (ASTM-D4632) > OR = 120 LBS.
MULLEN BURST STRENGTH (ASTM-D3786) > OR = 225 LBS.
FLOW RATE (ASTM-D4491) > OR = 95 GAL./MIN./FT²
UV RESISTANCE AFTER 500 HRS. (ASTM-D4355) > OR = 70%
HEAT-SET OR HEAT CALENDARED FABRICS ARE NOT PERMITTED

SITE	INFILTRATION BED STONE DEPTH, D (IN.)	INFILTRATION BED STONE WIDTH, (FT.)	INFILTRATION BED STONE LENGTH, (FT.)	PIPE LENGTH (FT.)
SHEHAQUA	22	17.28	41.33	40

4 INFILTRATION BED - SHEHAQUA NTS

CONSTRUCTION DOCUMENTS




NO.	REVISION

MARC B. HENDERSON
REGISTERED PROFESSIONAL ENGINEER
No. 08840
06/15/22
SIGNATURE DATE

SMP ARCHITECTS
1600 WALNUT STREET, SECOND FLOOR
PHILADELPHIA, PENNSYLVANIA





COMMONWEALTH OF PENNSYLVANIA
DEPARTMENT OF GENERAL SERVICES
HARRISBURG, PENNSYLVANIA

D.G.S. PROJECT No. C-114-0006 PHASE 1
HICKORY RUN STATE PARK
LATRINE IMPROVEMENTS
DEPT OF CONSERVATION AND NATURAL RESOURCES
WHITE HAVEN, CARBON COUNTY, PA

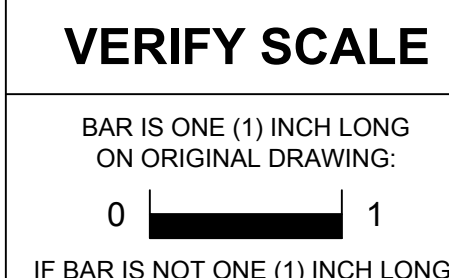

CONTRACTOR SHALL FIELD VERIFY ALL DIMENSIONS. VARIANCE FROM CONTRACT DOCUMENTS NOT PERMITTED WITHOUT PROFESSIONAL & BUREAU OF CONSTRUCTION APPROVAL.	DRAWN BY L GILL	DATE 06/17/2022	DRAWING No. C-38
	CHECKED BY M HENDERSON	SCALE AS NOTED	

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PLOTTED BY: Laura L. Gill

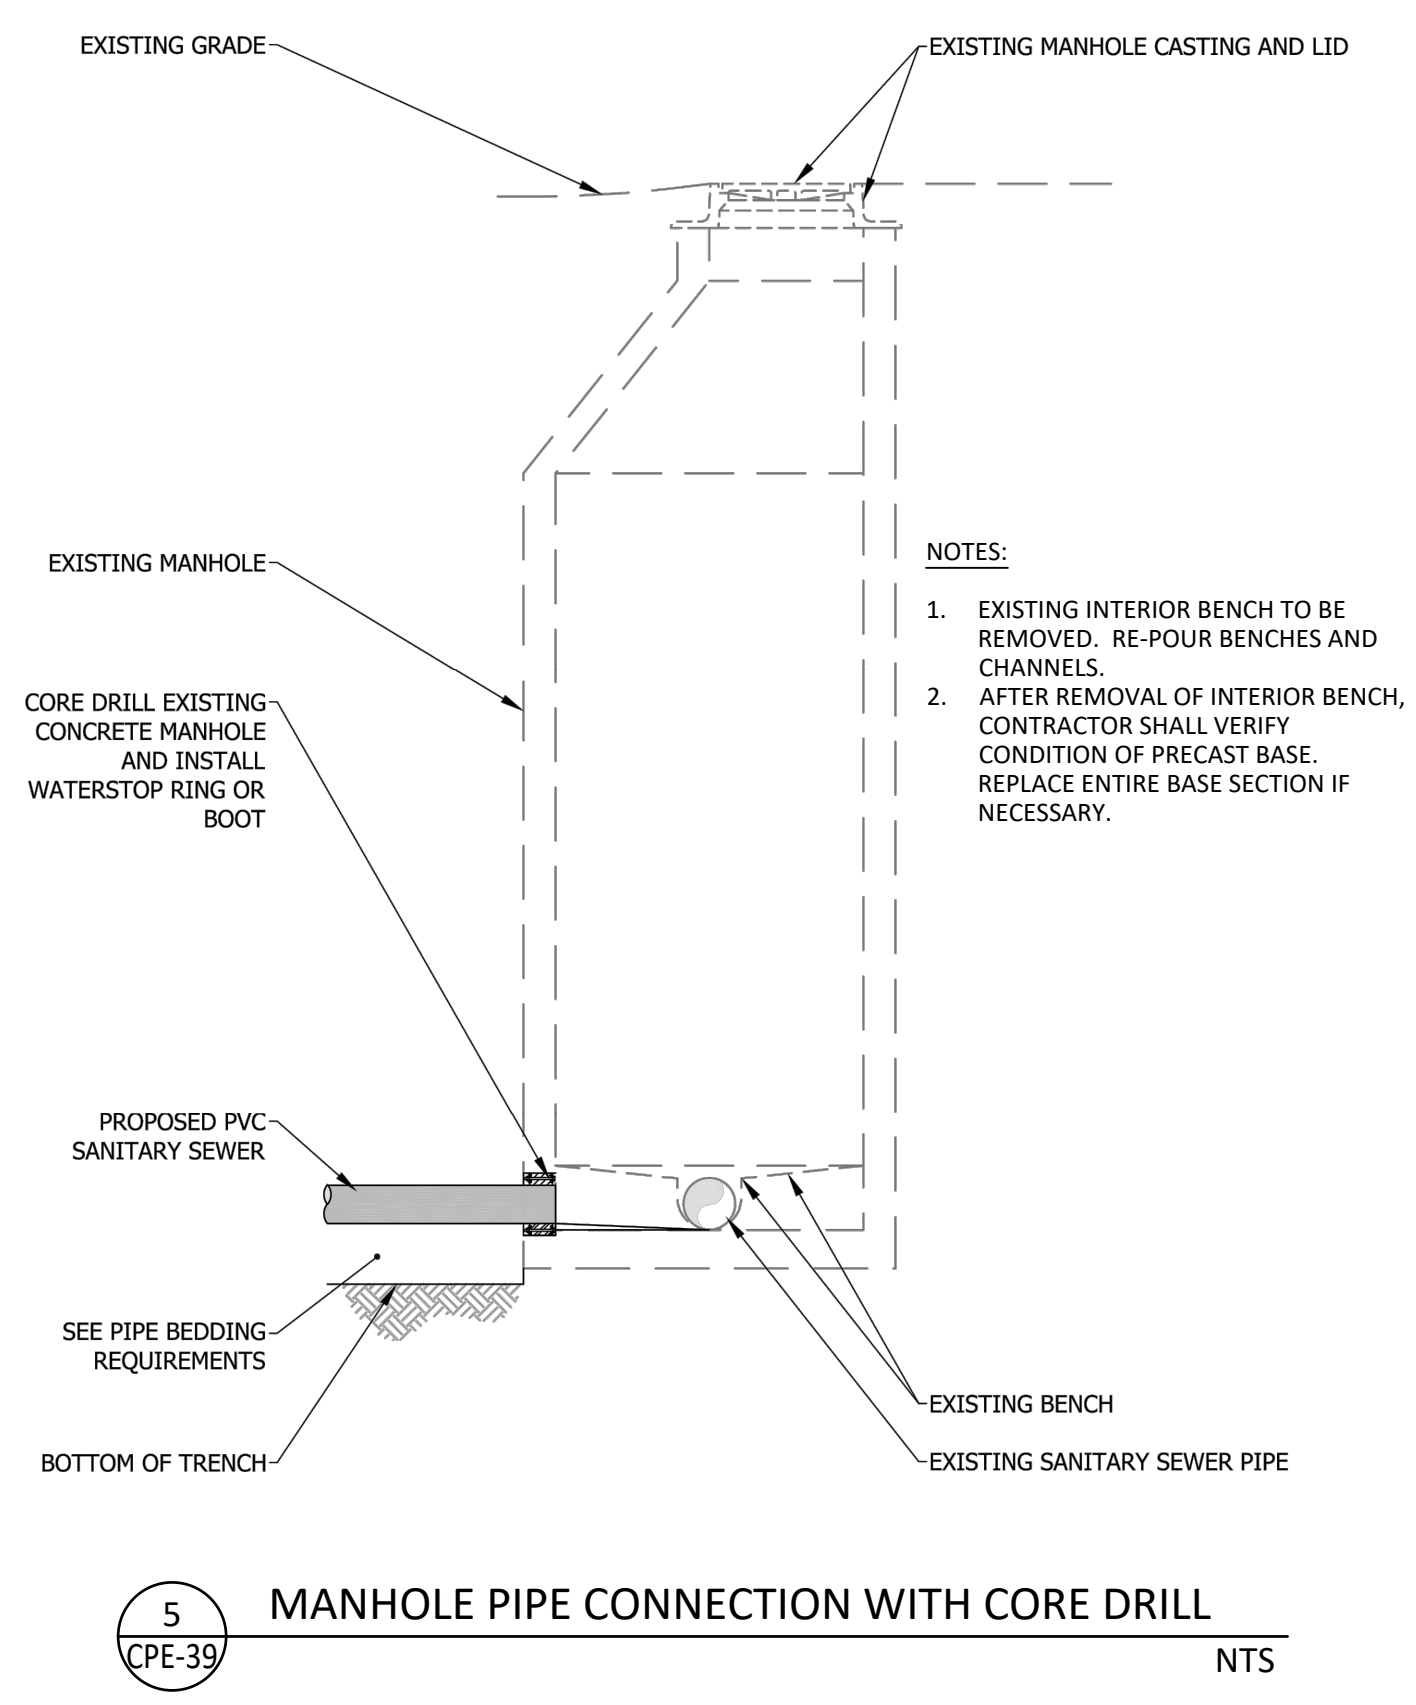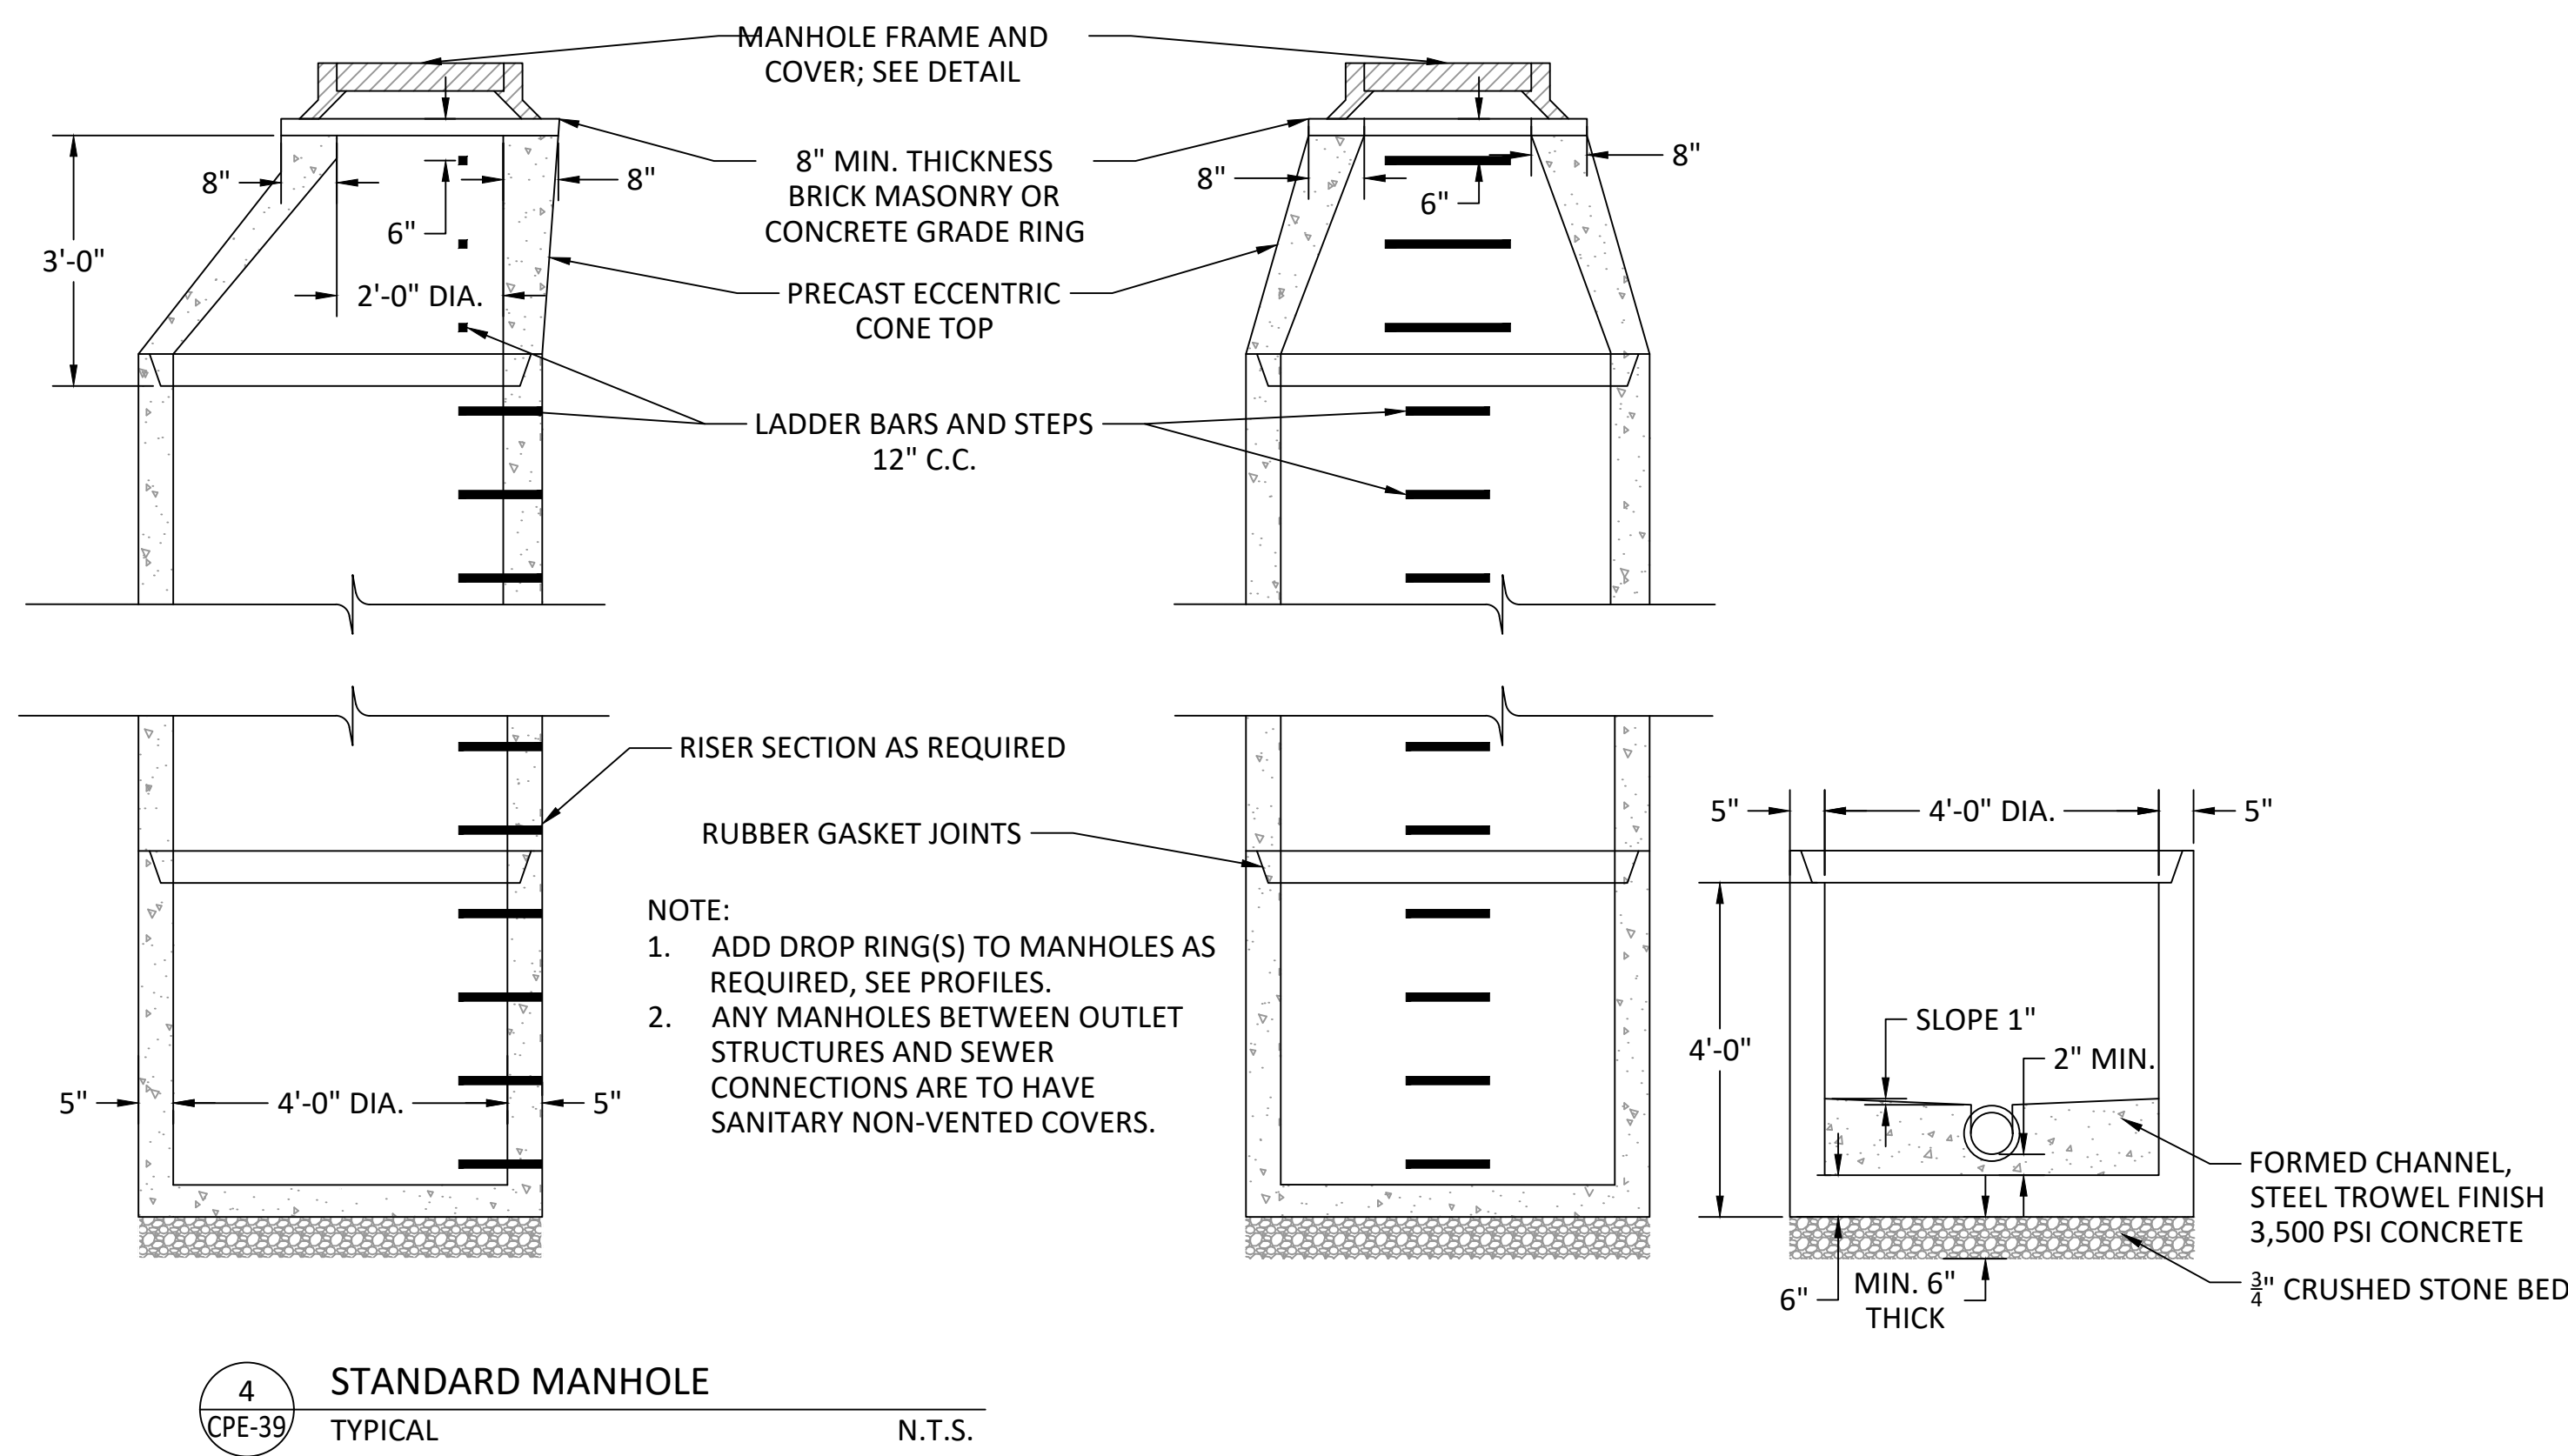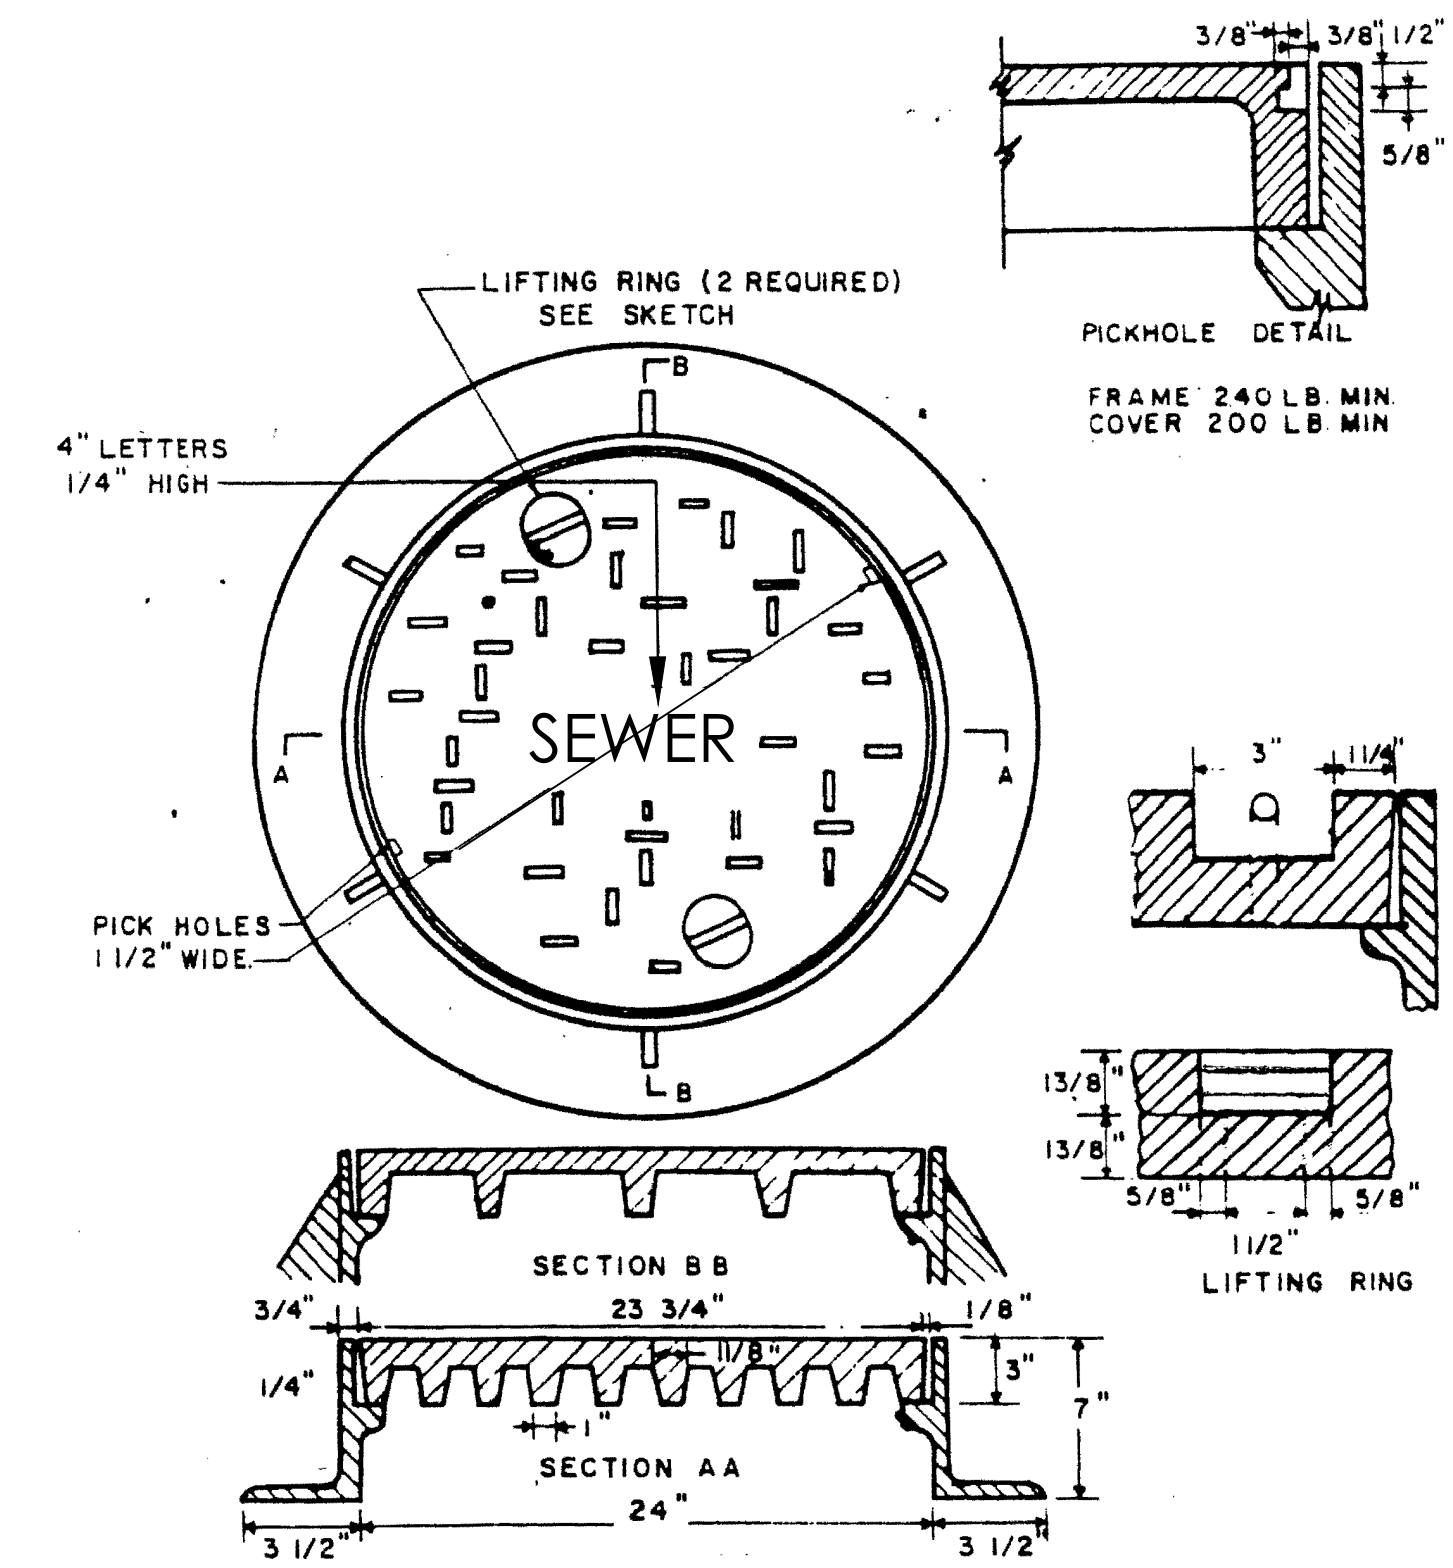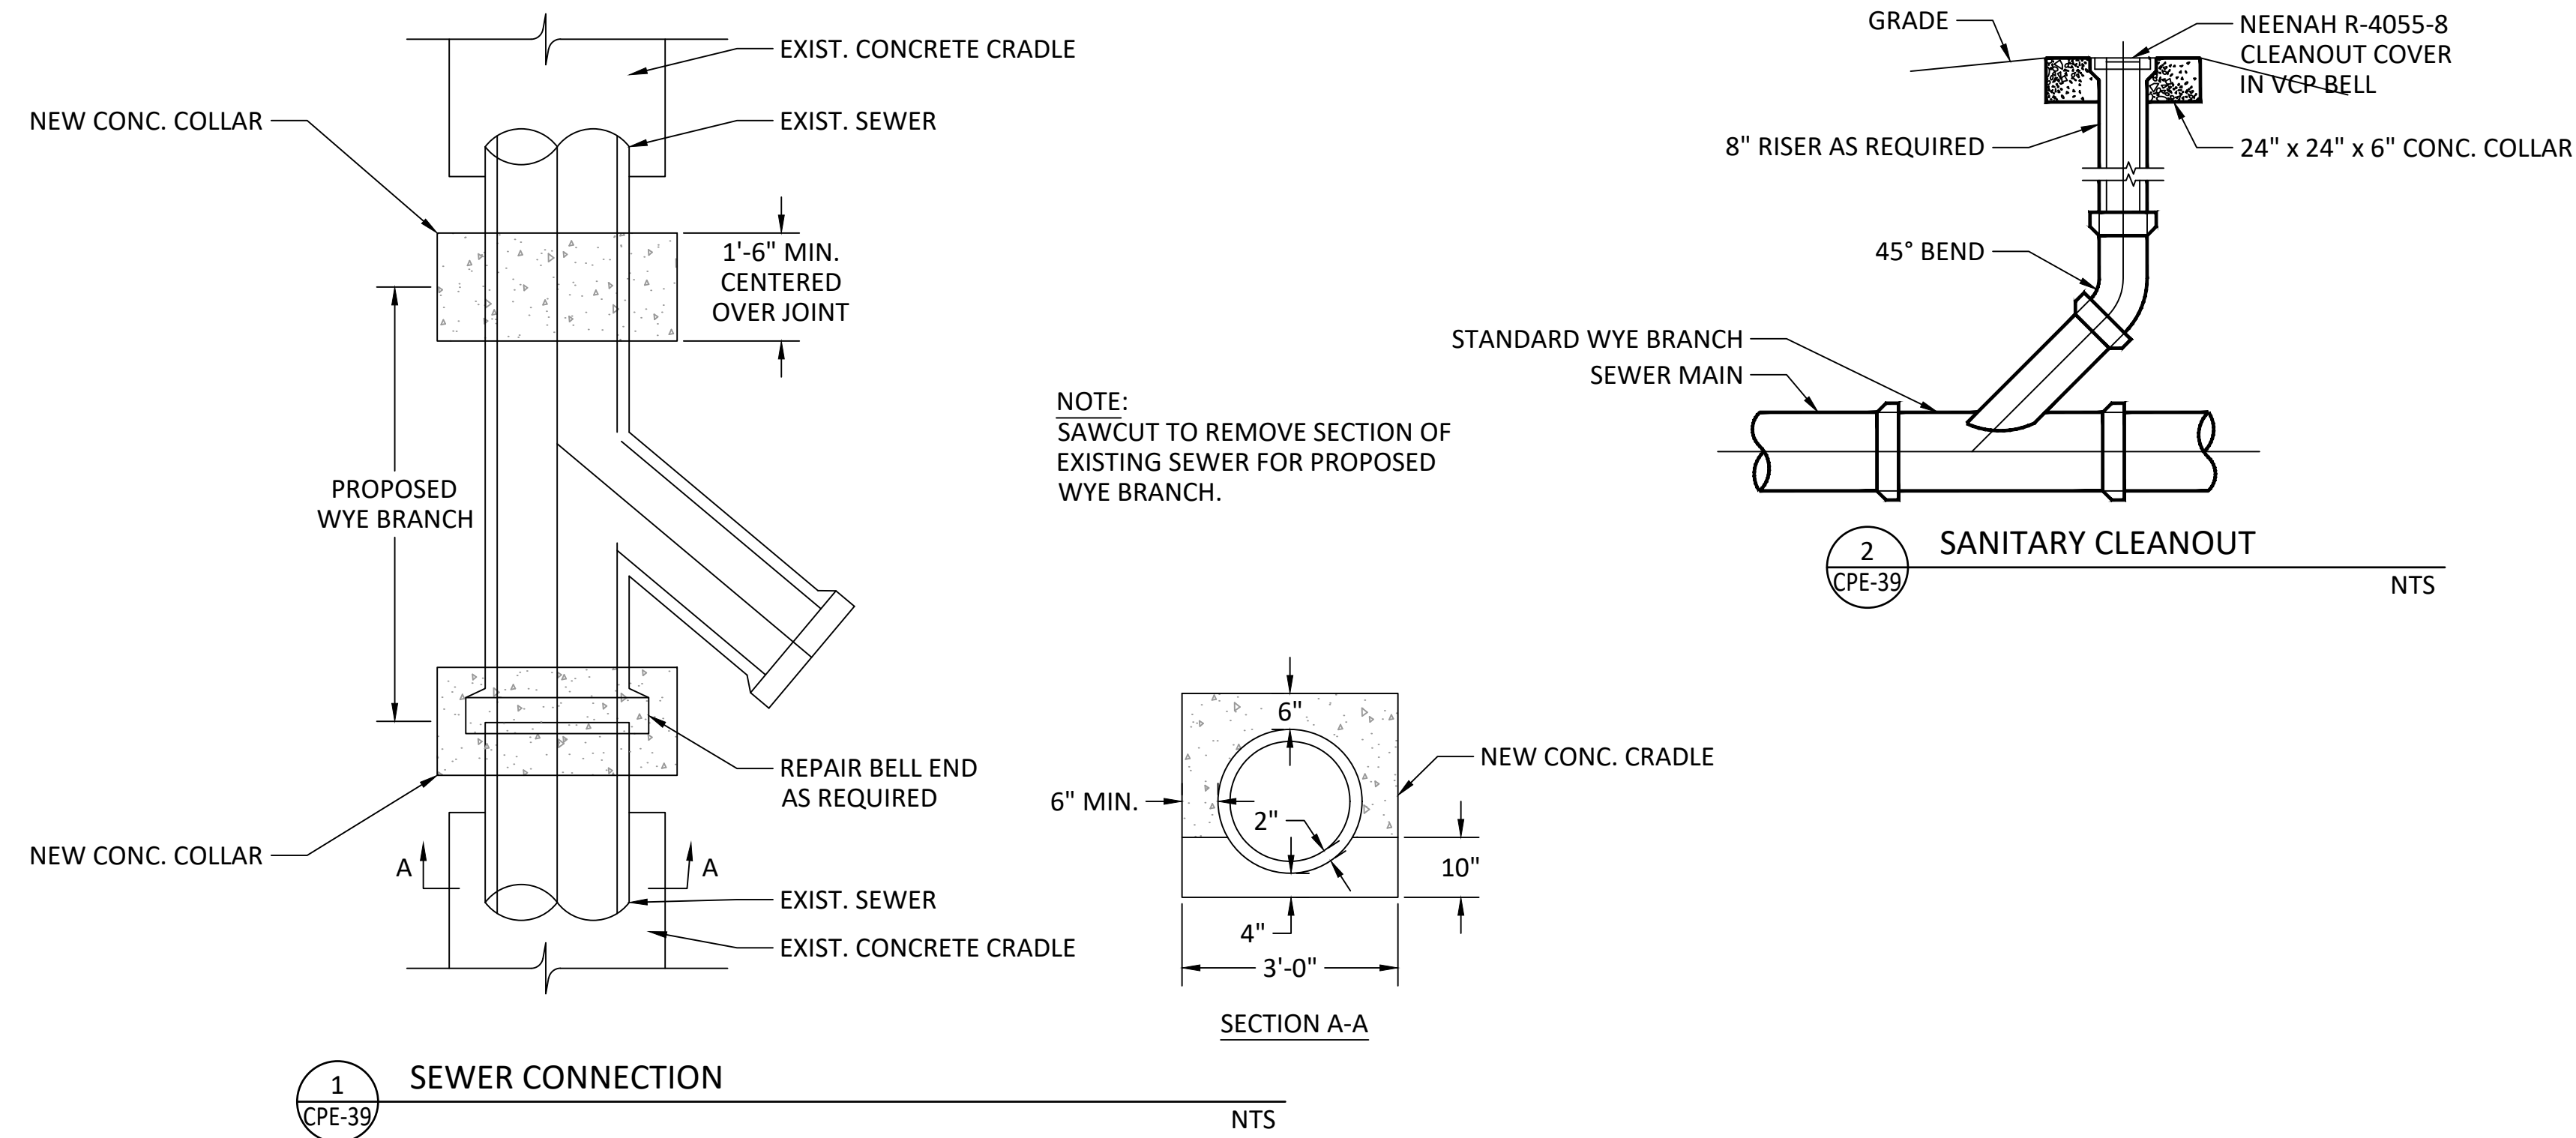

CONSTRUCTION DOCUMENTS



NO.	REVISION

MARC B. HENDERSON
REGISTERED PROFESSIONAL ENGINEER
No. 08040
06/15/22
SIGNATURE DATE


SMP ARCHITECTS
1600 WALNUT STREET, SECOND FLOOR
PHILADELPHIA, PENNSYLVANIA

COMMONWEALTH OF PENNSYLVANIA
DEPARTMENT OF GENERAL SERVICES
HARRISBURG, PENNSYLVANIA

D.G.S. PROJECT No. **C-114-0006 PHASE 1**


HICKORY RUN STATE PARK
LATRINE IMPROVEMENTS
DEPT of CONSERVATION AND NATURAL RESOURCES
WHITE HAVEN, CARBON COUNTY, PA

UTILITY DETAILS - SHEET 1

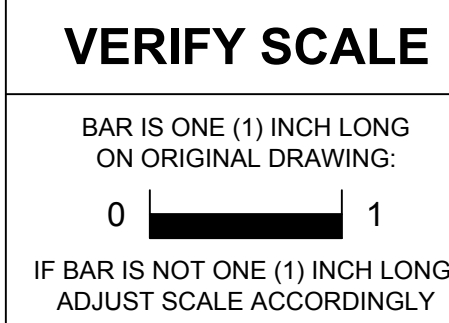


CONTRACTOR SHALL FIELD VERIFY ALL DIMENSIONS. VARIANCE FROM CONTRACT DOCUMENTS NOT PERMITTED WITHOUT PROFESSIONAL & BUREAU OF CONSTRUCTION APPROVAL.	DRAWN BY L GILL	DATE 06/17/2022	DRAWING No. CPE-39
	CHECKED BY M HENDERSON	SCALE AS NOTED	52 OF 144

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PLOTTED BY: Marc Henderson
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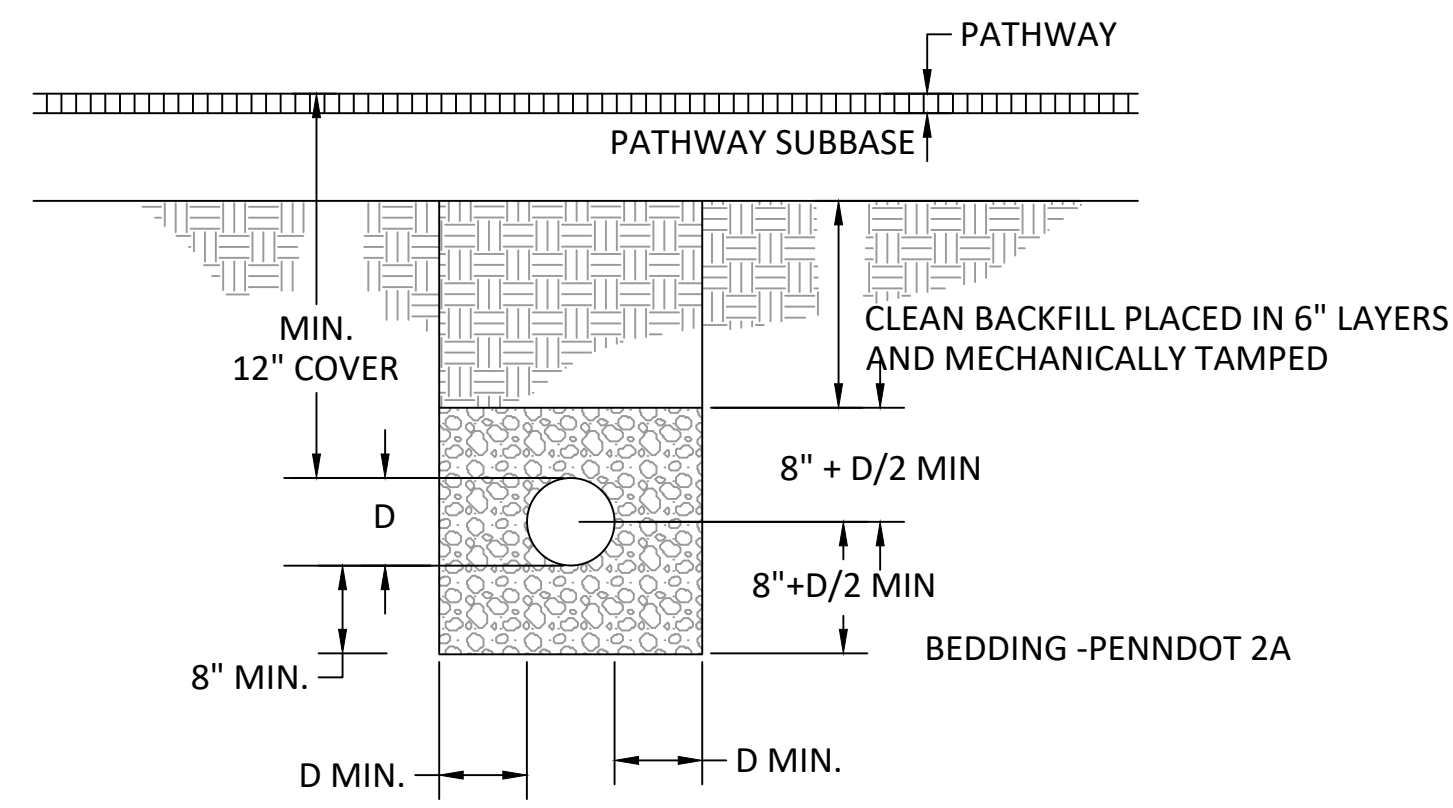


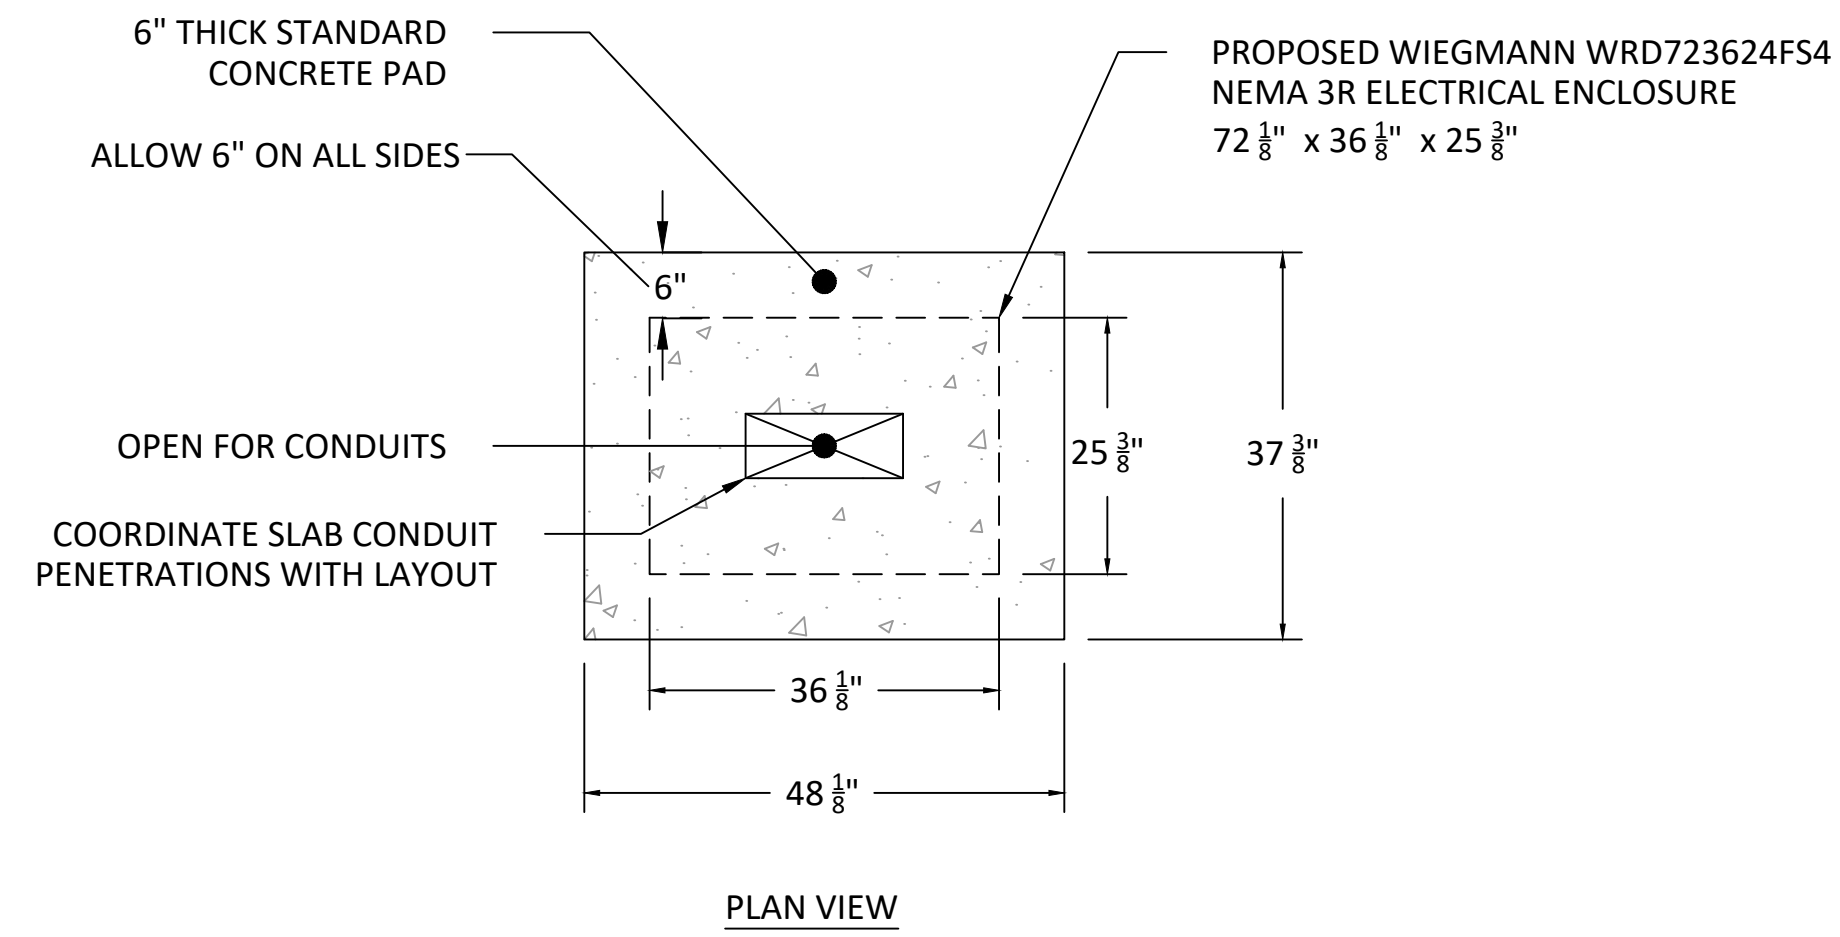PLAN VIEW

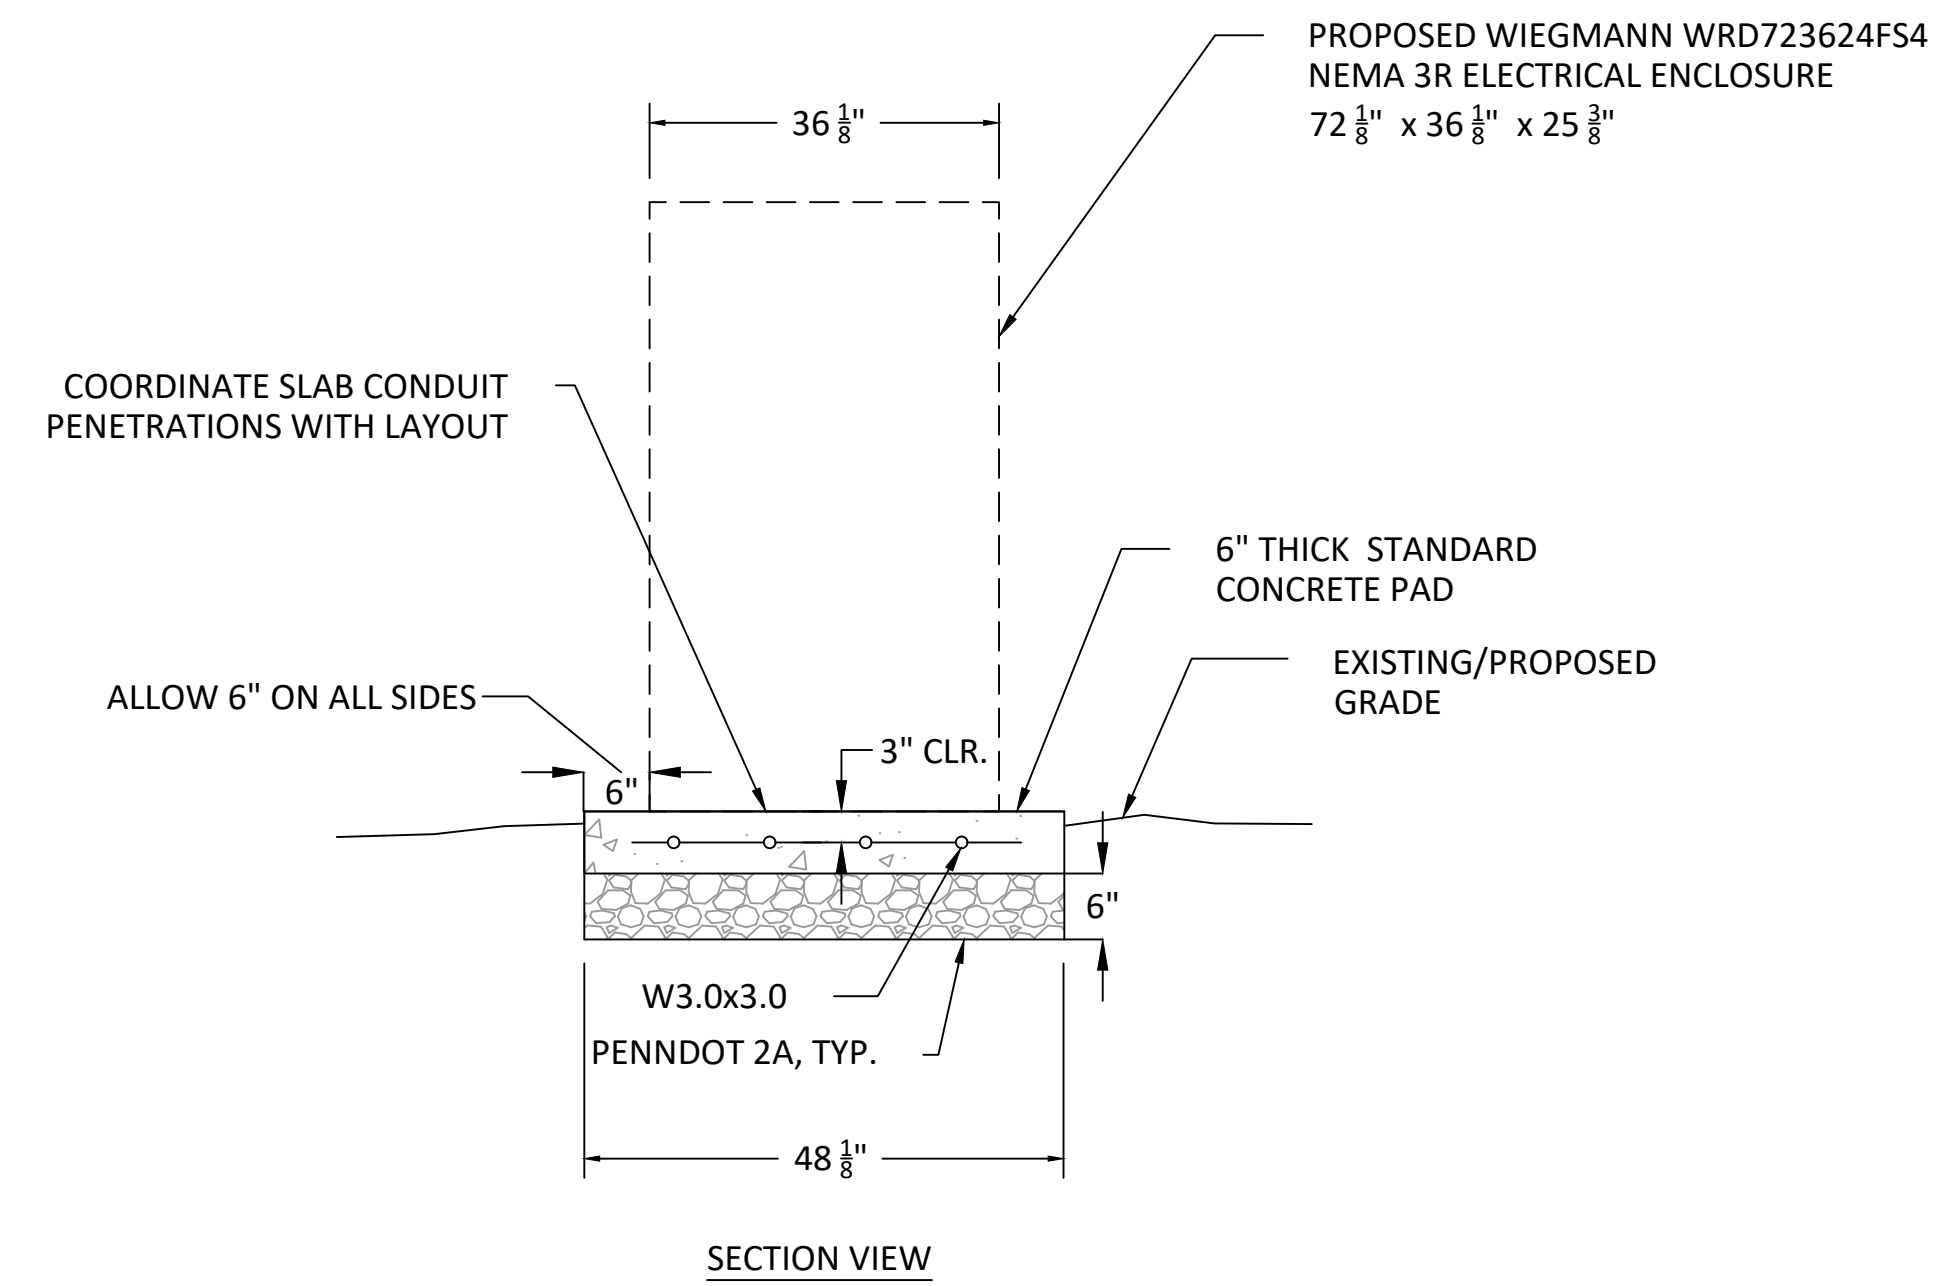


SECTION VIEW


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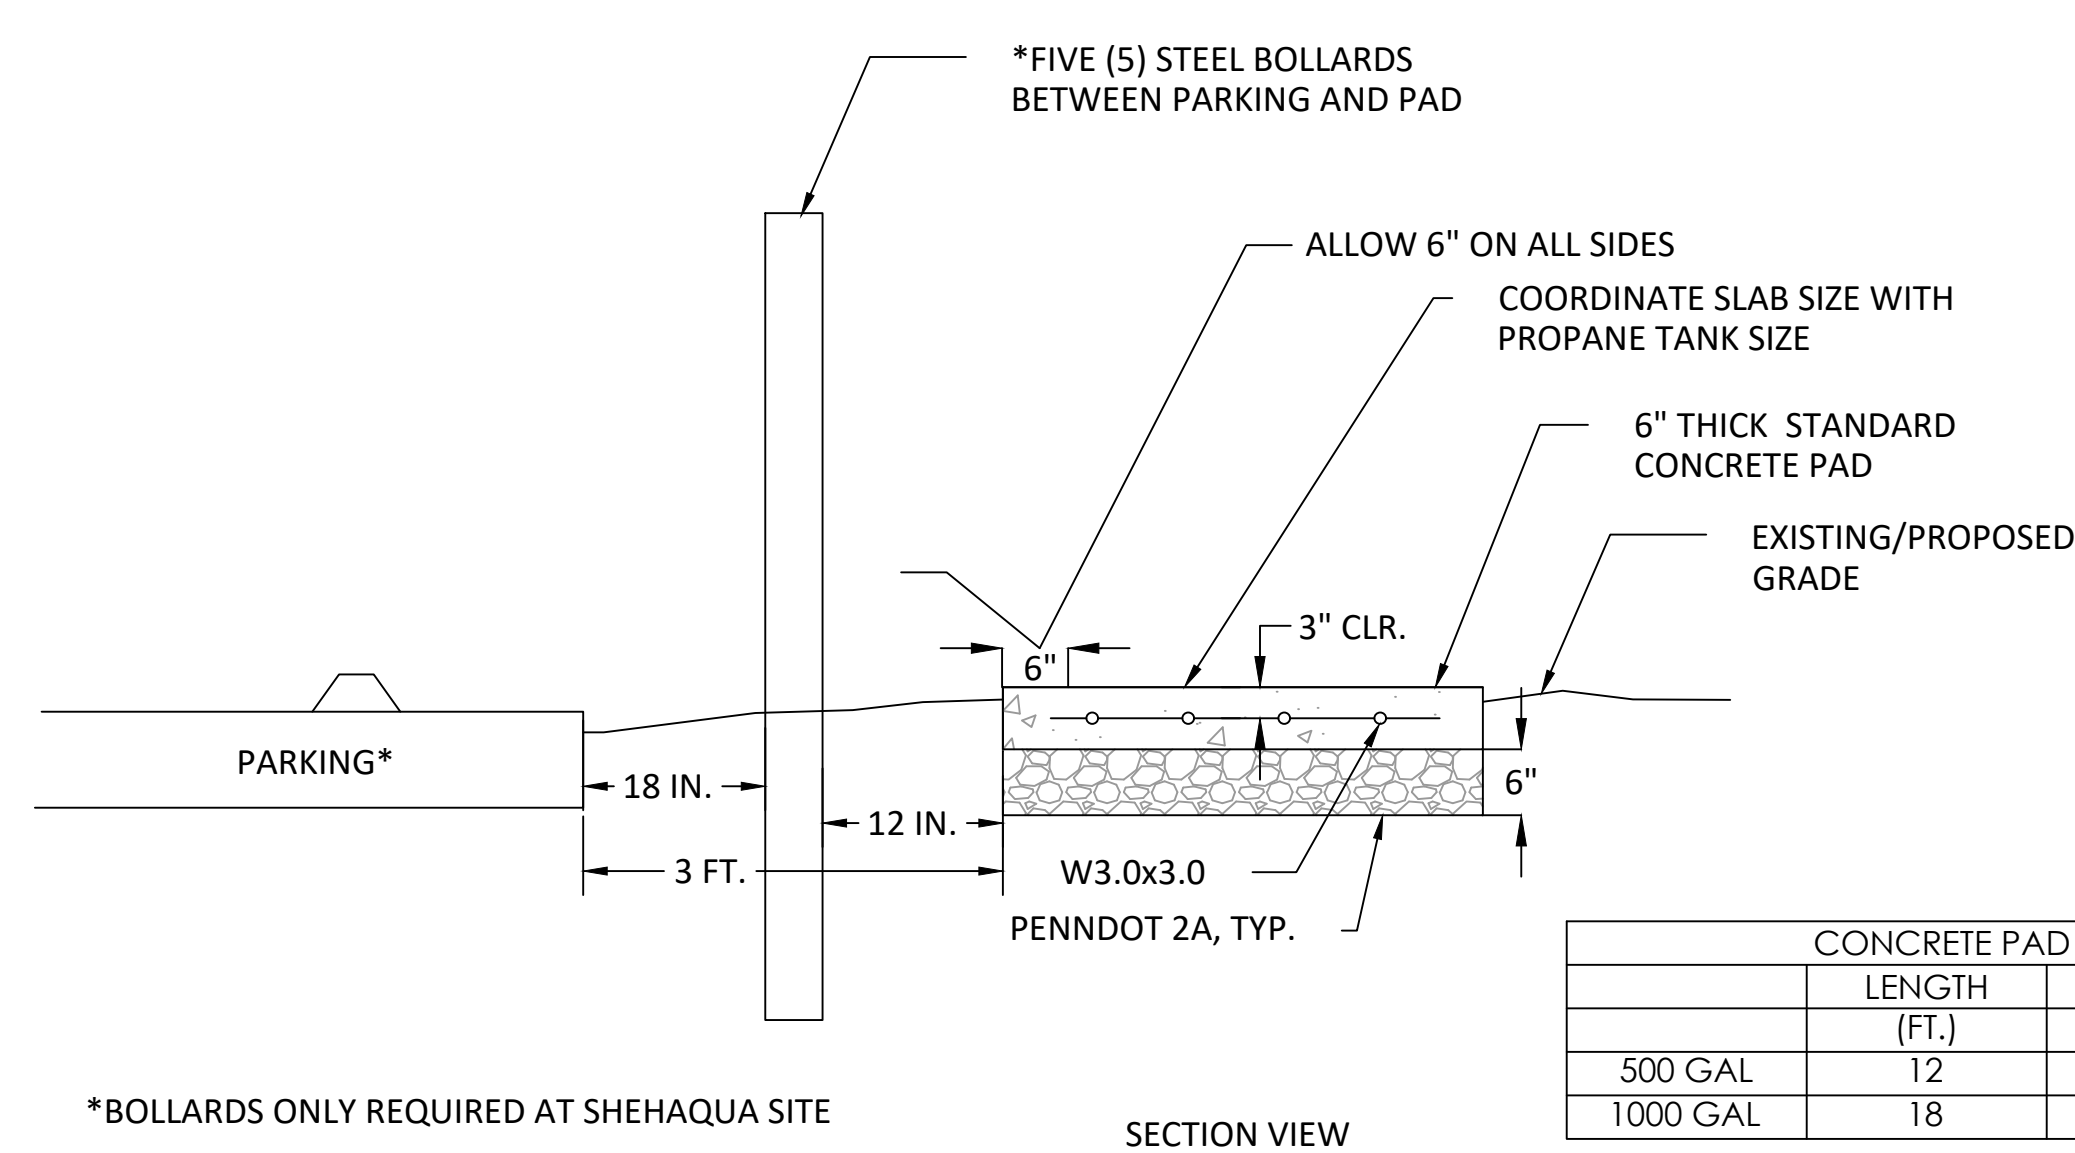
2 TYPICAL BEDDING IN PAVED AREAS NTS



4 PPL TRENCH DETAIL NTS

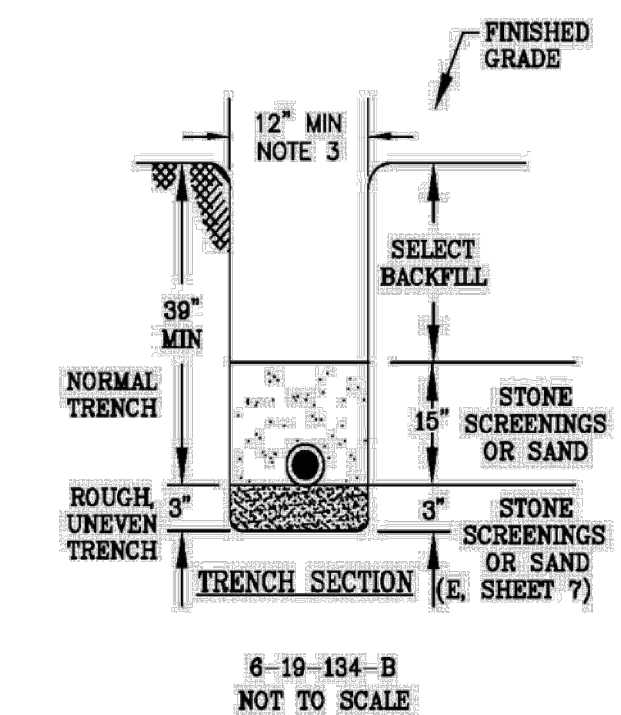


3 TYPICAL PIPE BEDDING UNDER UNPAVED AREAS NTS

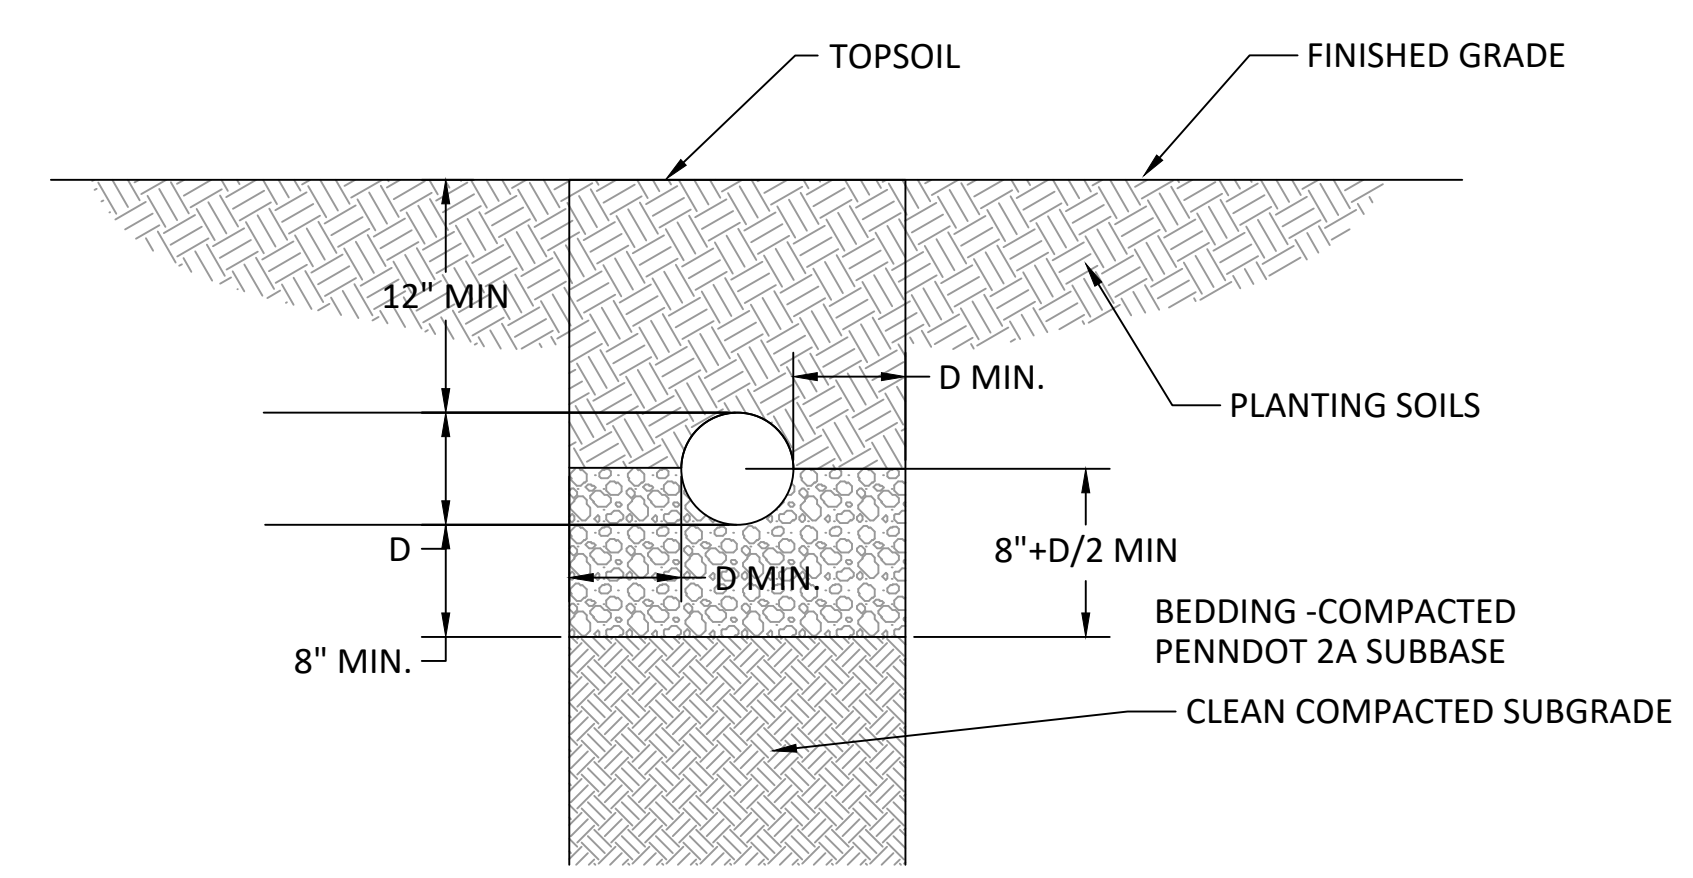

SECTION VIEW

CONCRETE PAD DIMENSIONS			
	LENGTH (FT.)	WIDTH (FT.)	THICKNESS (IN.)
500 GAL	12	5	6
1000 GAL	18	5	6

5 PROPANE TANK CONCRETE PAD NTS

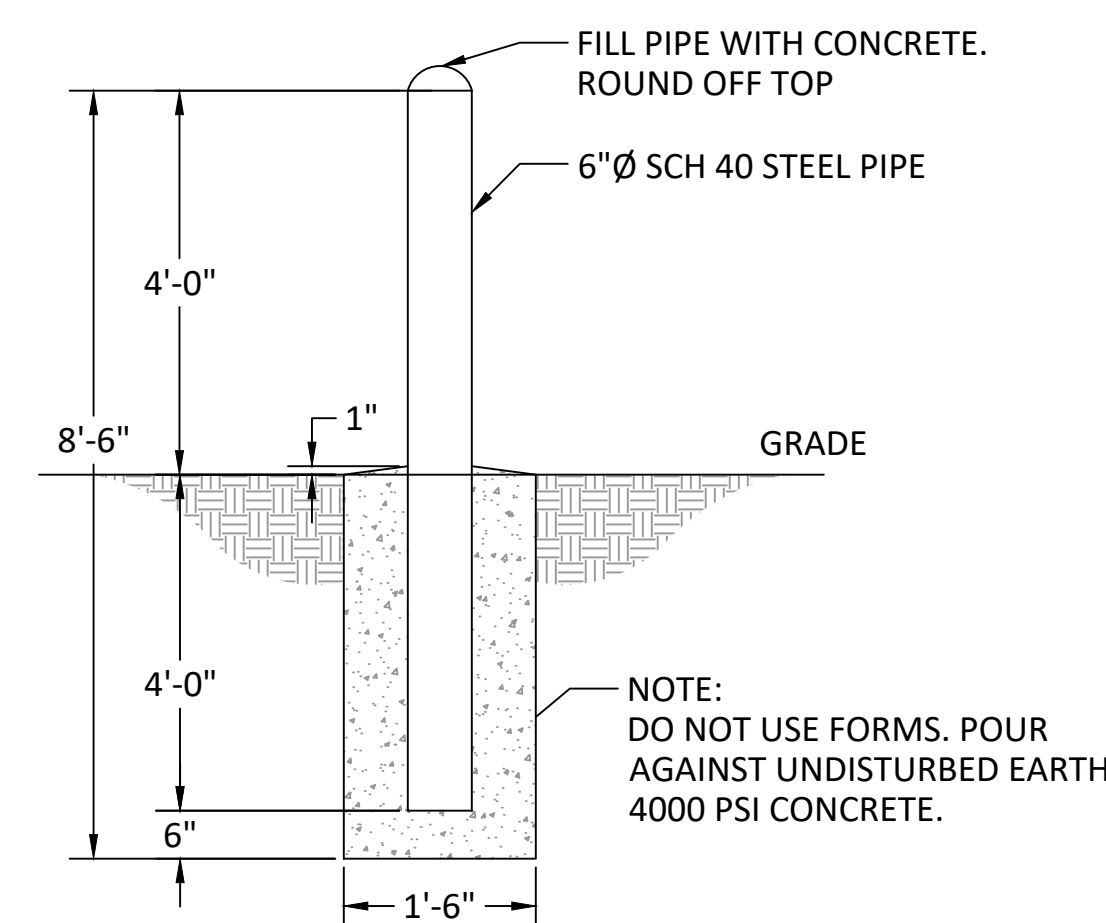


6 TYPICAL BOLLARD NTS

CONSTRUCTION DOCUMENTS



259 MORGAN STREET, PHOENIXVILLE, PA 19460
(610) 933-0123 melioradesign.com

RECORD REVISIONS

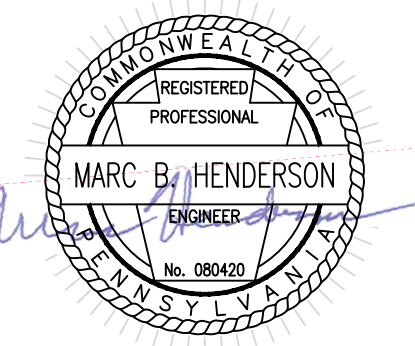

Marc B. Henderson 06/15/22
SIGNATURE DATE

SMP ARCHITECTS
1600 WALNUT STREET, SECOND FLOOR
PHILADELPHIA, PENNSYLVANIA

COMMONWEALTH OF PENNSYLVANIA
DEPARTMENT OF GENERAL SERVICES
HARRISBURG, PENNSYLVANIA

D.G.S. PROJECT No. C-114-0006 PHASE 1

HICKORY RUN STATE PARK
LATRINE IMPROVEMENTS
DEPT of CONSERVATION AND NATURAL RESOURCES
WHITE HAVEN, CARBON COUNTY, PA

UTILITY DETAILS - SHEET 2


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IF BAR IS NOT ONE (1) INCH LONG, ADJUST SCALE ACCORDINGLY

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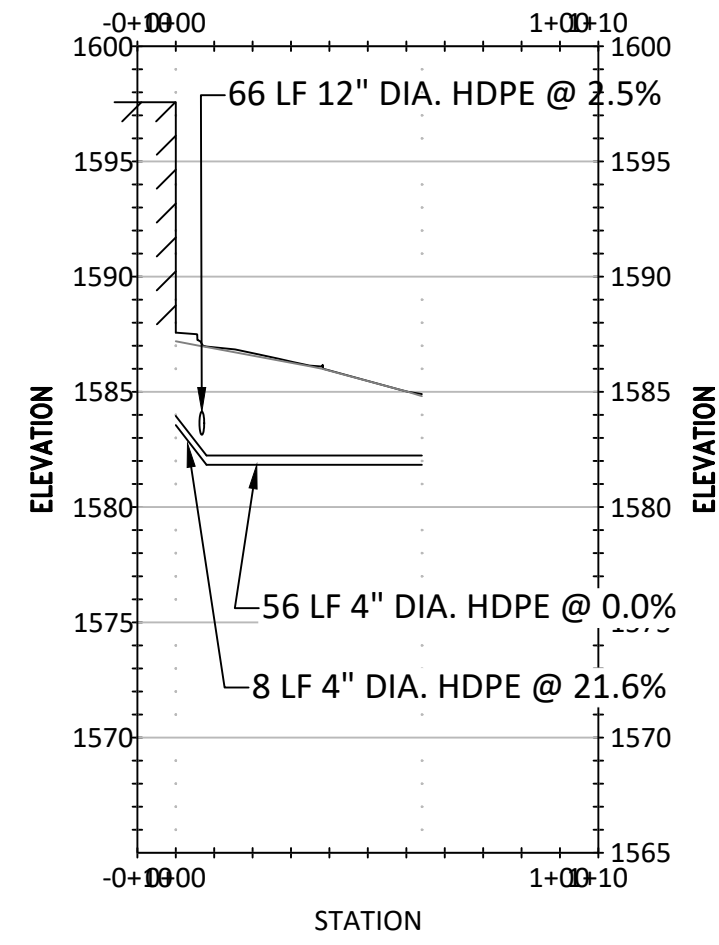
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CHECKED BY M HENDERSON
DATE 06/17/2022
SCALE AS NOTED

DRAWING No. CPE-40
53 OF 144


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LAST SAVED: 2022.02.14 10:09 AM PLOTTED BY: Marc Henderson

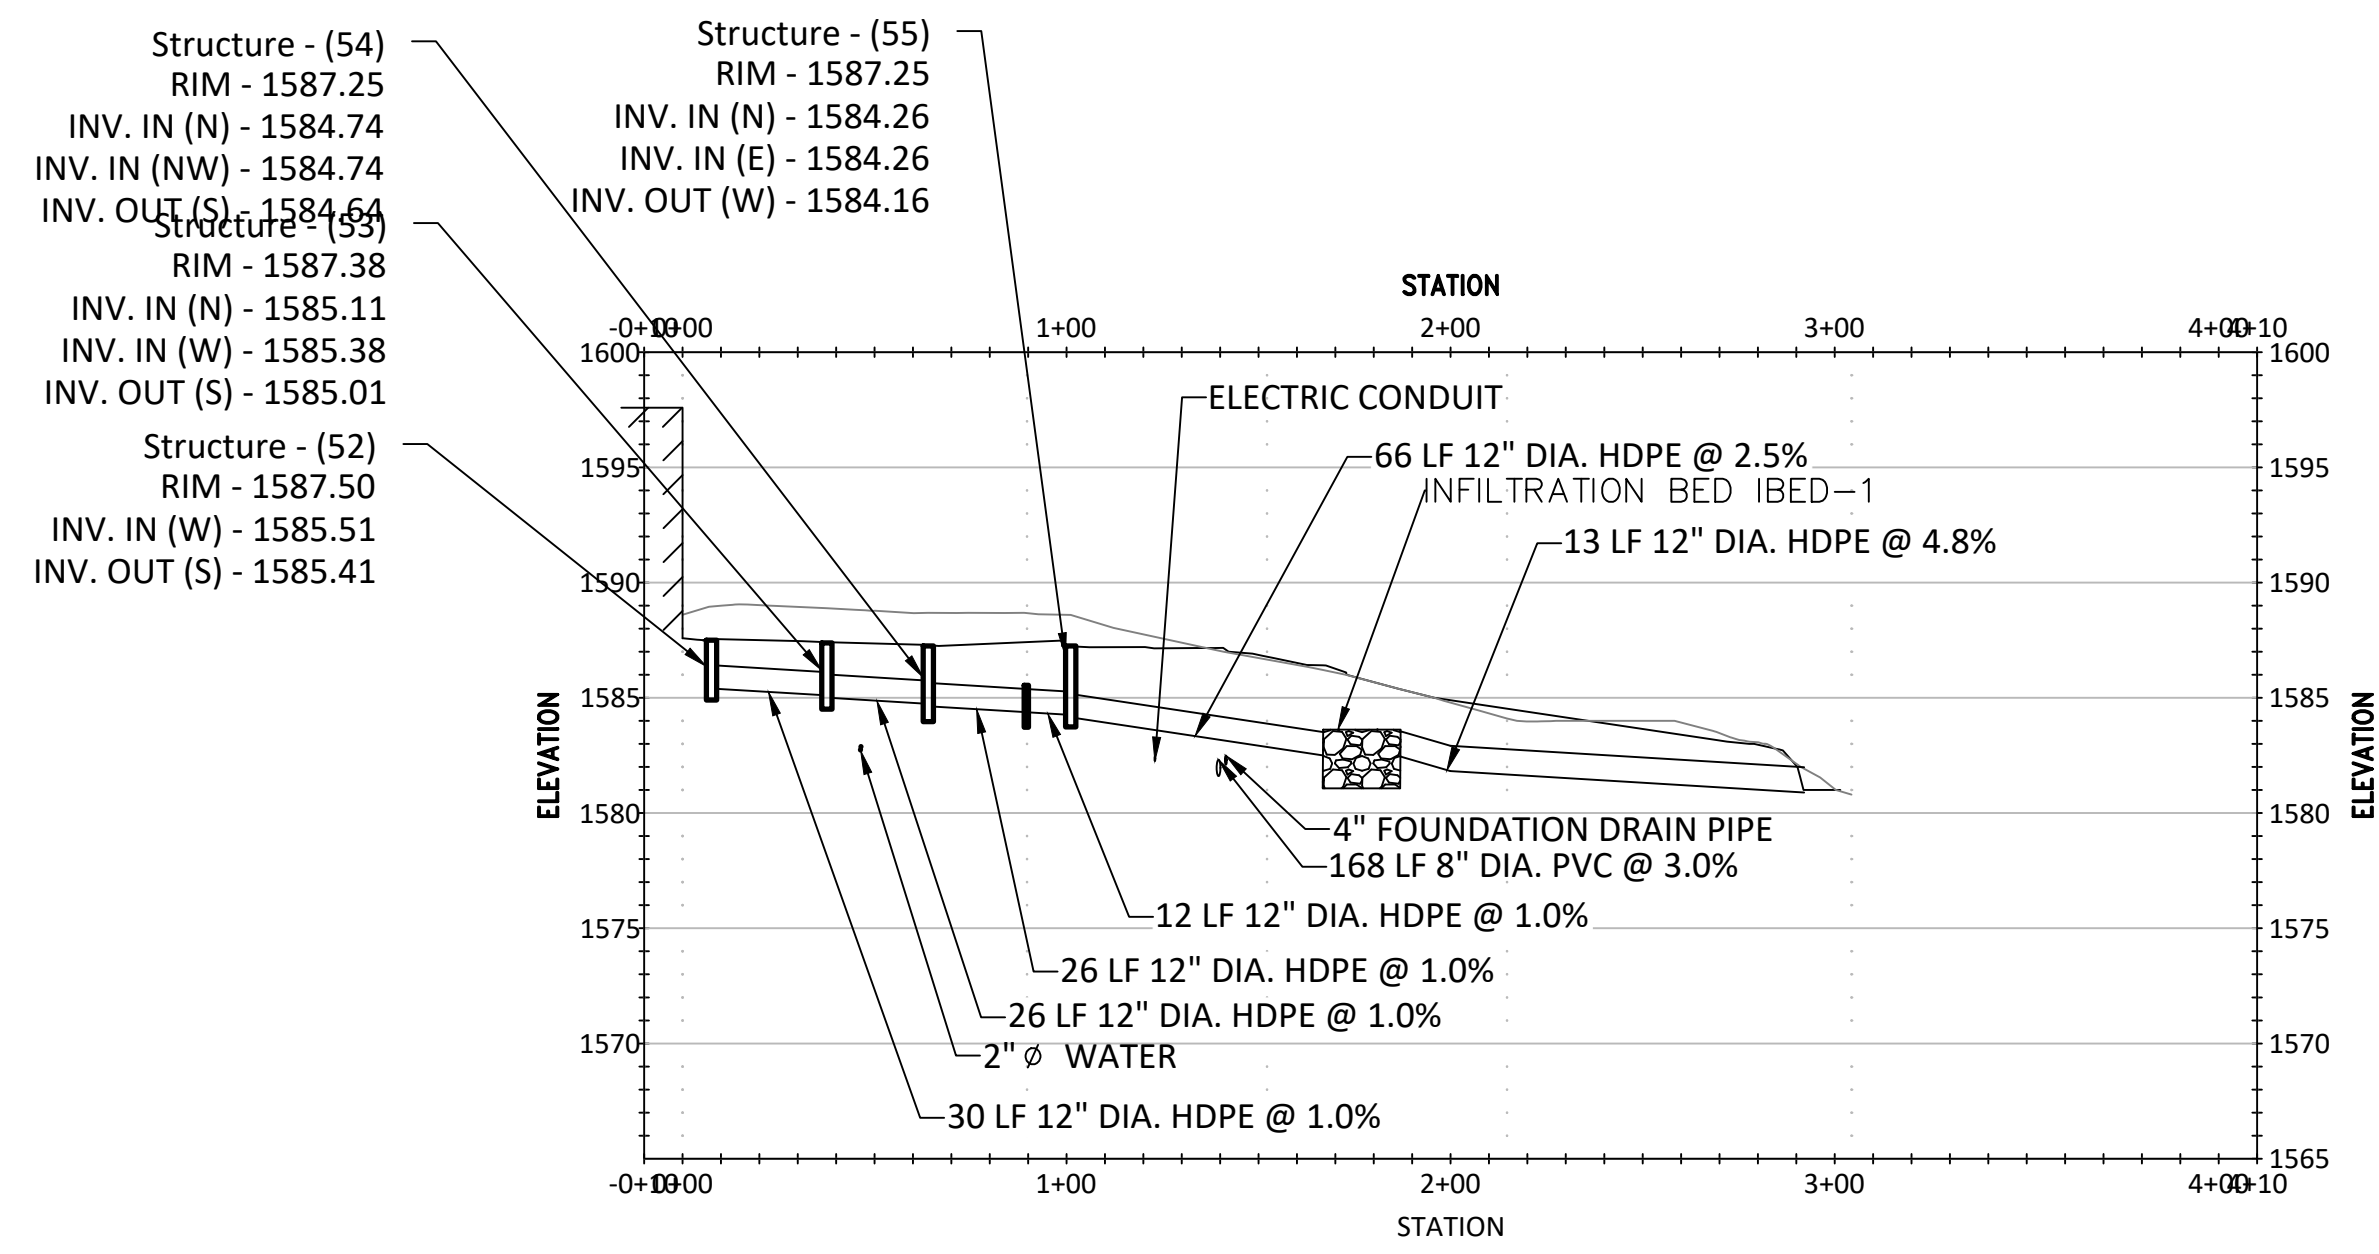


PROFILE VIEW
C-41 CAMP LOOP C - STORMWATER LINE 1"=50' H, 1"=10' V




PROFILE VIEW
C-41 CAMP LOOP C - STORMWATER LINE 1"=50' H, 1"=10' V

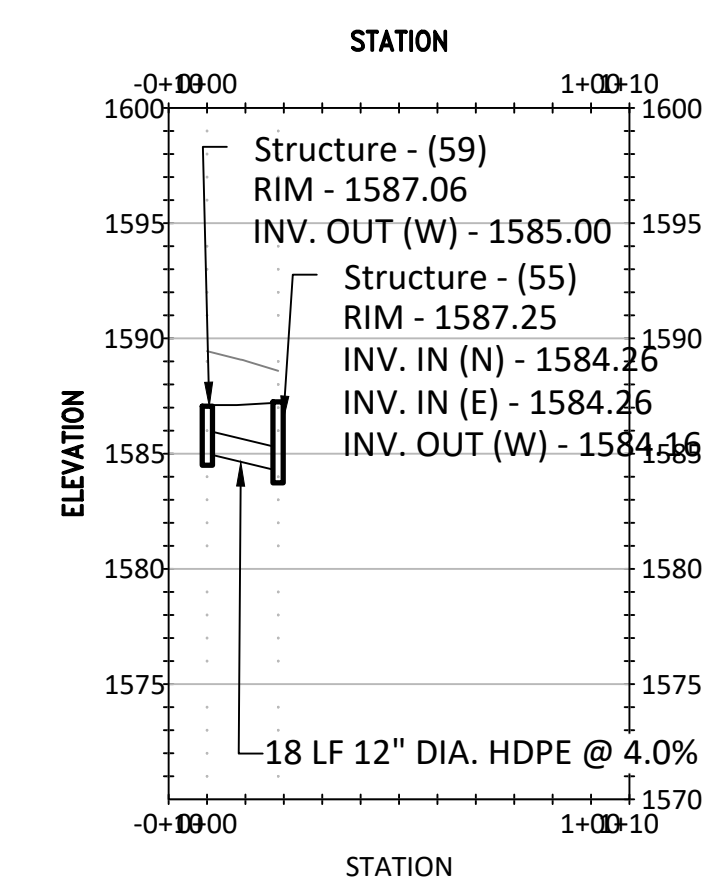


PROFILE VIEW
C-41 CAMP LOOP C - FOUNDATION DRAIN 1"=50' H, 1"=10' V

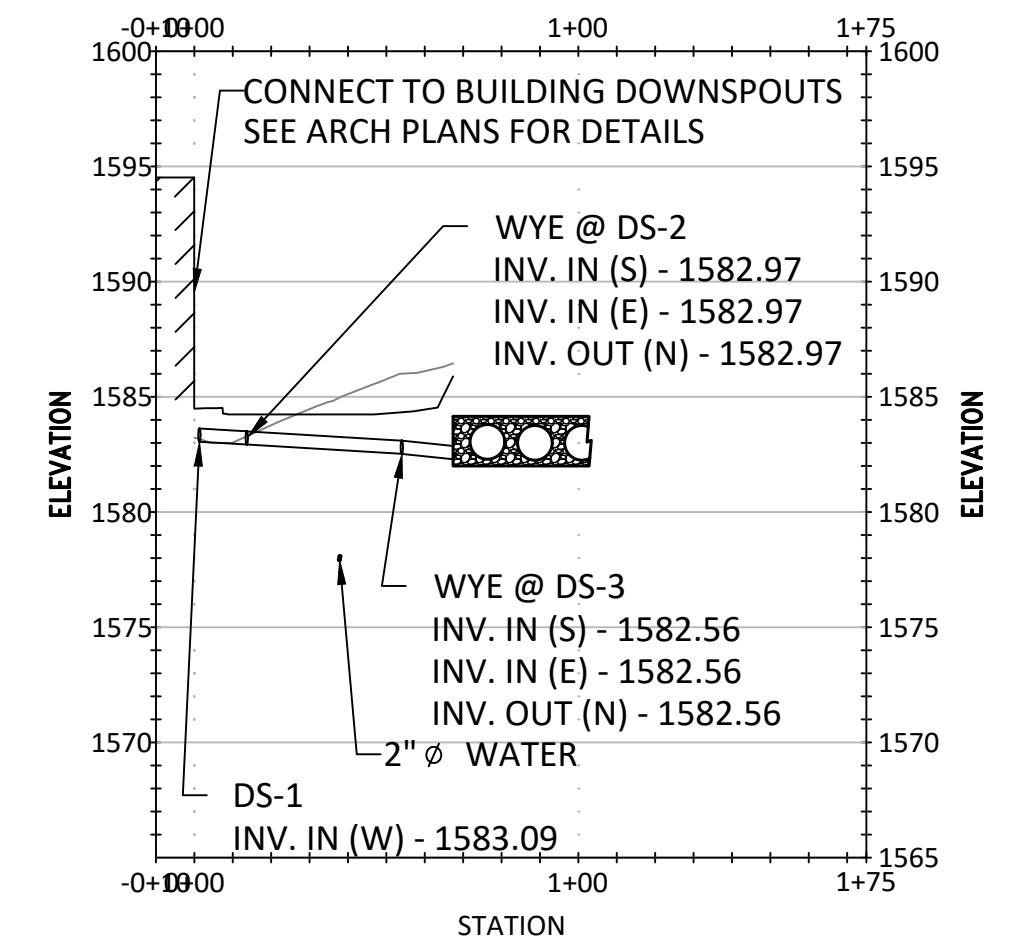


PROFILE VIEW
C-41 CAMP SHEHAQUA - STORM 1 1"=50' H, 1"=10' V

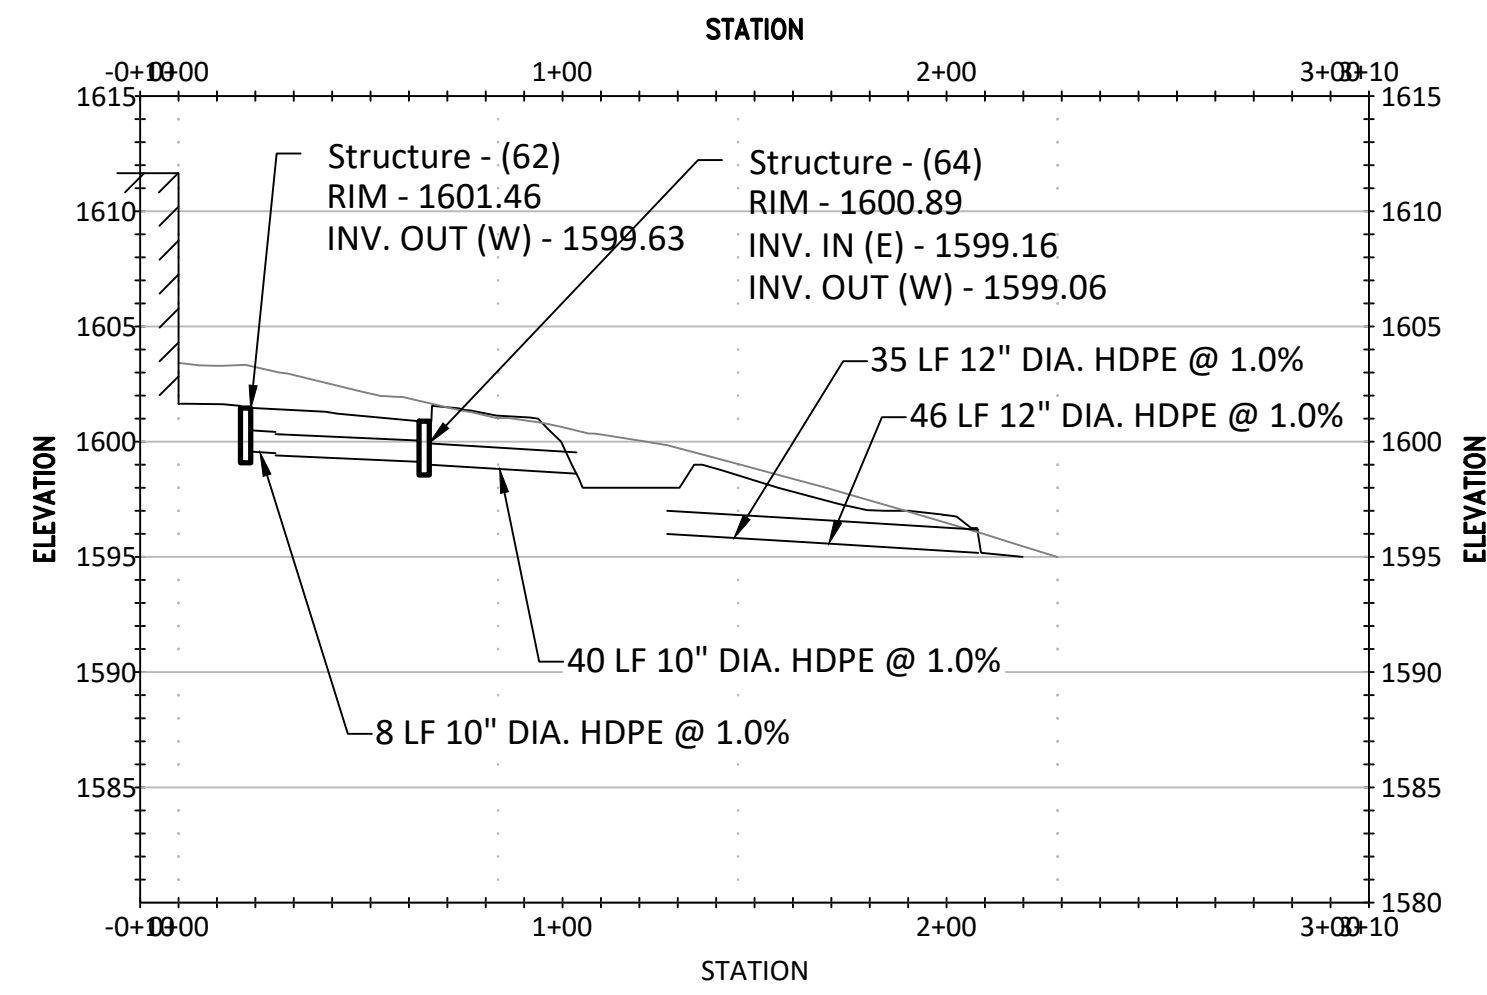


PROFILE VIEW
C-41 CAMP OGTC - STORMWATER LINE 1"=50' H, 1"=10' V

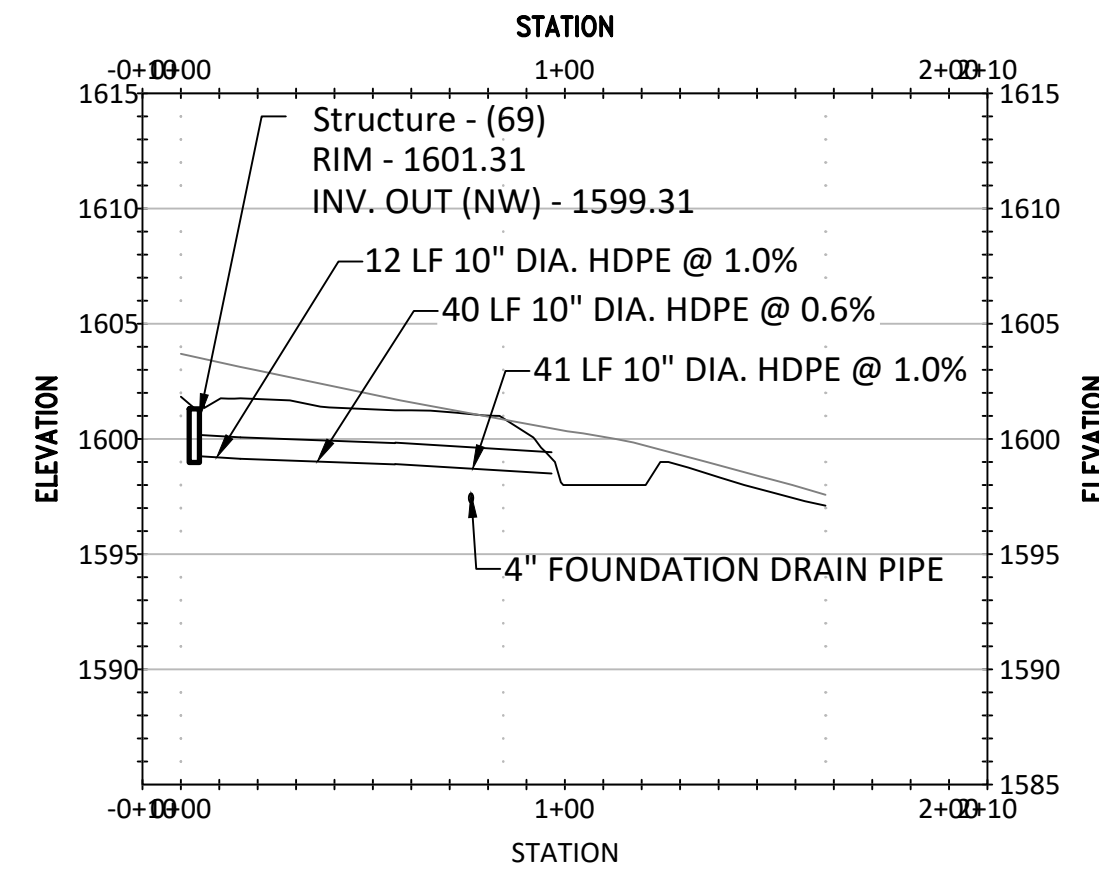


PROFILE VIEW
C-41 CAMP OGTC - STORMWATER LINE 1"=50' H, 1"=10' V

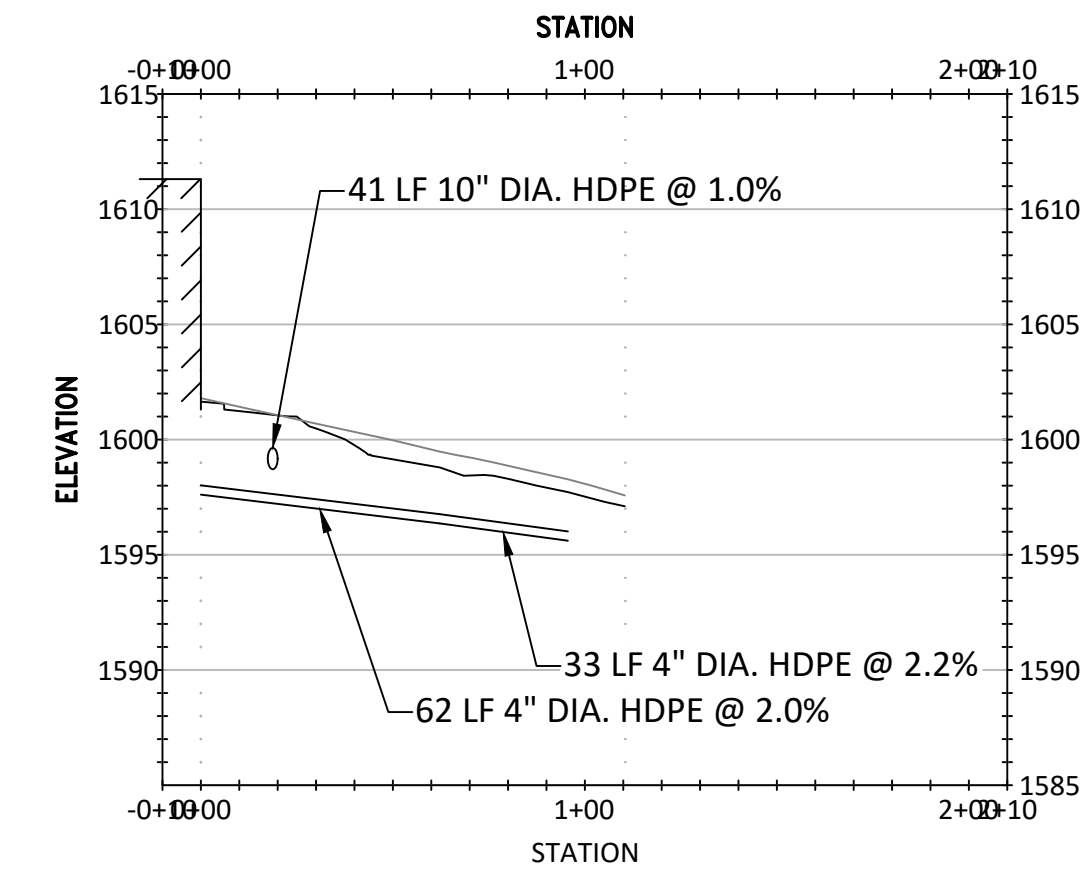


PROFILE VIEW
C-41 CAMP OGTC - FOUNDATION DRAIN 1"=50' H, 1"=10' V

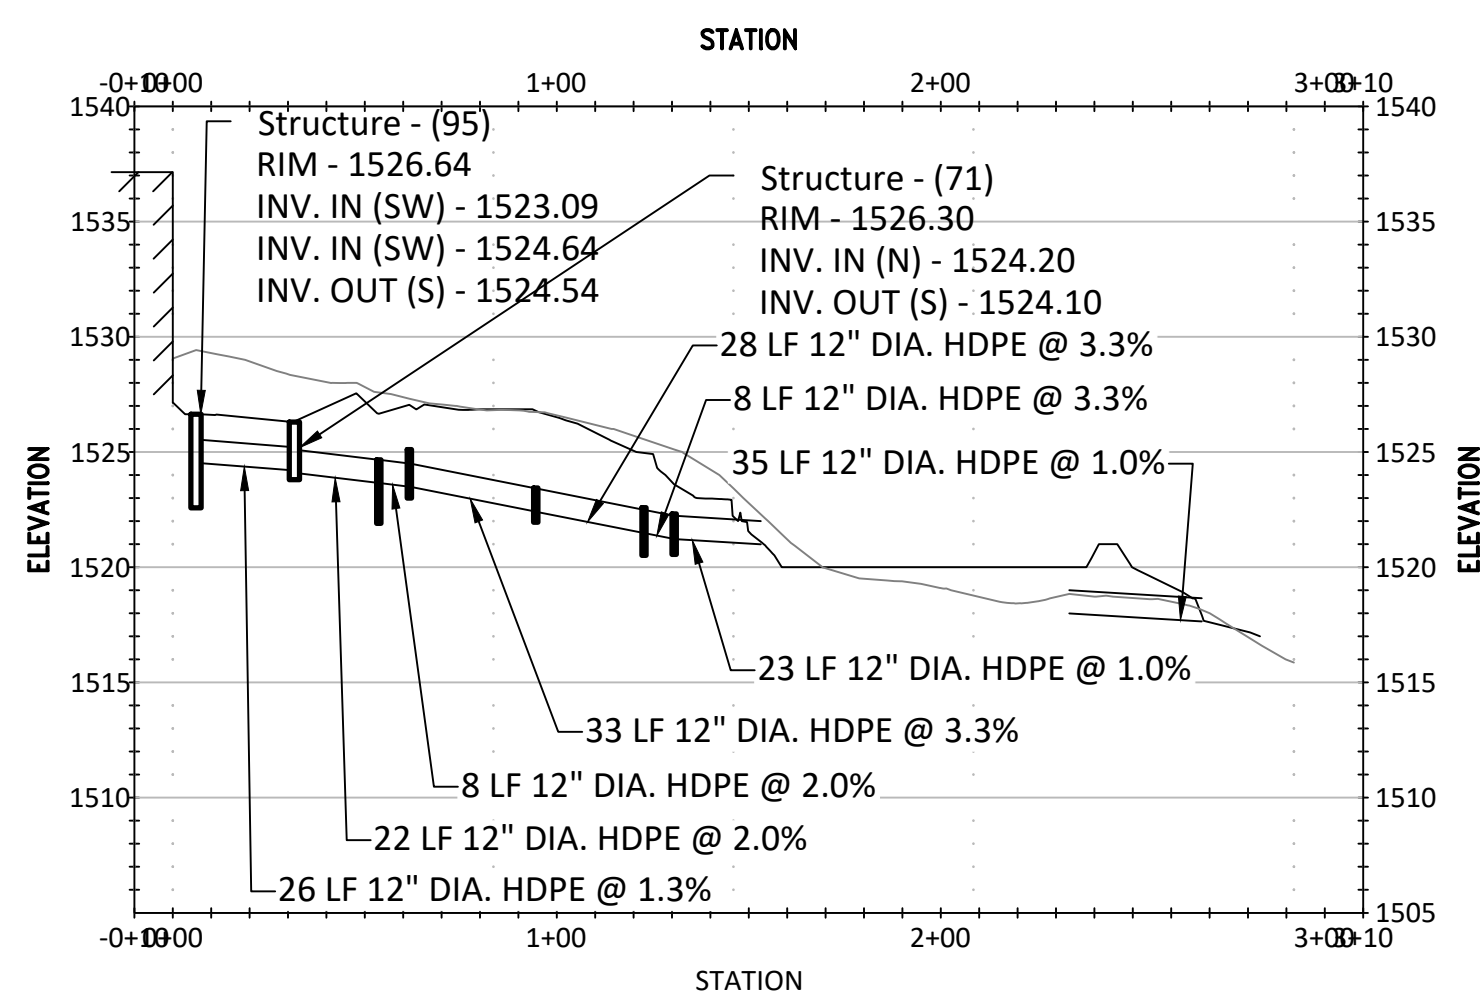

PROFILE VIEW
C-41 CAMP DADDY ALLEN - STORMWATER LINE 1"=50' H, 1"=10' V

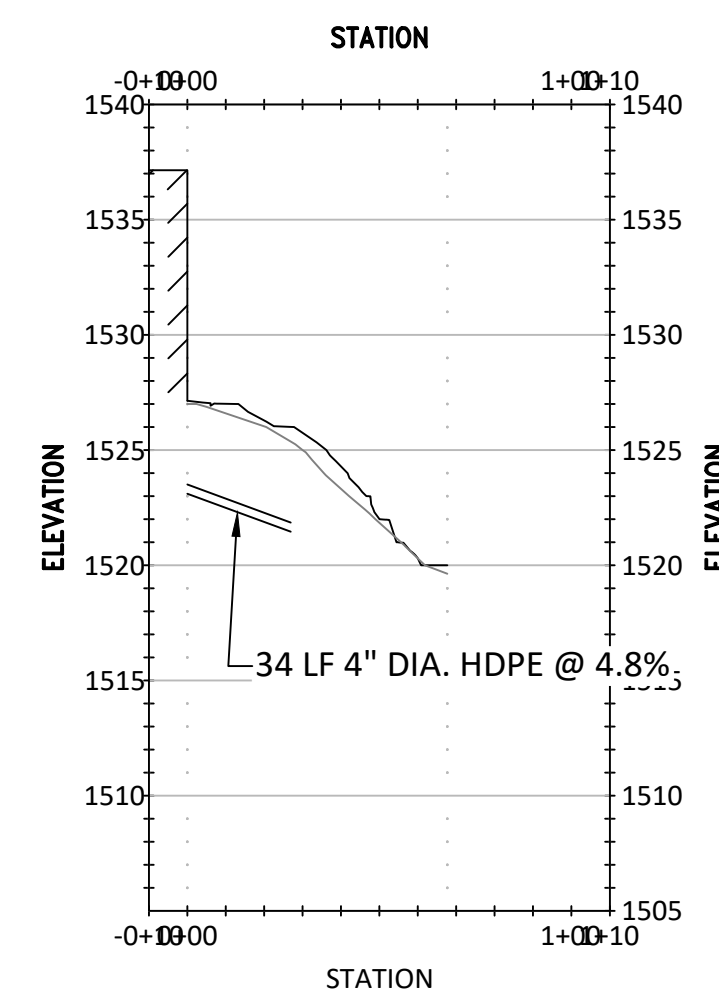

PROFILE VIEW
C-41 CAMP DADDY ALLEN - FOUNDATION DRAIN 1"=50' H, 1"=10' V

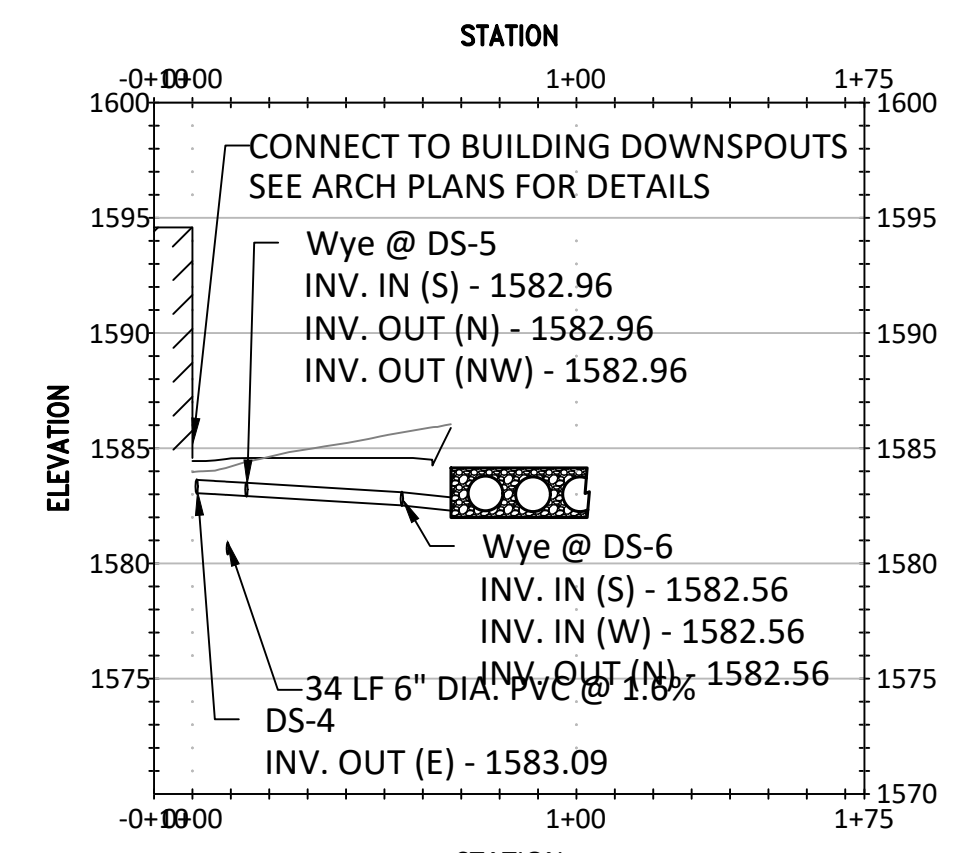


PROFILE VIEW
C-41 CAMP SHEHAQUA - STORM 2 1"=50' H, 1"=10' V

CONSTRUCTION DOCUMENTS



RECORD REVISIONS

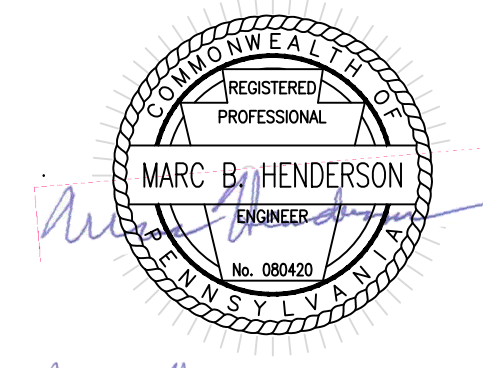

SIGNATURE: Marc B. Henderson DATE: 06/15/22

SMP ARCHITECTS
1600 WALNUT STREET, SECOND FLOOR
PHILADELPHIA, PENNSYLVANIA

COMMONWEALTH OF PENNSYLVANIA
DEPARTMENT OF GENERAL SERVICES
HARRISBURG, PENNSYLVANIA

D.G.S. PROJECT No. C-114-0006 PHASE 1


HICKORY RUN STATE PARK
LATRINE IMPROVEMENTS
DEPT of CONSERVATION AND NATURAL RESOURCES
WHITE HAVEN, CARBON COUNTY, PA

STORMWATER PROFILES

VERIFY SCALE
BAR IS ONE (1) INCH LONG ON ORIGINAL DRAWING.
0 1
IF BAR IS NOT ONE (1) INCH LONG, ADJUST SCALE ACCORDINGLY.


CONTRACTOR SHALL FIELD VERIFY ALL DIMENSIONS. VARIANCE FROM CONTRACT DOCUMENTS NOT PERMITTED WITHOUT PROFESSIONAL & BUREAU OF CONSTRUCTION APPROVAL.	DRAWN BY L GILL	DATE 06/17/2022	DRAWING No. C-41
	CHECKED BY M HENDERSON	SCALE AS NOTED	

FILE PATH: U:\2020\09077 - Hickory Run State Park\CAD\Shehaqua\2022\Storm Profiles.dwg PLOTTED BY: Laura L. Gill LAYOUT TAB: STORMWATER PROFILES

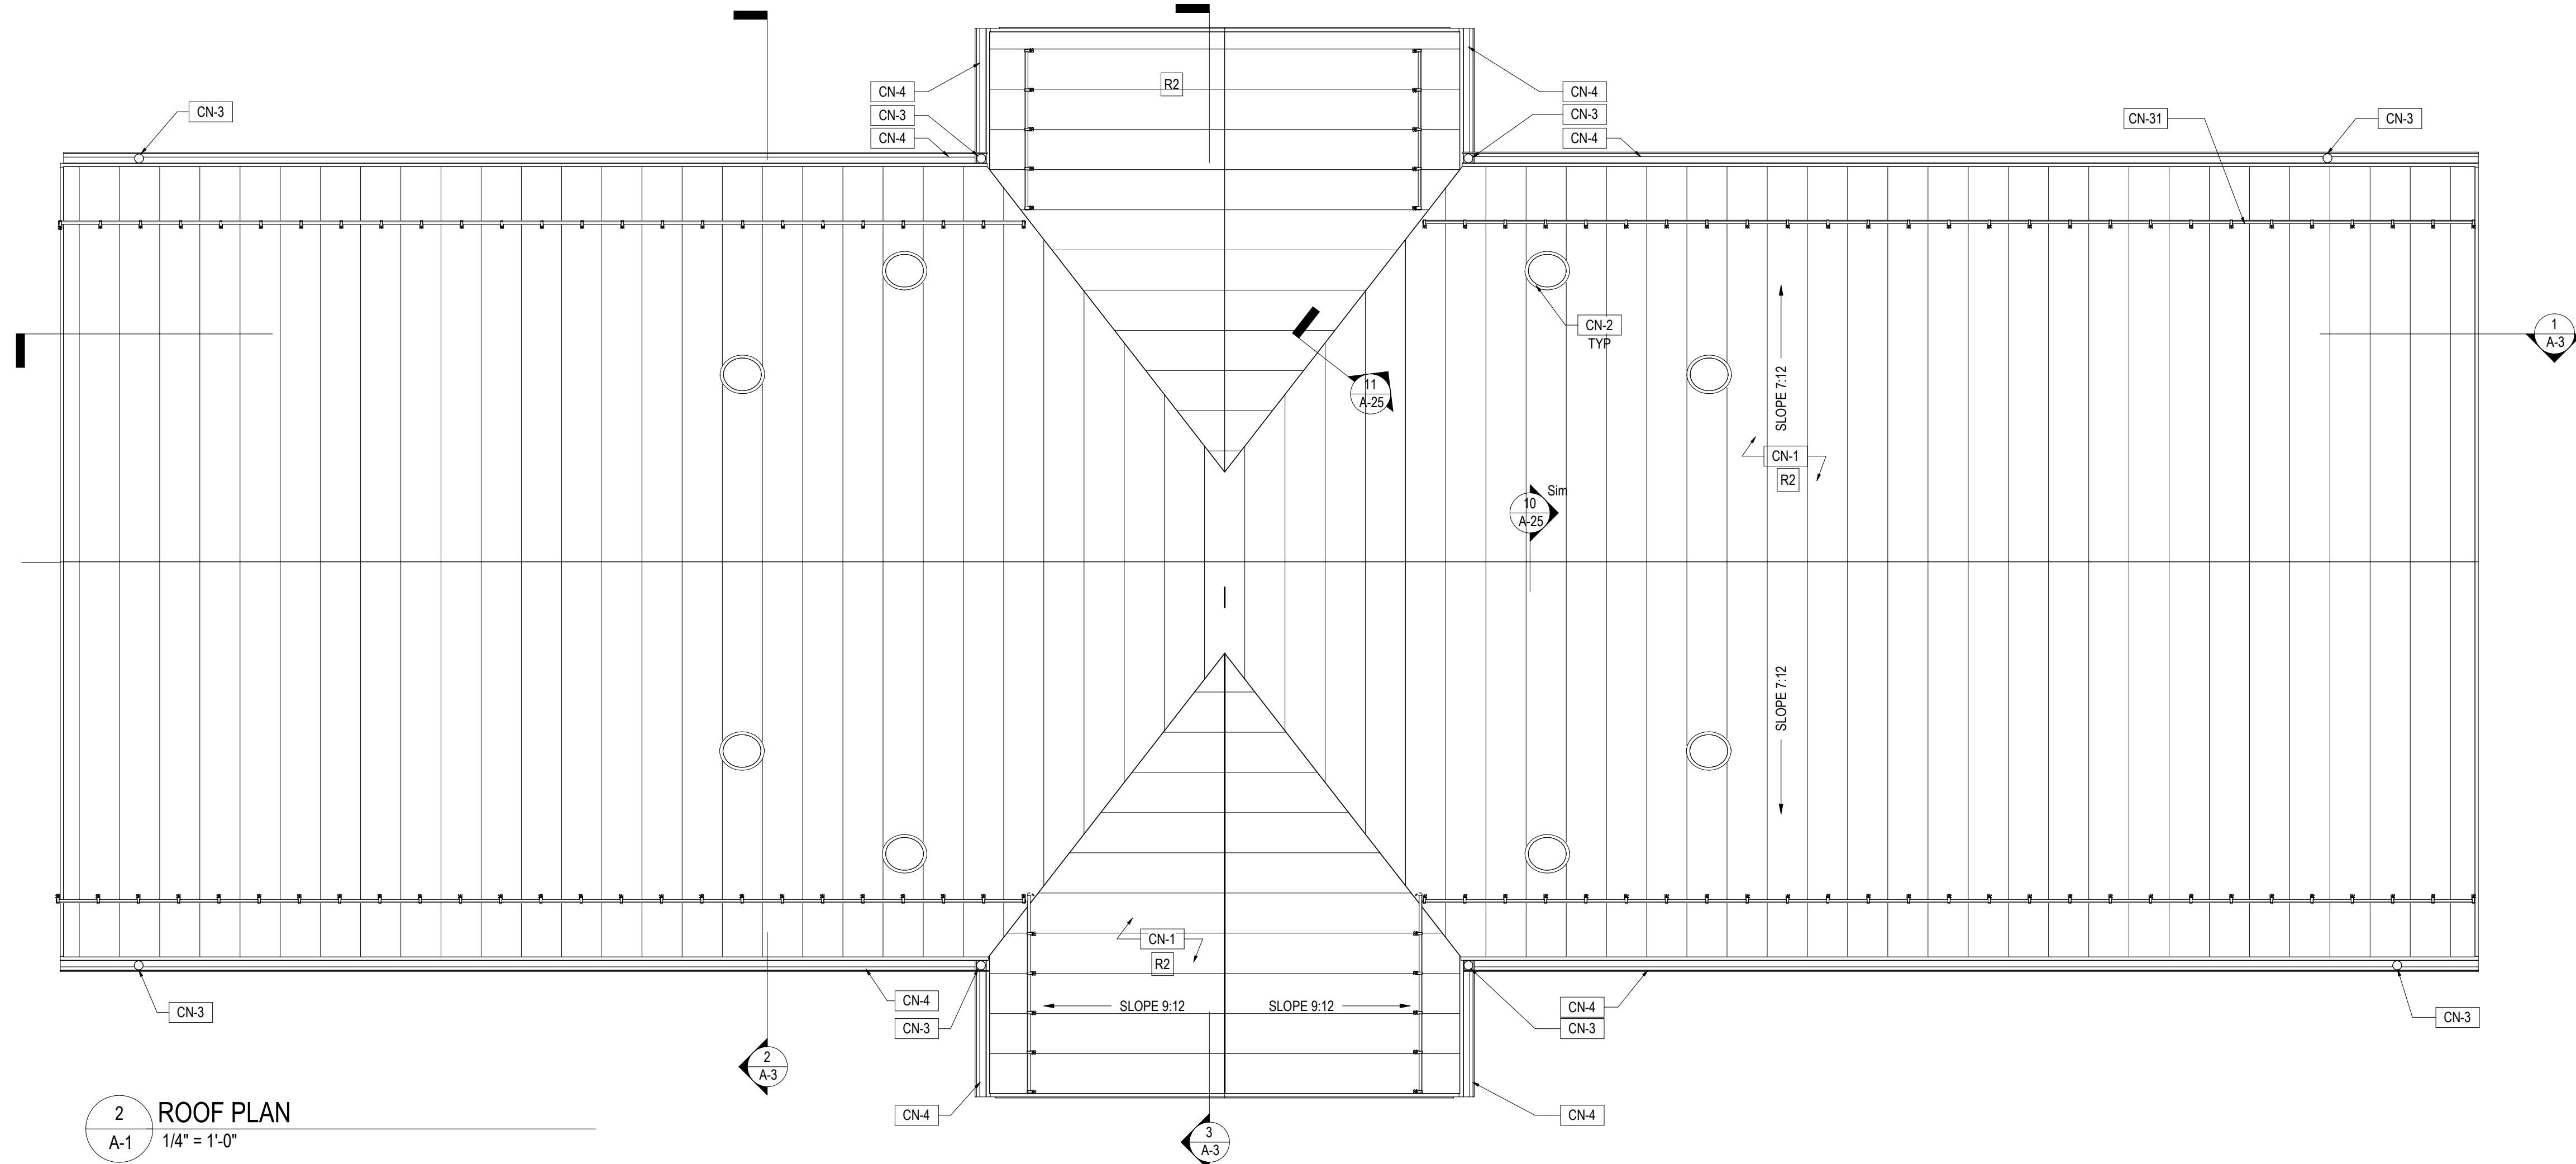


- GENERAL NOTES:**
- HVAC EQUIPMENT IS PROVIDED BY THE 2 CONTRACT.
 - PLUMBING FIXTURES ARE PROVIDED BY THE 3 CONTRACT.
 - LIGHT FIXTURES ARE PROVIDED BY THE 4 CONTRACT.
 - ALL EXPOSED SURFACES OF GFCM BLOCKS IN OCCUPIED SPACES SHALL BE GROUND AND FINISHED.

- CONSTRUCTION NOTES (CN)**
- CN-1 STANDING SEAM METAL ROOF (R2)
 - CN-2 TUBULAR SKYLIGHT
 - CN-3 METAL DOWNSPOUT
 - CN-4 METAL GUTTER
 - CN-5 CONCRETE SIDEWALK. SEE CIVIL DWGS.
 - CN-6 WATER FOUNTAIN. SEE MEP DWGS.
 - CN-7 DISHWASHING SINK
 - CN-8 EXTERIOR COUNTER
 - CN-9 STONE VENEER BENCH WITH CAST STONE SEAT
 - CN-10 NOT USED
 - CN-11 WALL MOUNTED FIRE EXTINGUISHER
 - CN-12 FLOOR DRAIN. SEE MEP DWGS.
 - CN-13 CHANGING AREA PARTITION
 - CN-14 BENCH BY PARTITION MANUFACTURER, HOOK (TYPE I) MOUNTED ABOVE
 - CN-15 ADA FOLDING SHOWER SEAT
 - CN-16 TRENCH DRAIN. SEE MEP DWGS.
 - CN-17 EPOXY FLOOR. SLOPE TO DRAIN.
 - CN-18 MOP SINK
 - CN-19 QUARTZ COUNTERTOP
 - CN-20 ELECTRIC HAND DRYER
 - CN-21 SOAP DISPENSER
 - CN-22 TOILET PARTITION
 - CN-23 URINAL SCREEN
 - CN-24 TOILET PAPER DISPENSER
 - CN-25 ADA GRAB BARS
 - CN-26 WASTE RECEPTACLE
 - CN-27 BABY CHANGING STATION
 - CN-28 ASPHALT SHINGLE ROOF (R1)
 - CN-29 STONE VENEER COLUMN
 - CN-30 WOOD COLUMNS WITH STONE VENEER BASE
 - CN-31 SNOW GUARD
 - CN-32 HOPE WALL MOUNTED BENCH
 - CN-33 ROOFLINE ABOVE
 - CN-34 SEE MEP DRAWINGS FOR EQUIPMENT IN UTILITY ROOM
 - CN-35 CLEAR FLOOR SPACE FOR LADDER
 - CN-36 UTILITY SHELF

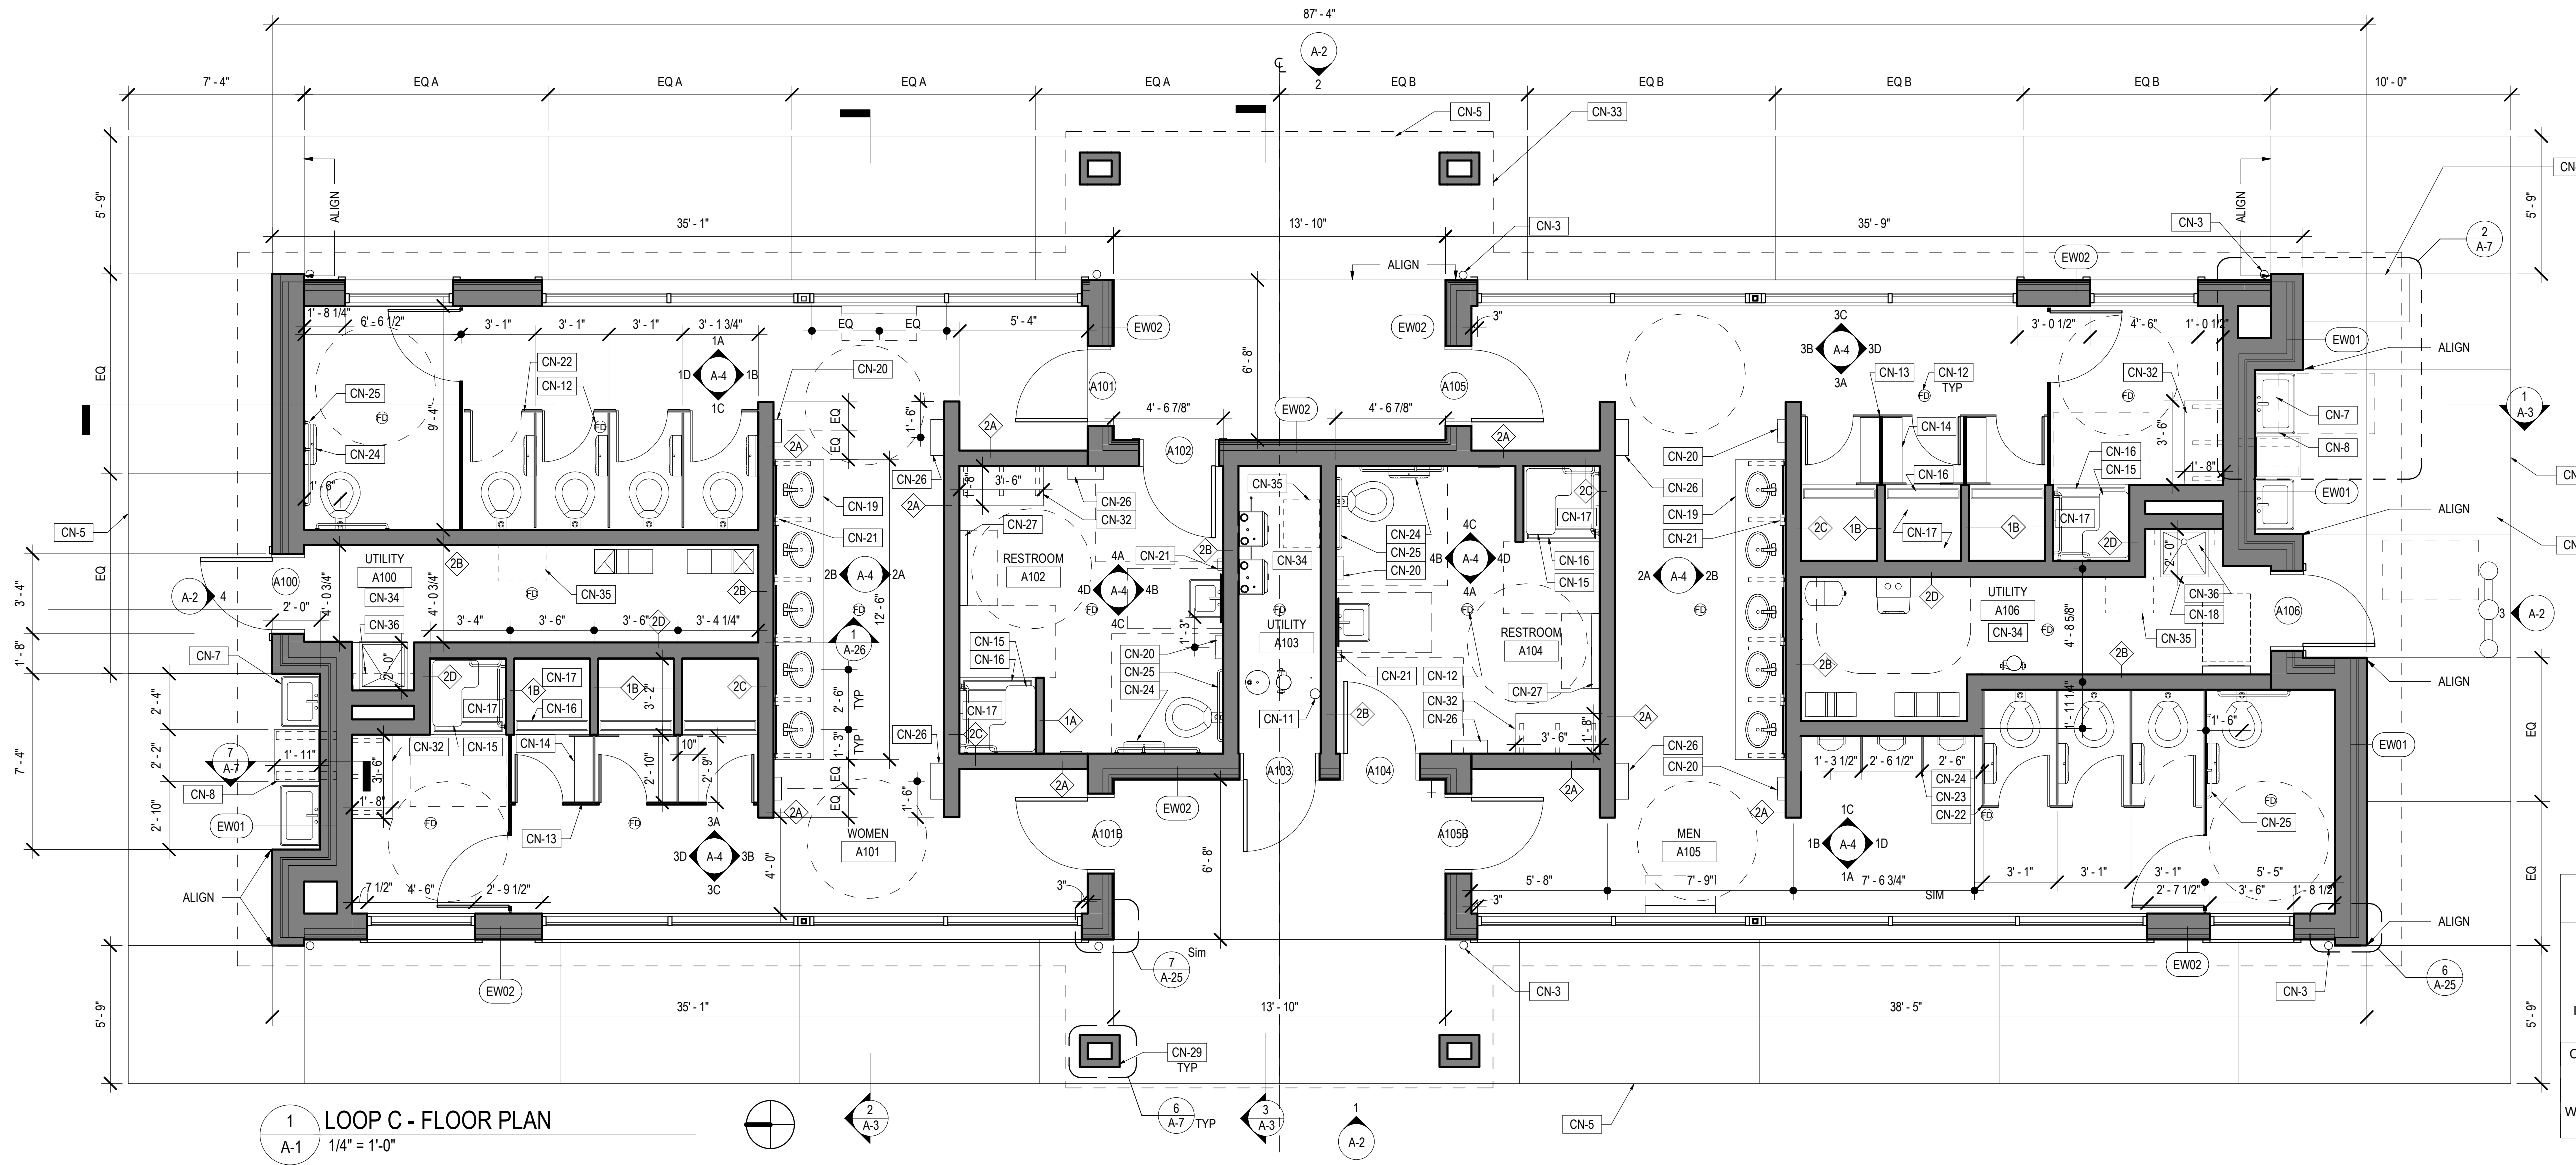


CONSTRUCTION DOCUMENTS	
RECORD REVISIONS	
SIGNATURE _____ DATE 03/05/2021	
SMP ARCHITECTS 1600 WALNUT STREET, SECOND FLOOR PHILADELPHIA, PENNSYLVANIA	
COMMONWEALTH OF PENNSYLVANIA DEPARTMENT OF GENERAL SERVICES HARRISBURG, PENNSYLVANIA	
D.G.S. PROJECT No. C-114-0006 PHASE 1	
HICKORY RUN STATE PARK LATRINE IMPROVEMENTS DEPT OF CONSERVATION AND NATURAL RESOURCES WHITE HAVEN, CARBON COUNTY, PA	
LOOP C - PLANS	
VERIFY SCALE BAR IS ONE (1) INCH LONG ON ORIGINAL DRAWING: 0 ADJUST SCALE ACCORDINGLY	CONTRACTOR SHALL FIELD VERIFY ALL DIMENSIONS. VARIANCE FROM CONTRACT DOCUMENTS NOT PERMITTED WITHOUT PROFESSIONAL & BUREAU OF CONSTRUCTION APPROVAL.
DRAWN BY M STRENSKI CHECKED BY T WOODWARD	DATE 06/17/2022 SCALE AS NOTED
DRAWING No. A-1	


FILE PATH: I:\723_Hickory Run\A101_Architects\01_Best\Hickory Run State Park Latrine Improvements - 1003.dwg
 PLOTTED BY: Megan H. Strenski
 LAST SAVED: 2020/06/04 12:14 PM
 PLOTTED: 2016.11.08 10:35 AM

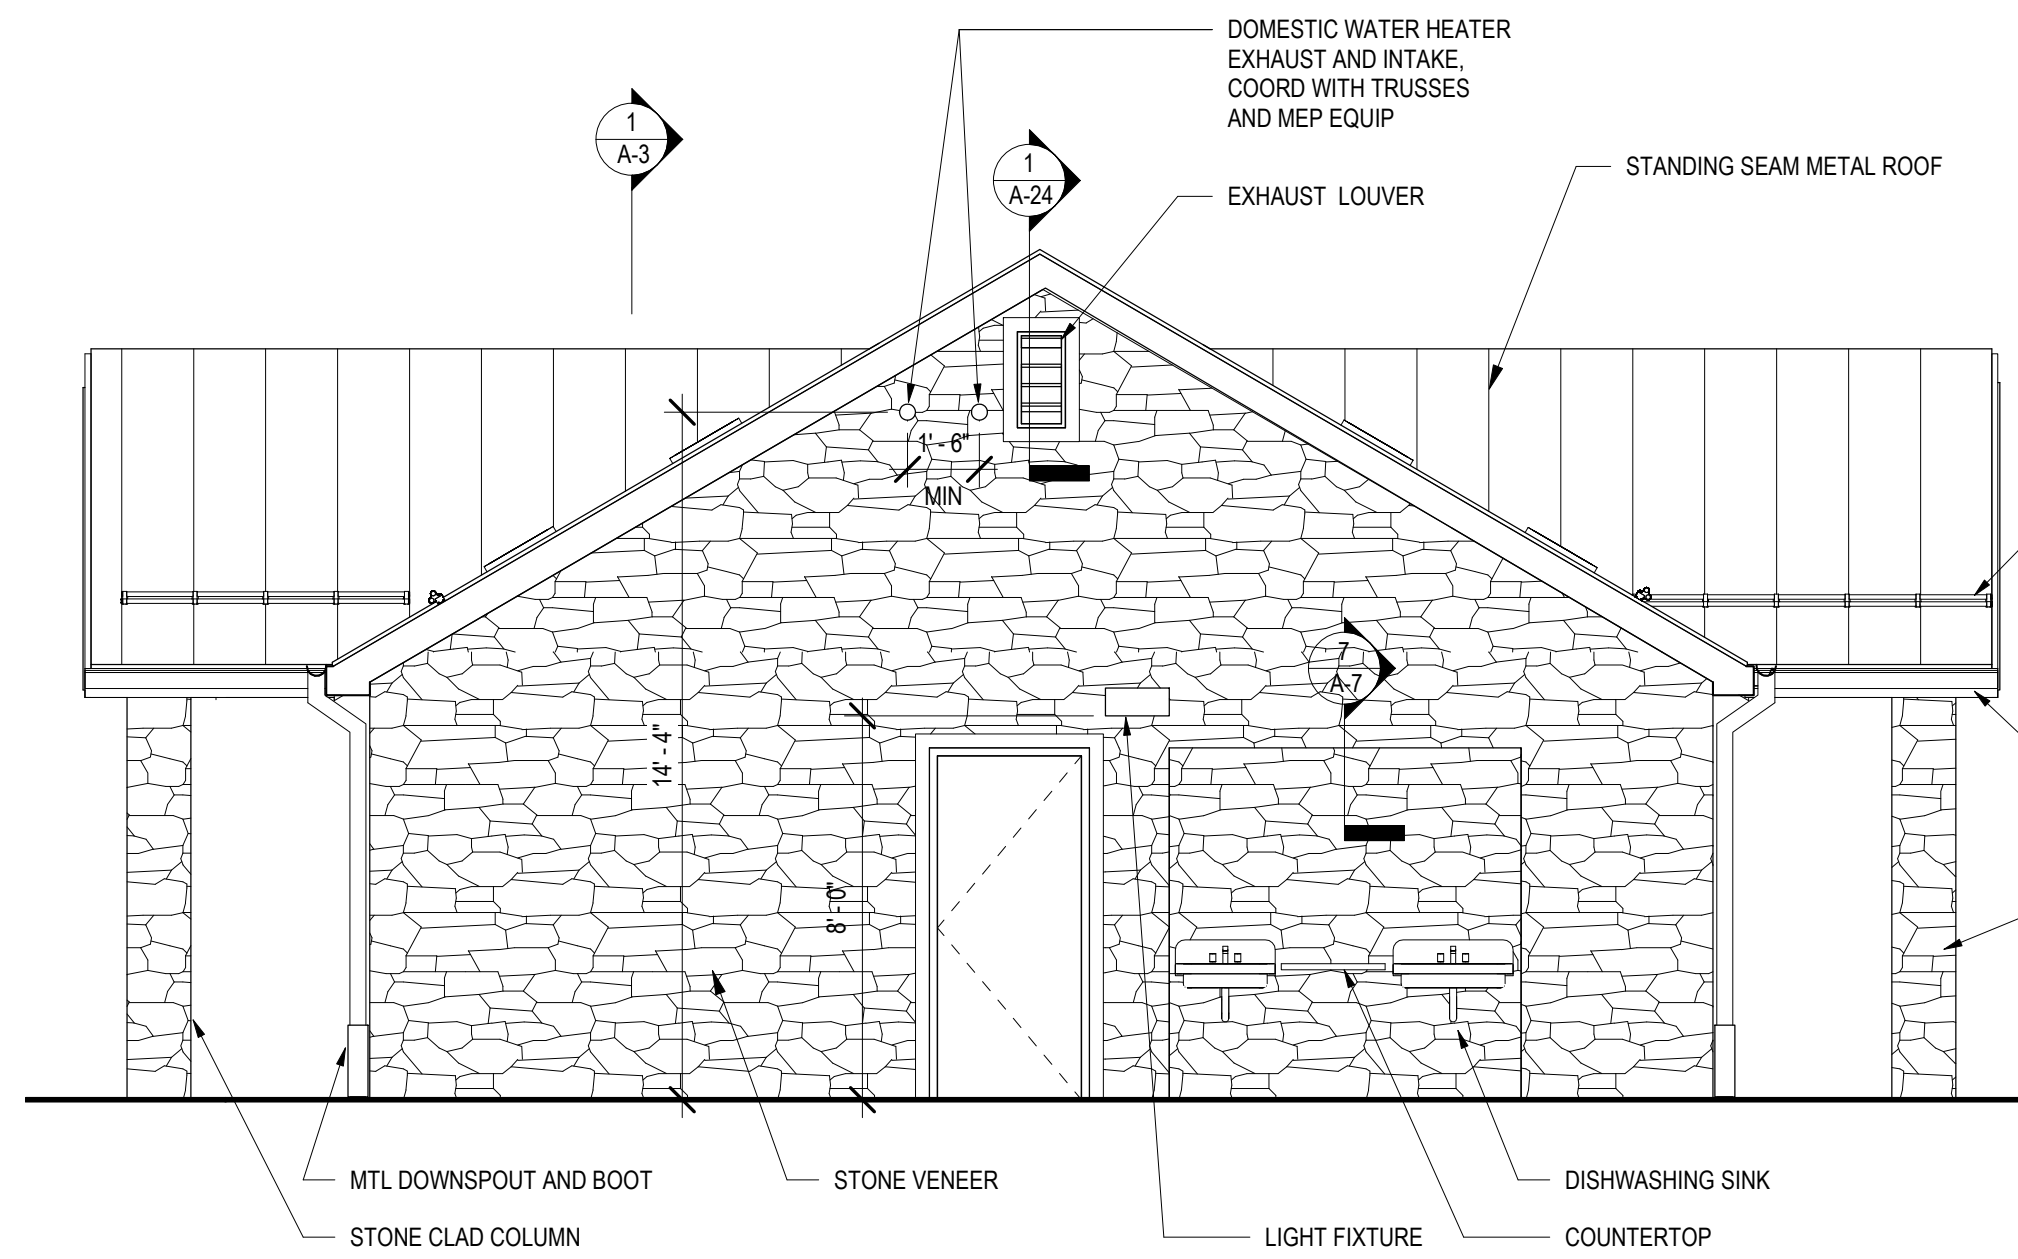


4 SOUTH ELEVATION
A-2 1/4" = 1'-0"

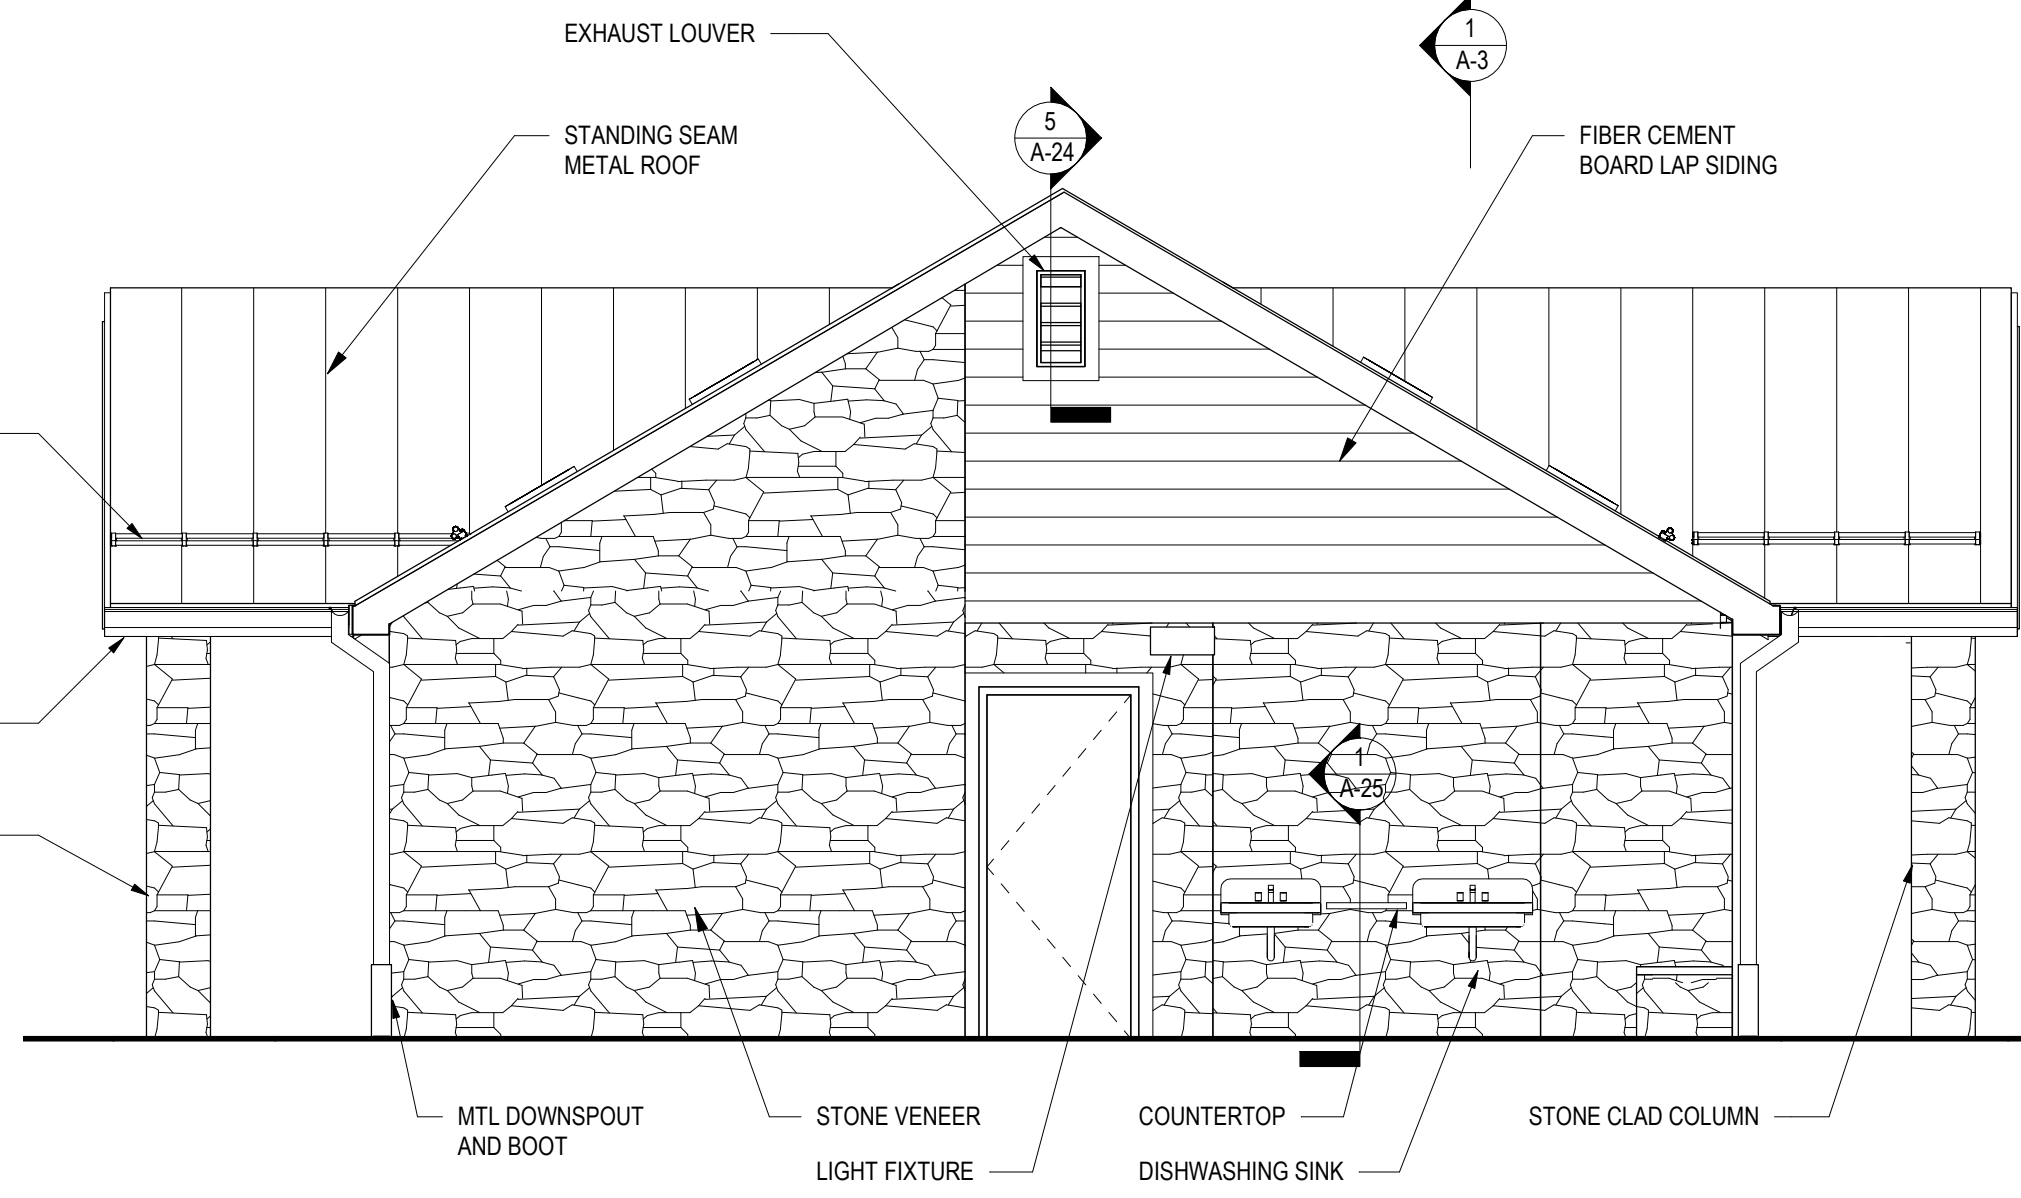

3 NORTH ELEVATION
A-2 1/4" = 1'-0"

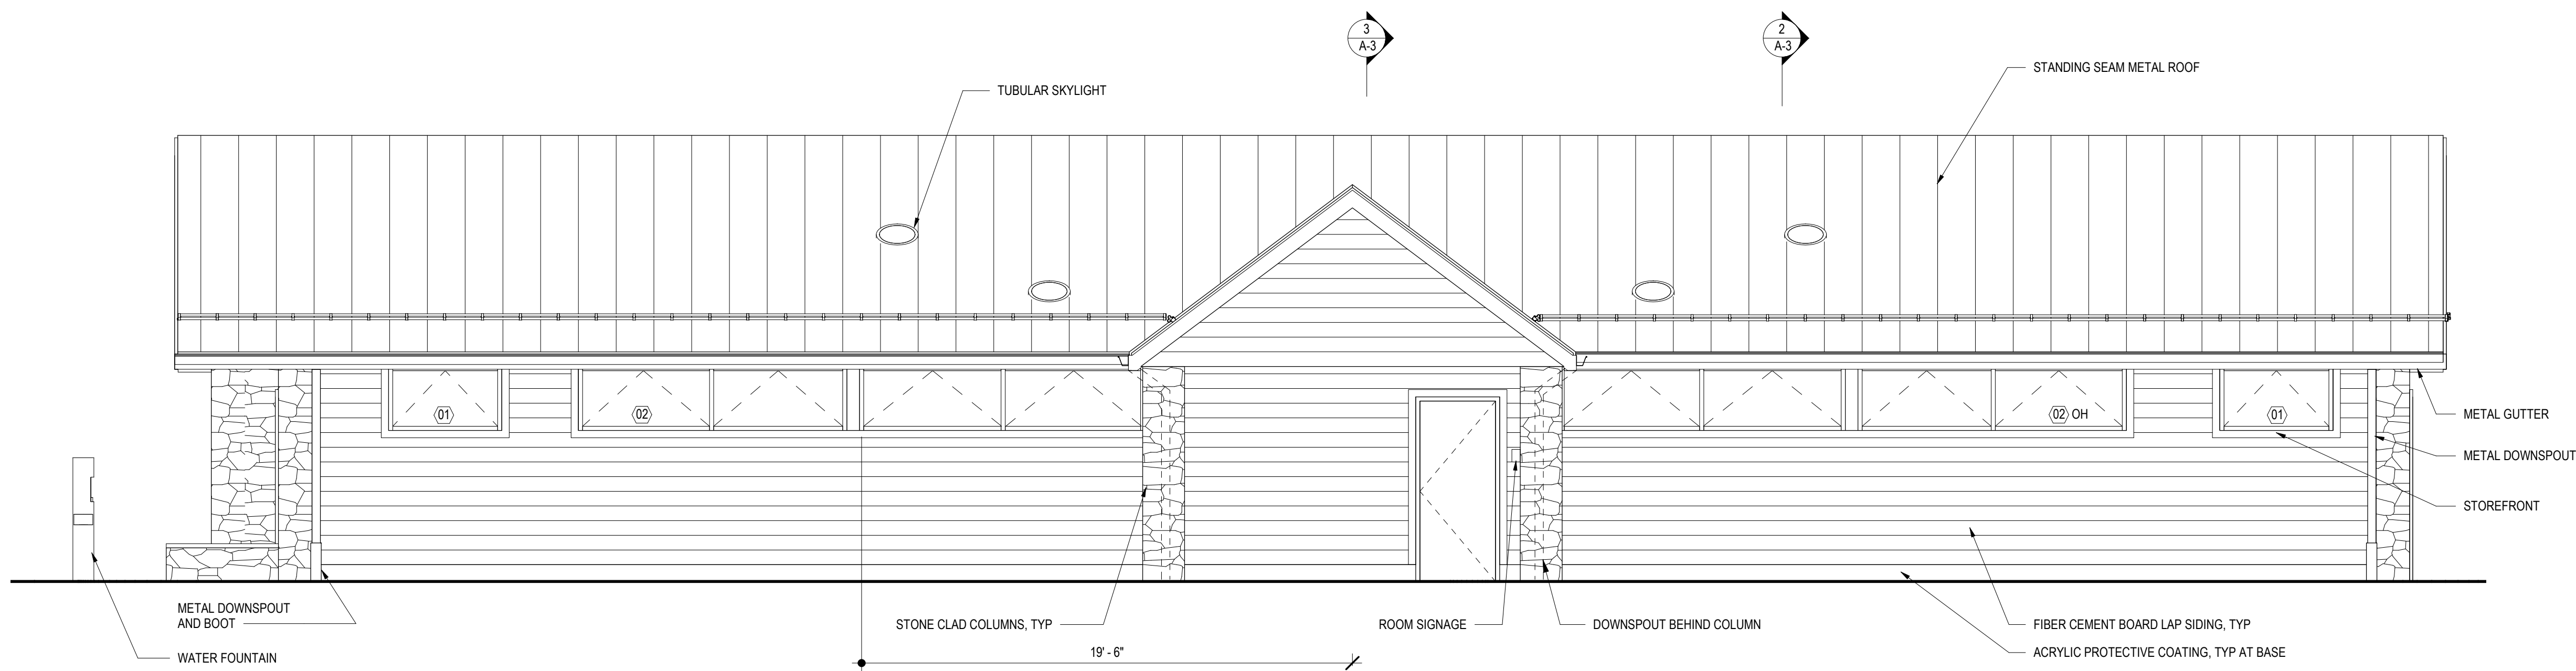


2 WEST ELEVATION
A-2 1/4" = 1'-0"

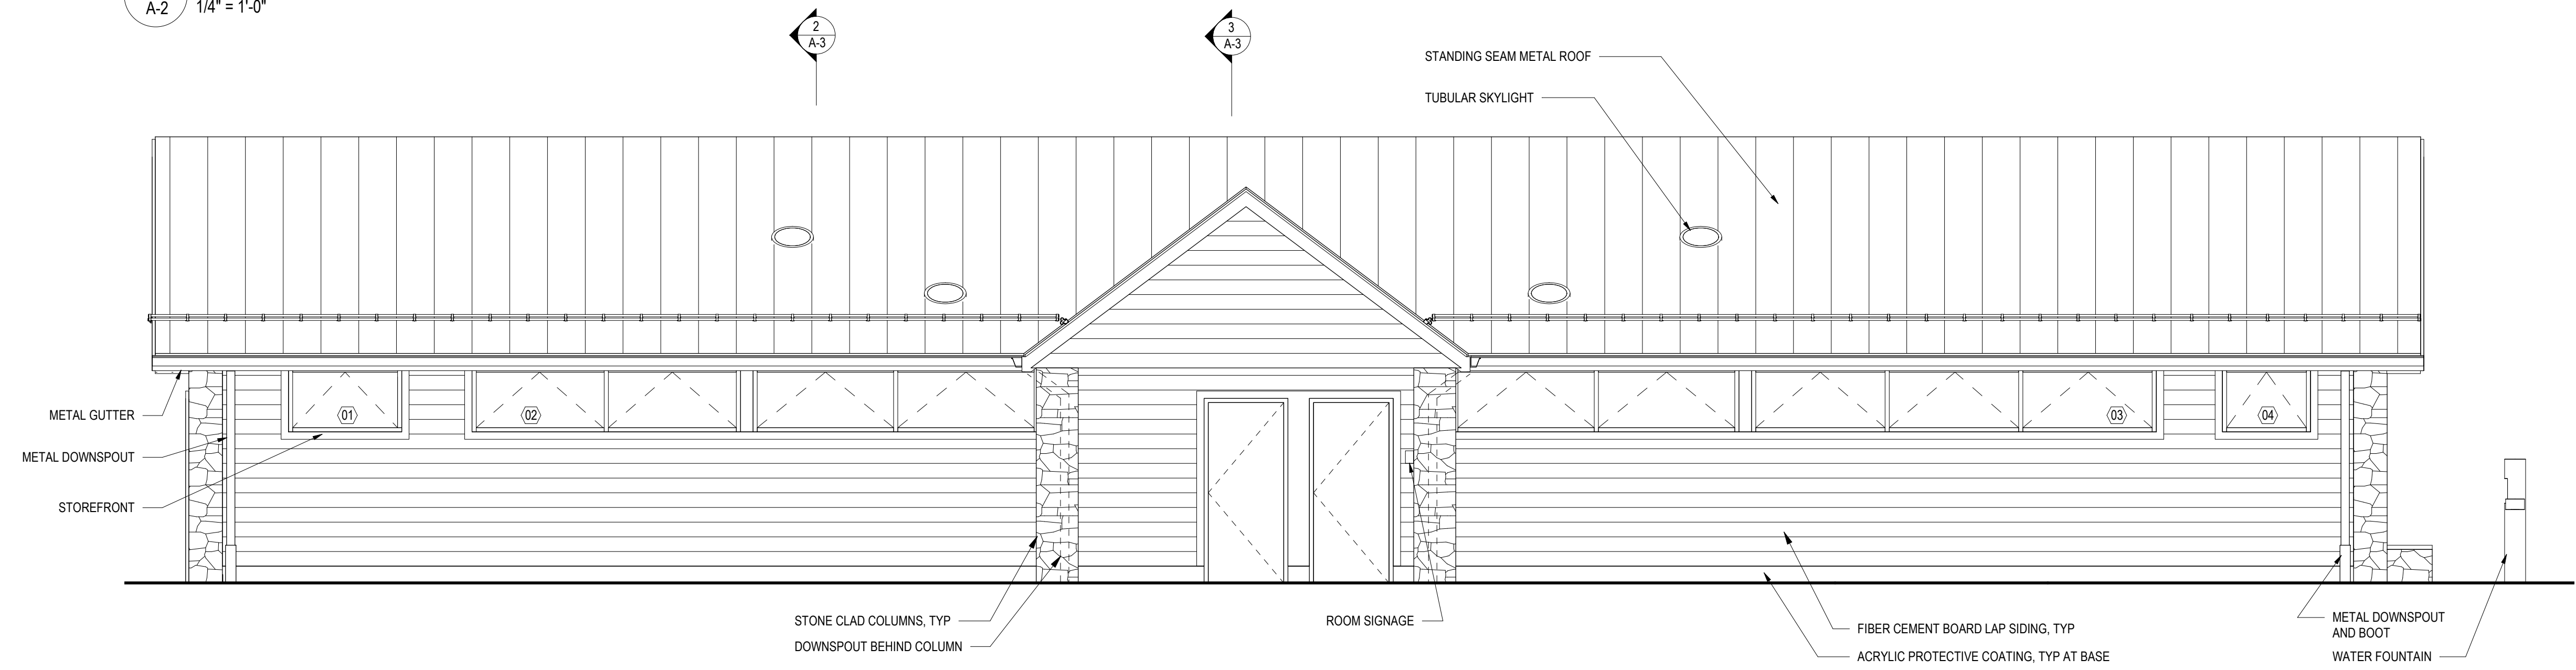

1 EAST ELEVATION
A-2 1/4" = 1'-0"

CONSTRUCTION DOCUMENTS

RECORD REVISIONS

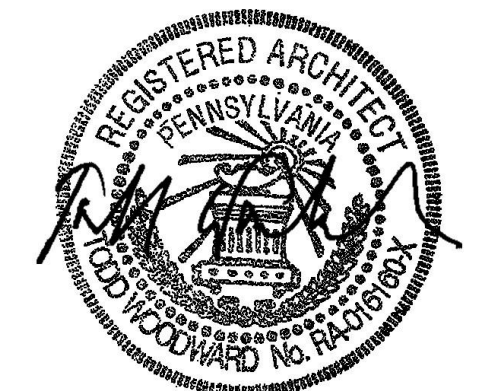

SMP ARCHITECTS
1600 WALNUT STREET, SECOND FLOOR
PHILADELPHIA, PENNSYLVANIA

COMMONWEALTH OF PENNSYLVANIA
DEPARTMENT OF GENERAL SERVICES
HARRISBURG, PENNSYLVANIA


D.G.S. PROJECT No. C-114-0006 PHASE 1
HICKORY RUN STATE PARK
LATRINE IMPROVEMENTS
DEPT of CONSERVATION AND NATURAL RESOURCES
WHITE HAVEN, CARBON COUNTY, PA
LOOP C - EXTERIOR ELEVATIONS

VERIFY SCALE
BAR IS ONE (1) INCH LONG
ON ORIGINAL DRAWING: 0 1
IF BAR IS NOT ONE (1) INCH LONG, ADJUST SCALE ACCORDINGLY


CONTRACTOR SHALL FIELD VERIFY ALL DIMENSIONS. VARIANCE FROM CONTRACT DOCUMENTS NOT PERMITTED WITHOUT PROFESSIONAL & BUREAU OF CONSTRUCTION APPROVAL.

DRAWN BY M STRENSKI	DATE 06/17/2022	DRAWING No. A-2
CHECKED BY T WOODWARD	SCALE AS NOTED	


FILE PATH: I:\723_Hickory Run\01_Arch\Drawings\01_Best\Exterior\Loop C\1224.dwg PLOTTED BY: Megan M. Strenski
LAST SAVED: 2022.06.04 12:14 PM PLOTTED: 2022.06.04 10:35 AM

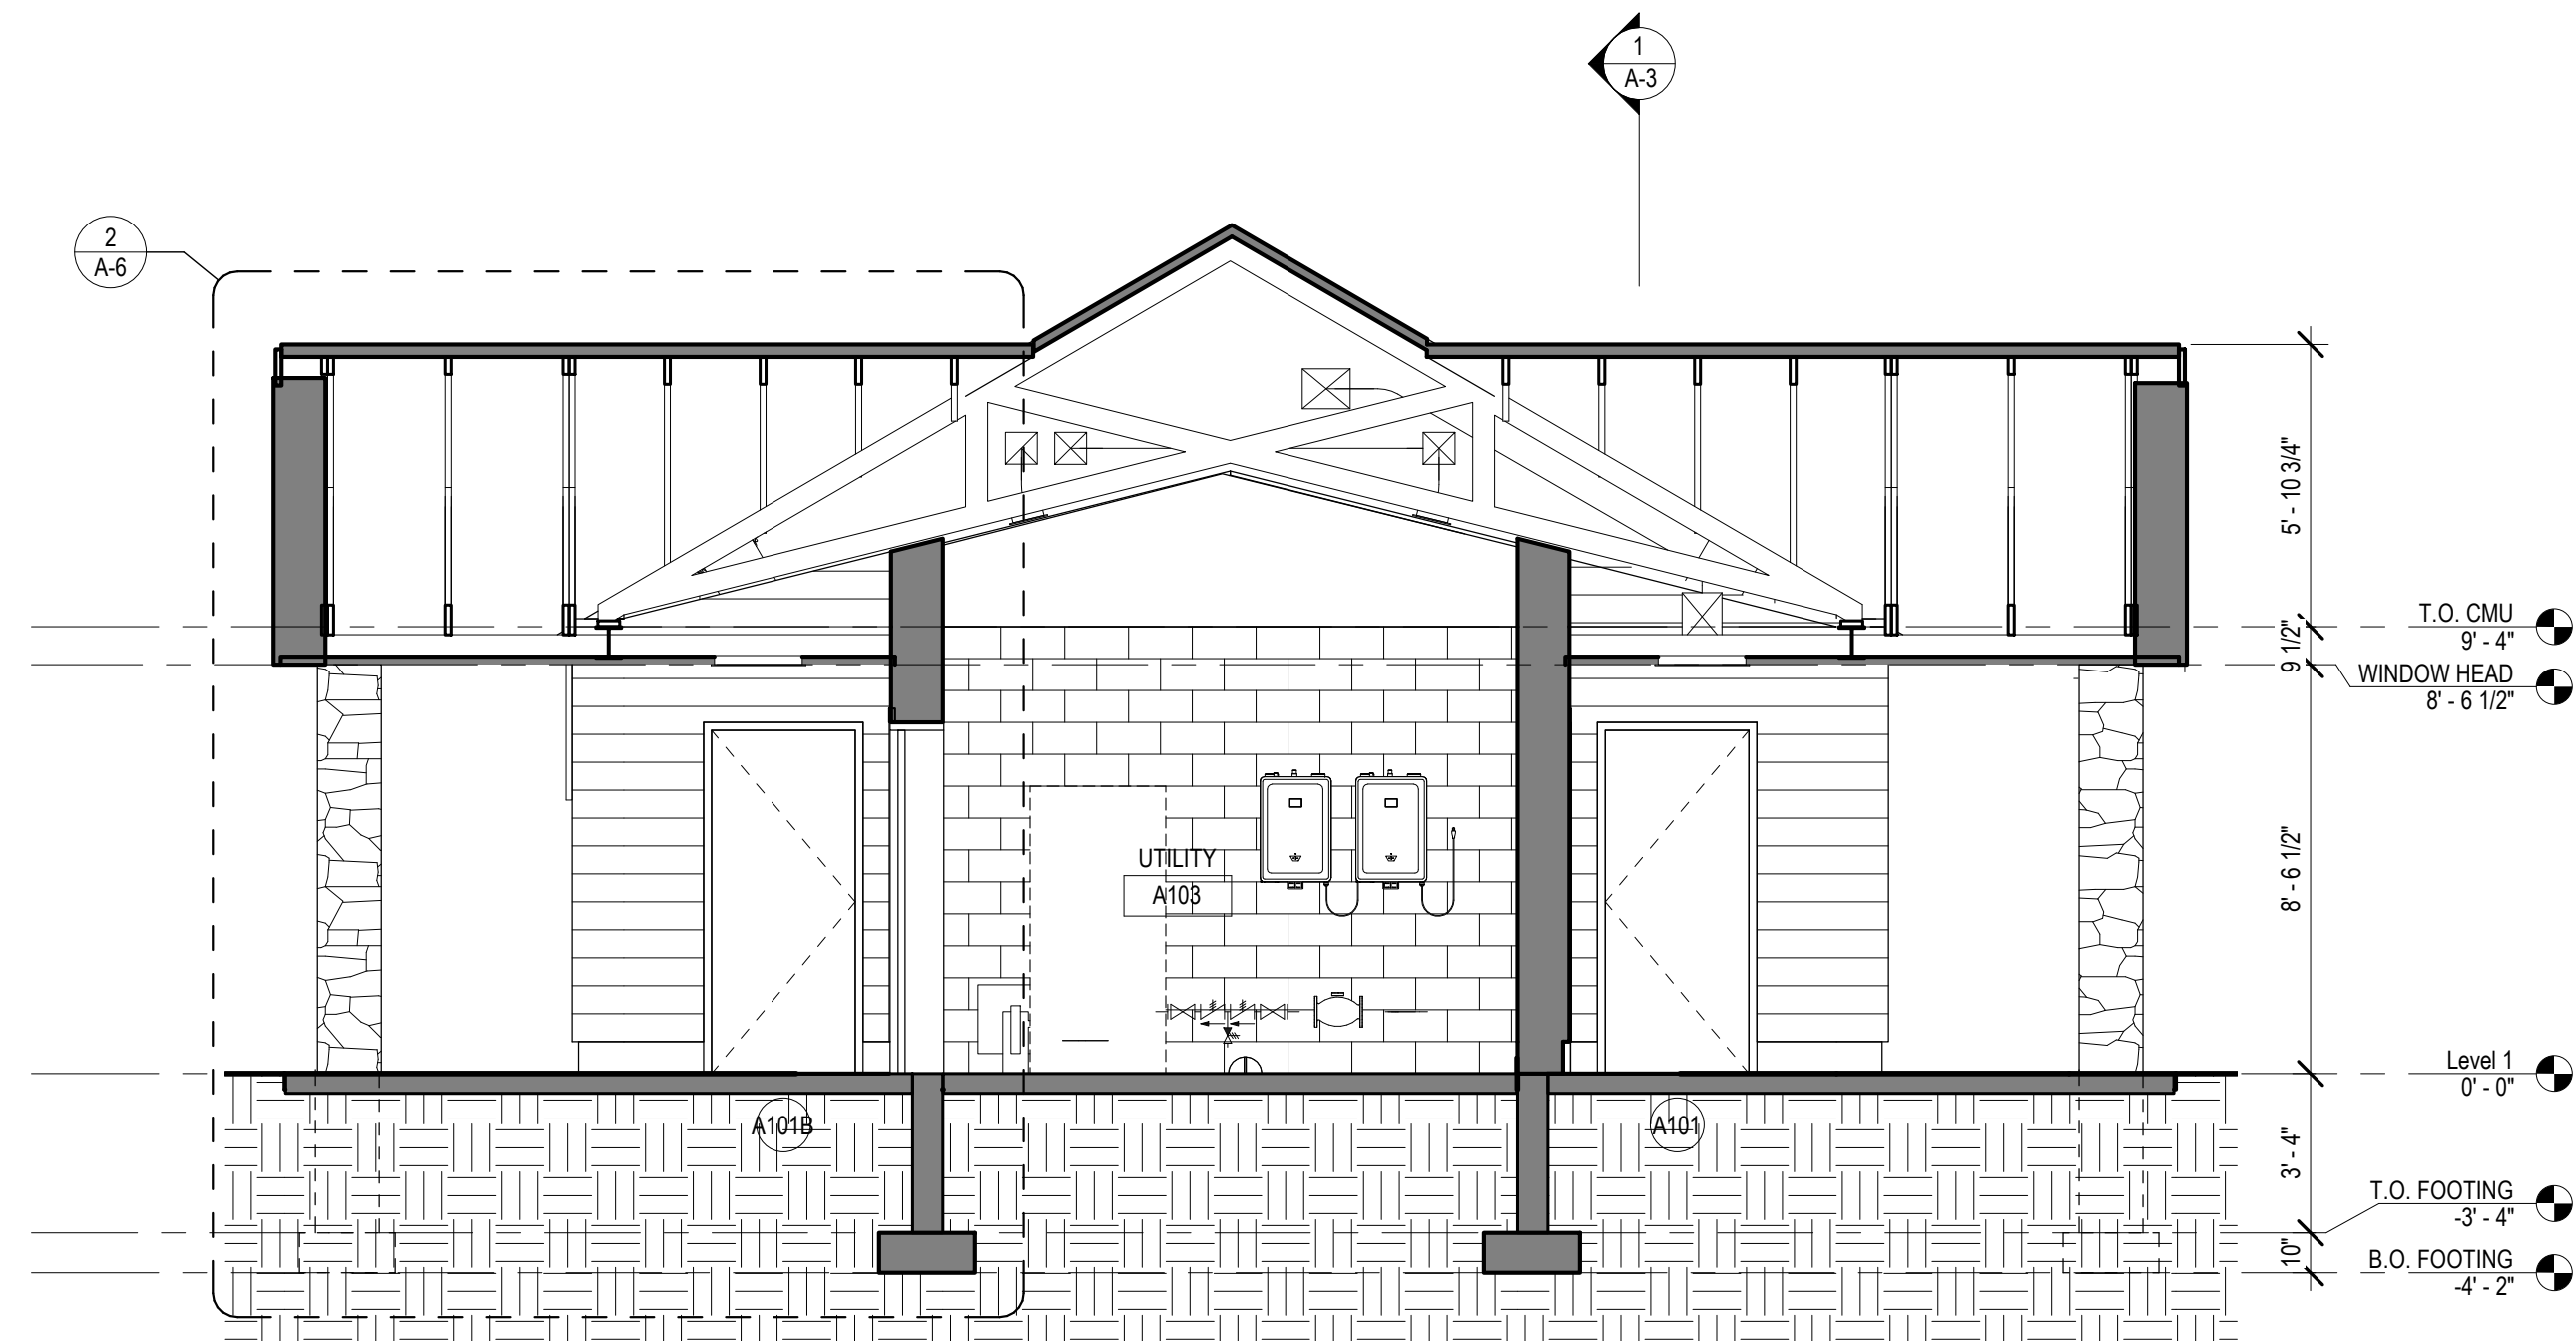

3 CROSS SECTION 2
A-3 1/4" = 1'-0"

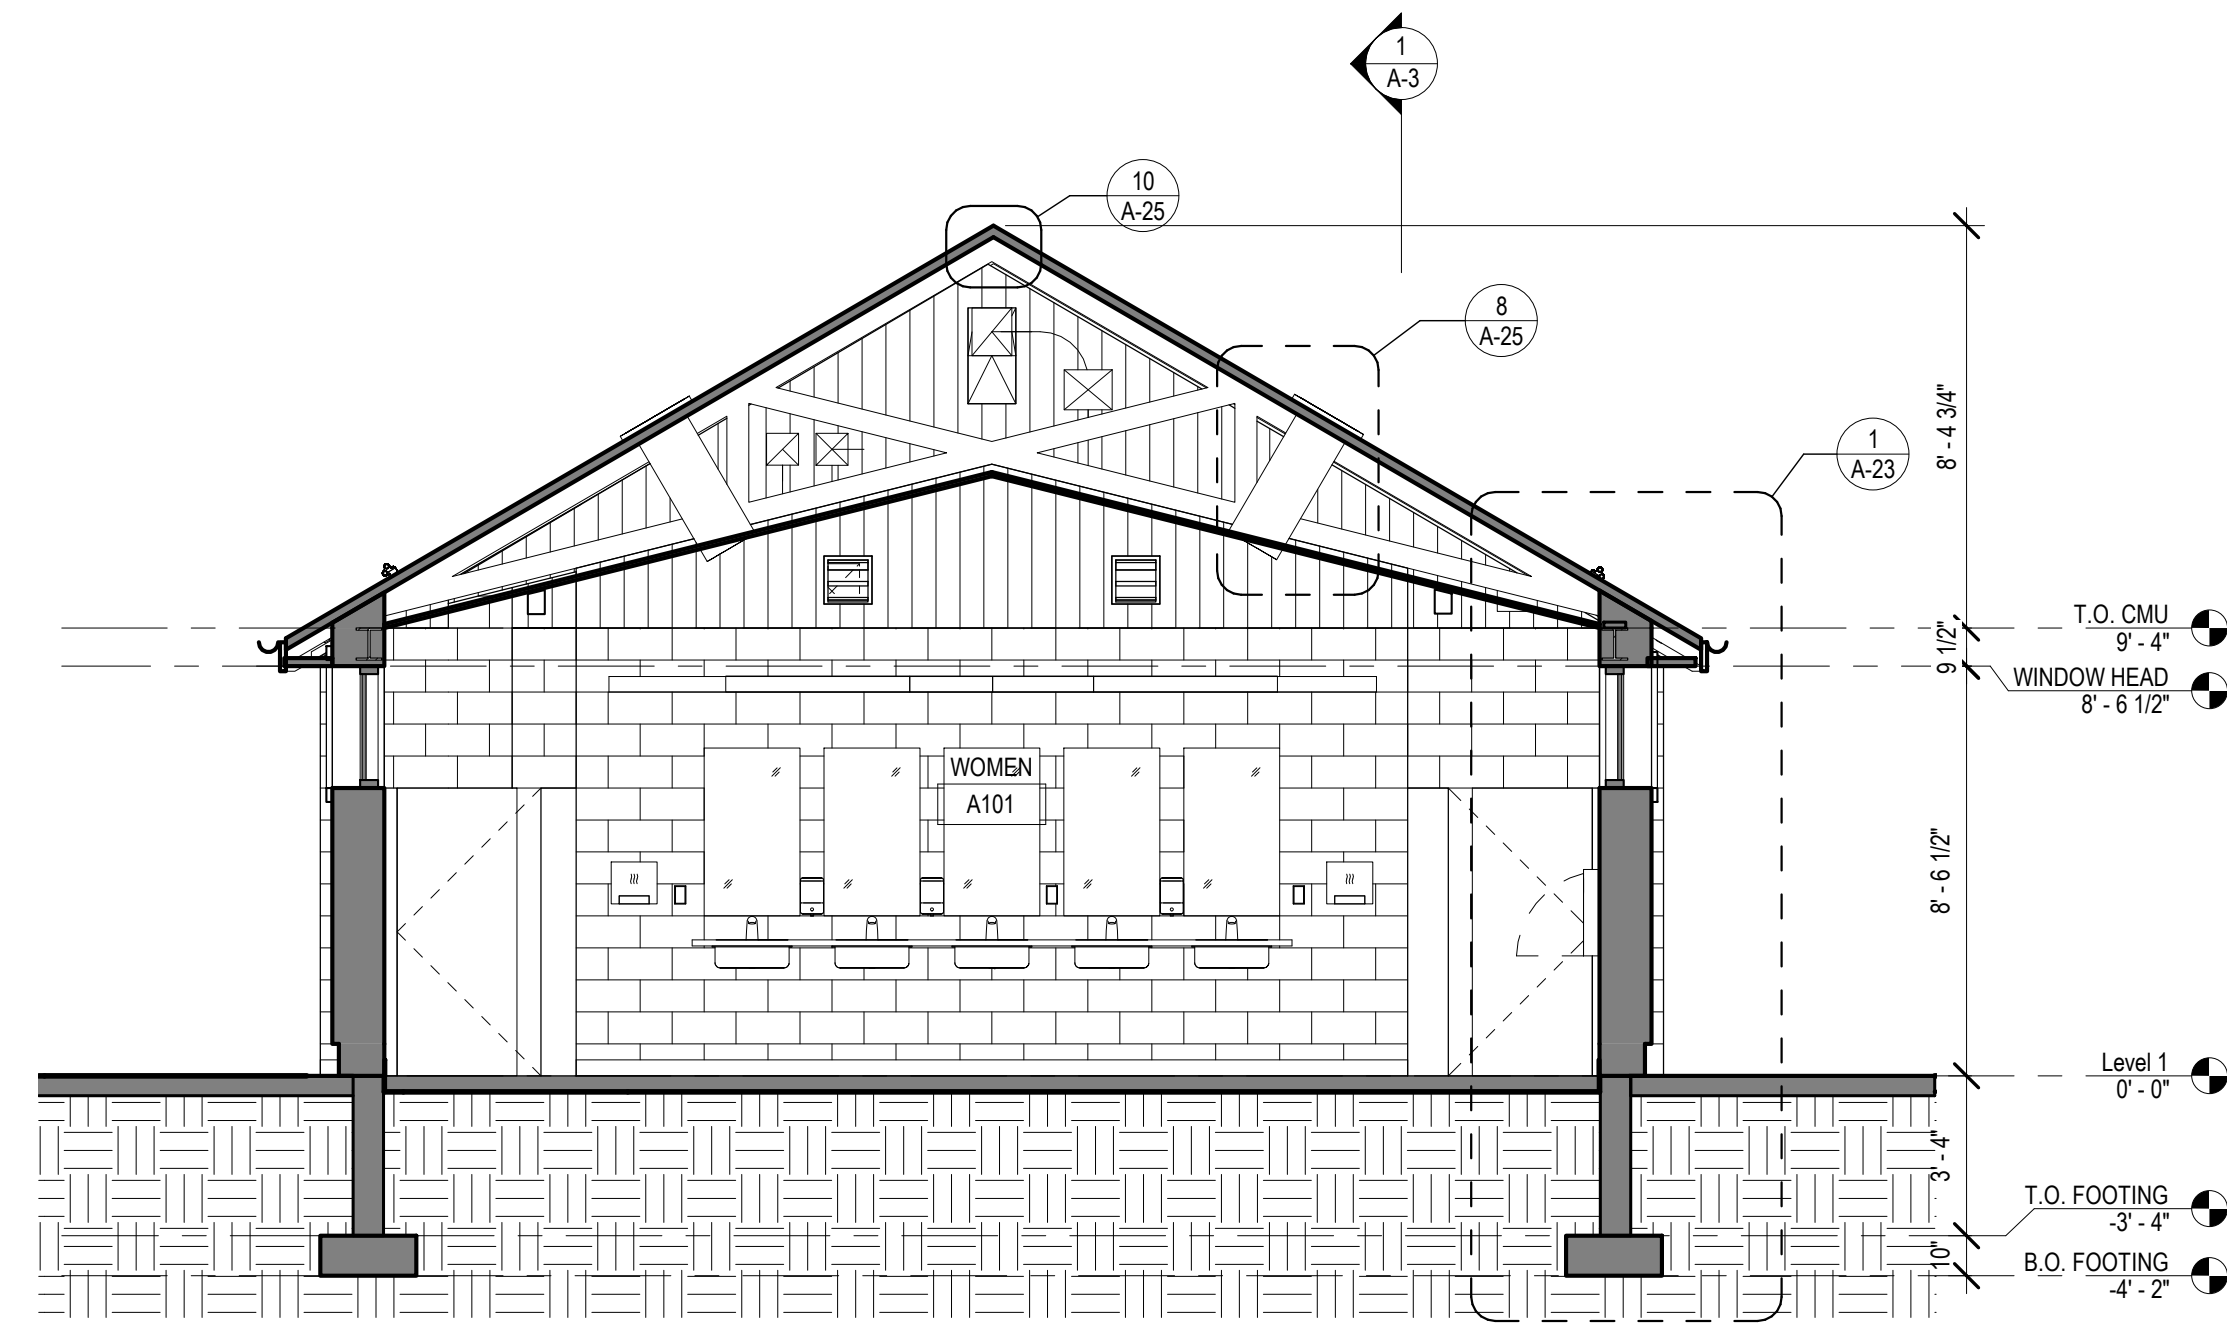


2 CROSS SECTION 1
A-3 1/4" = 1'-0"

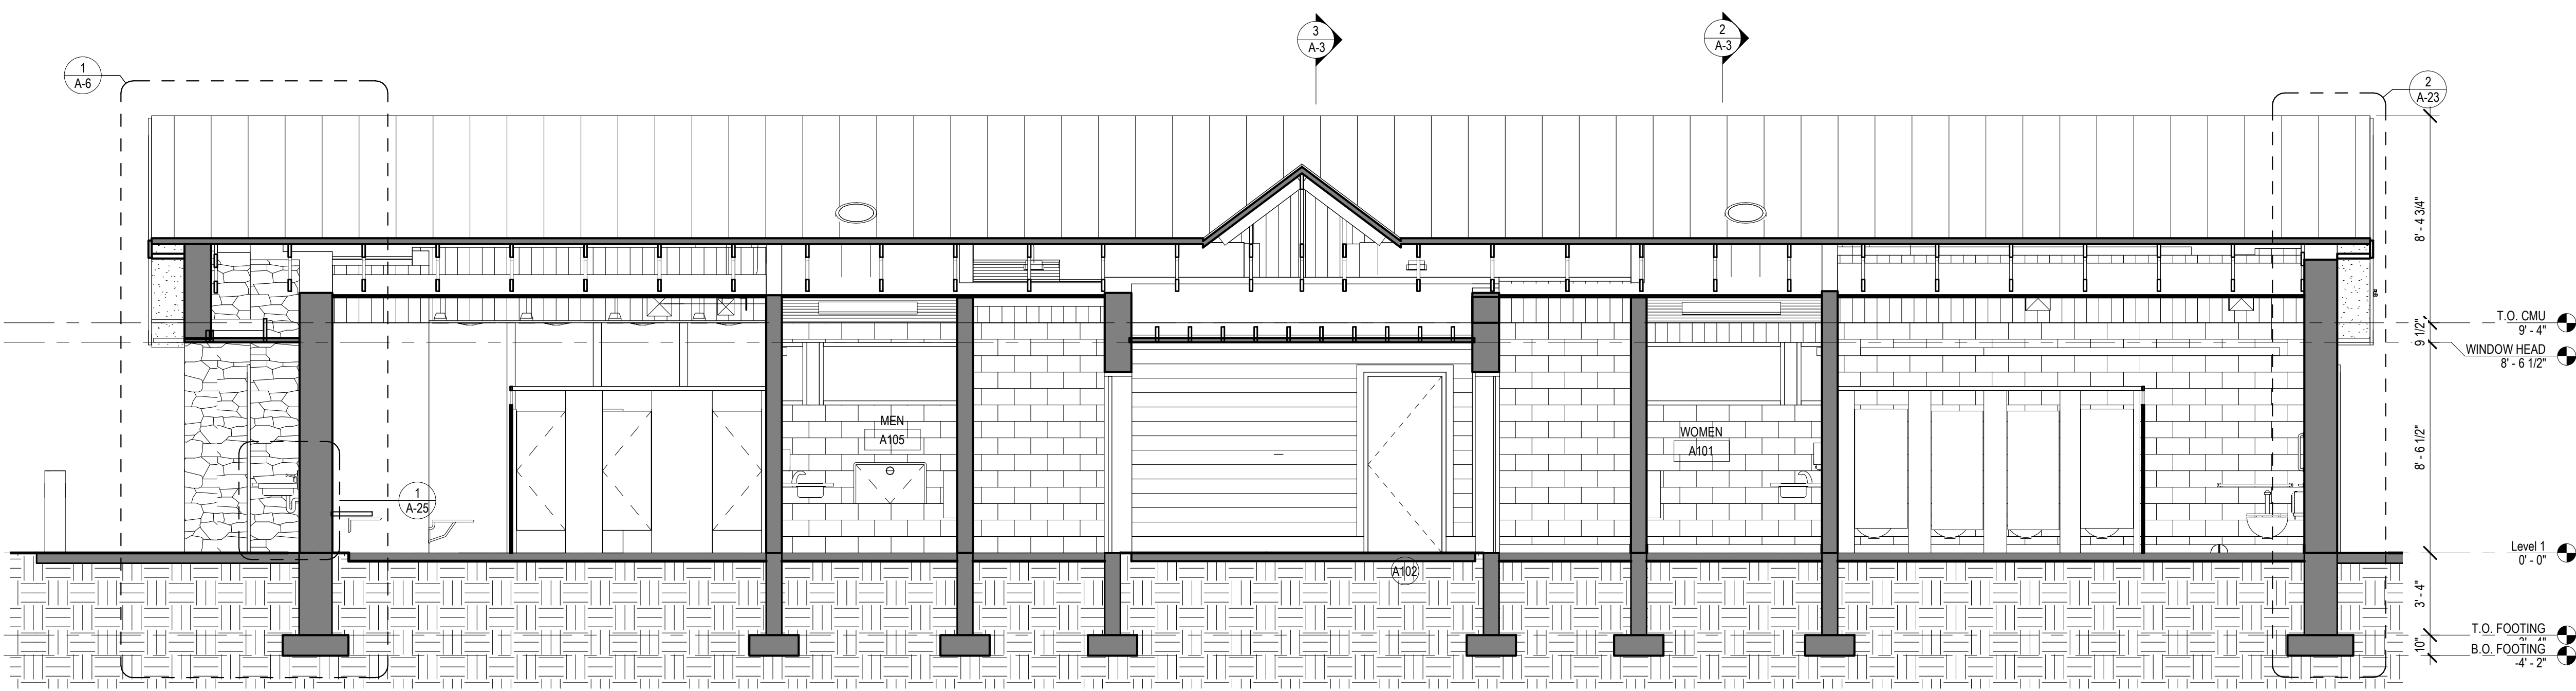

1 LONGITUDINAL SECTION
A-3 1/4" = 1'-0"

CONSTRUCTION DOCUMENTS

RECORD REVISIONS

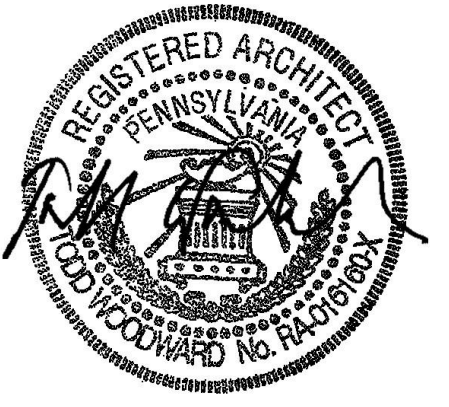

SIGNATURE DATE 03/05/2021

SMP ARCHITECTS
1600 WALNUT STREET, SECOND FLOOR
PHILADELPHIA, PENNSYLVANIA

COMMONWEALTH OF PENNSYLVANIA
DEPARTMENT OF GENERAL SERVICES
HARRISBURG, PENNSYLVANIA

D.G.S. PROJECT No. C-114-0006 PHASE 1

HICKORY RUN STATE PARK
LATRINE IMPROVEMENTS
DEPT OF CONSERVATION AND NATURAL RESOURCES
WHITE HAVEN, CARBON COUNTY, PA

LOOP C - BUILDING SECTIONS

VERIFY SCALE


BAR IS ONE (1) INCH LONG
ON ORIGINAL DRAWING: 0 1

IF BAR IS NOT ONE (1) INCH LONG, ADJUST SCALE ACCORDINGLY


CONTRACTOR SHALL FIELD VERIFY ALL DIMENSIONS. VARIANCE FROM CONTRACT DOCUMENTS NOT PERMITTED WITHOUT PROFESSIONAL & BUREAU OF CONSTRUCTION APPROVAL.

DRAWN BY M STRENSKI
CHECKED BY T WOODWARD
DATE 06/17/2022
SCALE AS NOTED


DRAWING No. A-3
57 OF 144

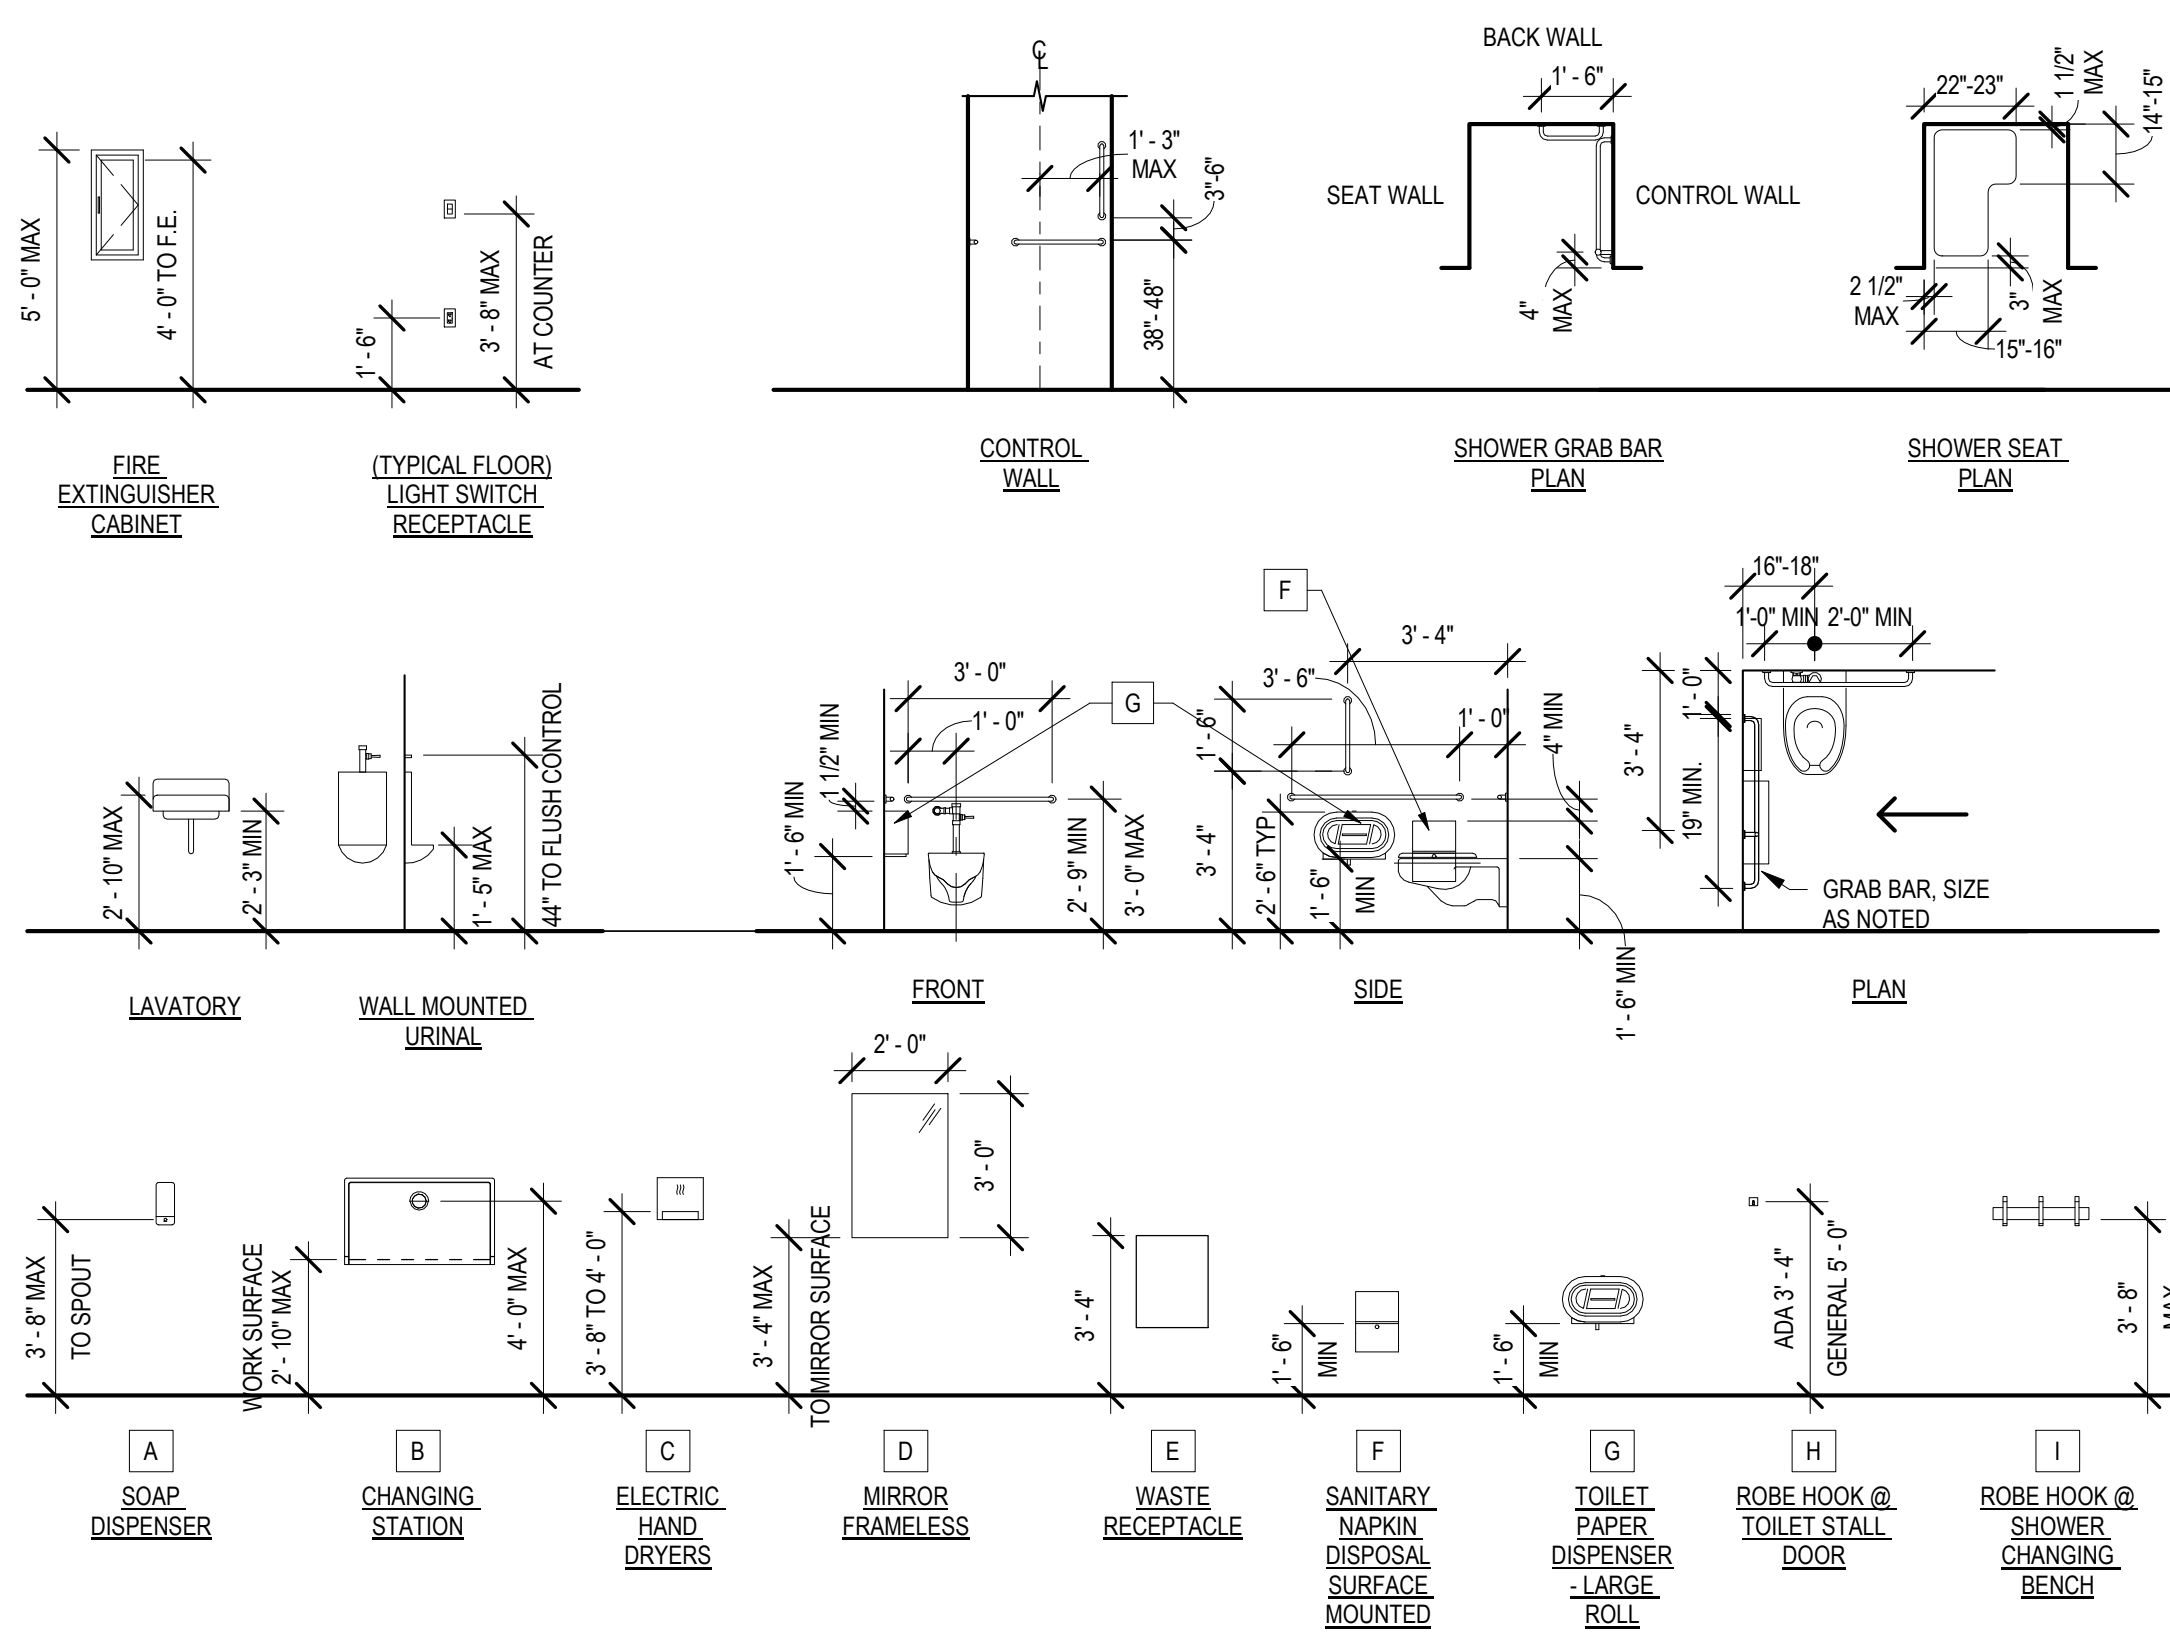


TYPICAL MOUNTING HEIGHTS
1/4" = 1'-0"

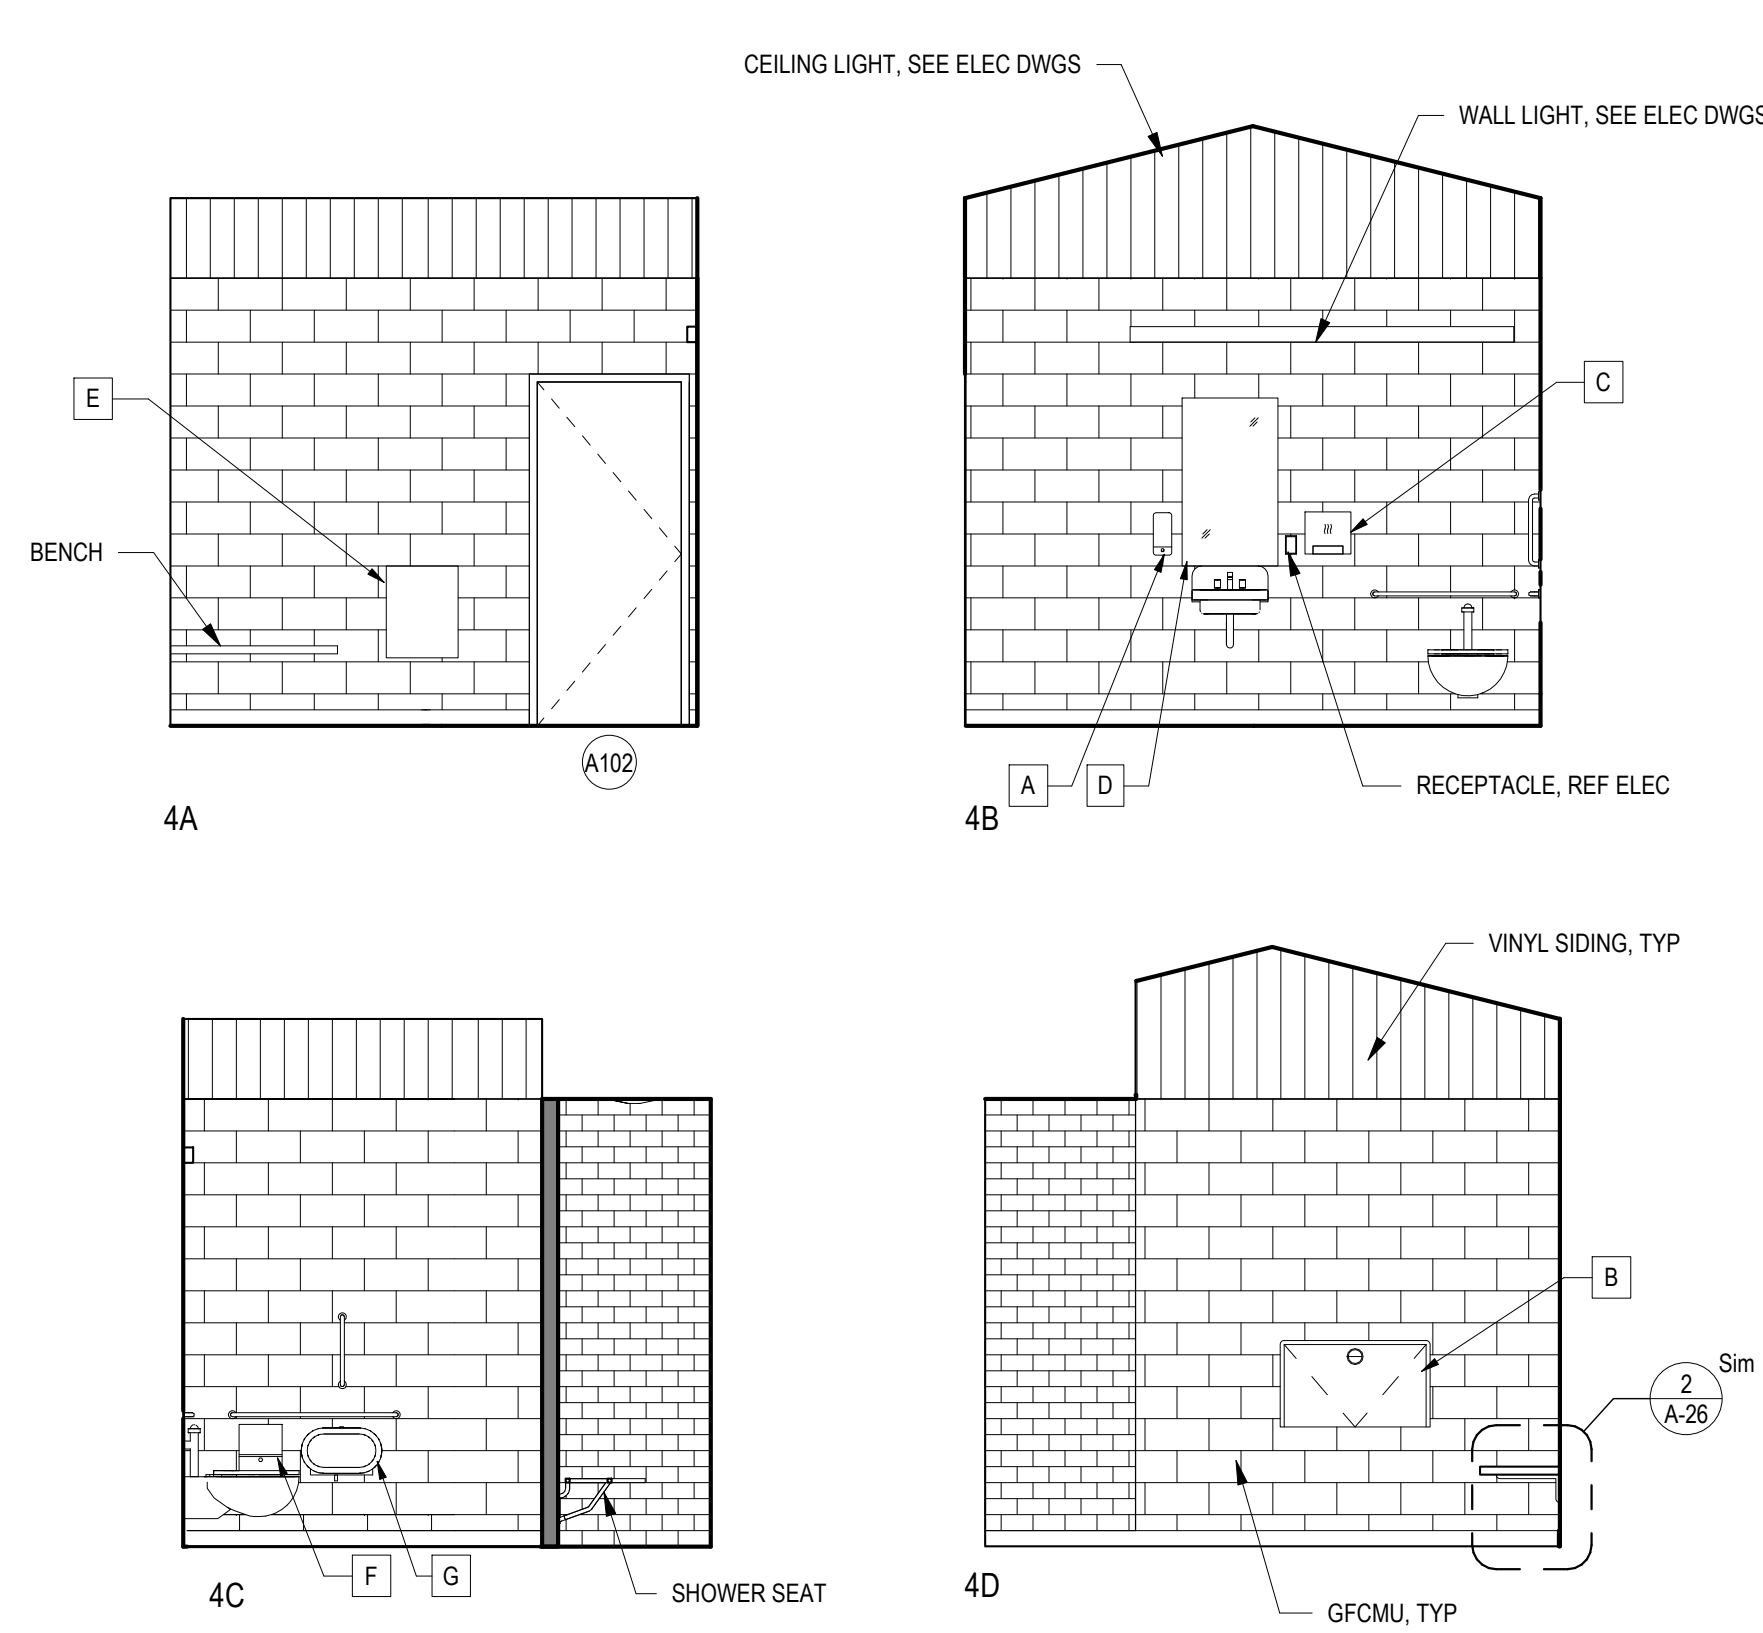


4C INTERIOR ELEVATIONS - RESTROOMS A102/A104
A-4 1/4" = 1'-0"

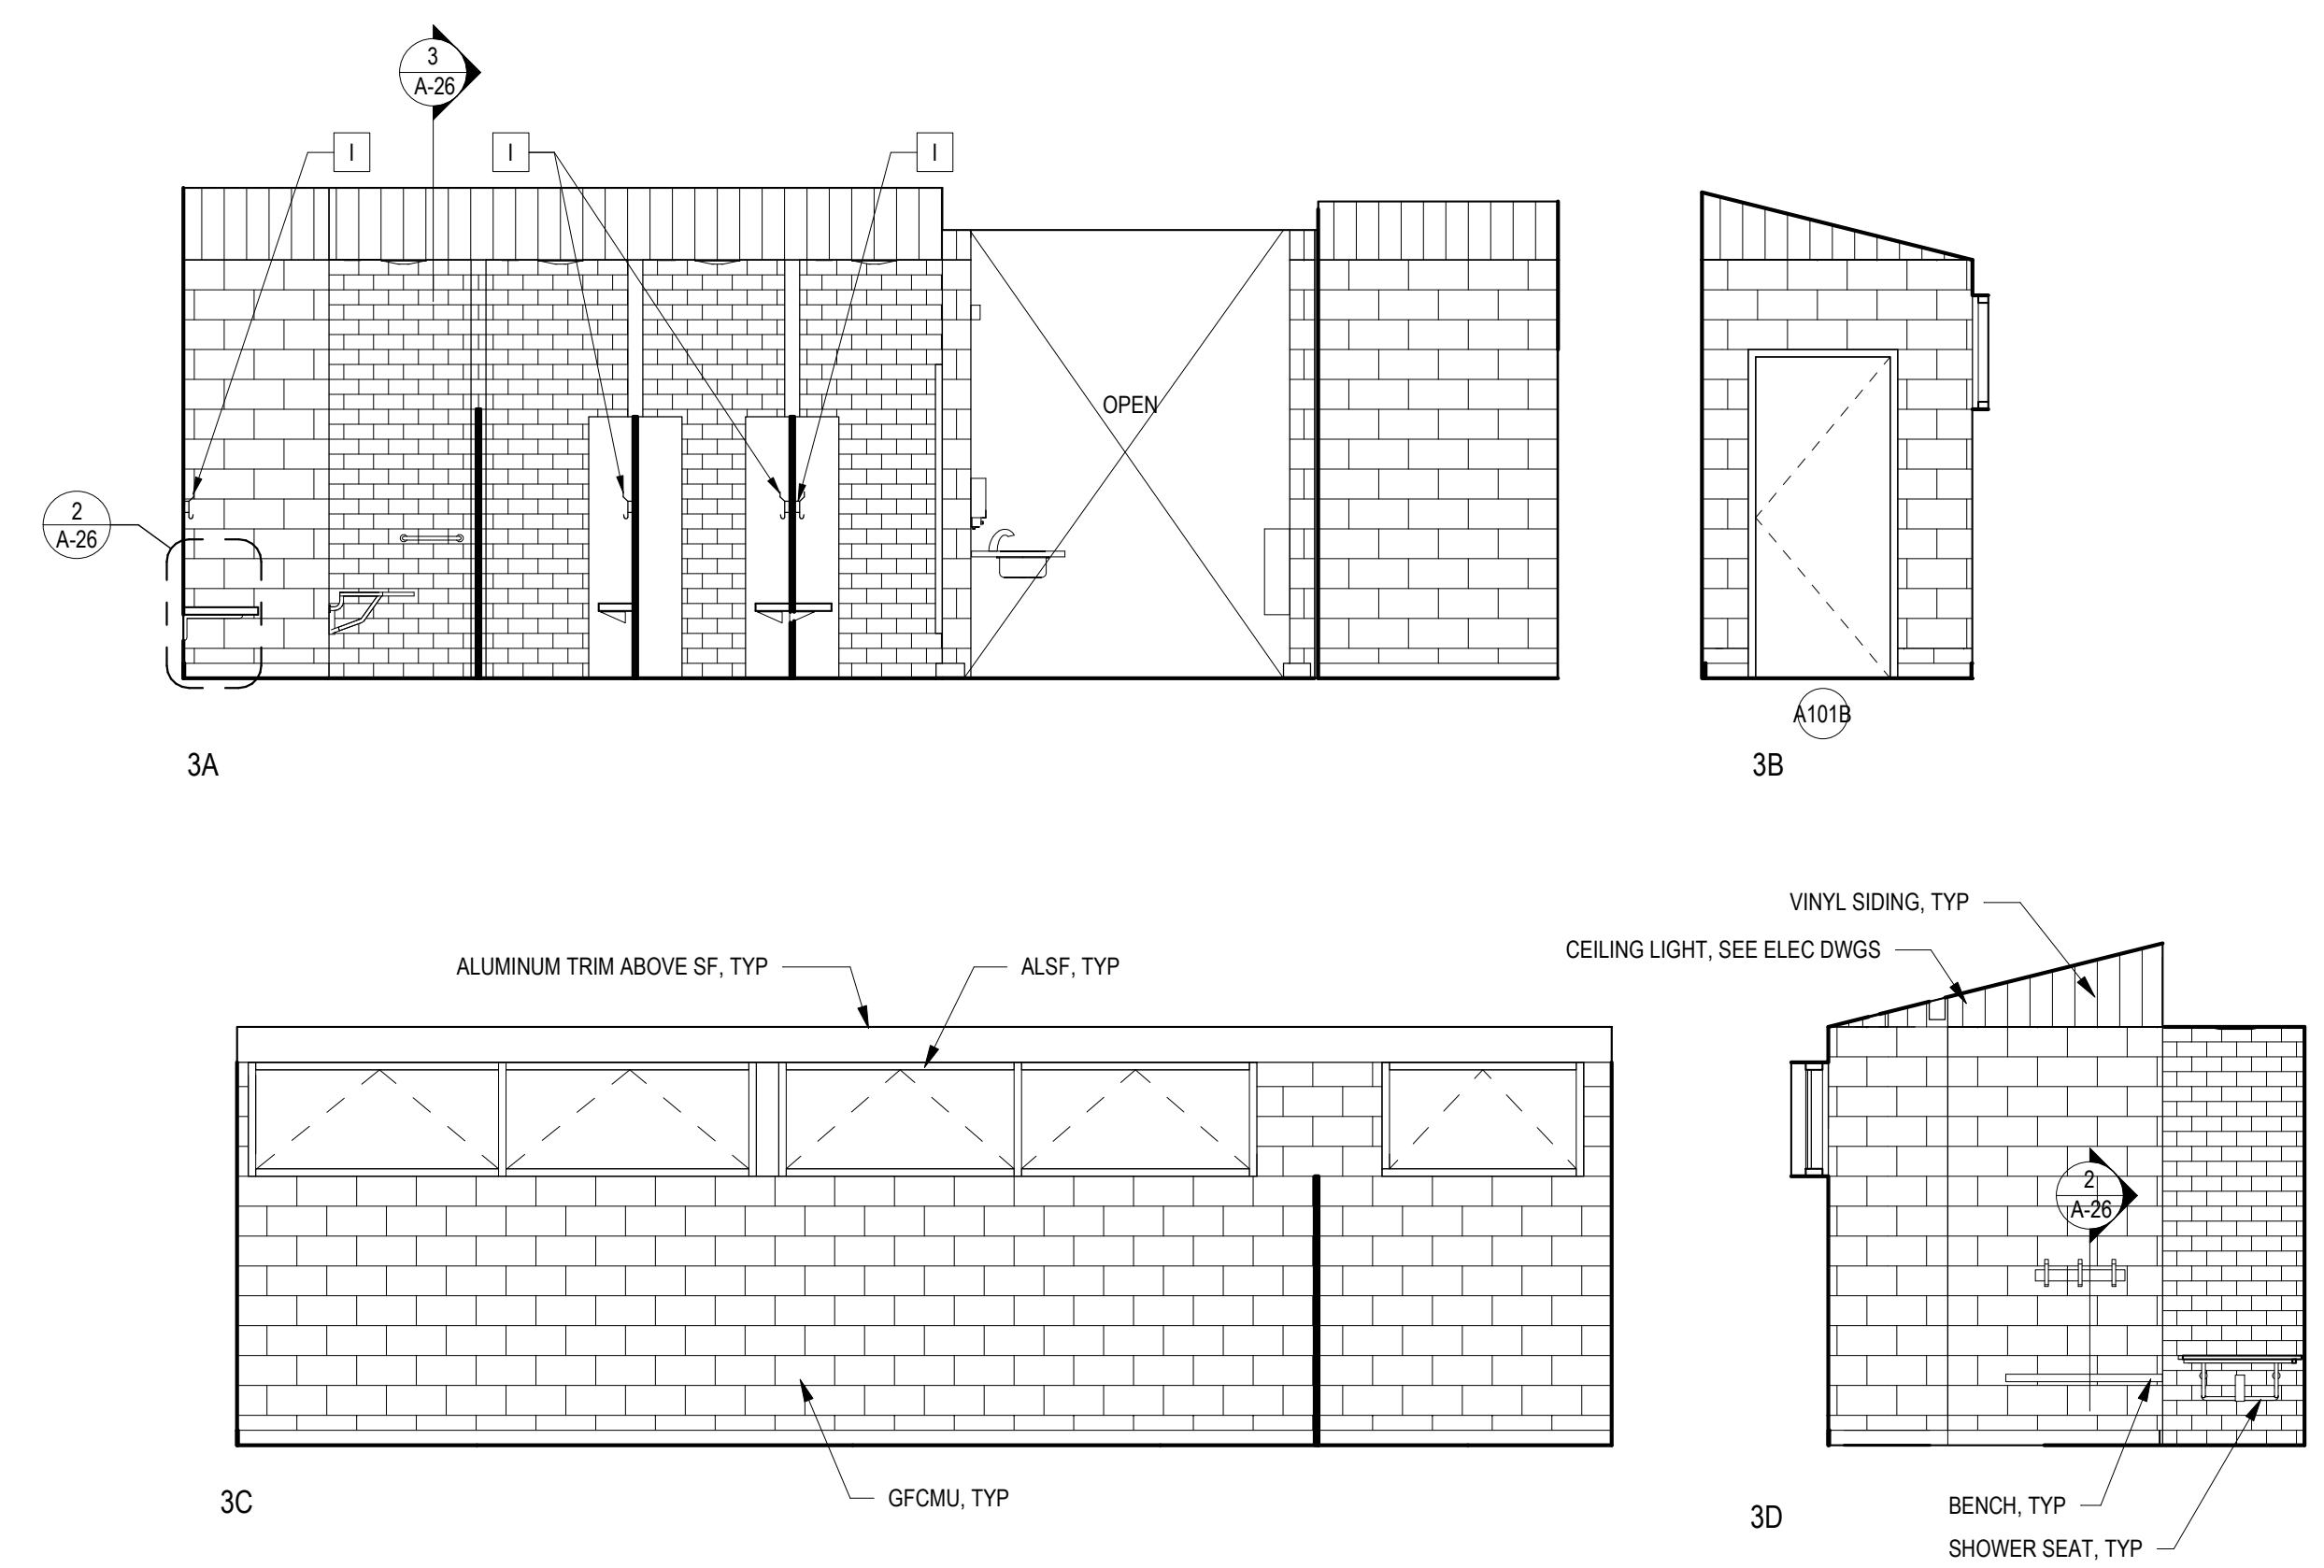


3C INTERIOR ELEVATIONS - WOMEN A101/MEN A106 SHOWER AREA
A-4 1/4" = 1'-0"

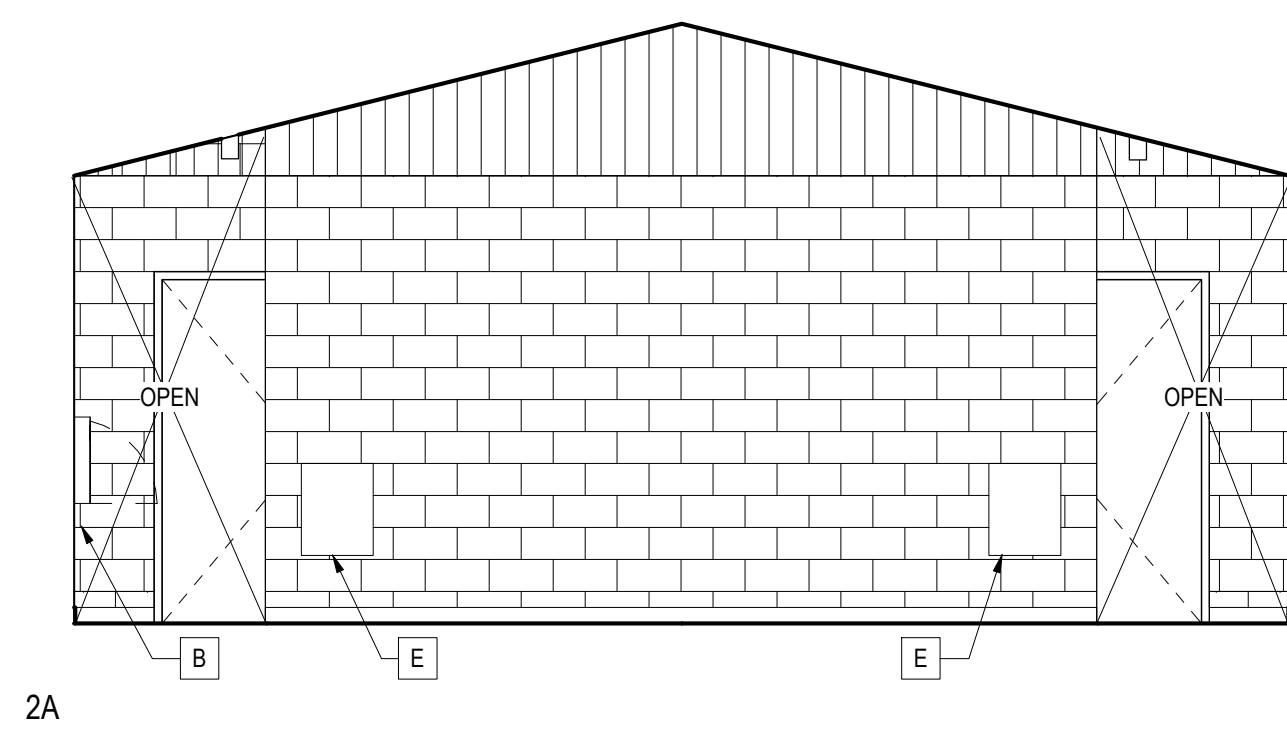


2A

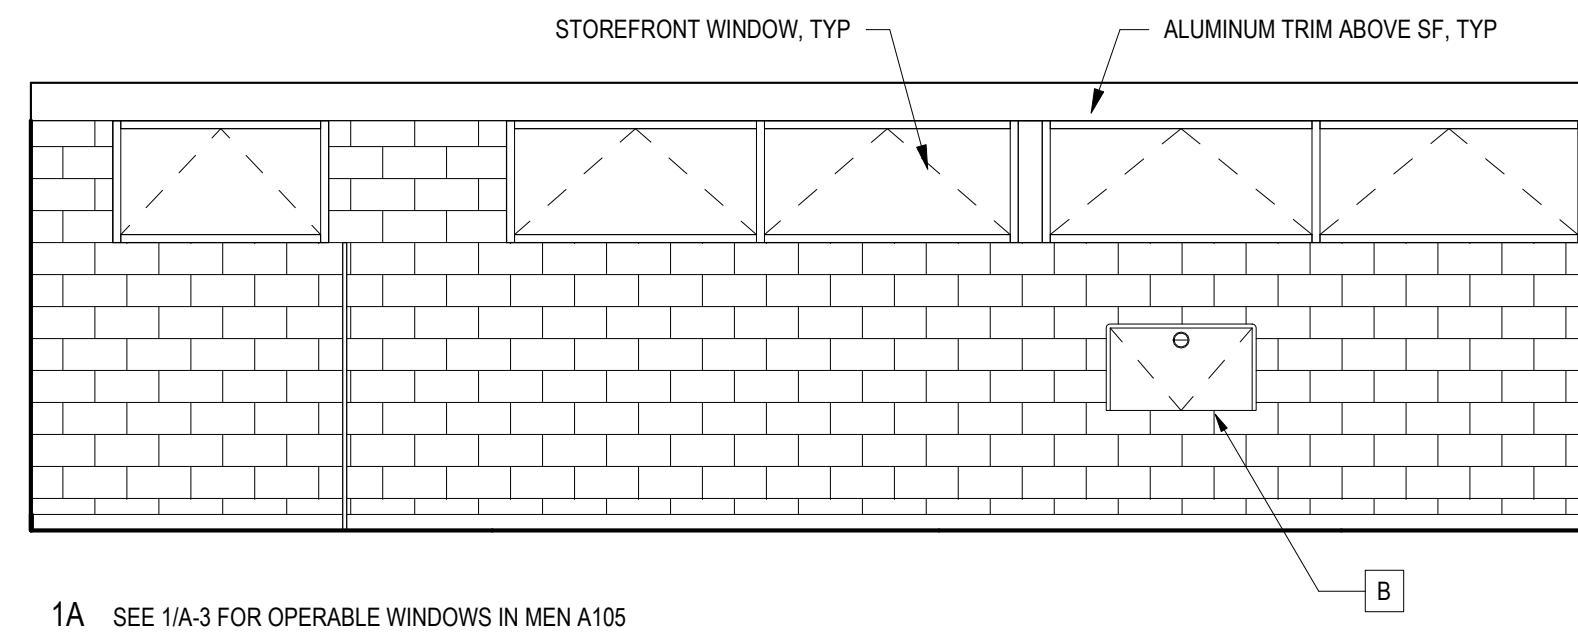

1A SEE 1/A-3 FOR OPERABLE WINDOWS IN MEN A105

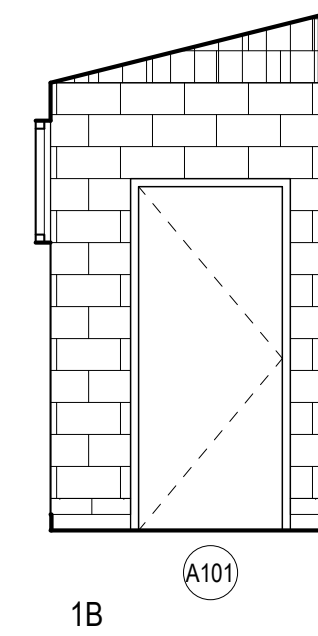


1B

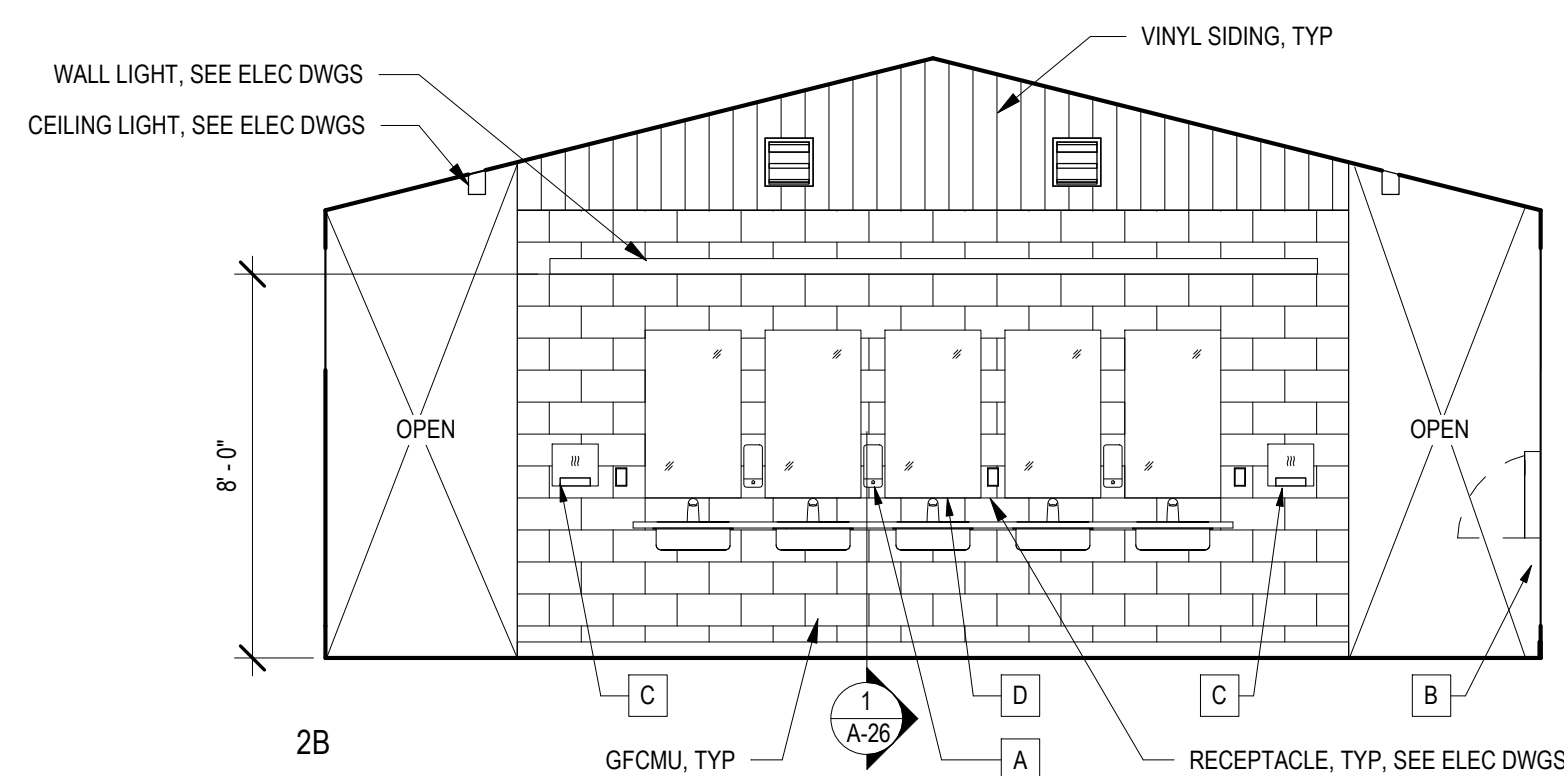


2B


2B INTERIOR ELEVATIONS - WOMEN A101/MEN A105 SINK AREA
A-4 1/4" = 1'-0"

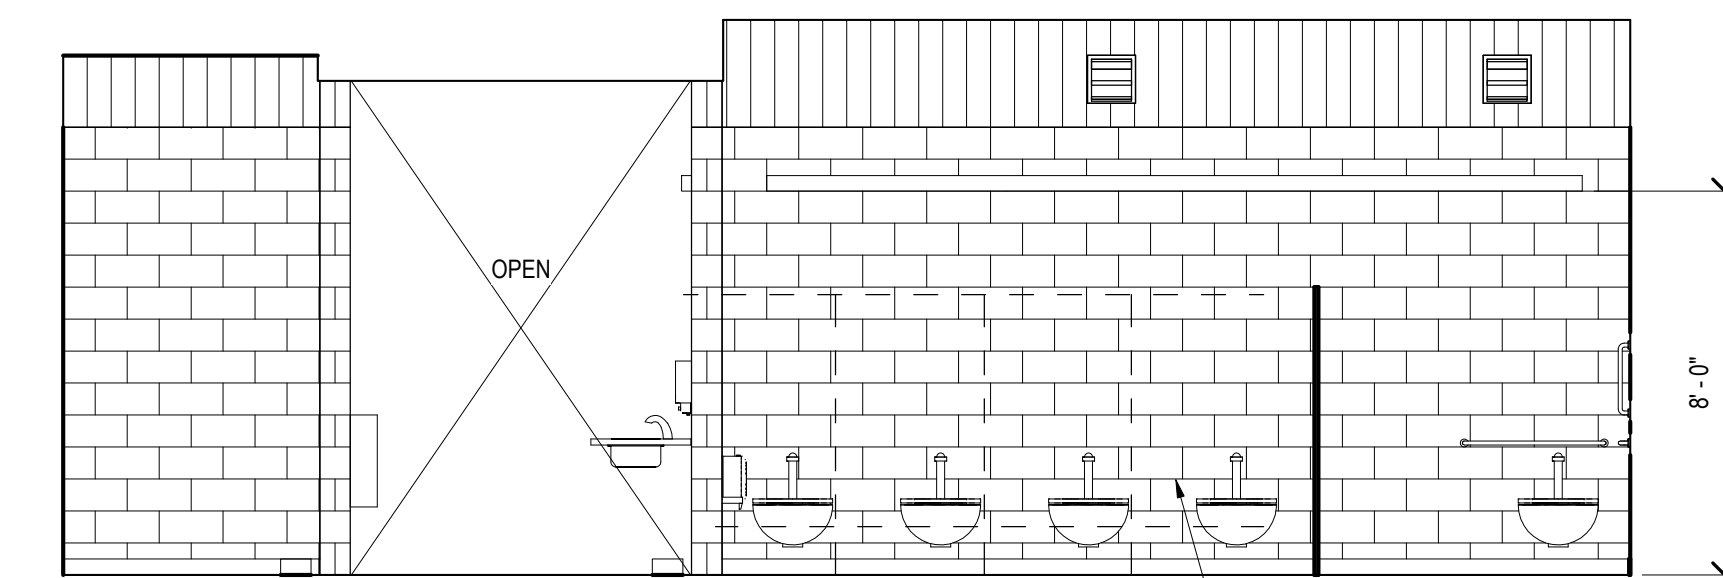

1C WOMEN A101

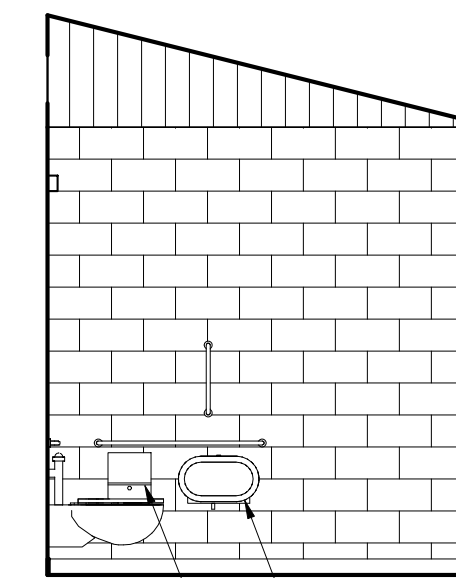

1D

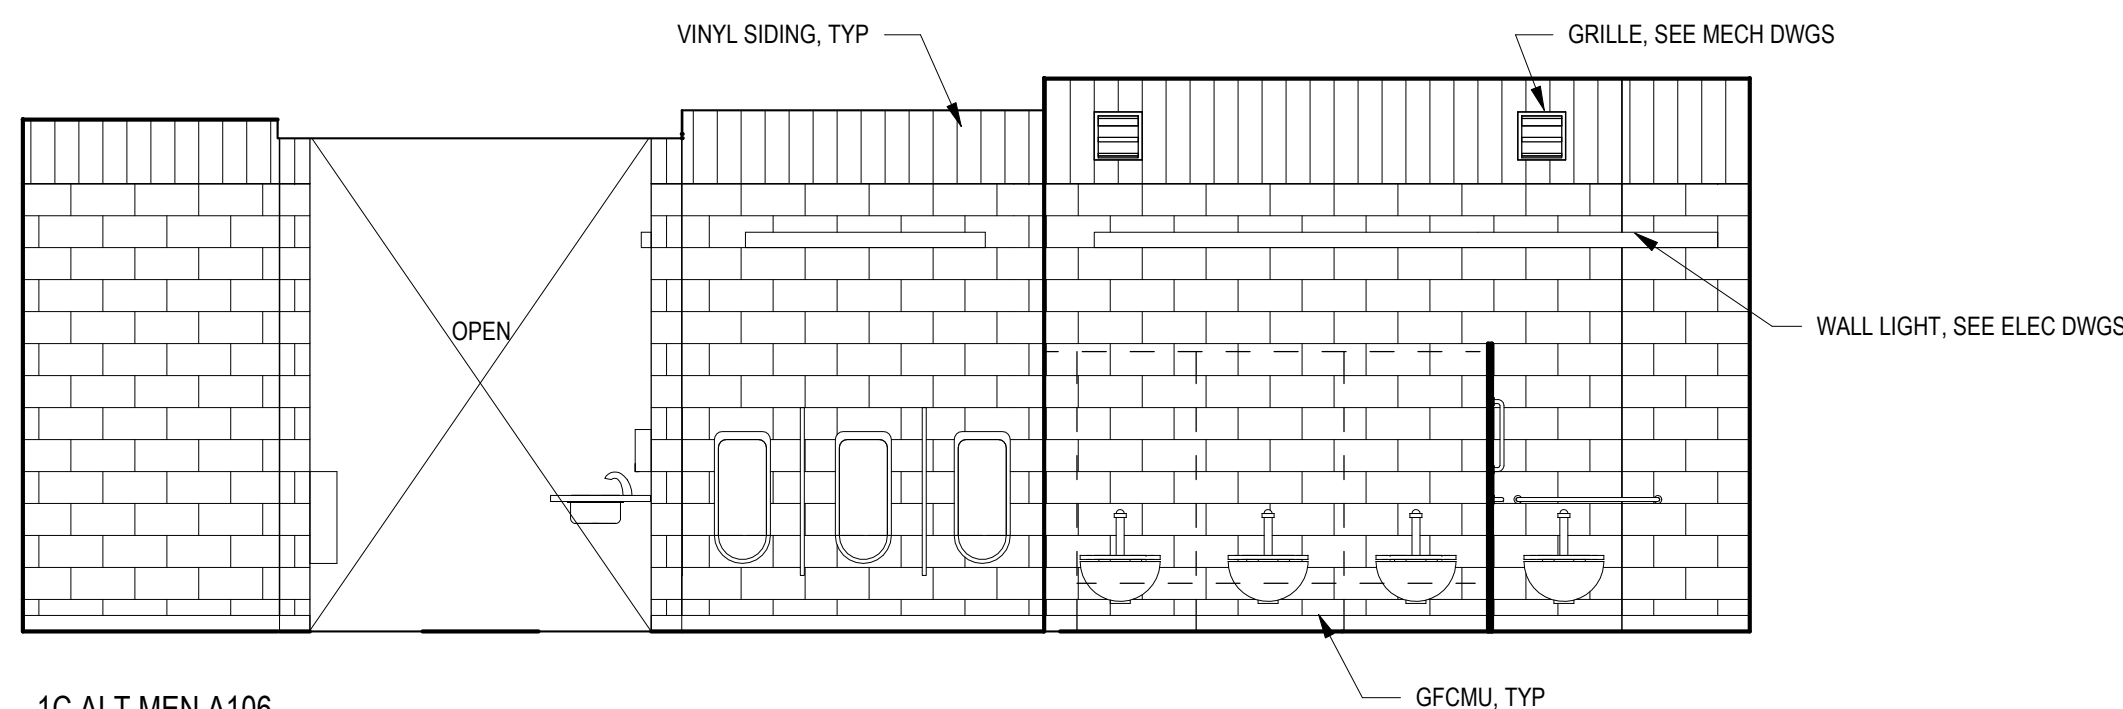


1C ALT MEN A106

1 INTERIOR ELEVATIONS - WOMEN A101/MEN A106 TOILET AREA
A-4 1/4" = 1'-0"

CONSTRUCTION DOCUMENTS

RECORD REVISIONS

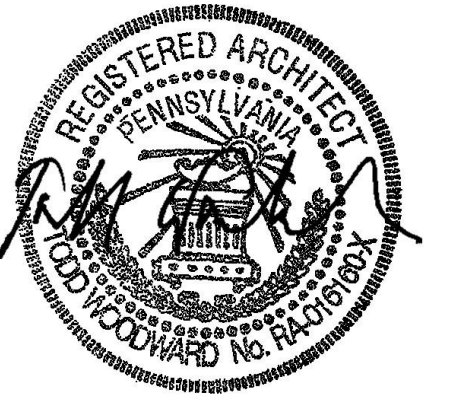

SIGNATURE DATE 03/05/2021

SMP ARCHITECTS
1600 WALNUT STREET, SECOND FLOOR
PHILADELPHIA, PENNSYLVANIA

COMMONWEALTH OF PENNSYLVANIA
DEPARTMENT OF GENERAL SERVICES
HARRISBURG, PENNSYLVANIA

D.G.S. PROJECT No. C-114-0006 PHASE 1

HICKORY RUN STATE PARK
LATRINE IMPROVEMENTS

DEPT of CONSERVATION AND NATURAL RESOURCES
WHITE HAVEN, CARBON COUNTY, PA

LOOP C - INTERIOR ELEVATIONS

VERIFY SCALE














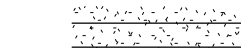

BAR IS ONE (1) INCH LONG
ON ORIGINAL DRAWING: 0 1
IF BAR IS NOT ONE (1) INCH LONG, ADJUST SCALE ACCORDINGLY

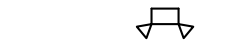
CONTRACTOR SHALL FIELD VERIFY ALL DIMENSIONS. VARIANCE FROM CONTRACT DOCUMENTS NOT PERMITTED WITHOUT PROFESSIONAL & BUREAU OF CONSTRUCTION APPROVAL.

DRAWN BY M STRENSKI	DATE 06/17/2022
CHECKED BY T WOODWARD	SCALE AS NOTED

DRAWING No.
A-4

RCP LEGEND

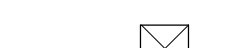
-  4' x 4' SURFACED MOUNTED LED LIGHT
-  LED SHOWER LIGHT
-  EMERGENCY LIGHT
-  WALL MOUNTED LED UP/DOWN LIGHT
-  BUILDING MOUNTED EXTERIOR LED LIGHT
-  LED STRIP LIGHT
-  RECESSED EXTERIOR CAN LIGHT
-  OCCUPANCY SENSOR
-  OCCUPANCY SENSOR
-  POWER PACK
-  TUBULAR SKYLIGHT
-  SUPPLY DIFFUSER
-  RETURN DIFFUSER
-  VINYL PANELING
-  FIBER CEMENT SOFFIT PANELS

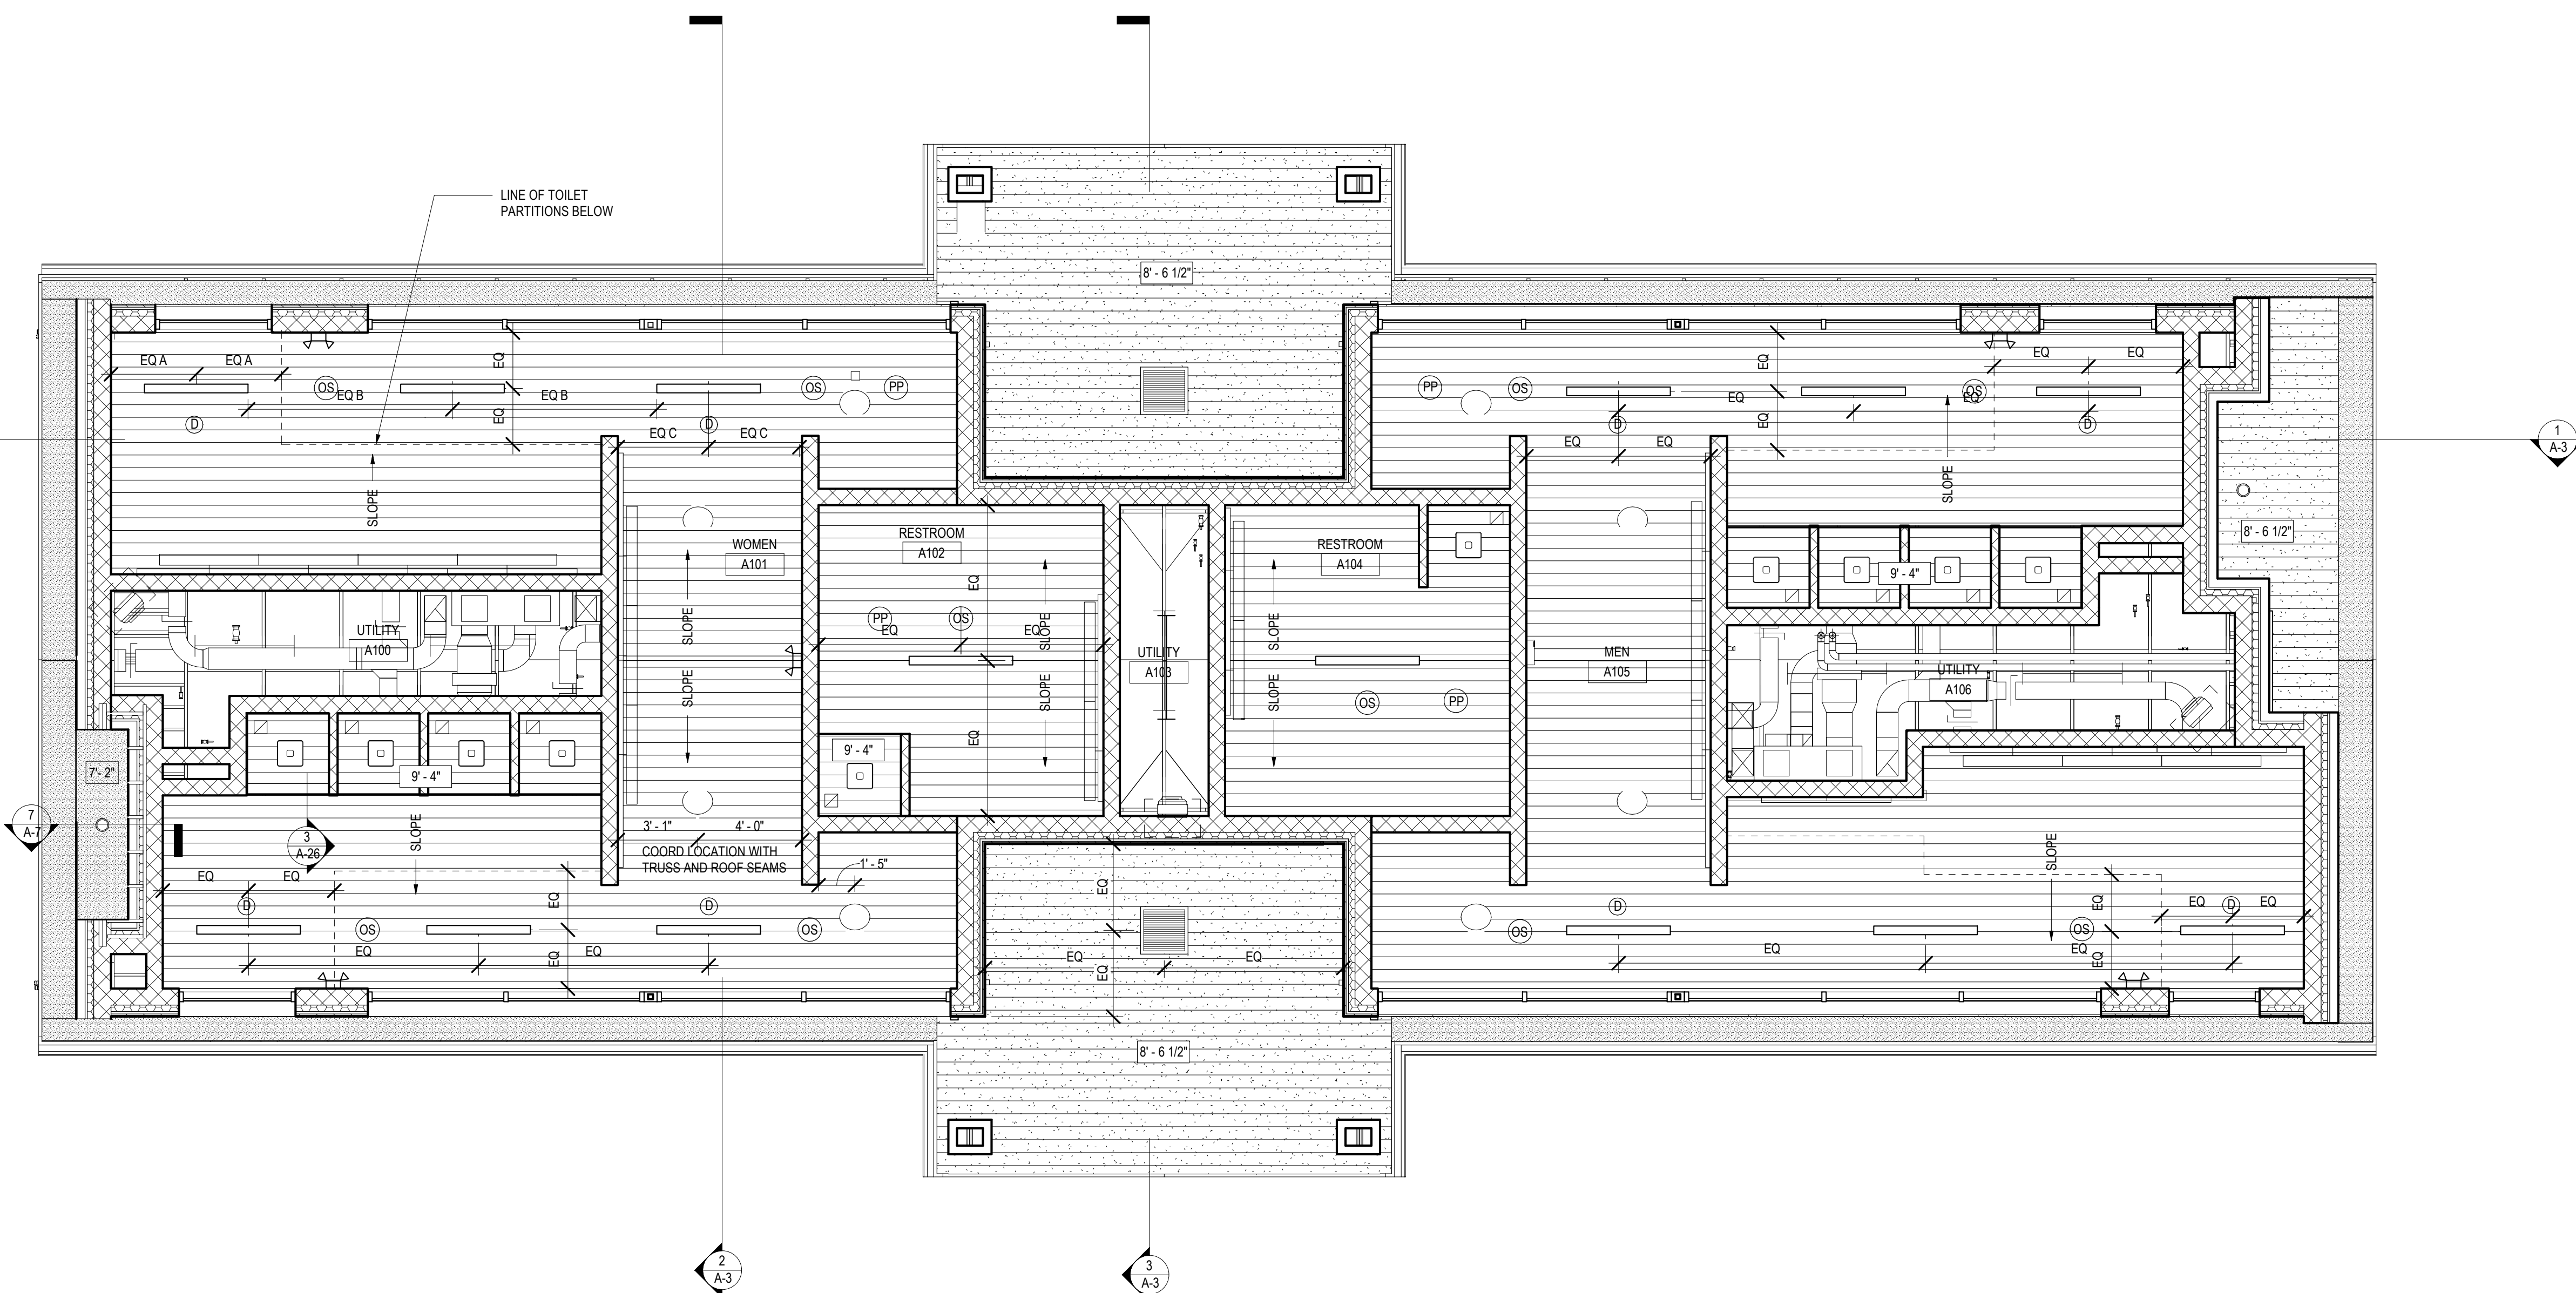

1
A-5
LOOP C - REFLECTED CEILING PLAN
1/4" = 1'-0"

CONSTRUCTION DOCUMENTS

RECORD REVISIONS

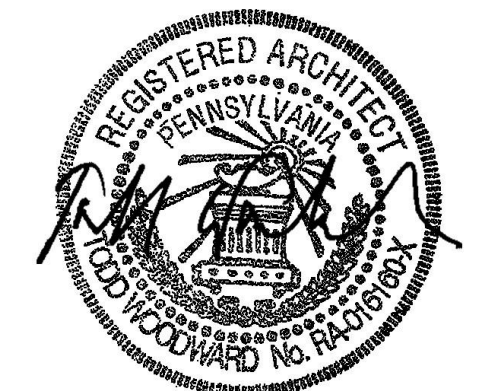

03/05/2021
DATE

SMP ARCHITECTS
1600 WALNUT STREET, SECOND FLOOR
PHILADELPHIA, PENNSYLVANIA

COMMONWEALTH OF PENNSYLVANIA
DEPARTMENT OF GENERAL SERVICES
HARRISBURG, PENNSYLVANIA

D.G.S. PROJECT No.
C-114-0006 PHASE 1

HICKORY RUN STATE PARK
LATRINE IMPROVEMENTS
DEPT of CONSERVATION AND NATURAL RESOURCES
WHITE HAVEN, CARBON COUNTY, PA


LOOP C - REFLECTED CEILING PLAN

VERIFY SCALE
BAR IS ONE (1) INCH LONG
ON ORIGINAL DRAWING: 0 1
IF BAR IS NOT ONE (1) INCH LONG, ADJUST SCALE ACCORDINGLY
CONTRACTOR SHALL FIELD VERIFY ALL DIMENSIONS. VARIANCE FROM CONTRACT DOCUMENTS NOT PERMITTED WITHOUT PROFESSIONAL & BUREAU OF CONSTRUCTION APPROVAL.


DRAWN BY M STRENSKI	DATE 06/17/2022
CHECKED BY T WOODWARD	SCALE AS NOTED

DRAWING No.
A-5
59 OF 144

FILE PATH: I:\723_Hickory_Run\A101_Arch\Drawings\01_Best\Hickory_Run_State_Park_Latrines_Improvements.dwg PLOTTED BY: Megan M. Strenski PLOTTED: 2022/06/04 12:14 PM

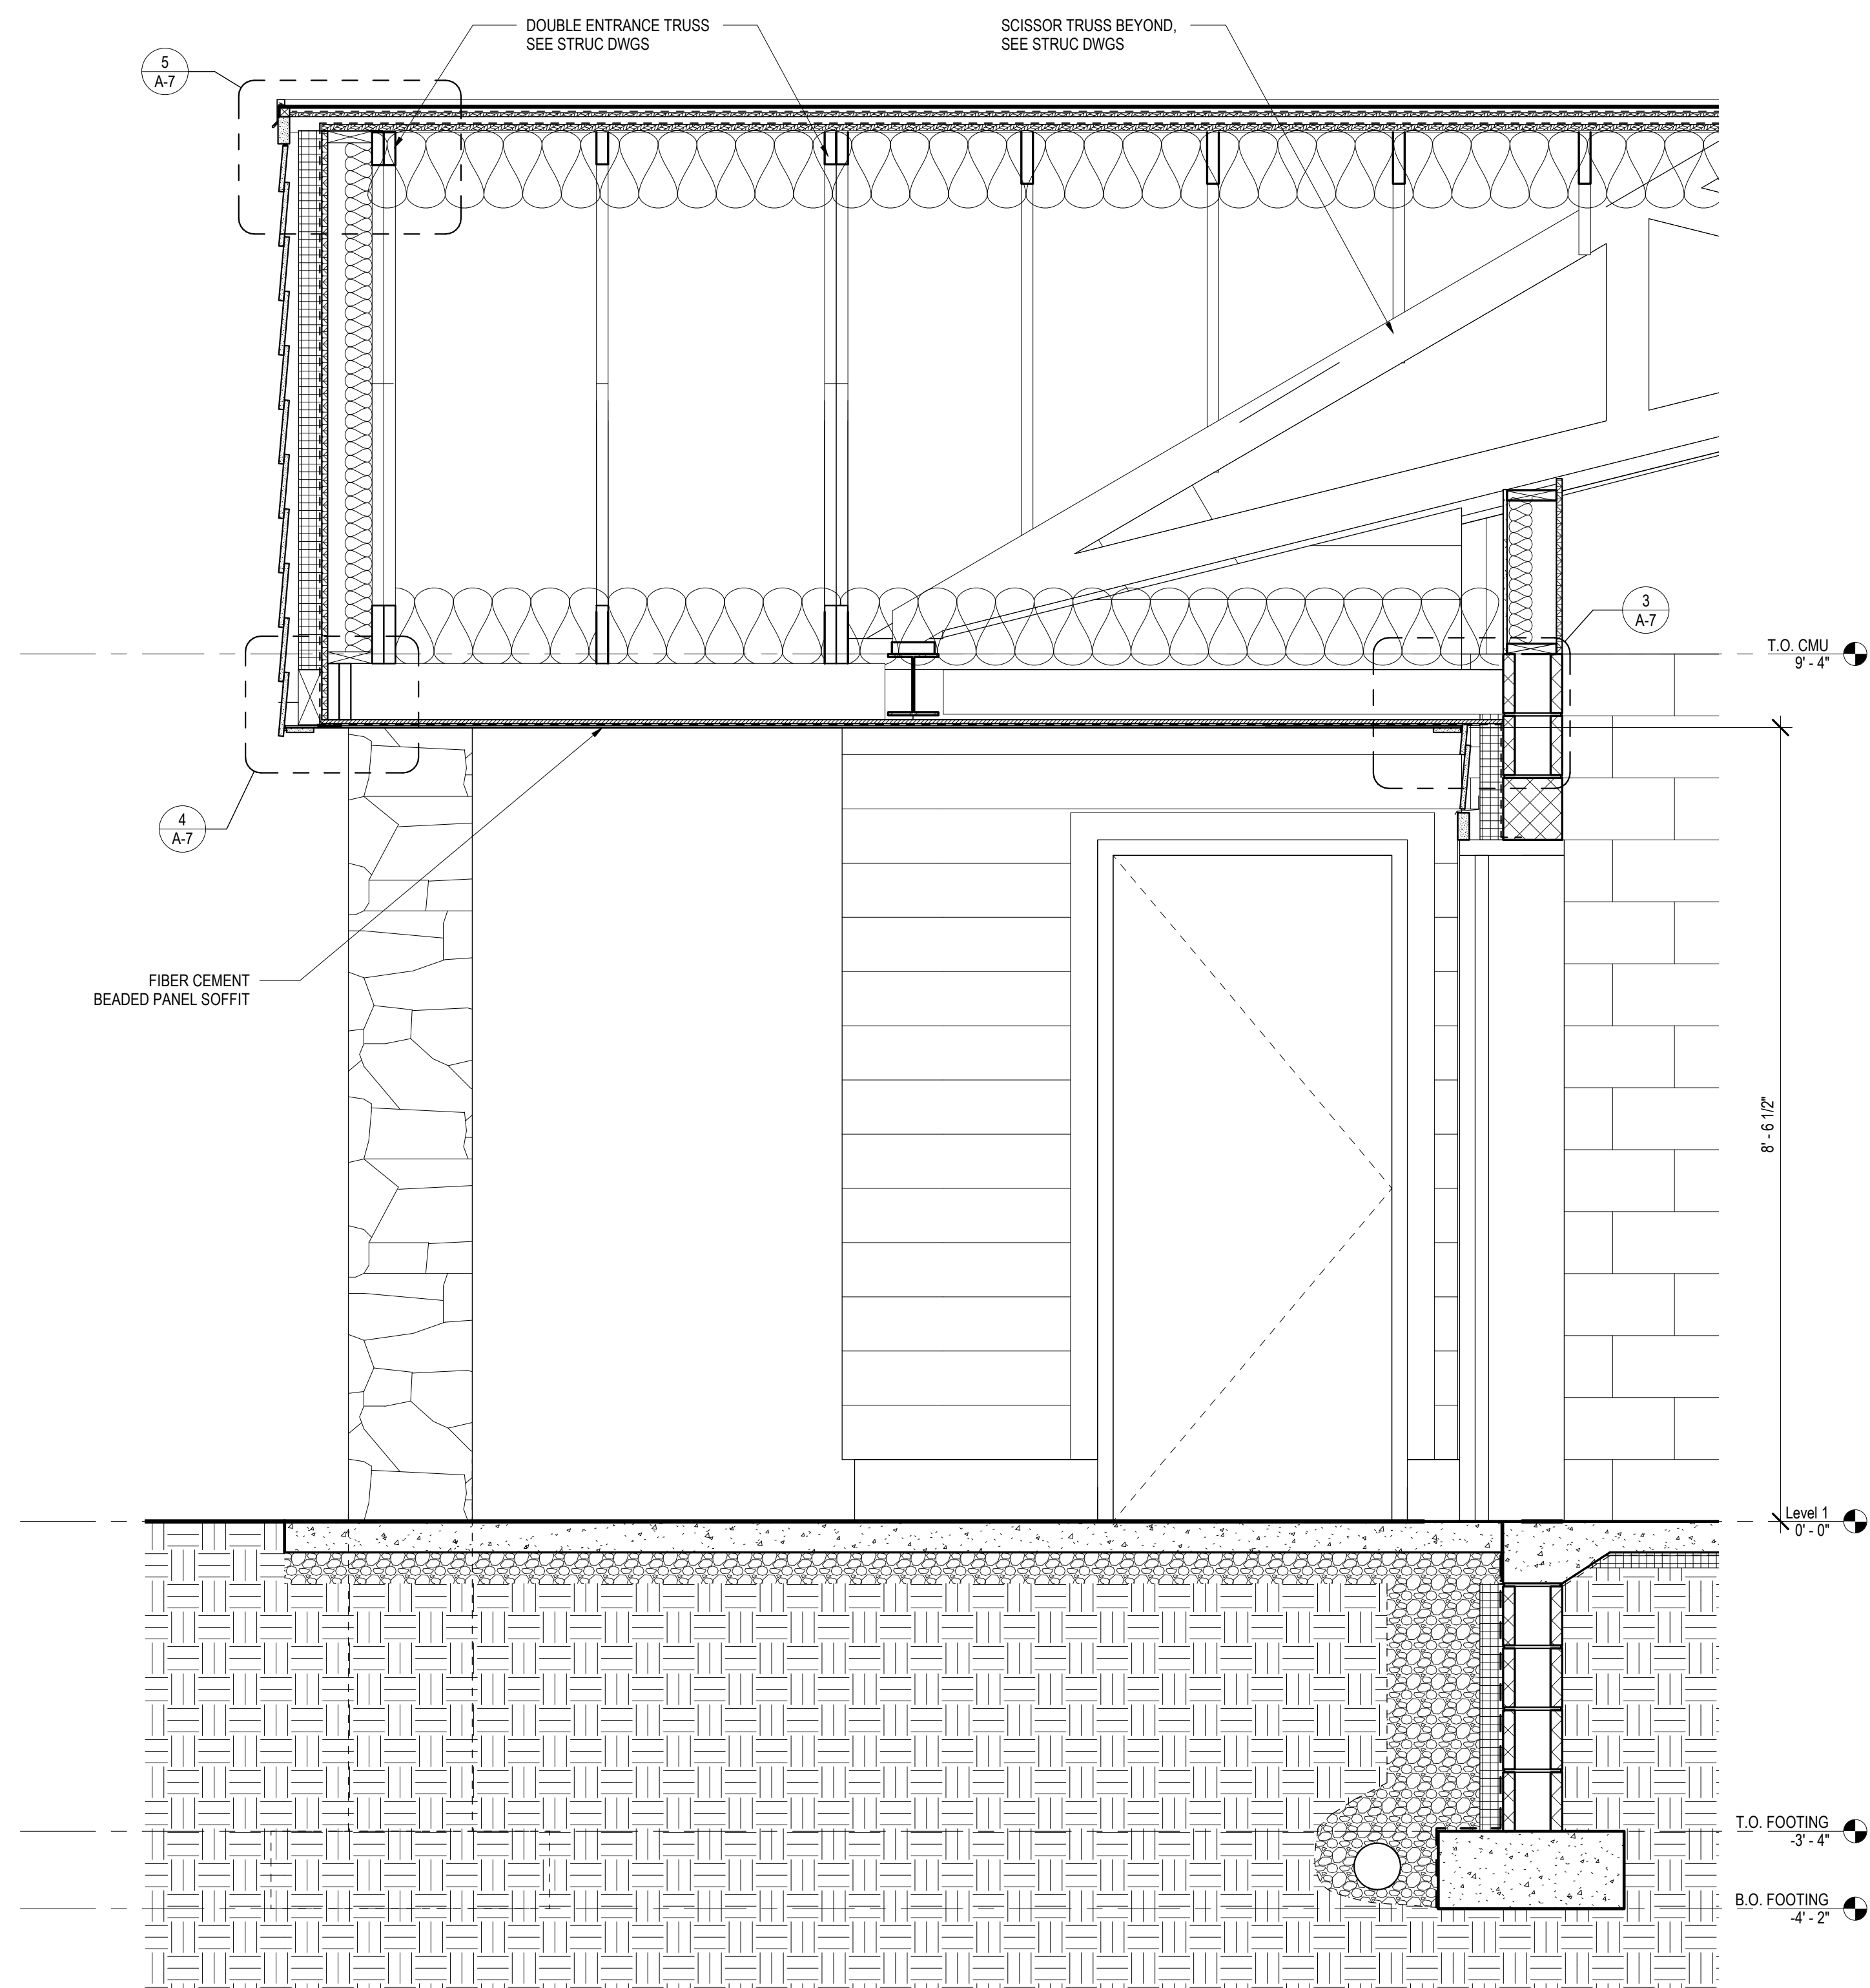

2 WALL SECTION - LOOP C ENTRY PORCH
A-6 3/4" = 1'-0"

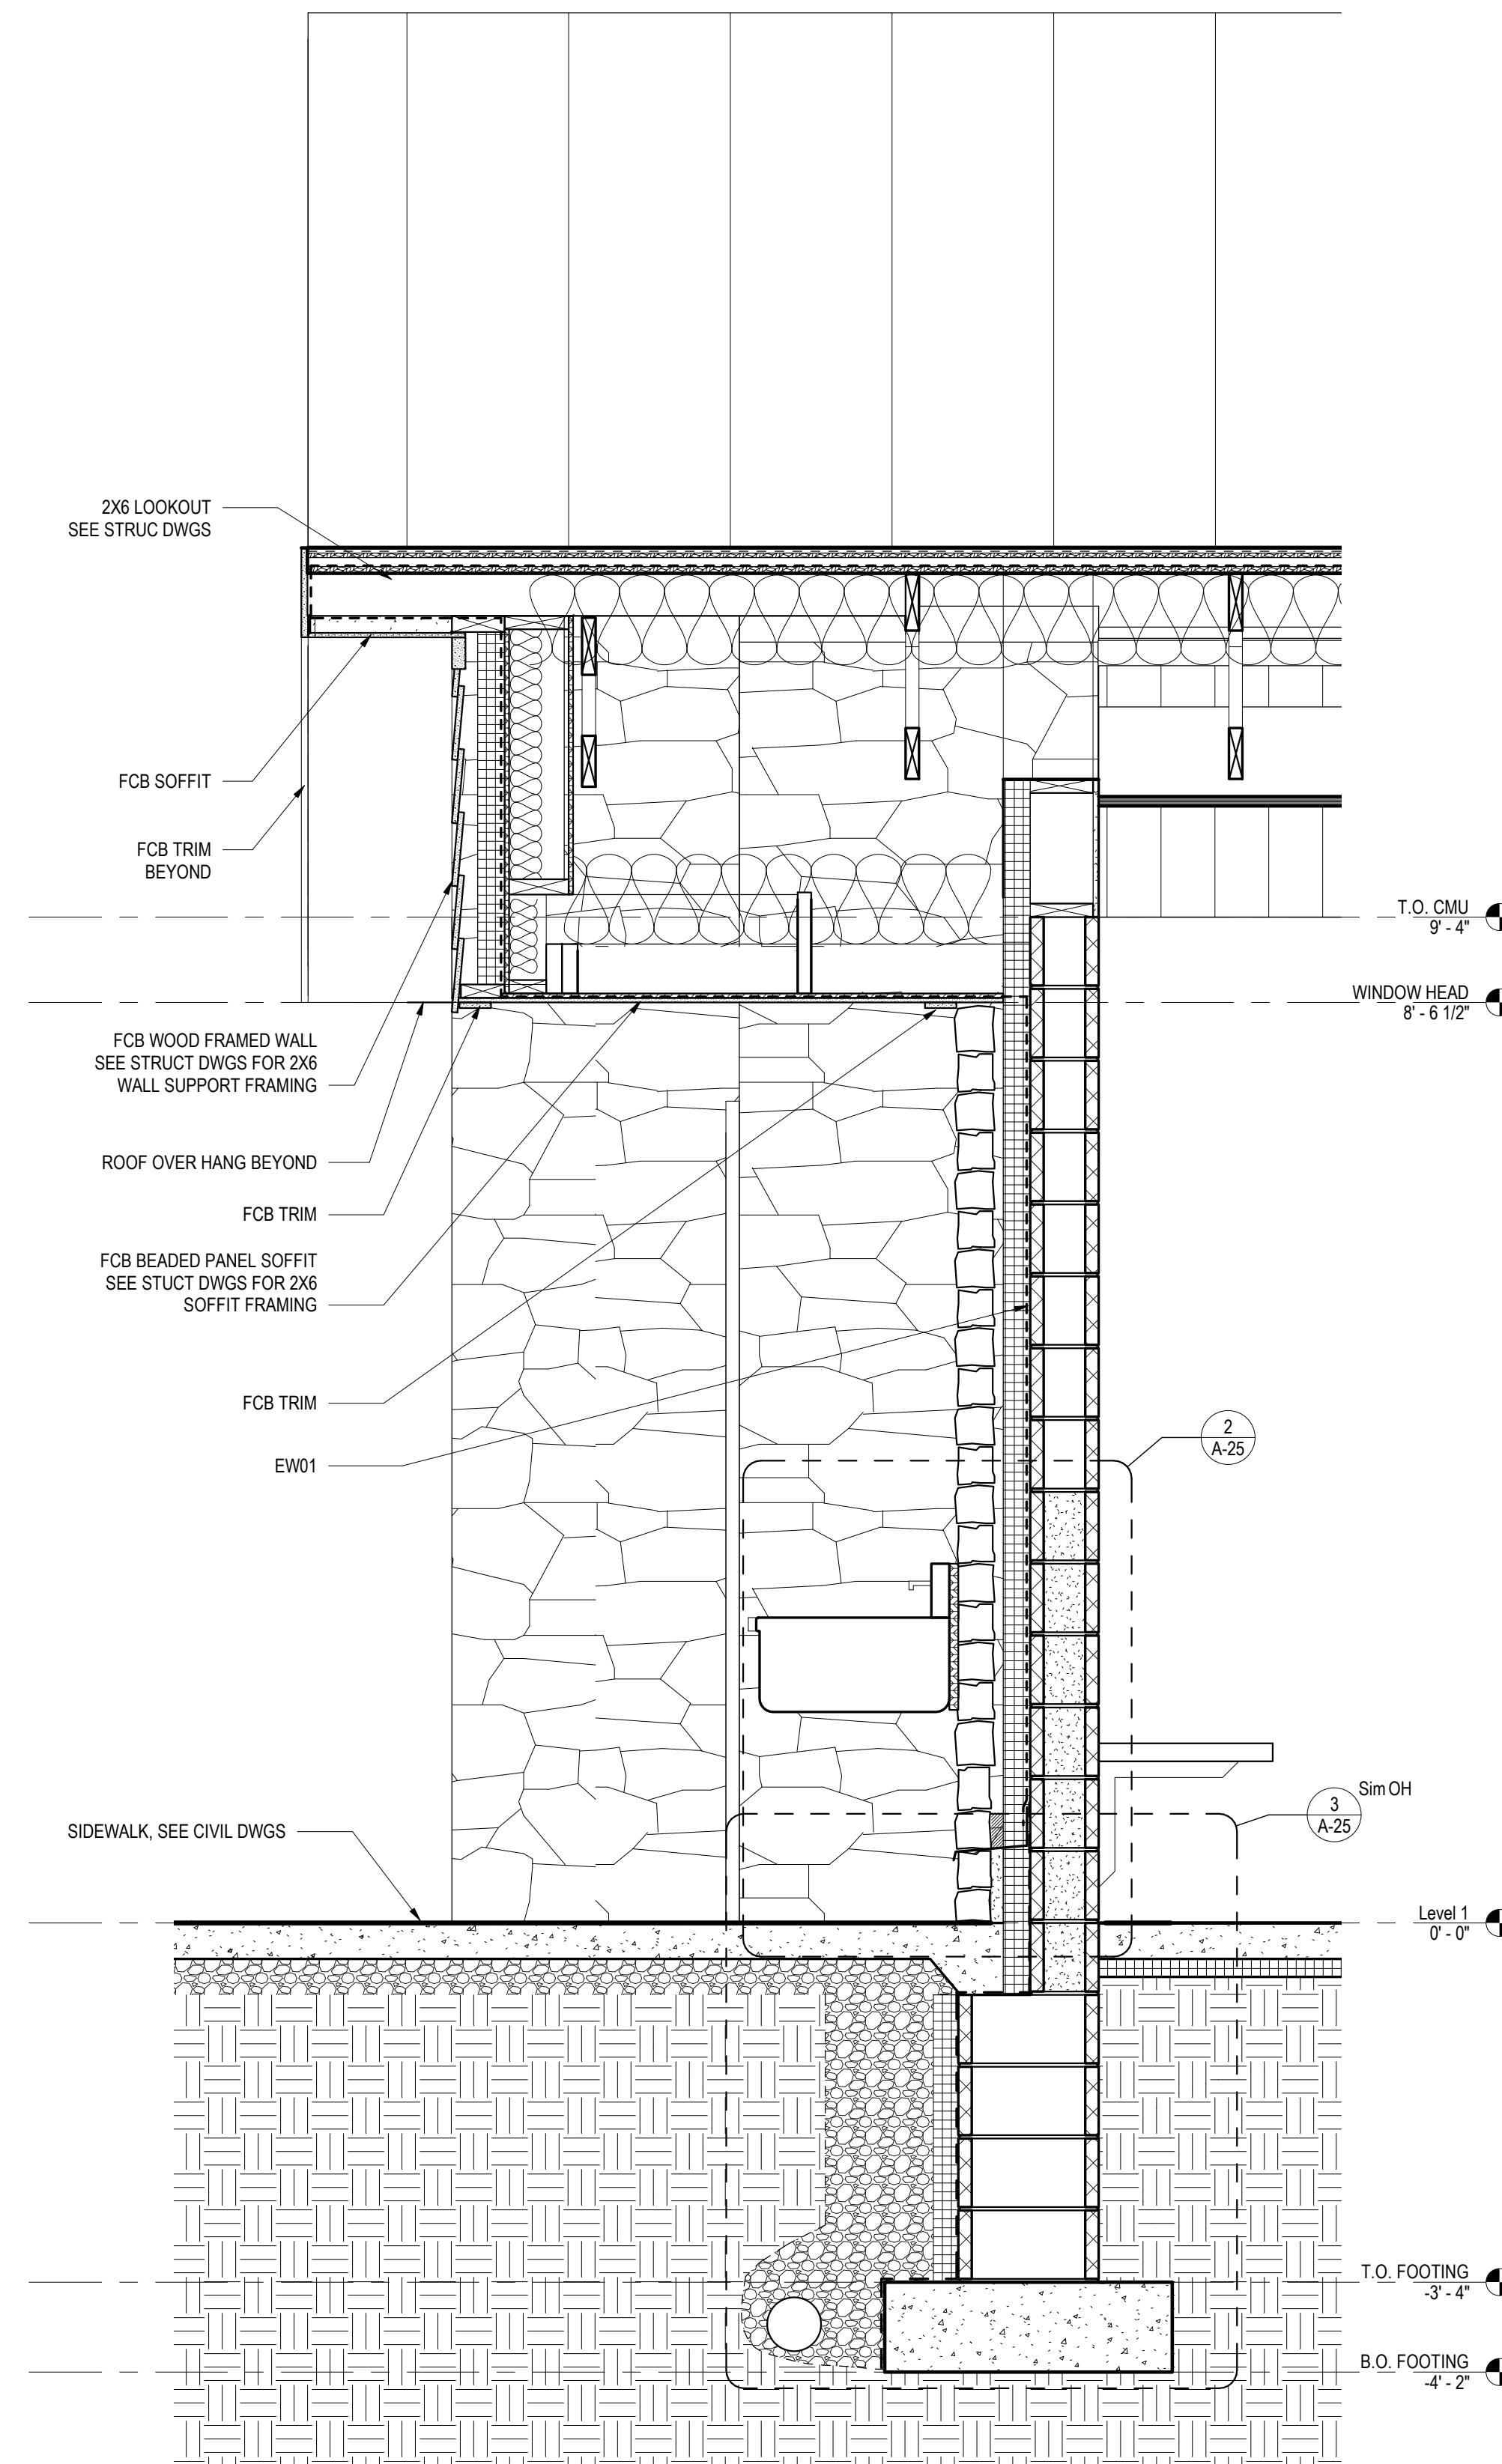

1 WALL SECTION - LOOP C DISHWASHING SINK OVERHANG
A-6 3/4" = 1'-0"


VERIFY SCALE
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DRAWN BY
M STRENSKI
 DATE
06/17/2022
 CHECKED BY
T WOODWARD
 SCALE
AS NOTED


DRAWING No.
A-6
 60 OF 144

CONSTRUCTION DOCUMENTS	
RECORD REVISIONS	
 03/05/2021 SIGNATURE DATE	
SMP ARCHITECTS 1600 WALNUT STREET, SECOND FLOOR PHILADELPHIA, PENNSYLVANIA	
COMMONWEALTH OF PENNSYLVANIA DEPARTMENT OF GENERAL SERVICES HARRISBURG, PENNSYLVANIA	
D.G.S. PROJECT No. C-114-0006 PHASE 1	
HICKORY RUN STATE PARK LATRINE IMPROVEMENTS	
DEPT of CONSERVATION AND NATURAL RESOURCES WHITE HAVEN, CARBON COUNTY, PA	
LOOP C - WALL SECTIONS	


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 PLOTTED BY: Megan M. Strenski
 PLOTTED: 2022.06.04 12:14 PM

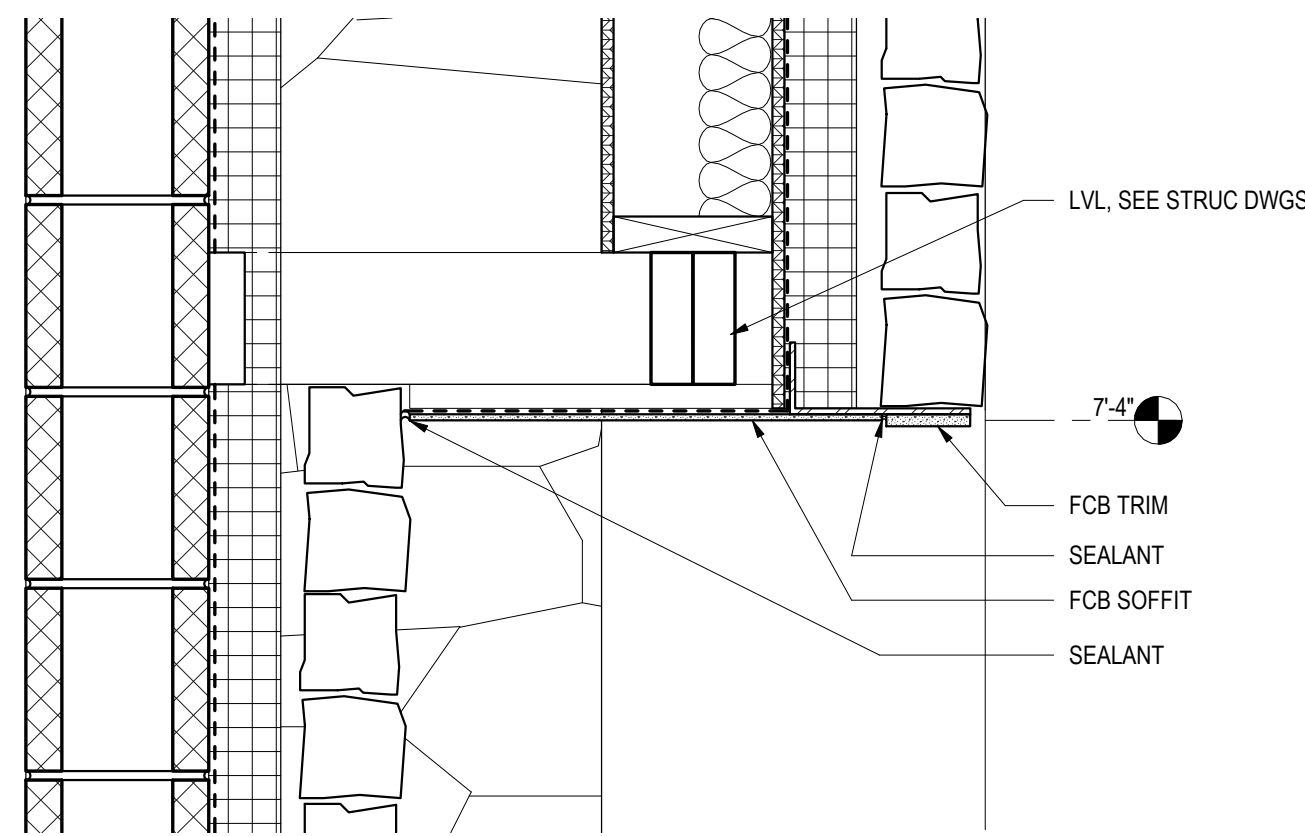


7 SECTION - FCB SOFFIT AT STONE WALL
A-7 1 1/2" = 1'-0"

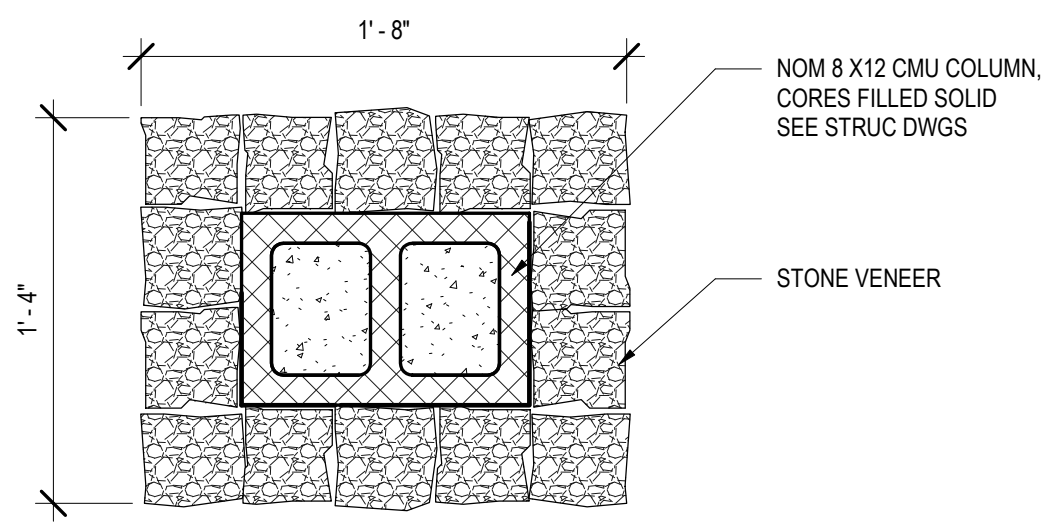


6 PLAN DETAIL - LOOP C PORCH COLUMN
A-7 1 1/2" = 1'-0"

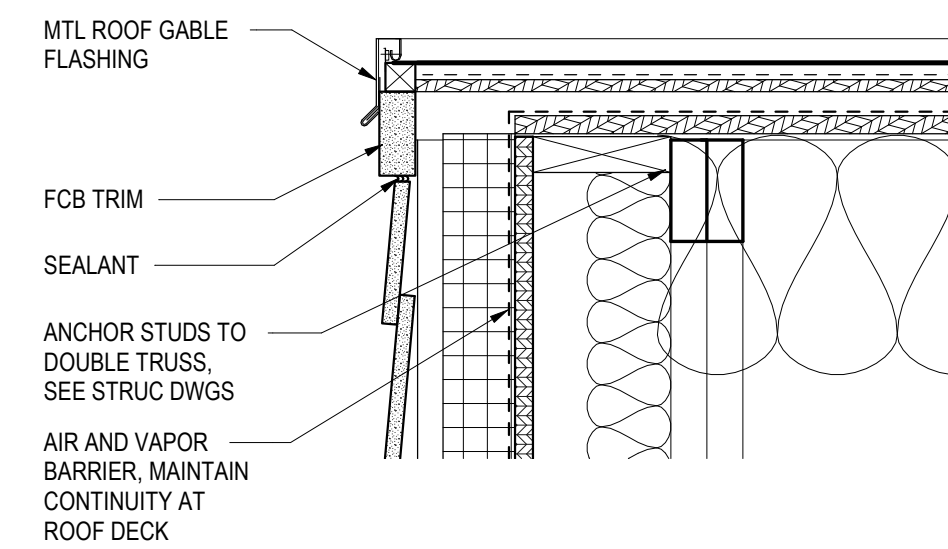


5 WALL SECTION - RAKE DETAIL
A-7 1 1/2" = 1'-0"

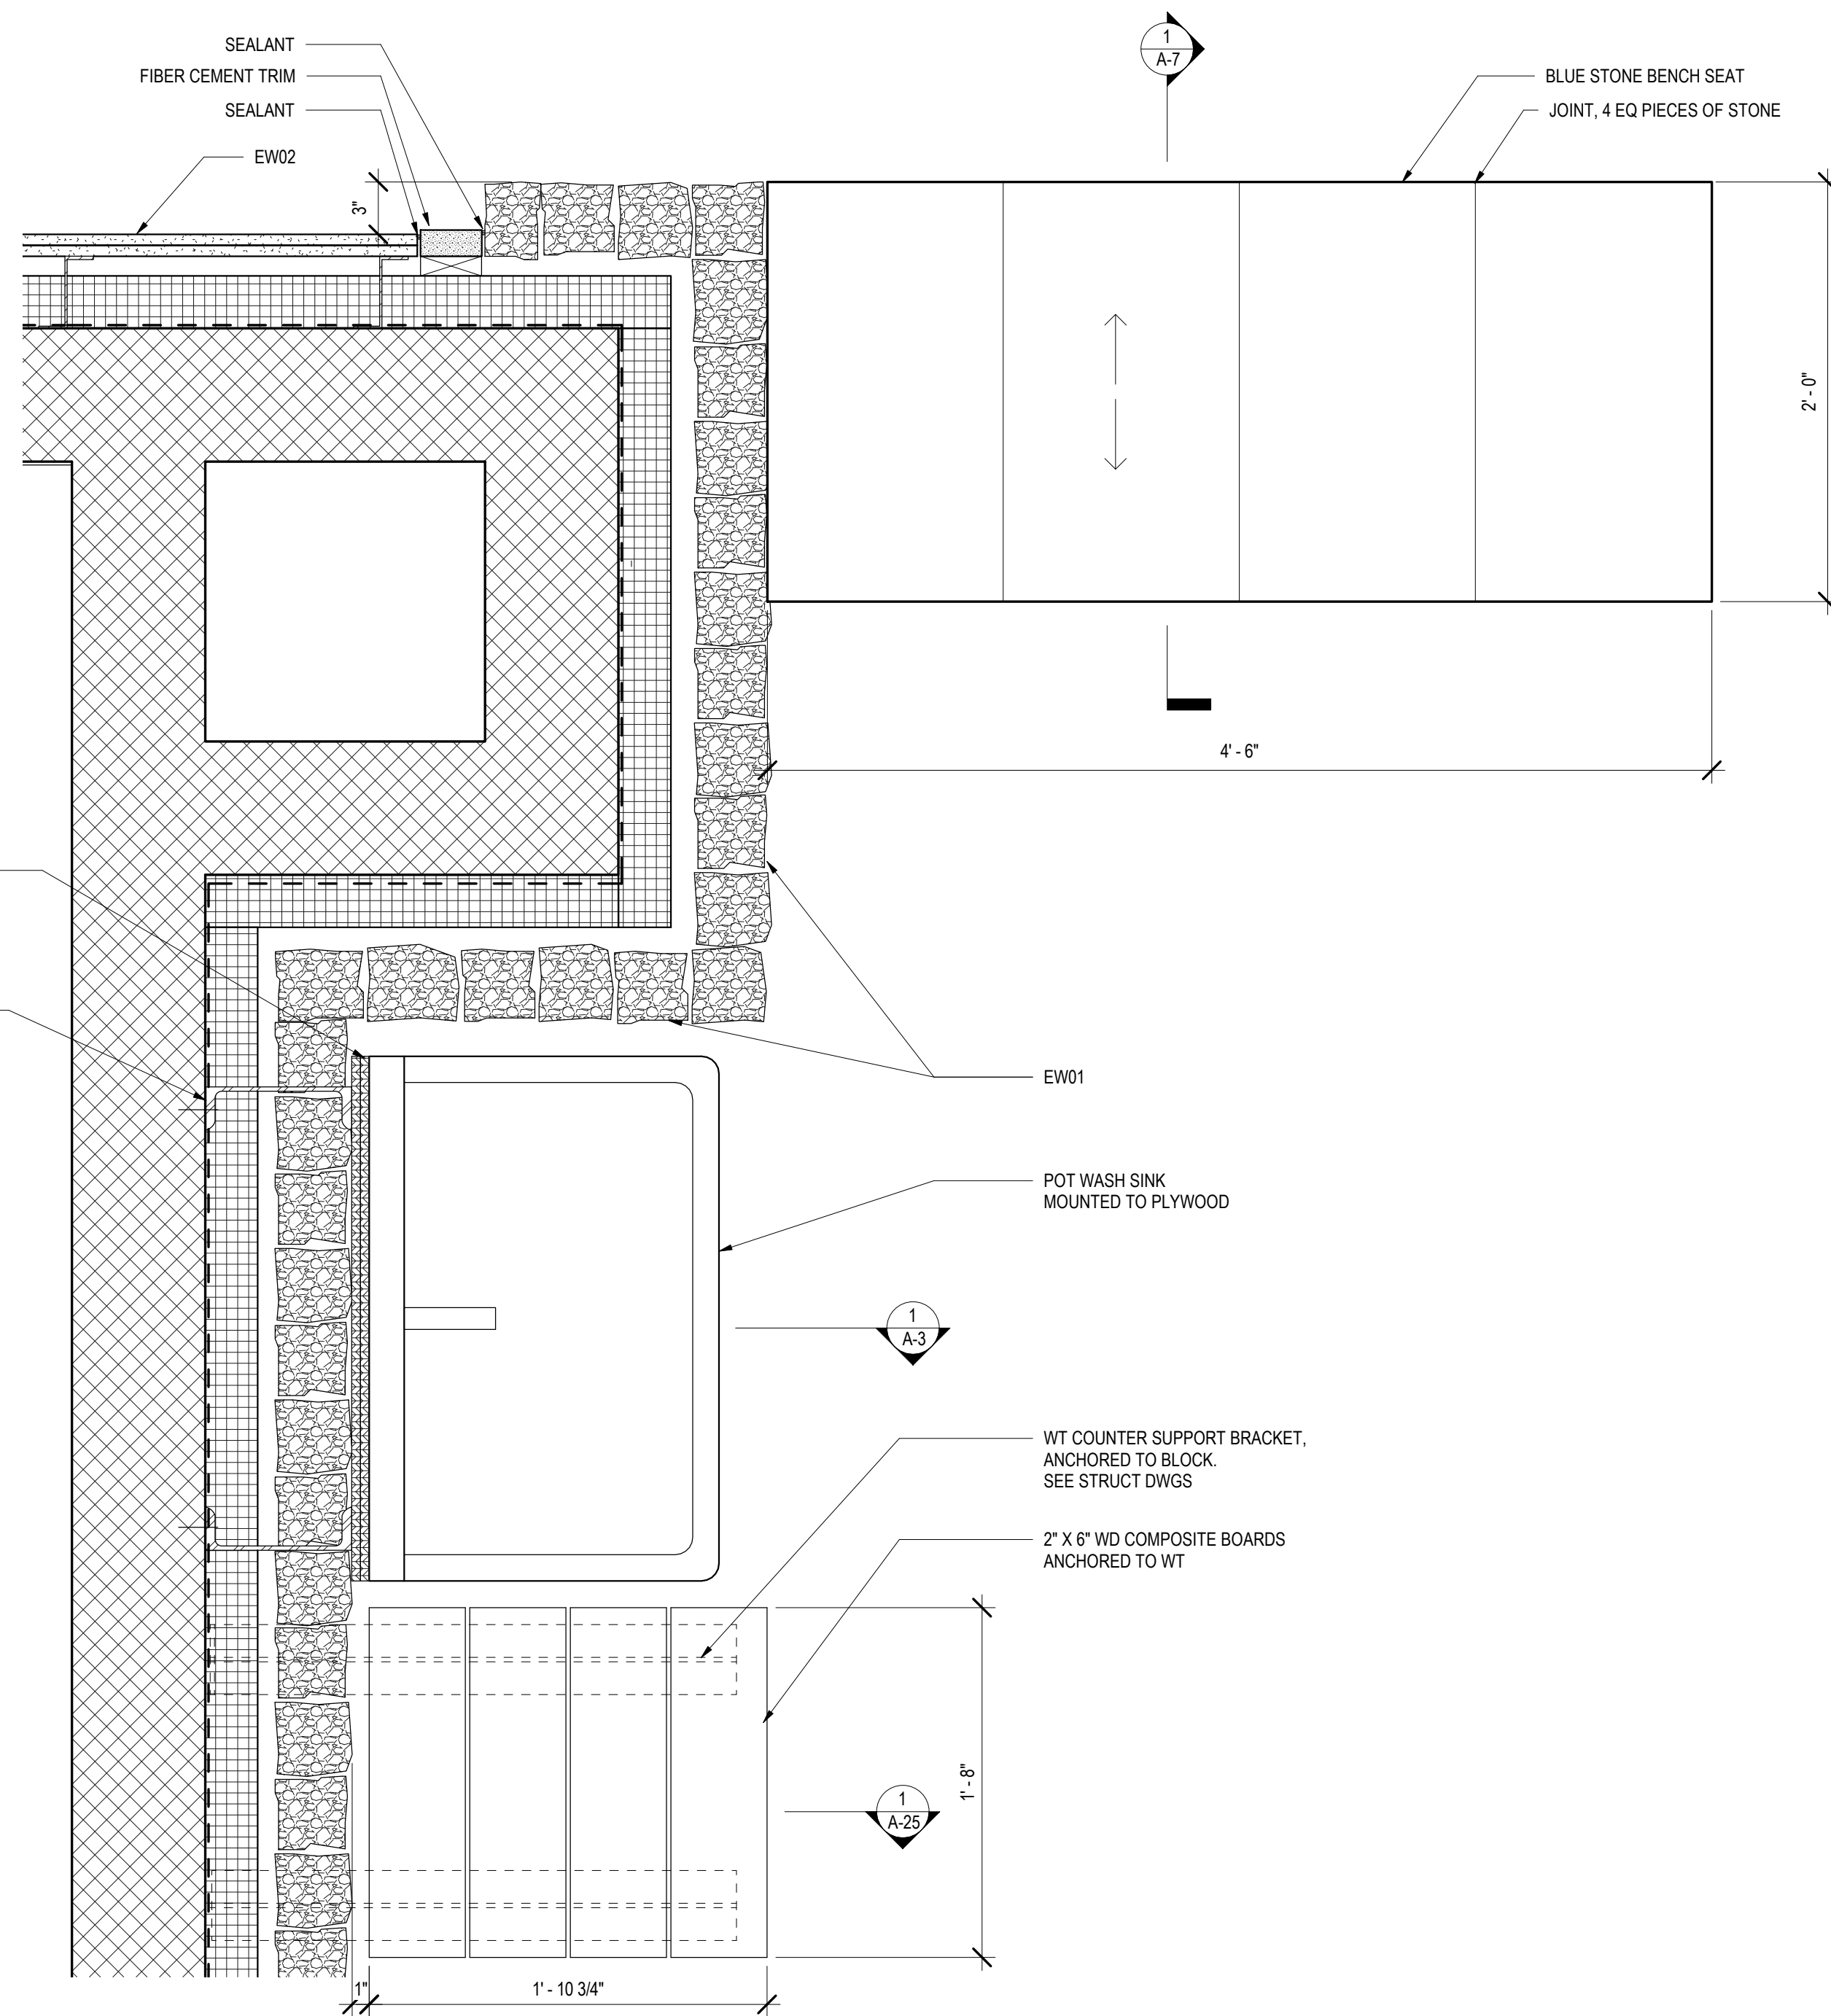


2 PLAN DETAIL - LOOP C EXTERIOR BENCH
A-7 1 1/2" = 1'-0"

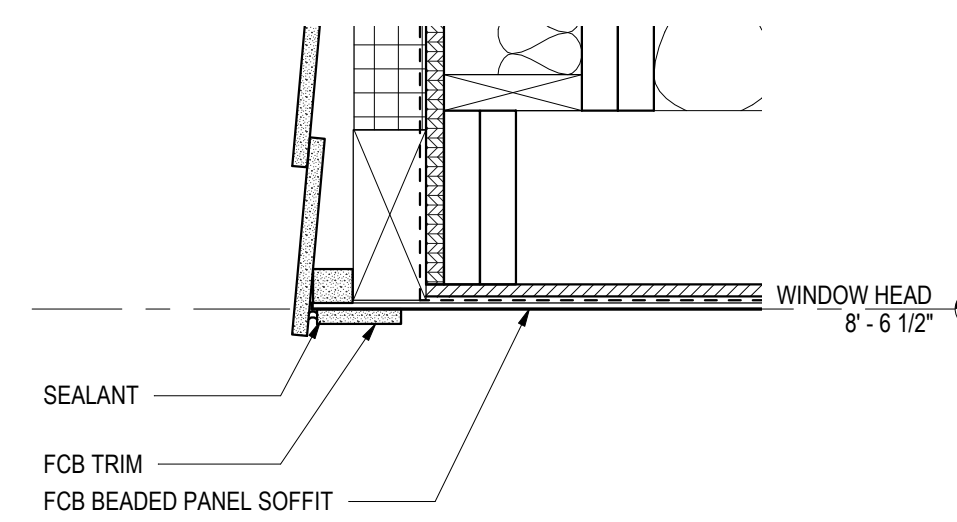

4 WALL SECTION - FCB SOFFIT OUTSIDE CORNER
A-7 1 1/2" = 1'-0"

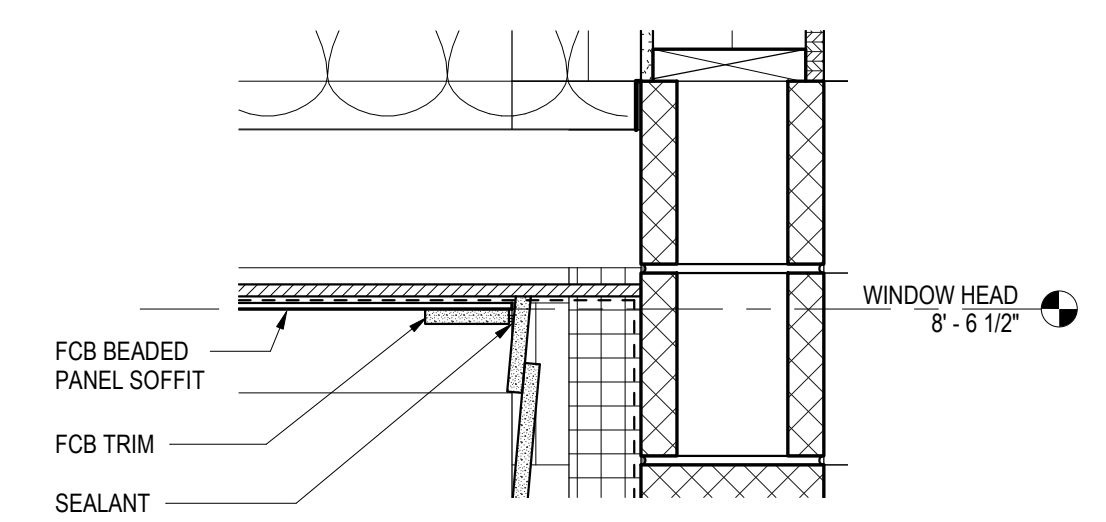

3 SECTION DETAIL - FCB SOFFIT INSIDE CORNER
A-7 1 1/2" = 1'-0"

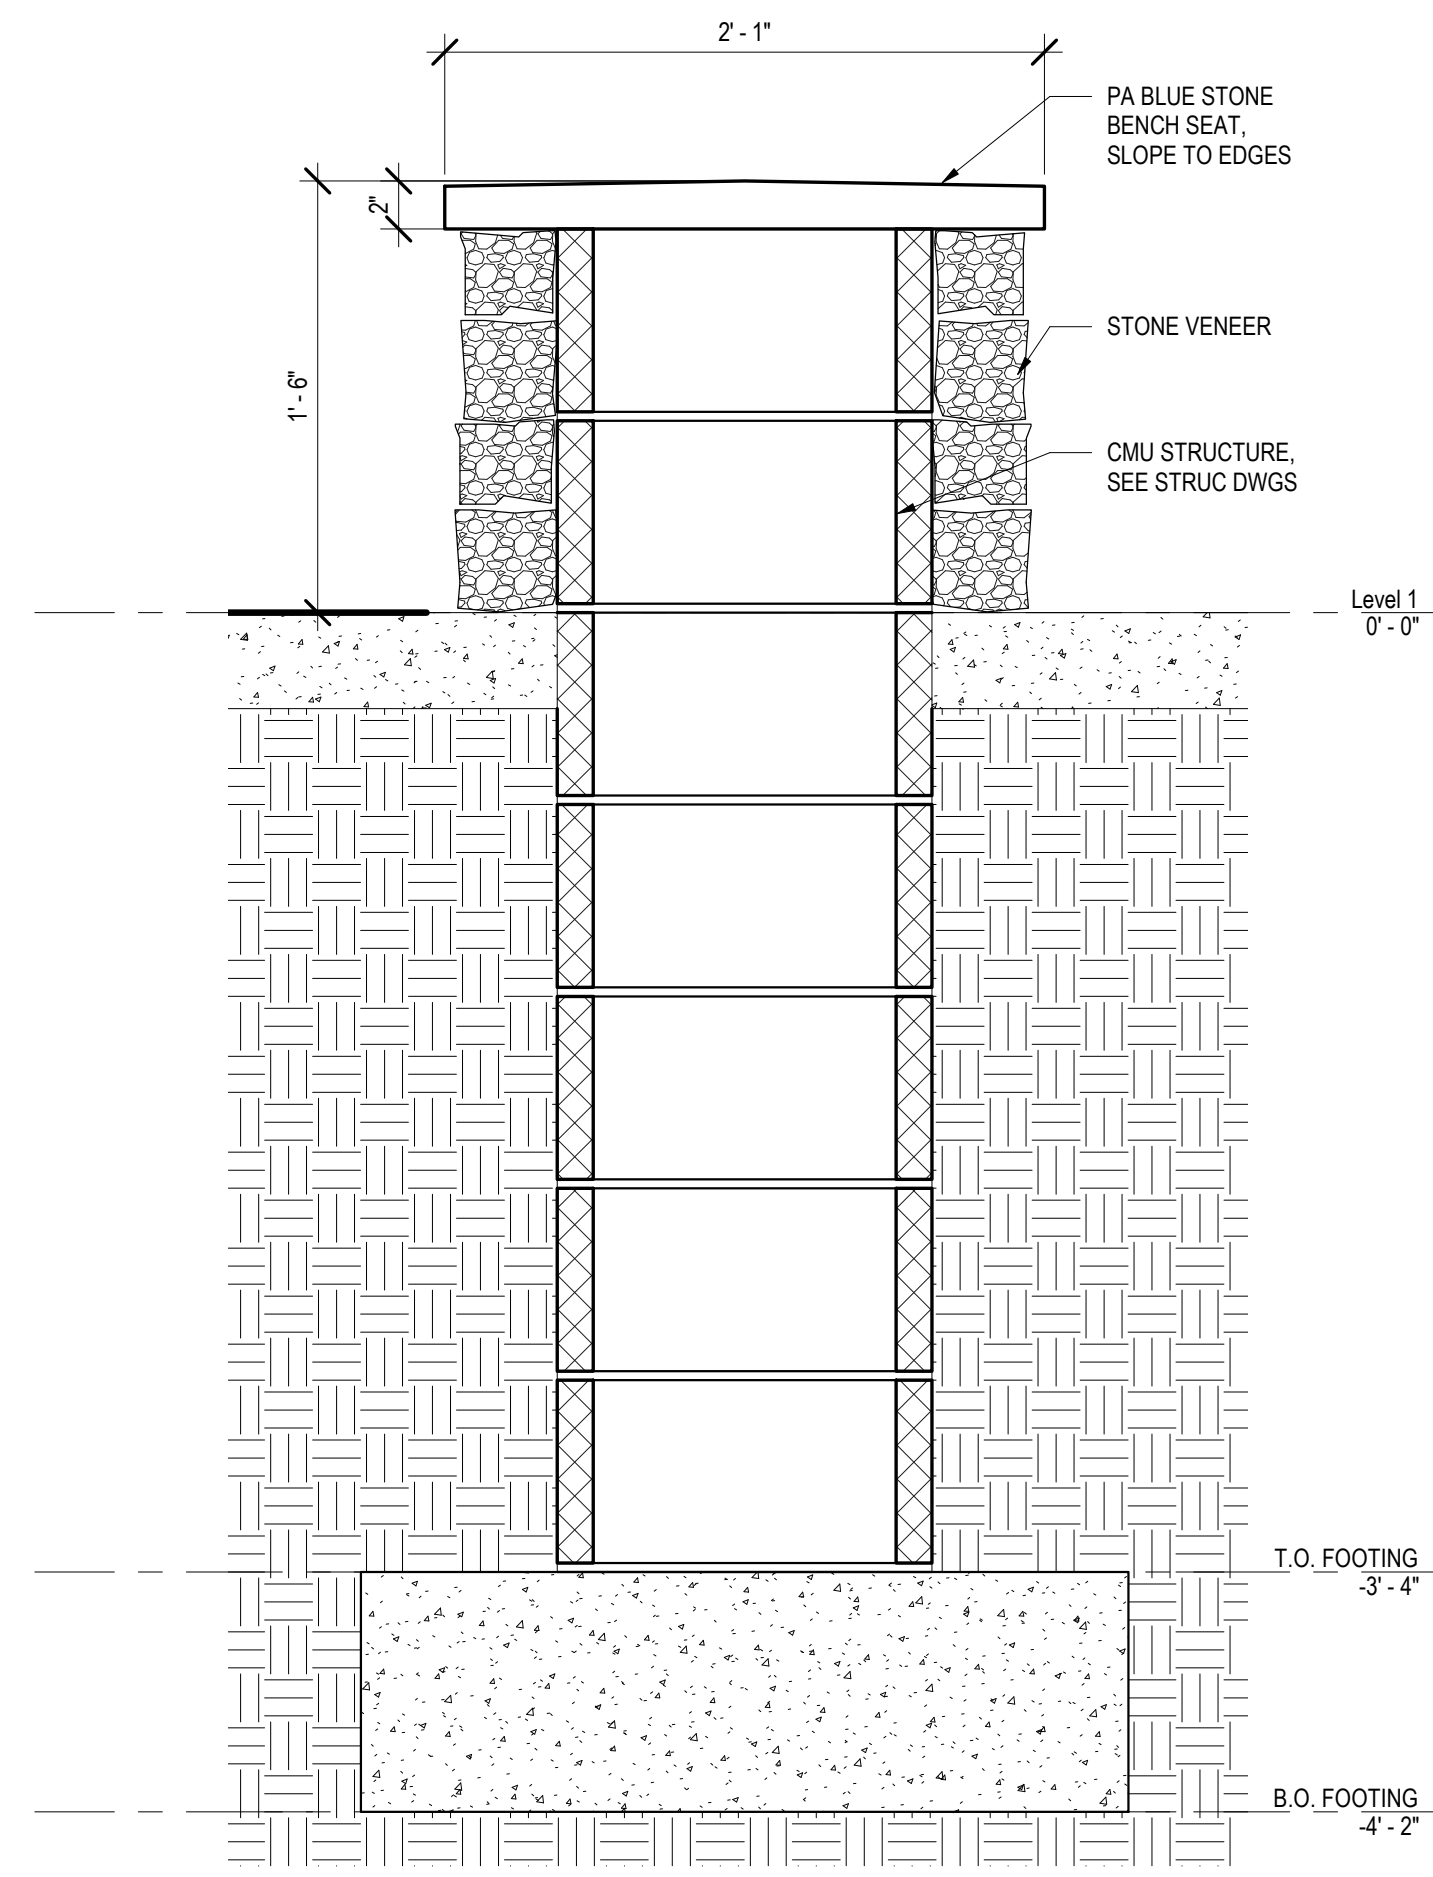

1 SECTION - LOOP C EXTERIOR BENCH
A-7 1 1/2" = 1'-0"

CONSTRUCTION DOCUMENTS

RECORD REVISIONS



SIGNATURE DATE 03/05/2021

SMP ARCHITECTS
1600 WALNUT STREET, SECOND FLOOR
PHILADELPHIA, PENNSYLVANIA

COMMONWEALTH OF PENNSYLVANIA
DEPARTMENT OF GENERAL SERVICES
HARRISBURG, PENNSYLVANIA

D.G.S. PROJECT No. C-114-0006 PHASE 1

HICKORY RUN STATE PARK
LATRINE IMPROVEMENTS
DEPT of CONSERVATION AND NATURAL RESOURCES
WHITE HAVEN, CARBON COUNTY, PA

LOOP C - DETAILS

VERIFY SCALE

BAR IS ONE (1) INCH LONG
ON ORIGINAL DRAWING: 0 1

IF BAR IS NOT ONE (1) INCH LONG, ADJUST SCALE ACCORDINGLY

CONTRACTOR SHALL FIELD VERIFY ALL DIMENSIONS. VARIANCES FROM CONTRACT DOCUMENTS NOT PERMITTED WITHOUT PROFESSIONAL & BUREAU OF CONSTRUCTION APPROVAL.

DRAWN BY M STRENSKI
DATE 06/17/2022
CHECKED BY T WOODWARD
SCALE AS NOTED


DRAWING No. A-7
61 OF 144

GENERAL NOTES:


1. HVAC EQUIPMENT IS PROVIDED BY THE .2 CONTRACT.
2. PLUMBING FIXTURES ARE PROVIDED BY THE .3 CONTRACT.
3. LIGHT FIXTURES ARE PROVIDED BY THE .4 CONTRACT.
4. ALL EXPOSED SURFACES OF GFCMU BLOCKS IN OCCUPIED SPACES SHALL BE GROUND AND FINISHED.

CONSTRUCTION NOTES (CN)

- CN-1 STANDING SEAM METAL ROOF (R2)
- CN-2 TUBULAR SKYLIGHT
- CN-3 METAL DOWNSPOUT
- CN-4 METAL GUTTER
- CN-5 CONCRETE SIDEWALK. SEE CIVIL DWGS.
- CN-6 WATER FOUNTAIN. SEE MEP DWGS.
- CN-7 DISHWASHING SINK
- CN-8 EXTERIOR COUNTER
- CN-9 STONE VENEER BENCH WITH CAST STONE SEAT
- CN-10 NOT USED
- CN-11 WALL MOUNTED FIRE EXTINGUISHER
- CN-12 FLOOR DRAIN. SEE MEP DWGS.
- CN-13 CHANGING AREA PARTITION
- CN-14 BENCH BY PARTITION MANUFACTURER, HOOK (TYPE I) MOUNTED ABOVE
- CN-15 ADA FOLDING SHOWER SEAT
- CN-16 TRENCH DRAIN. SEE MEP DWGS.
- CN-17 EPOXY FLOOR. SLOPE TO DRAIN.
- CN-18 MOP SINK
- CN-19 QUARTZ COUNTERTOP
- CN-20 ELECTRIC HAND DRYER
- CN-21 SOAP DISPENSER
- CN-22 TOILET PARTITION
- CN-23 URINAL SCREEN
- CN-24 TOILET PAPER DISPENSER
- CN-25 ADA GRAB BARS
- CN-26 WASTE RECEPTACLE
- CN-27 BABY CHANGING STATION
- CN-28 ASPHALT SHINGLE ROOF (R1)
- CN-29 STONE VENEER COLUMN
- CN-30 WOOD COLUMNS WITH STONE VENEER BASE
- CN-31 SNOW GUARD
- CN-32 HOPE WALL MOUNTED BENCH
- CN-33 ROOF LINE ABOVE
- CN-34 SEE MEP DRAWINGS FOR EQUIPMENT IN UTILITY ROOM
- CN-35 CLEAR FLOOR SPACE FOR LADDER
- CN-36 UTILITY SHELF

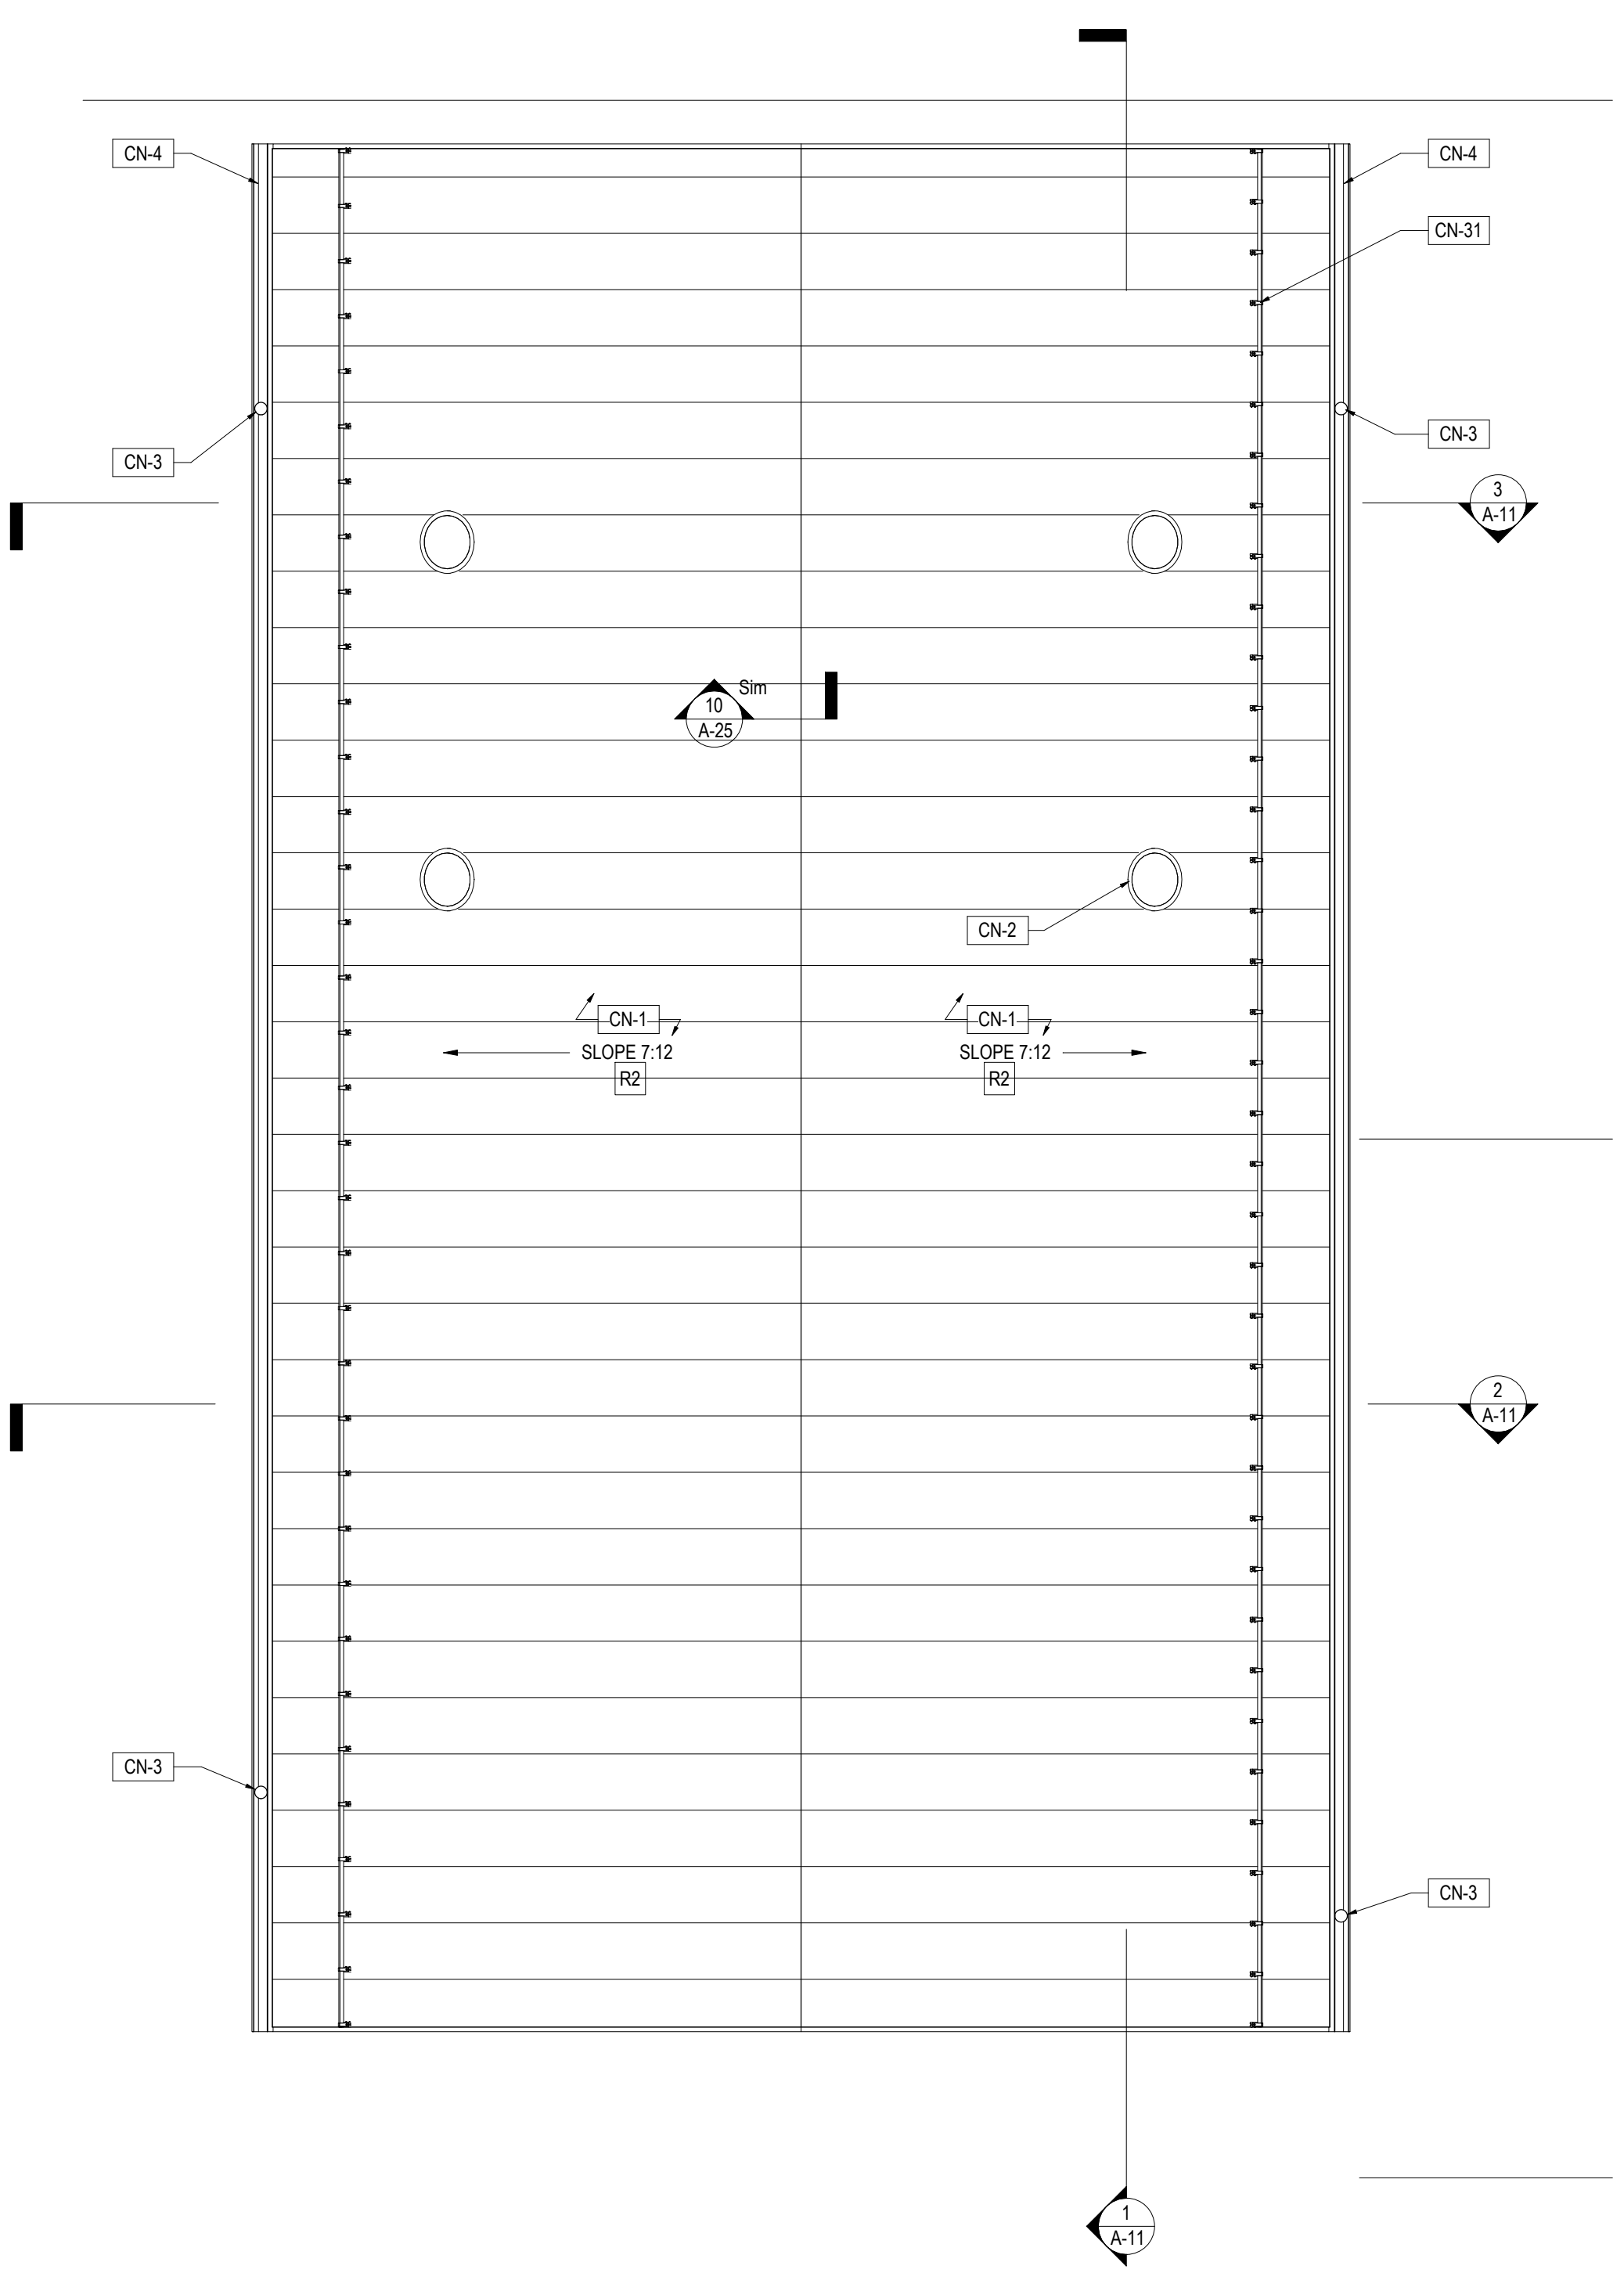


2 TENT CAMP ROOF PLAN
1/4" = 1'-0"

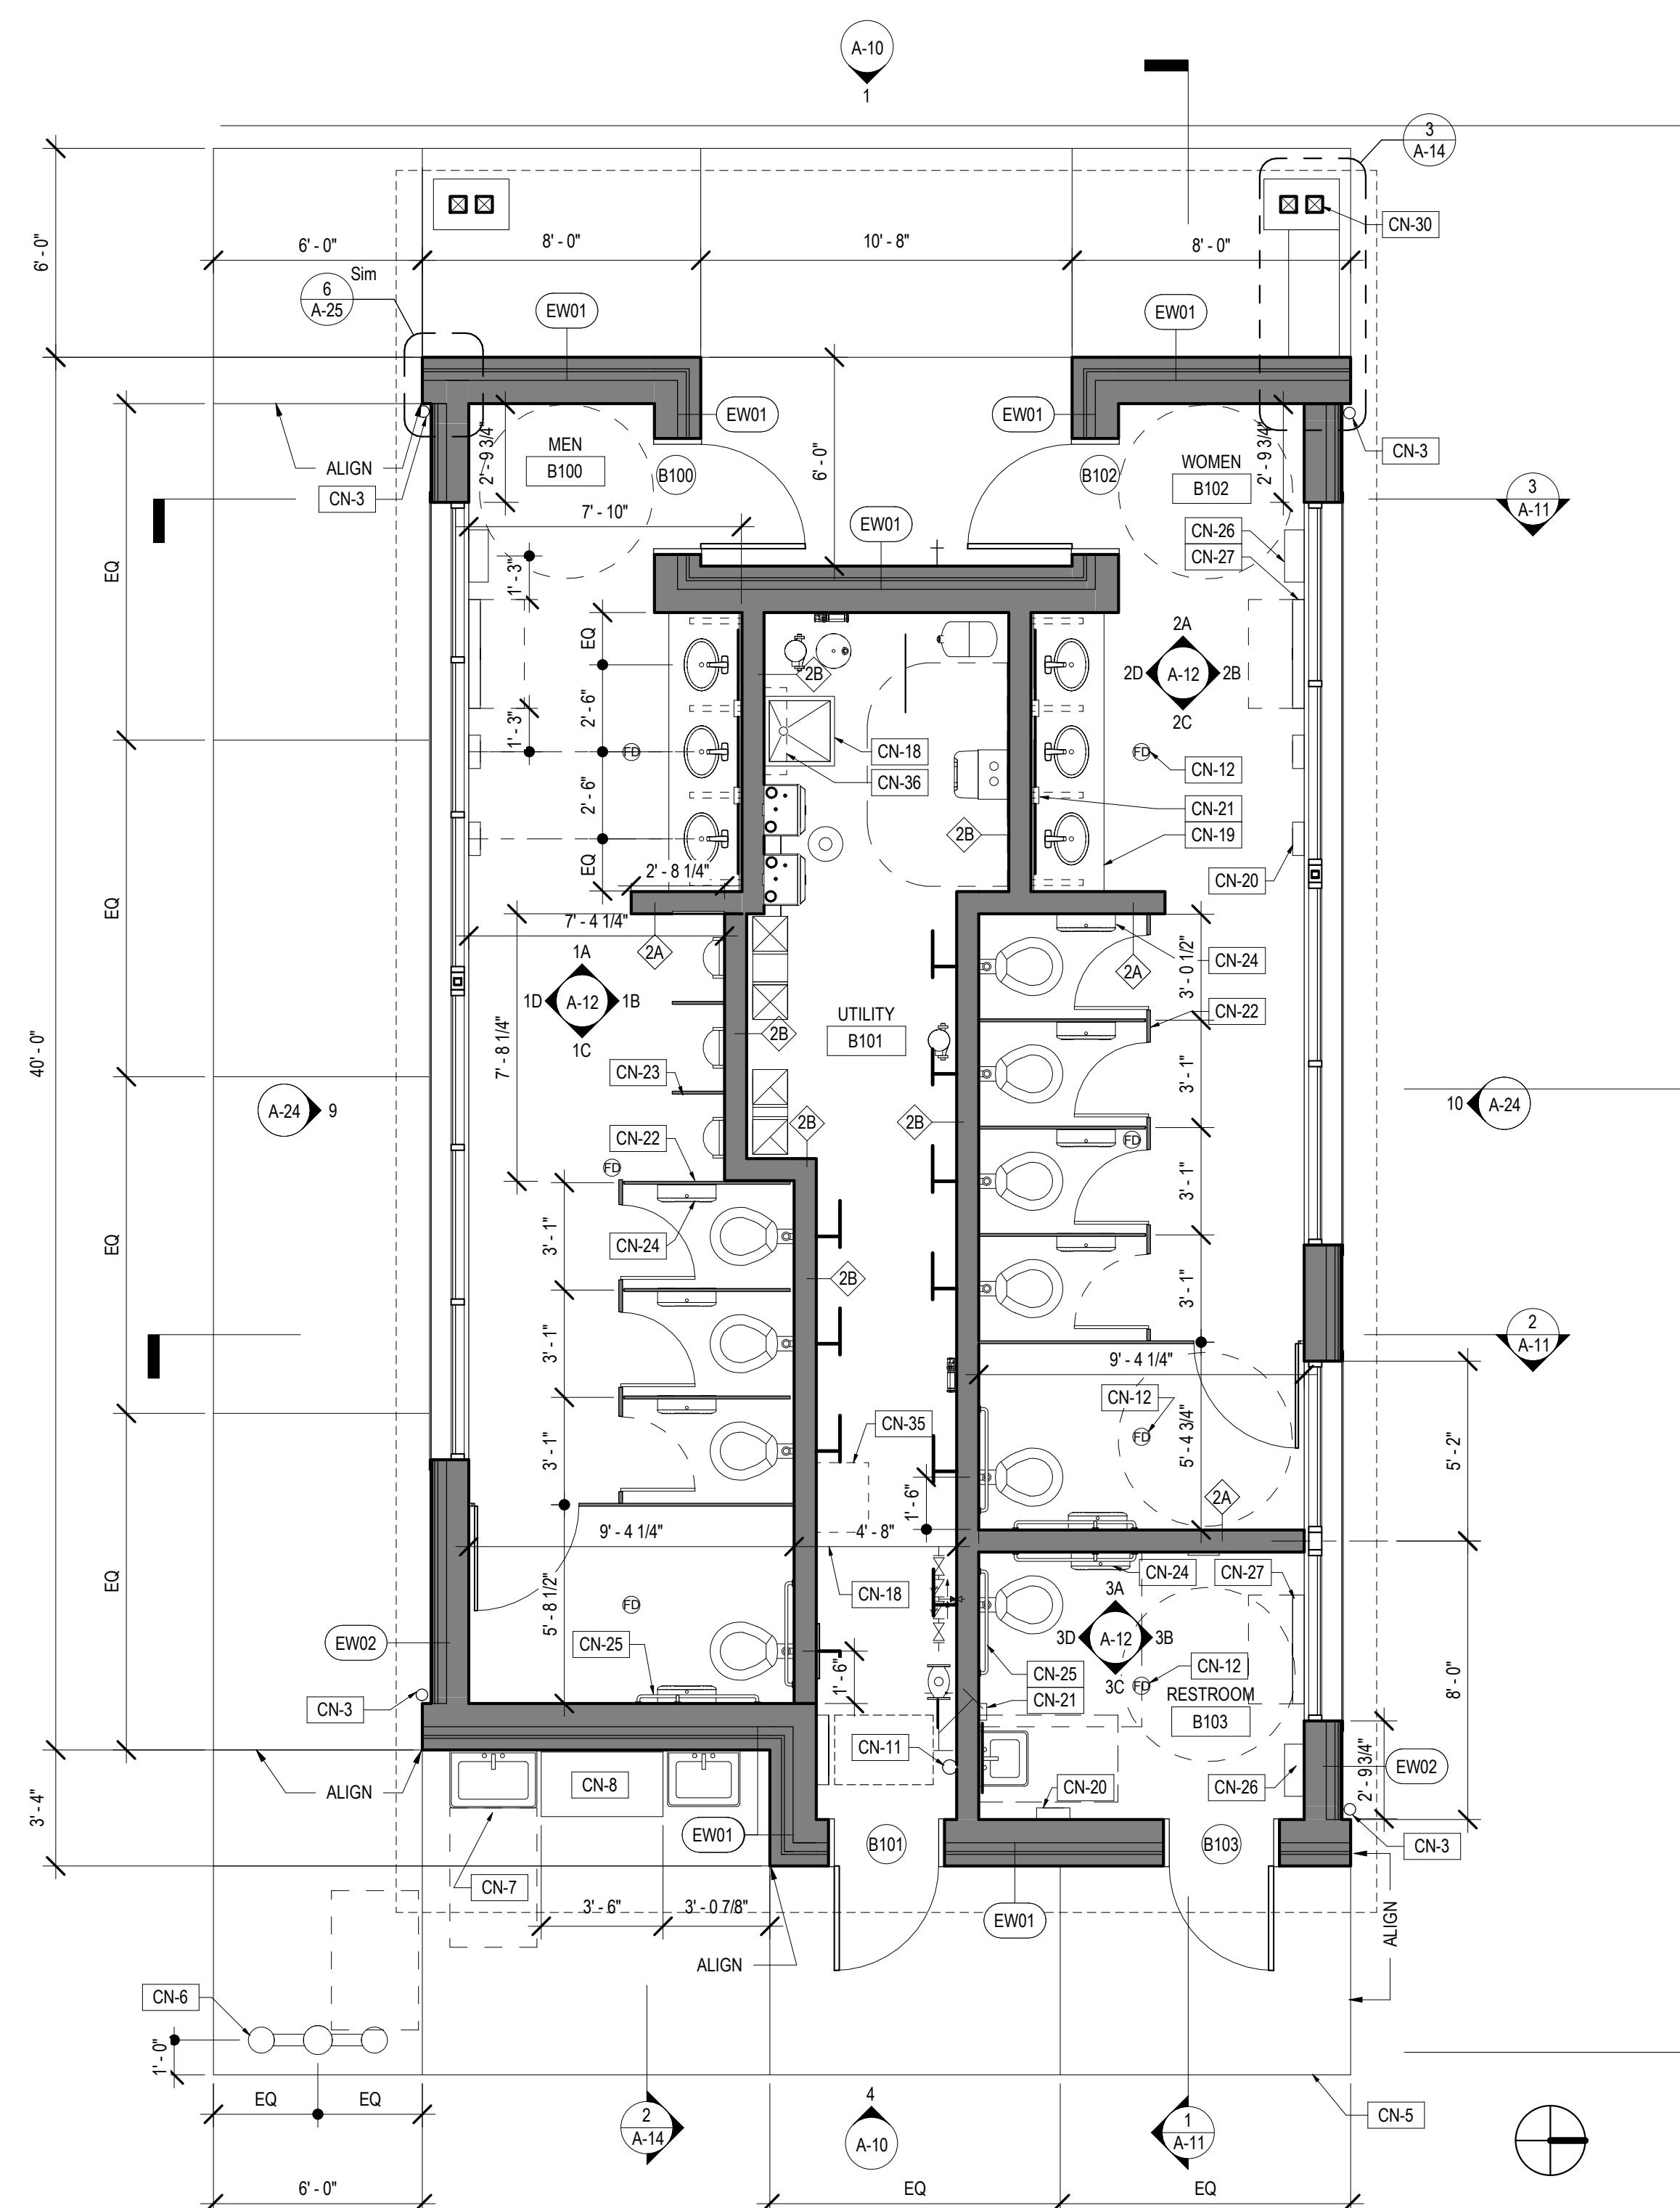

1 TENT CAMP - FLOOR PLAN
1/4" = 1'-0"

CONSTRUCTION DOCUMENTS

RECORD REVISIONS

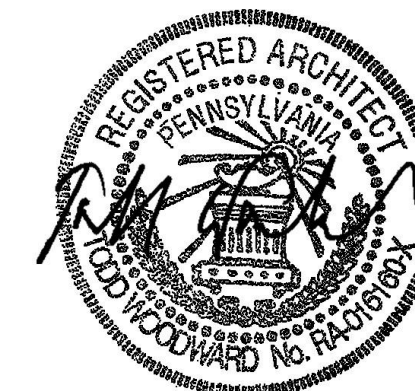

03/05/2021

SIGNATURE

DATE

SMP ARCHITECTS
1600 WALNUT STREET, SECOND FLOOR
PHILADELPHIA, PENNSYLVANIA

COMMONWEALTH OF PENNSYLVANIA
DEPARTMENT OF GENERAL SERVICES
HARRISBURG, PENNSYLVANIA

D.G.S. PROJECT No.
C-114-0006 PHASE 1

HICKORY RUN STATE PARK
LATRINE IMPROVEMENTS
DEPT of CONSERVATION AND NATURAL RESOURCES
WHITE HAVEN, CARBON COUNTY, PA

ORGANIZED GROUP TENT CAMPING - PLANS

VERIFY SCALE


BAR IS ONE (1) INCH LONG
ON ORIGINAL DRAWING: 1
IF BAR IS NOT ONE (1) INCH LONG, ADJUST SCALE ACCORDINGLY

CONTRACTOR SHALL FIELD VERIFY ALL DIMENSIONS. VARIANCE FROM CONTRACT DOCUMENTS NOT PERMITTED WITHOUT PROFESSIONAL & BUREAU OF CONSTRUCTION APPROVAL.


DRAWN BY M STRENSKI	DATE 06/17/2022
CHECKED BY T WOODWARD	SCALE AS NOTED

DRAWING No.
A-9
63 OF 144


FILE PATH: I:\723_Hickory Run\01_Arch\01_Arch\01_Arch.dwg
LAST SAVER: 2022.06.04 12:14 PM
PLOTTER: 2016.11.08 10:35 AM
PLOTTED BY: Megan M. Strenski

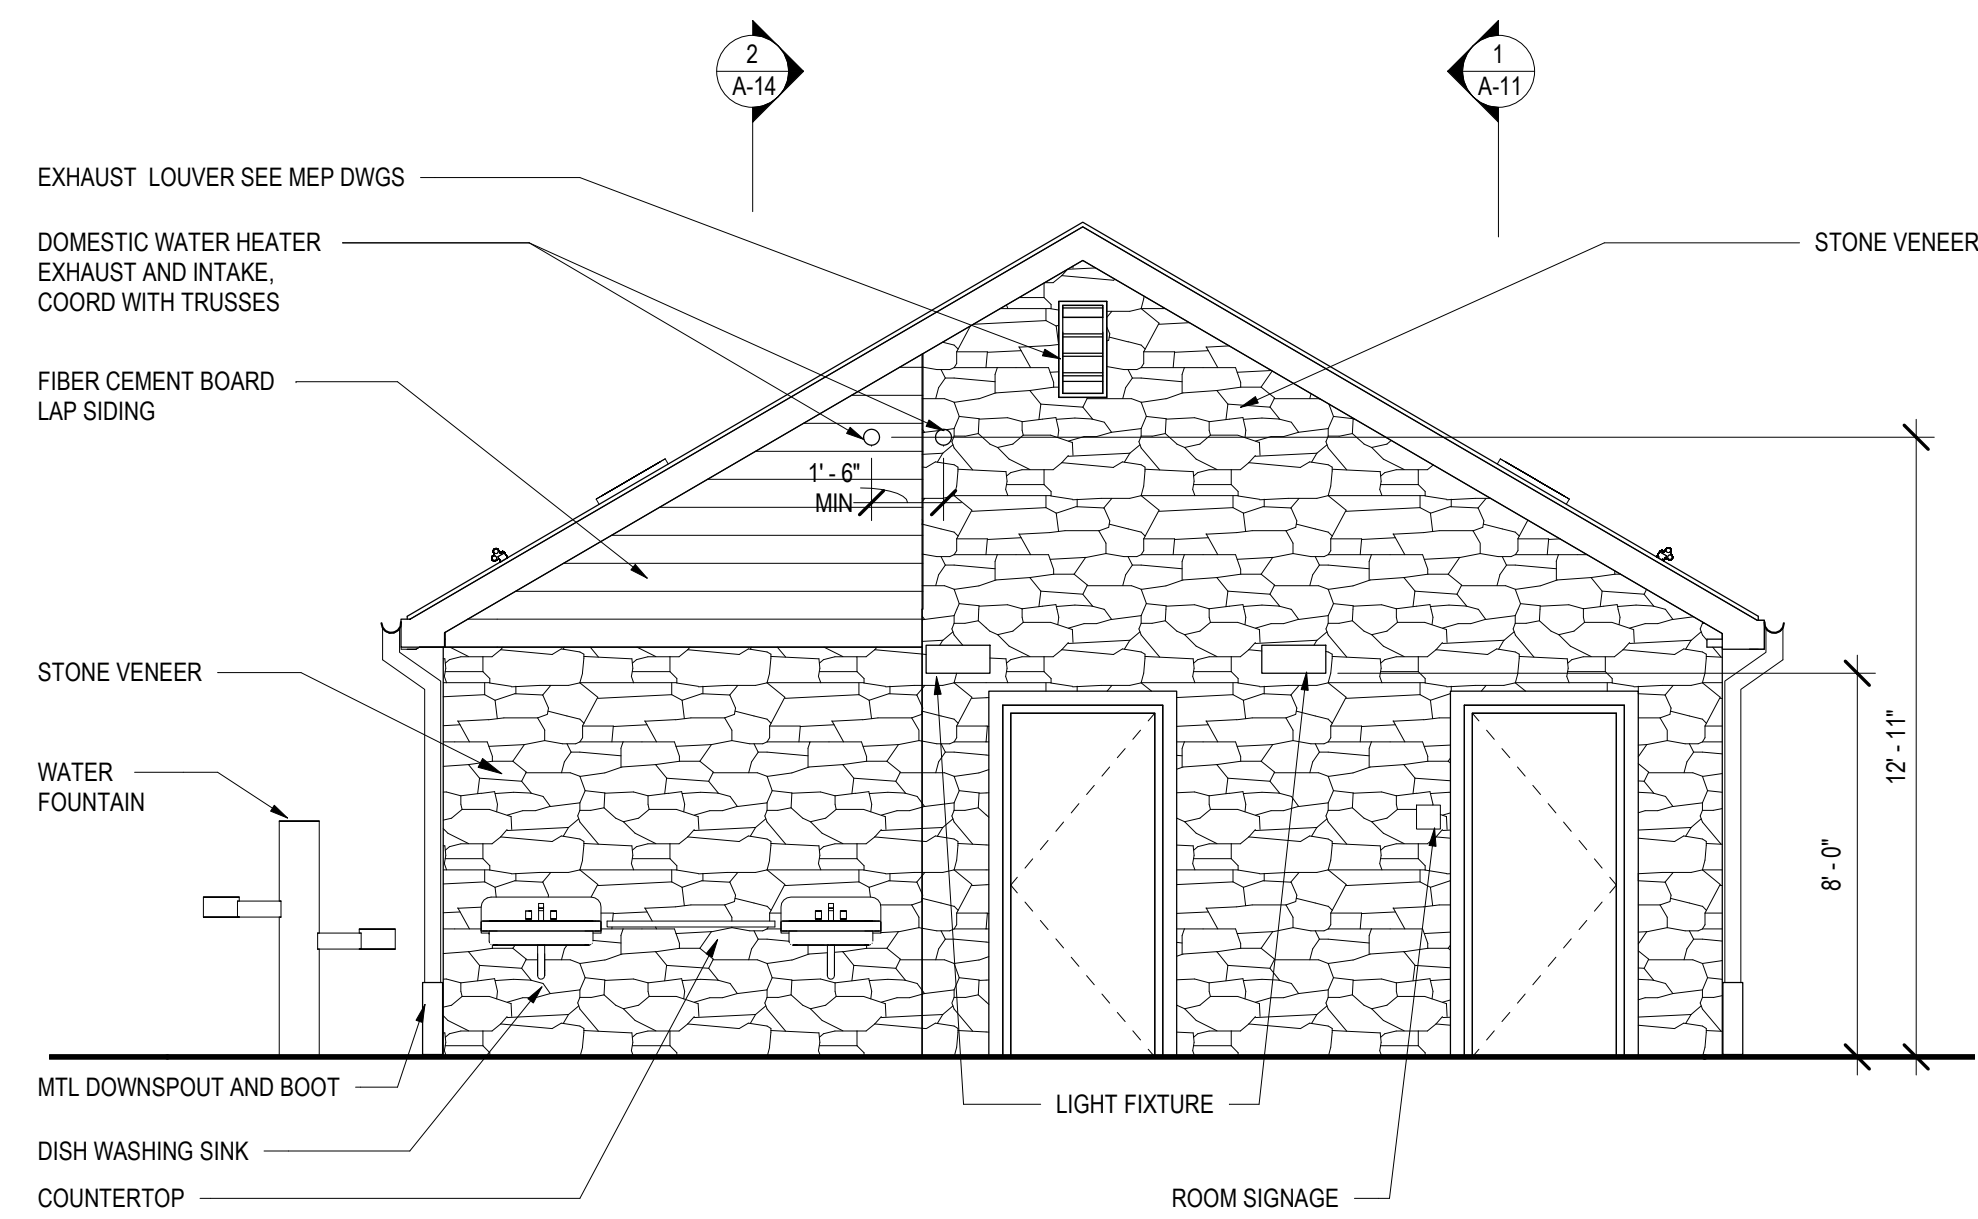


4 WEST ELEVATION
A-10 1/4" = 1'-0"

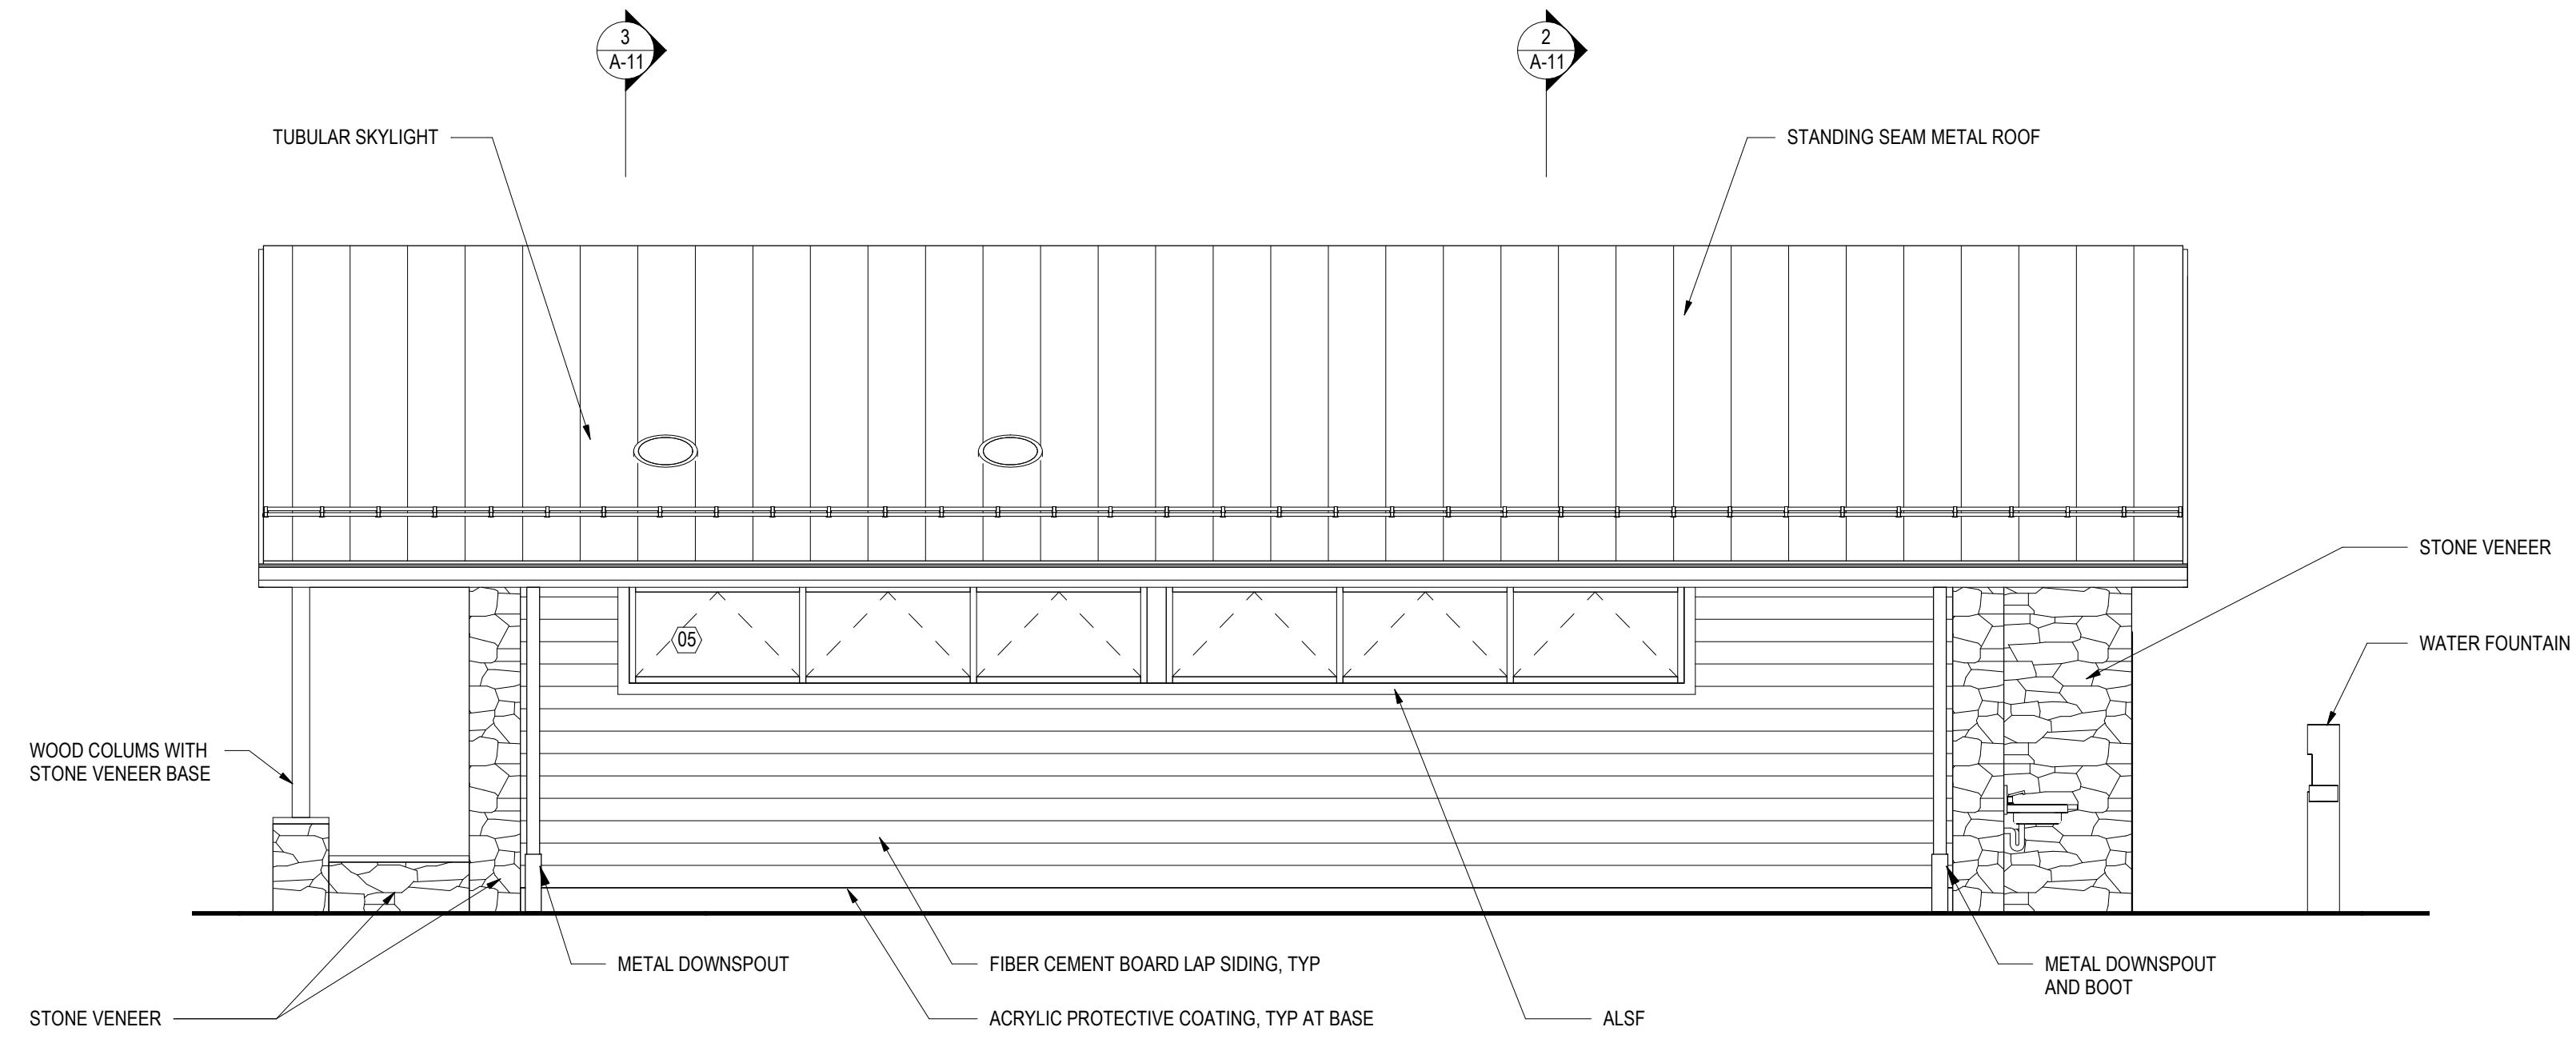

3 NORTH ELEVATION
A-10 1/4" = 1'-0"

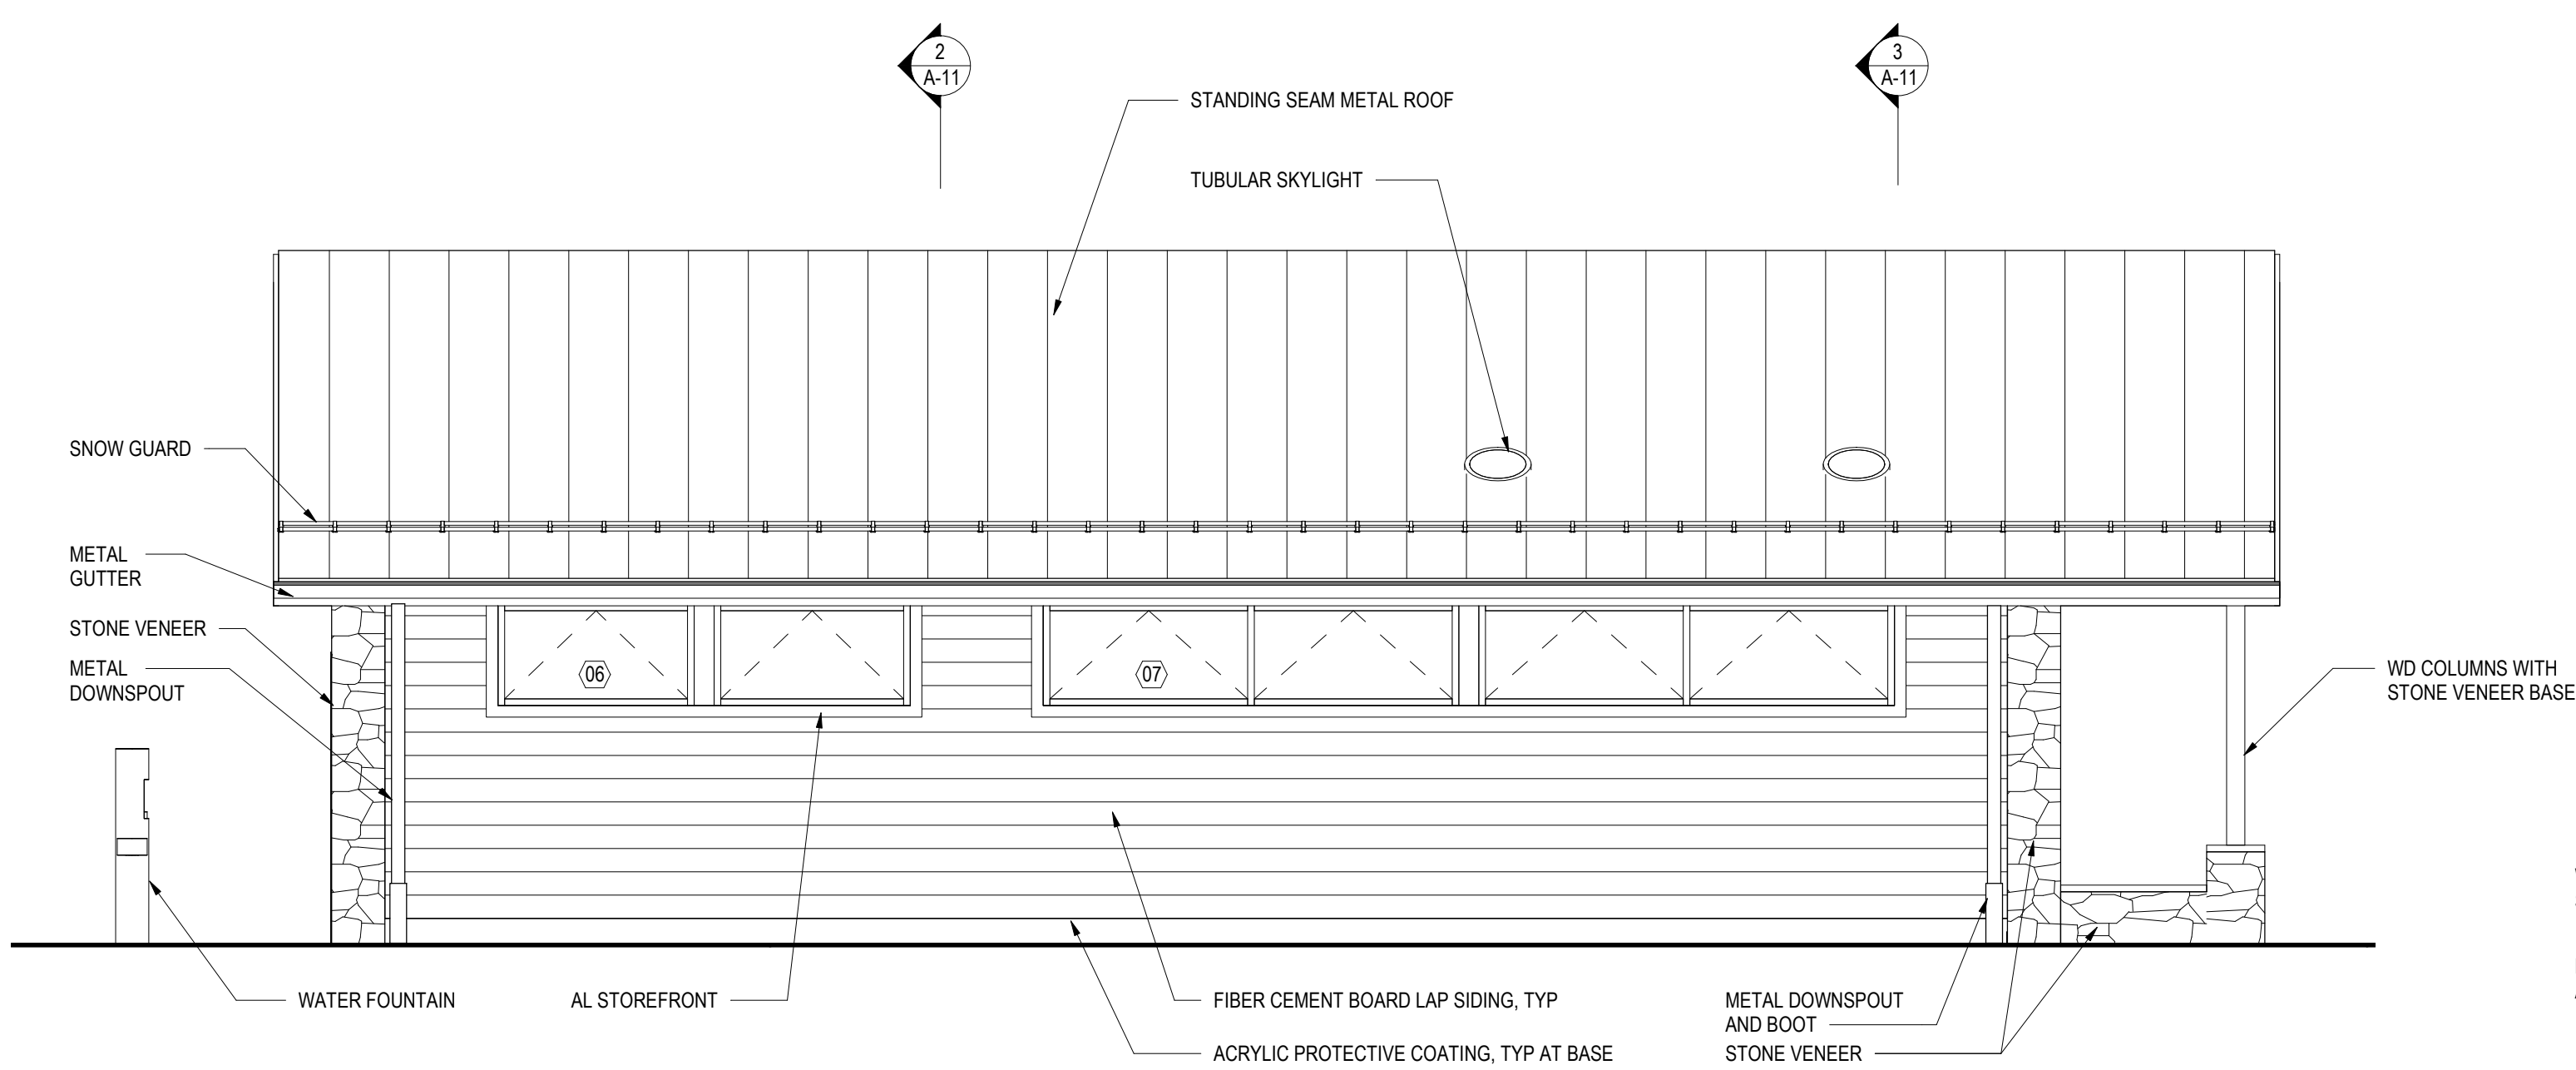

2 SOUTH ELEVATION
A-10 1/4" = 1'-0"

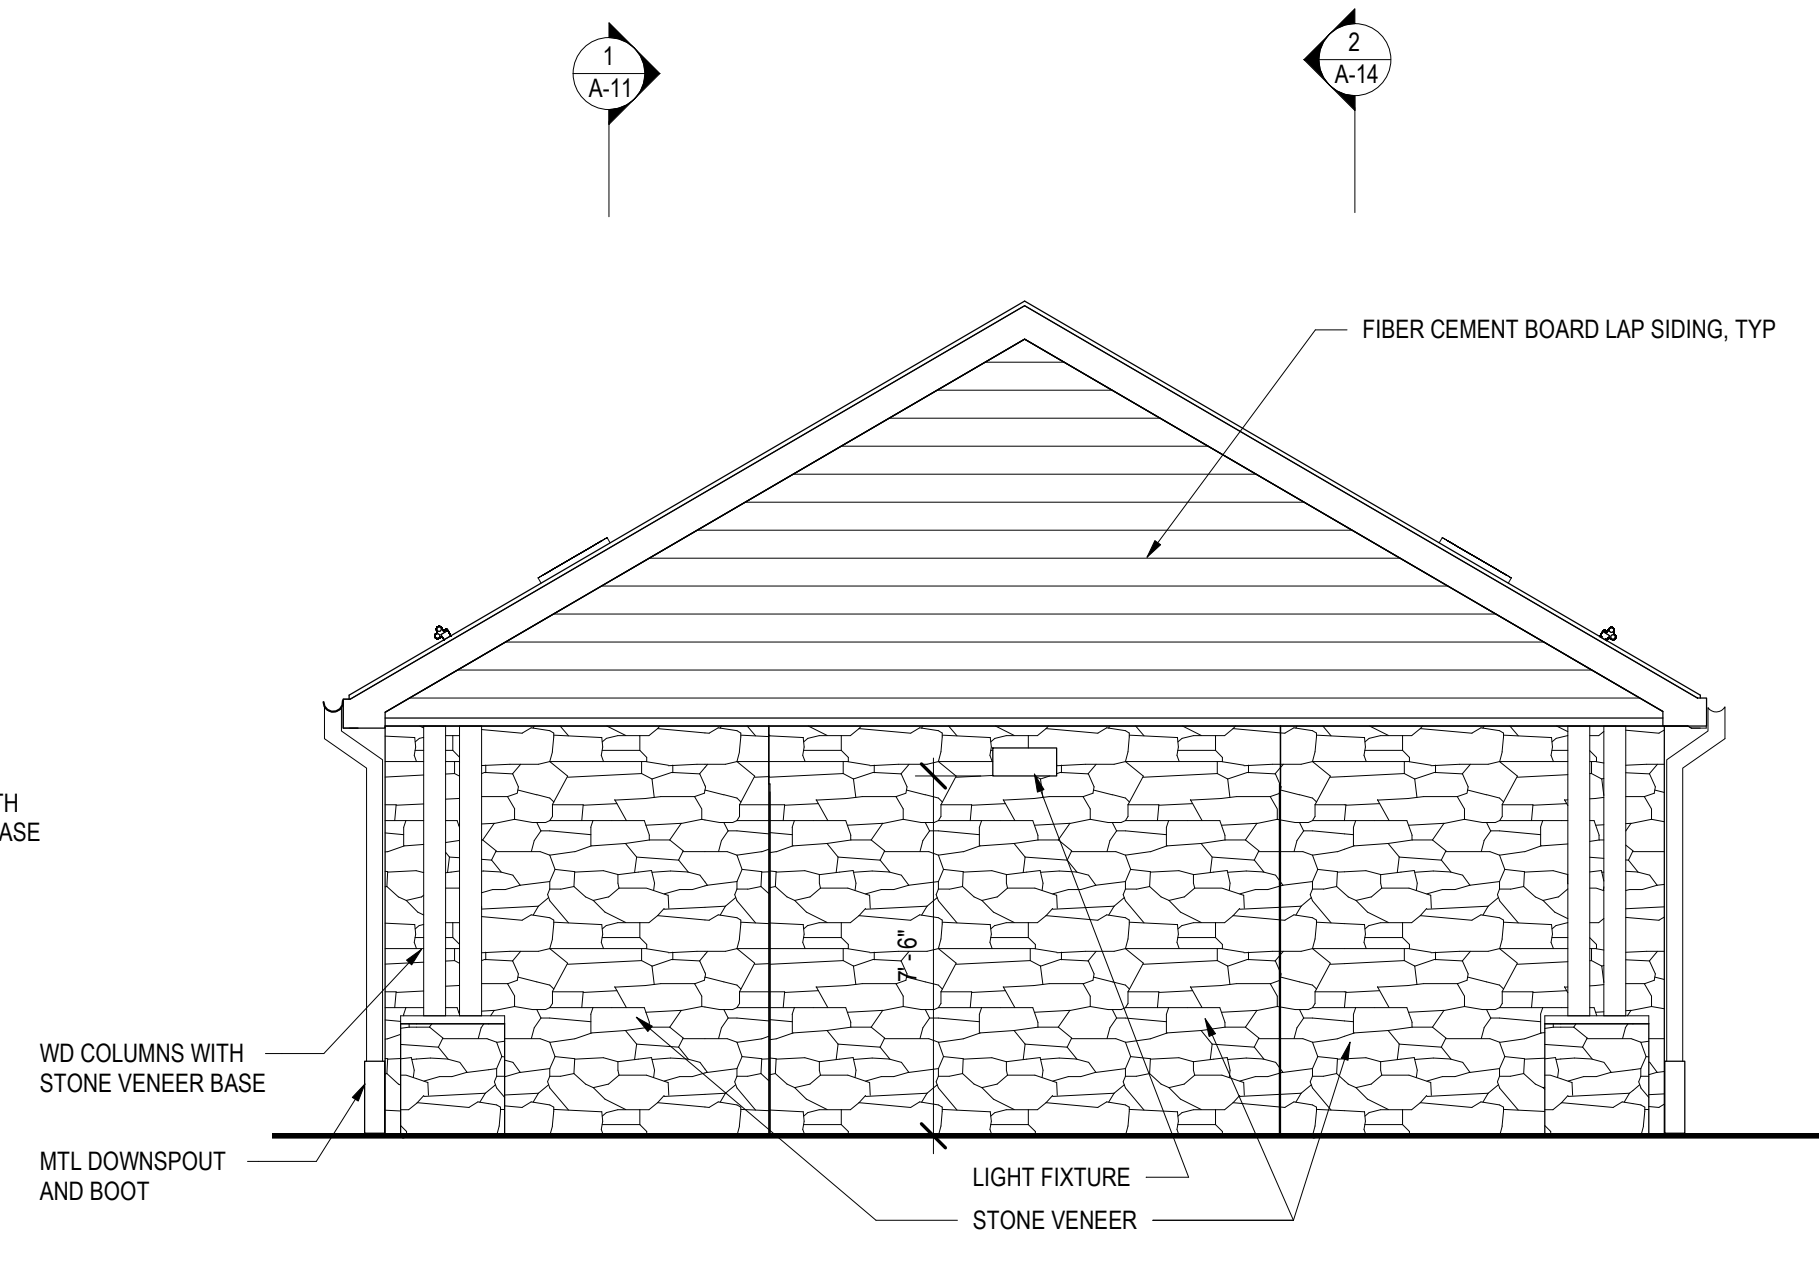

1 EAST ELEVATION
A-10 1/4" = 1'-0"

CONSTRUCTION DOCUMENTS

RECORD REVISIONS



SIGNATURE DATE 03/05/2021

SMP ARCHITECTS
1600 WALNUT STREET, SECOND FLOOR
PHILADELPHIA, PENNSYLVANIA

COMMONWEALTH OF PENNSYLVANIA
DEPARTMENT OF GENERAL SERVICES
HARRISBURG, PENNSYLVANIA

D.G.S. PROJECT No. C-114-0006 PHASE 1

HICKORY RUN STATE PARK
LATRINE IMPROVEMENTS
DEPT of CONSERVATION AND NATURAL RESOURCES
WHITE HAVEN, CARBON COUNTY, PA


ORGANIZED GROUP TENT CAMPING -
EXTERIOR ELEVATIONS

VERIFY SCALE
BAR IS ONE (1) INCH LONG
ON ORIGINAL DRAWING: 0 1
IF BAR IS NOT ONE (1) INCH LONG, ADJUST SCALE ACCORDINGLY
CONTRACTOR SHALL FIELD VERIFY ALL DIMENSIONS. VARIANCE FROM CONTRACT DOCUMENTS NOT PERMITTED WITHOUT PROFESSIONAL & BUREAU OF CONSTRUCTION APPROVAL.


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CHECKED BY T WOODWARD
DATE 06/17/2022
SCALE AS NOTED

DRAWING No. A-10
64 OF 144


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LAST SAVED: 2020/06/04 12:14 PM PLOTTED: 2018/11/08 10:35 AM

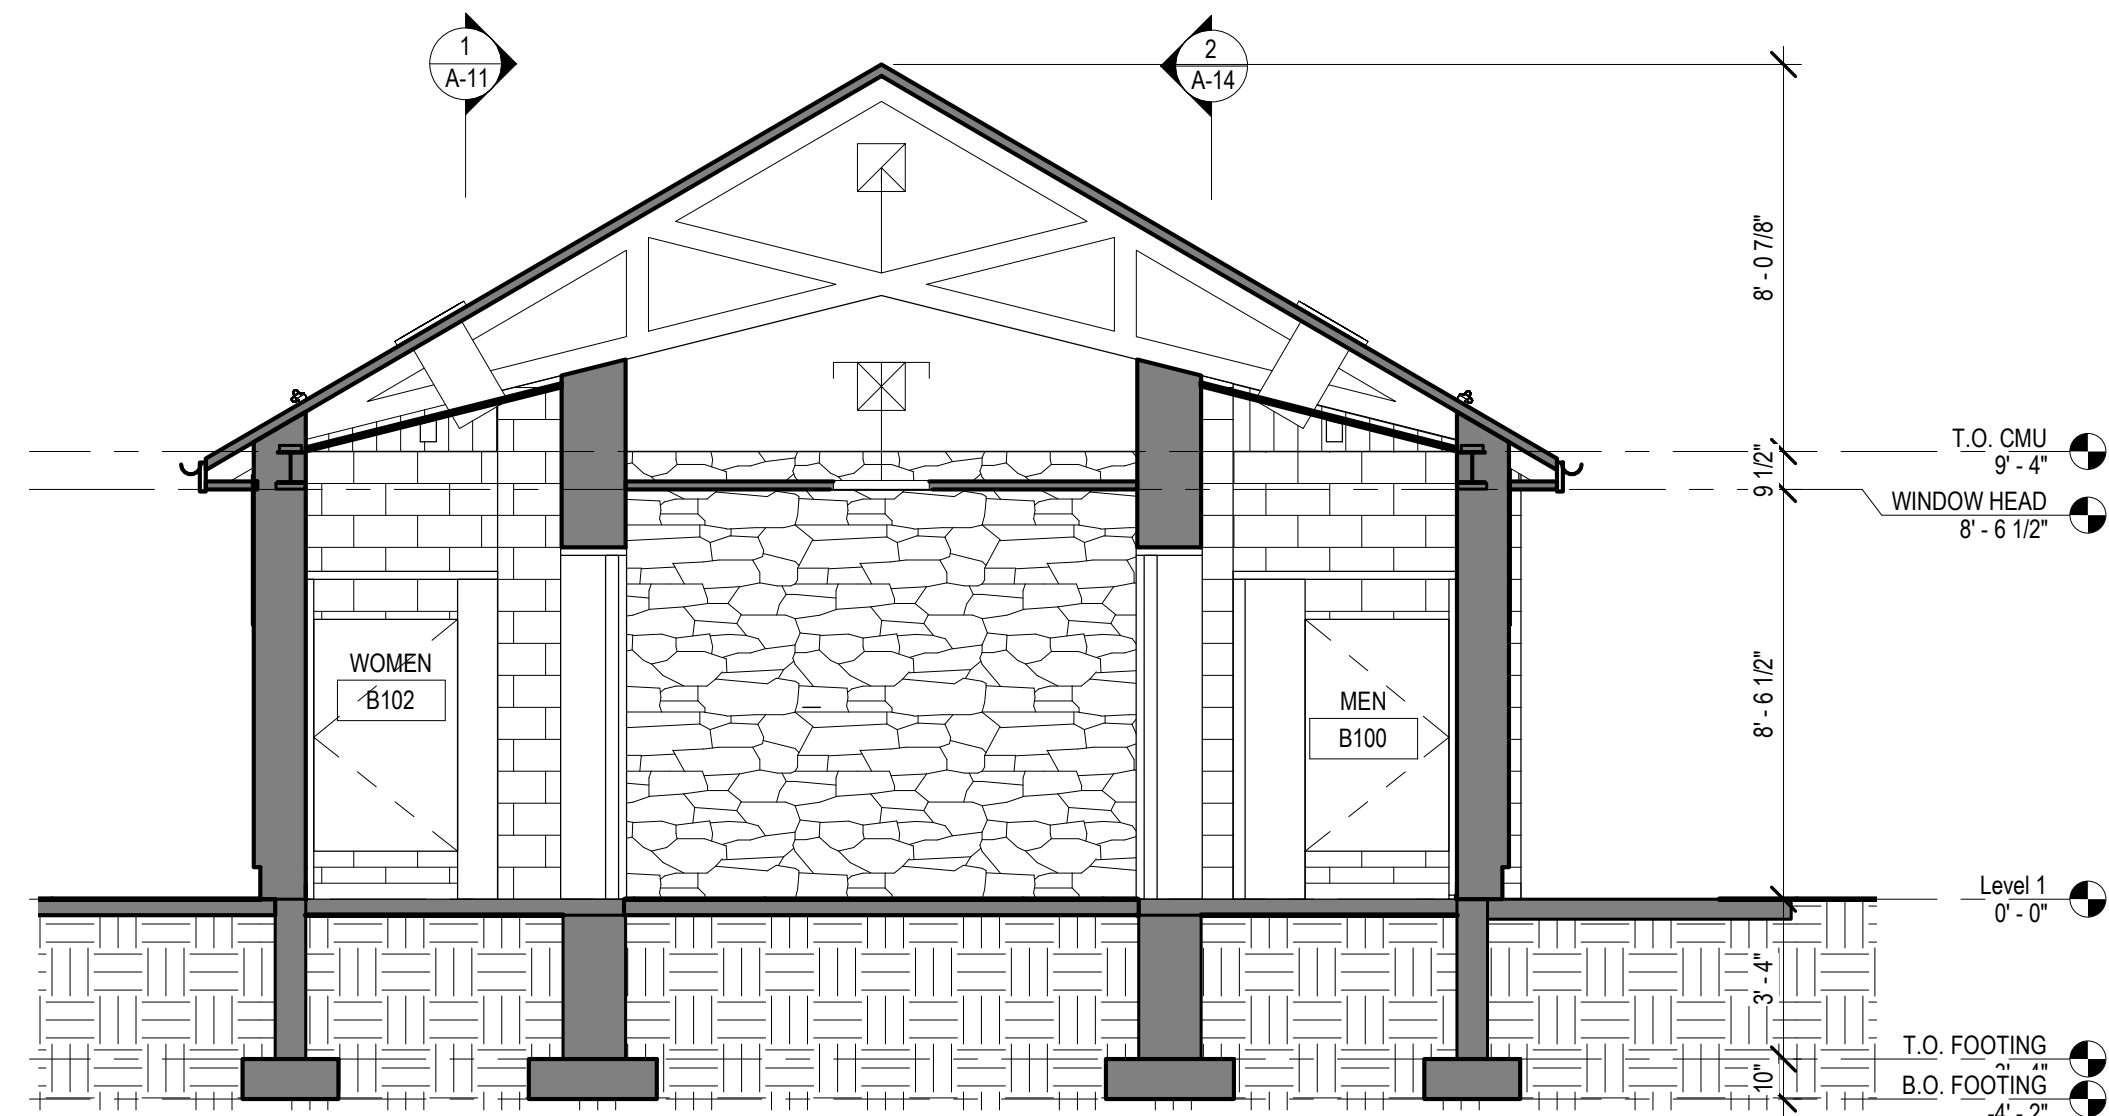

3 CROSS SECTION 2
A-11 1/4" = 1'-0"

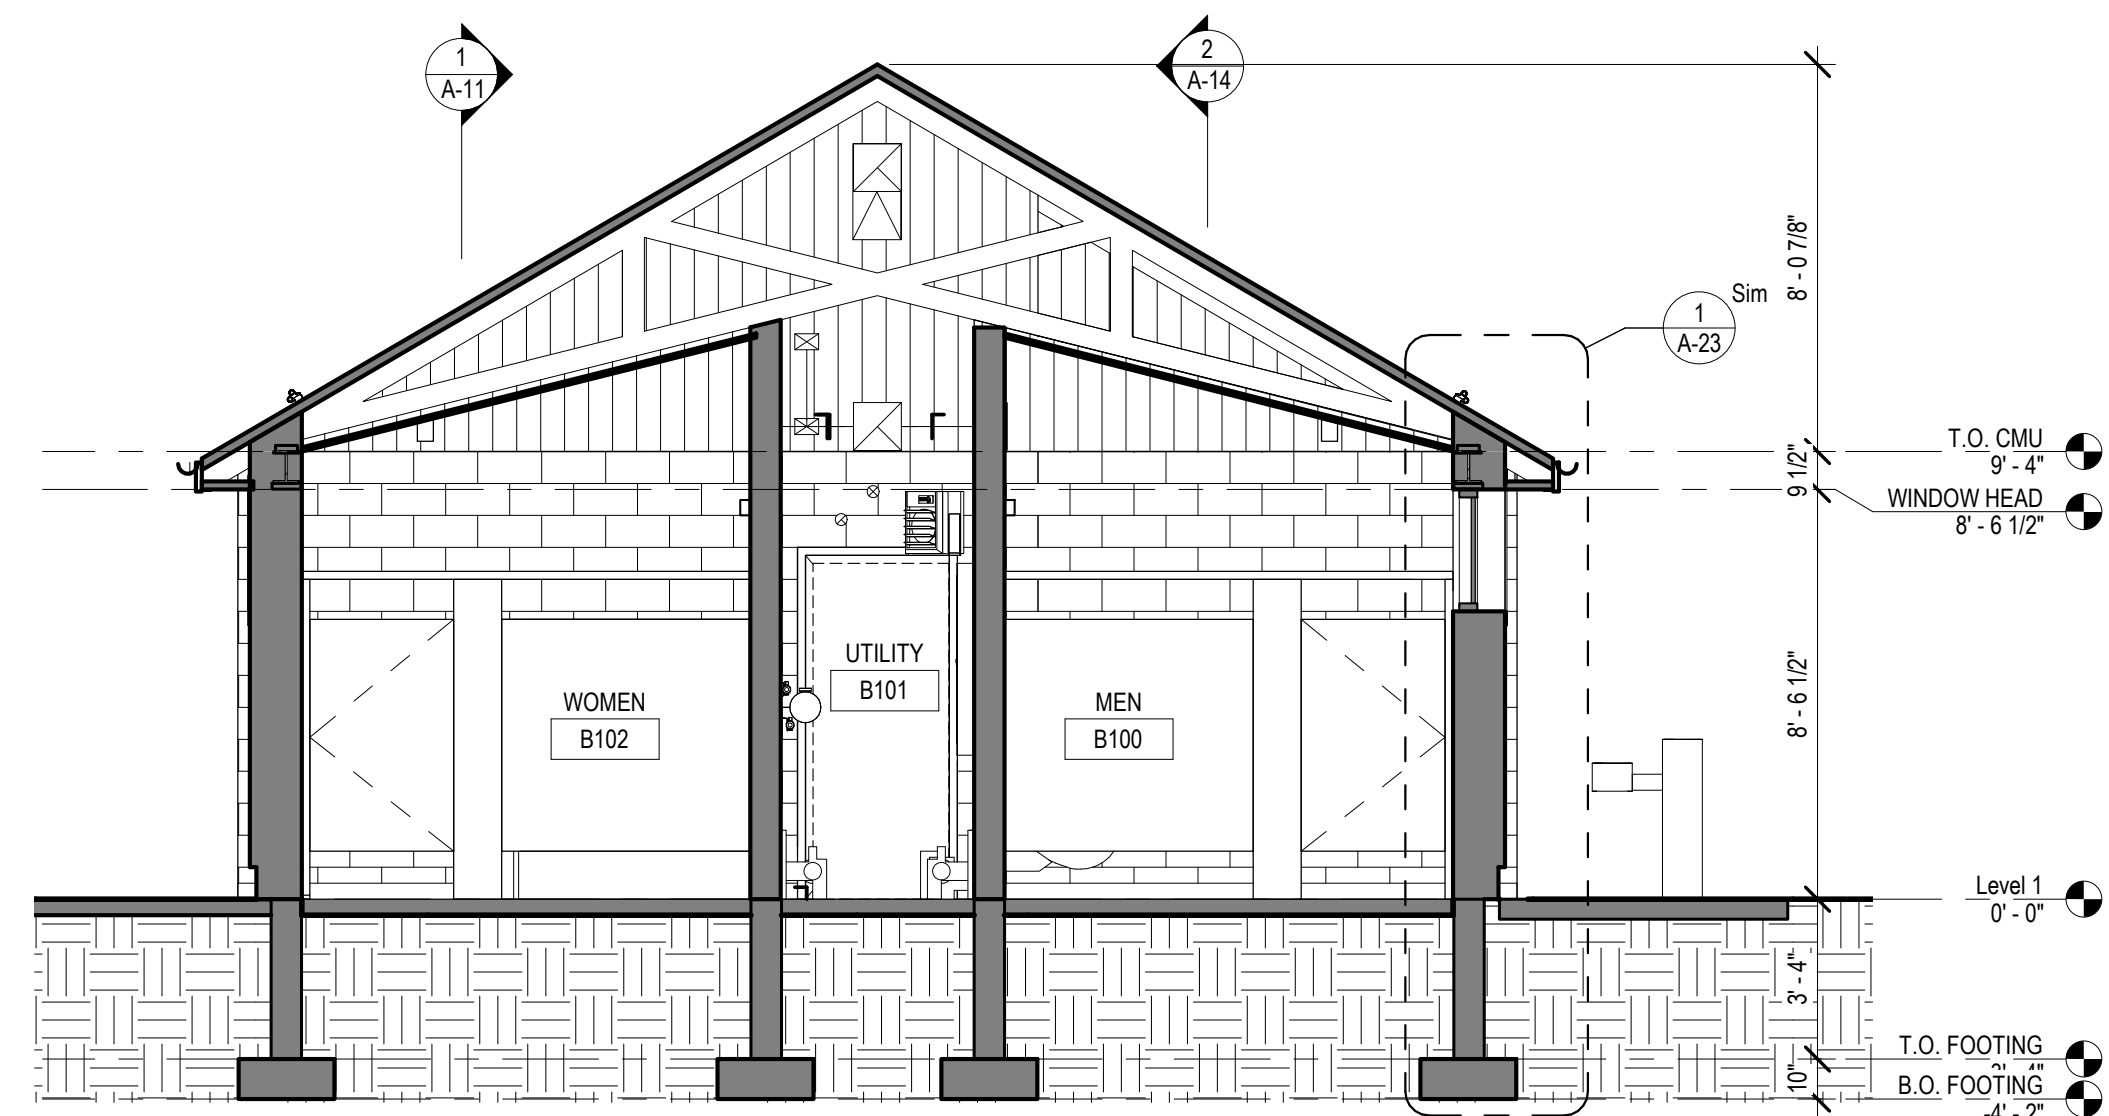

2 CROSS SECTION 1
A-11 1/4" = 1'-0"

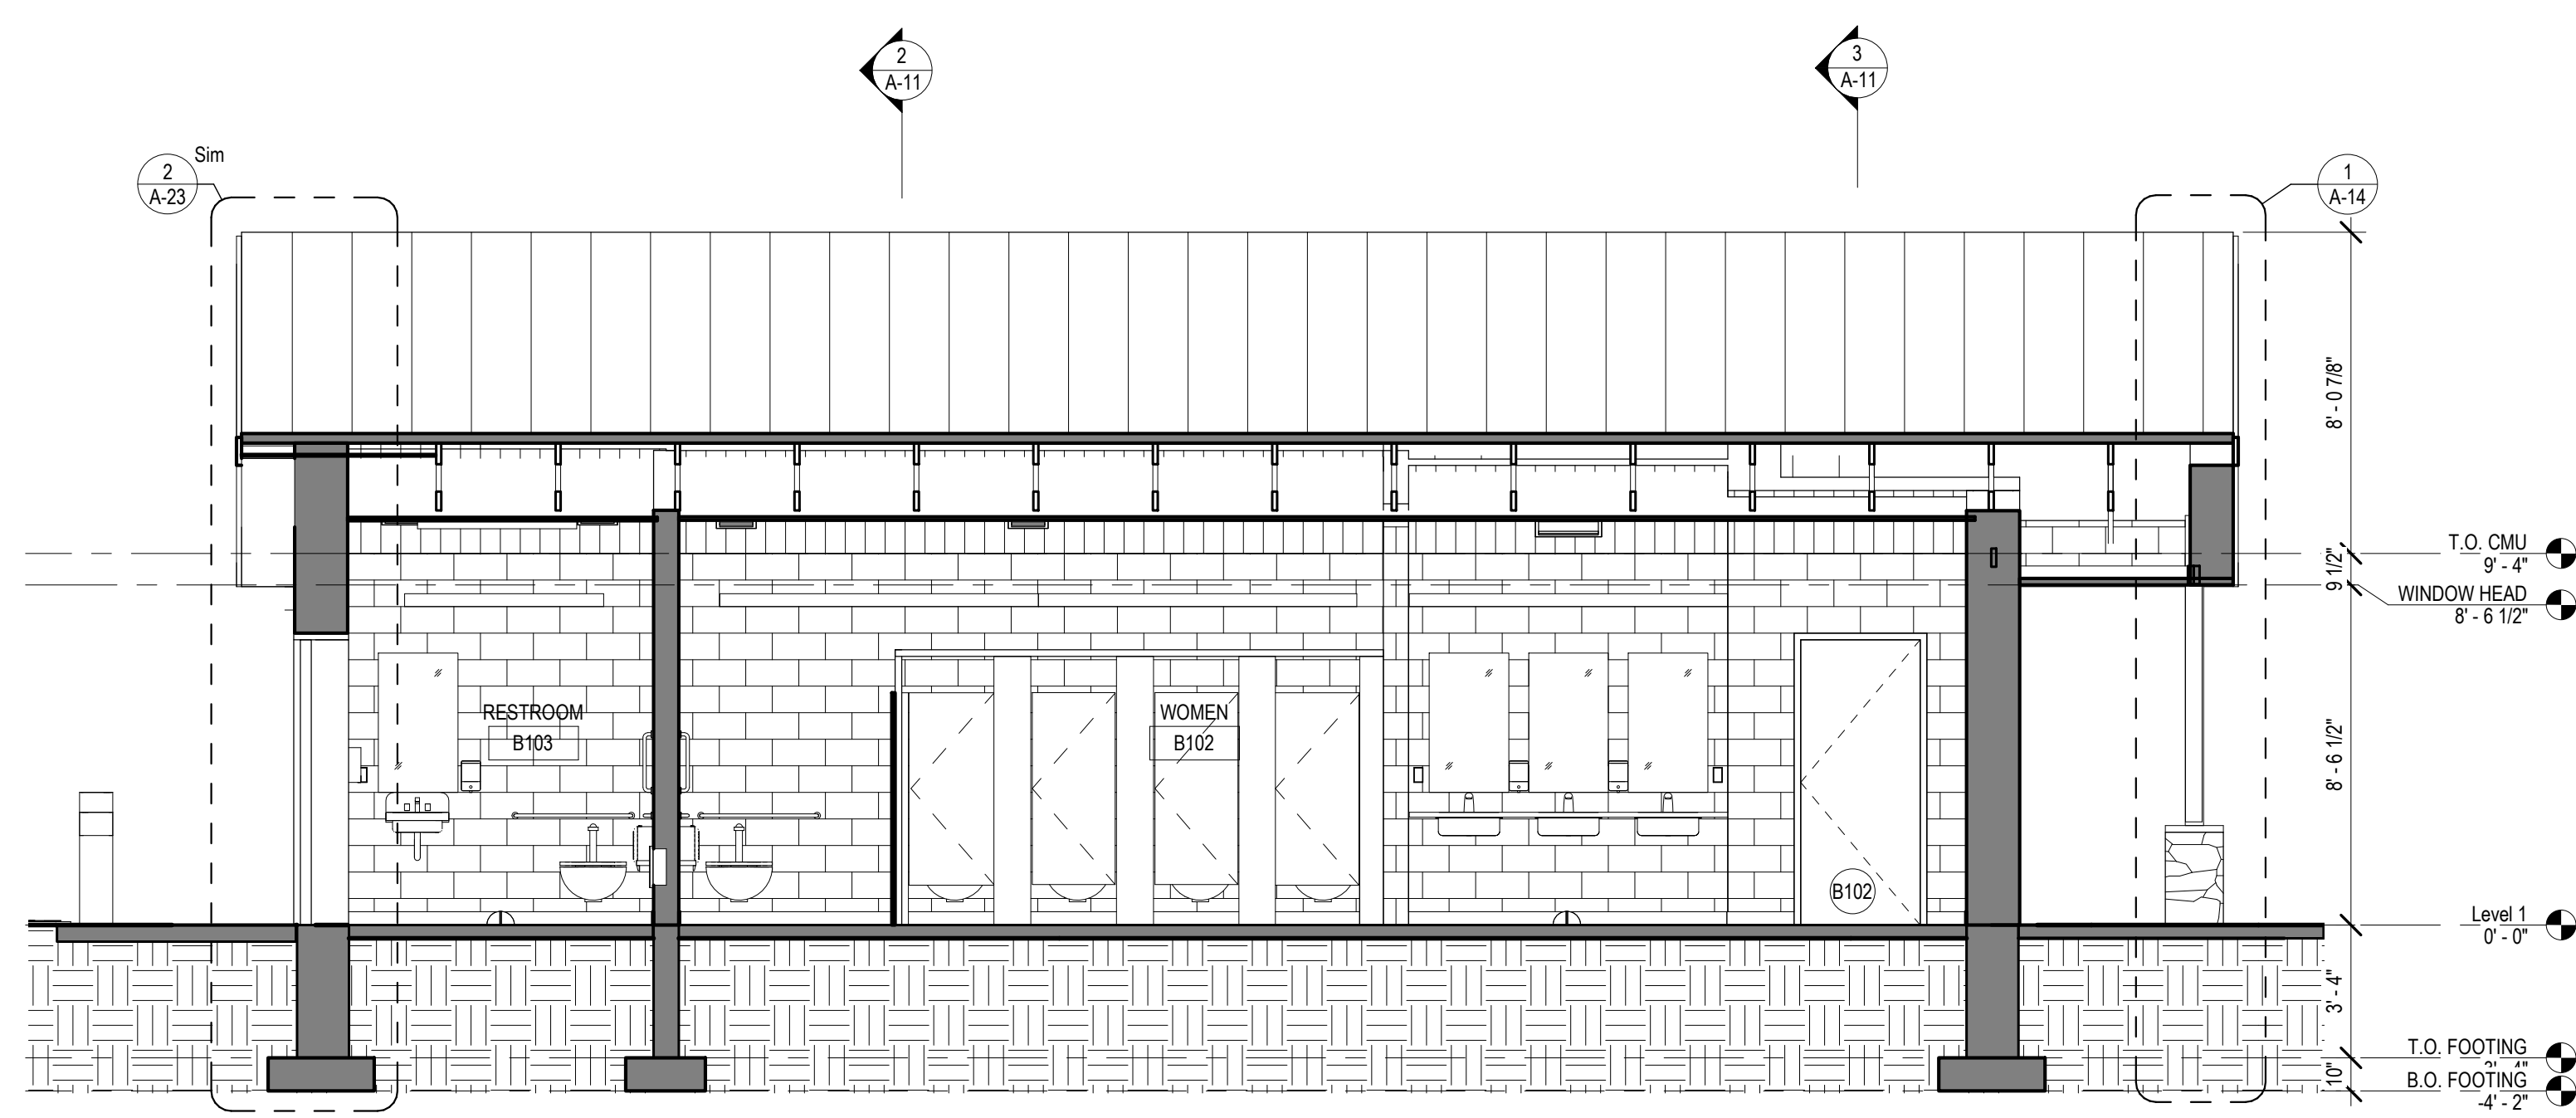

1 LONGITUDINAL SECTION
A-11 1/4" = 1'-0"

CONSTRUCTION DOCUMENTS

RECORD REVISIONS



SIGNATURE DATE 03/05/2021

SMP ARCHITECTS
1600 WALNUT STREET, SECOND FLOOR
PHILADELPHIA, PENNSYLVANIA

COMMONWEALTH OF PENNSYLVANIA
DEPARTMENT OF GENERAL SERVICES
HARRISBURG, PENNSYLVANIA

D.G.S. PROJECT No. C-114-0006 PHASE 1

HICKORY RUN STATE PARK
LATRINE IMPROVEMENTS

DEPT of CONSERVATION AND NATURAL RESOURCES
WHITE HAVEN, CARBON COUNTY, PA


ORGANIZED GROUP TENT CAMPING -
BUILDING SECTIONS

VERIFY SCALE
BAR IS ONE (1) INCH LONG
ON ORIGINAL DRAWING: 0
IF BAR IS NOT ONE (1) INCH LONG, ADJUST SCALE ACCORDINGLY
CONTRACTOR SHALL FIELD VERIFY ALL DIMENSIONS. VARIANCE FROM CONTRACT DOCUMENTS NOT PERMITTED WITHOUT PROFESSIONAL & BUREAU OF CONSTRUCTION APPROVAL.


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CHECKED BY T WOODWARD
DATE 06/17/2022
SCALE AS NOTED

DRAWING No. A-11
65 OF 144


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LAST SAVER: 2020.06.04 12:14 PM PLOTTED BY: Megan M. Strenski

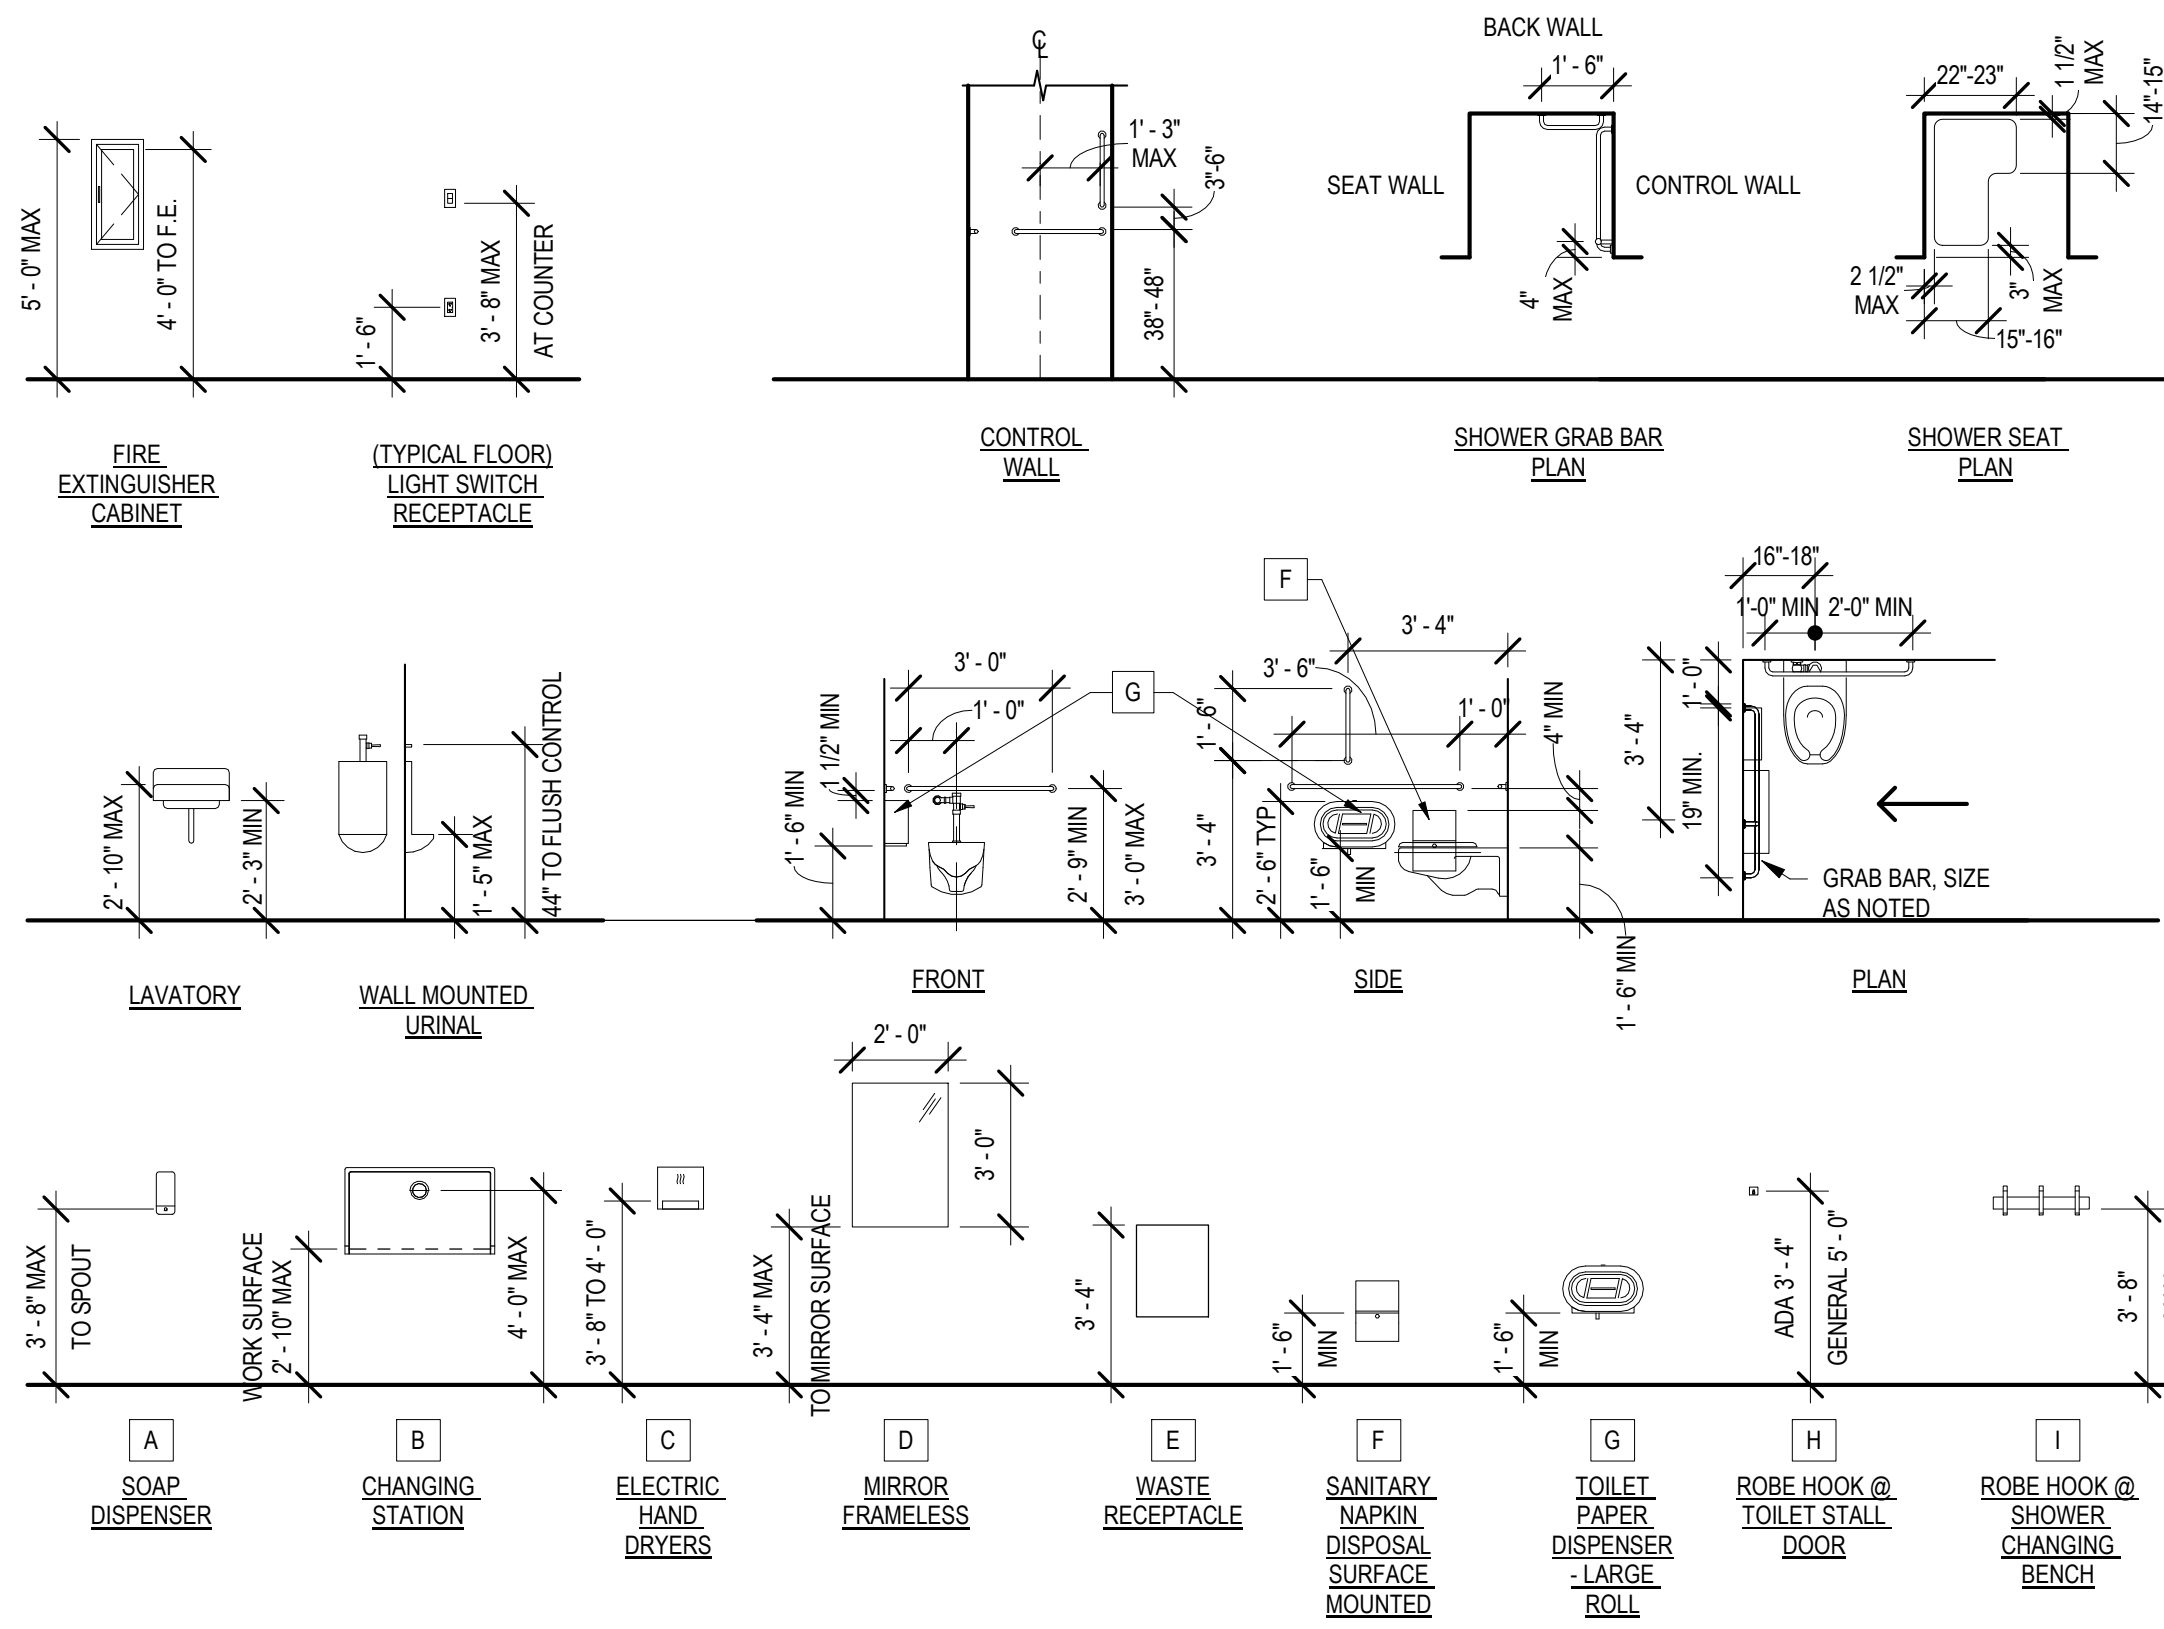


2C INTERIOR ELEVATIONS - WOMEN B102
A-12 1/4" = 1'-0"

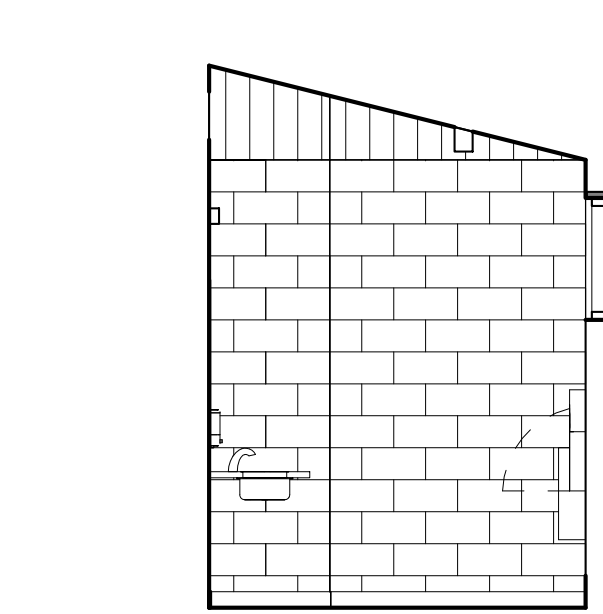


2A

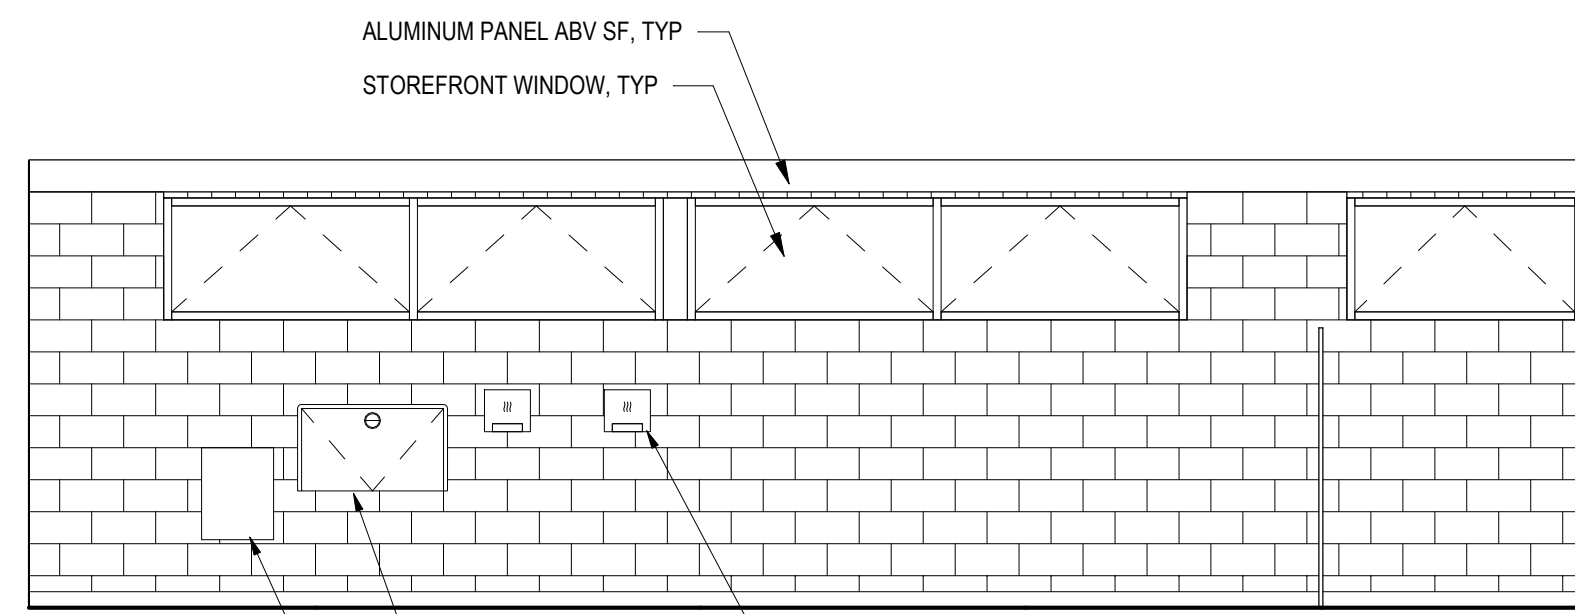


2B

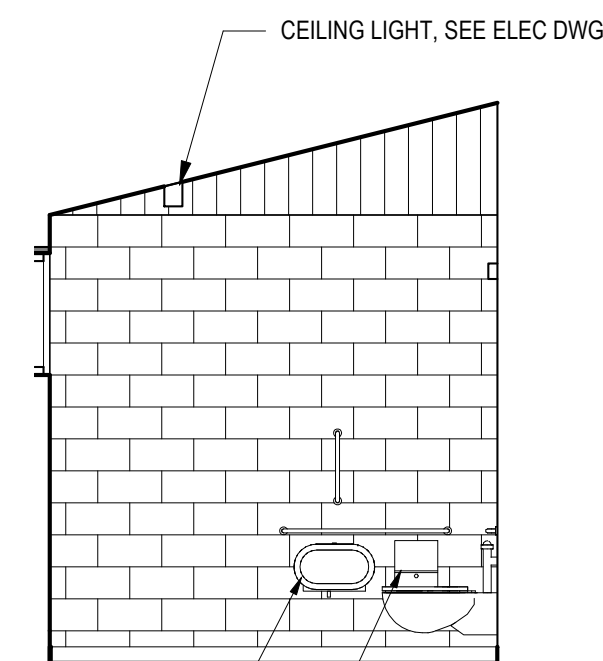


2C

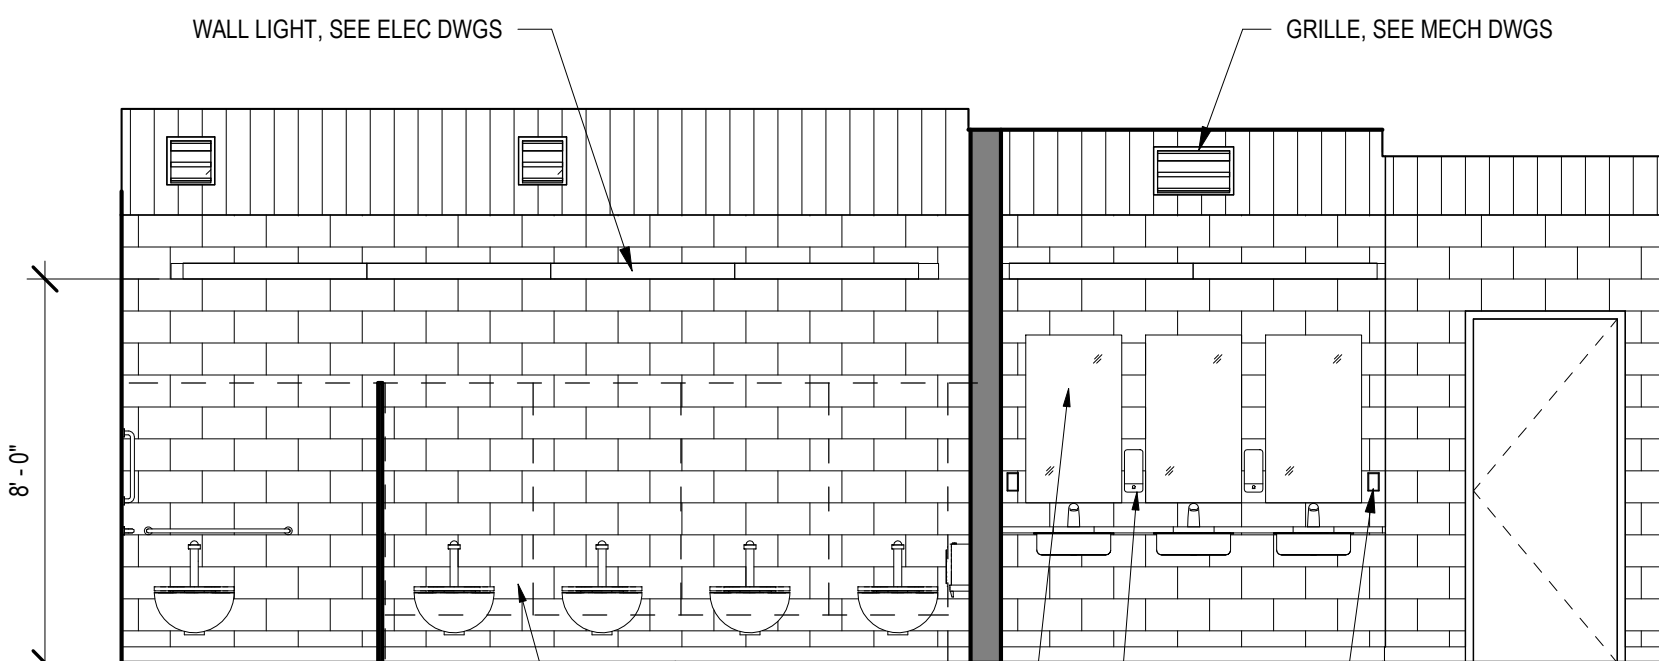

2D

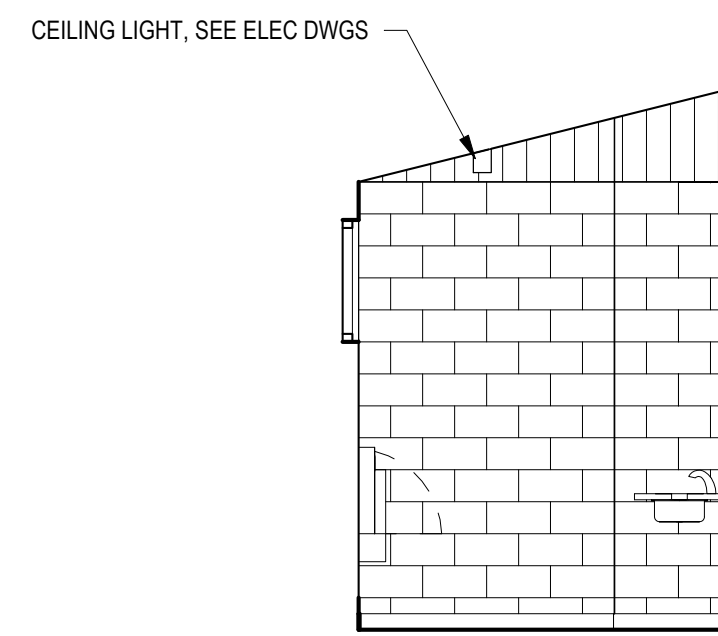


1A

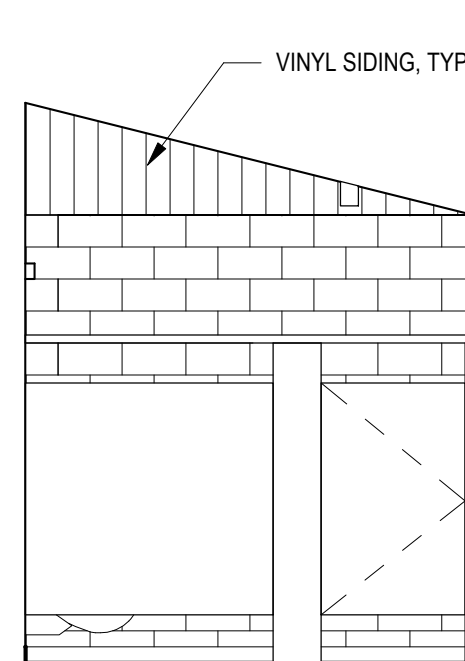


1C



1C INTERIOR ELEVATIONS - MEN B100
A-12 1/4" = 1'-0"

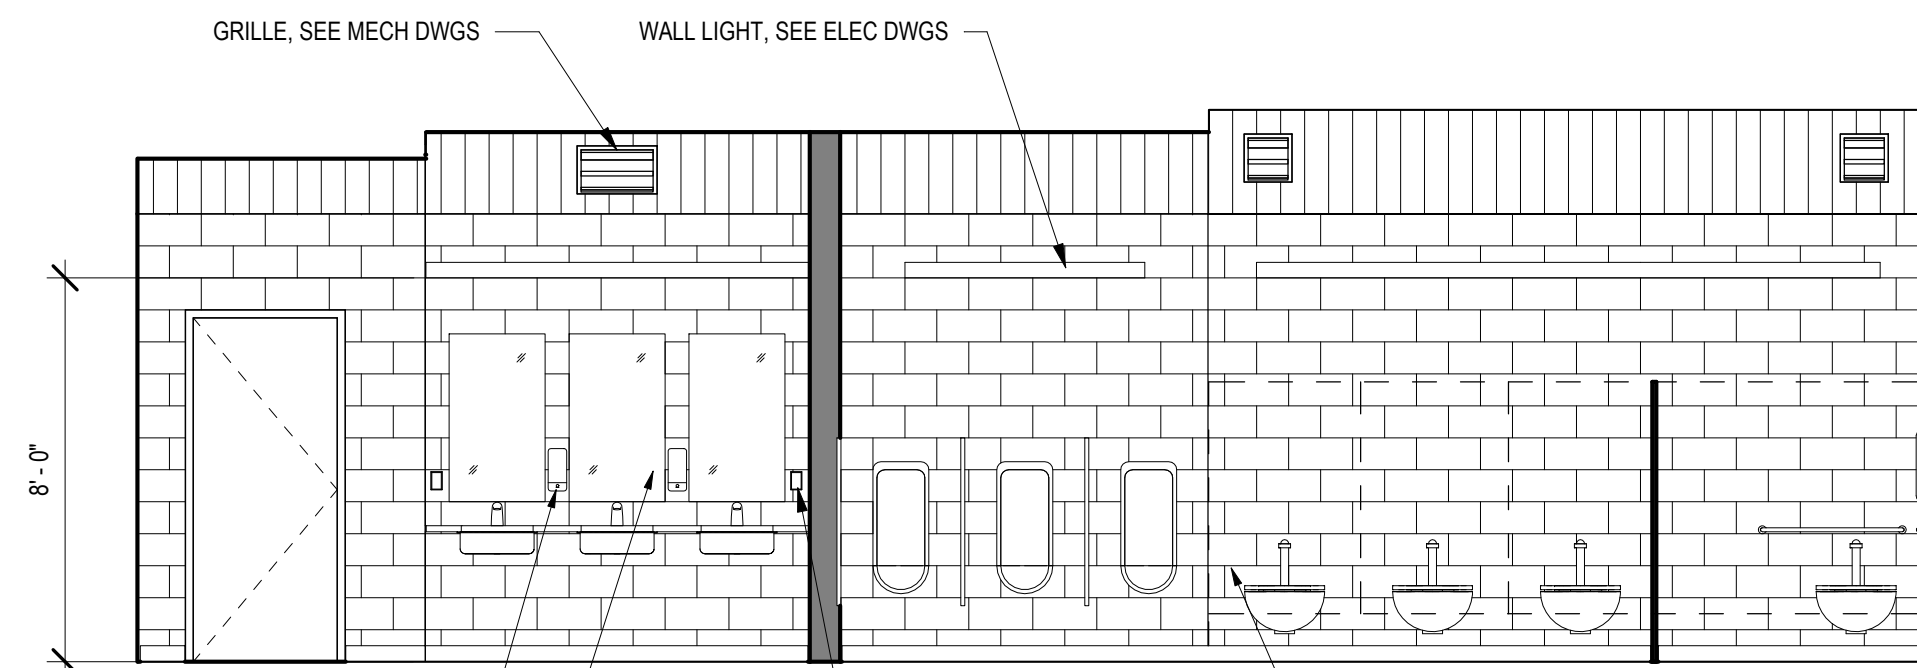

1B

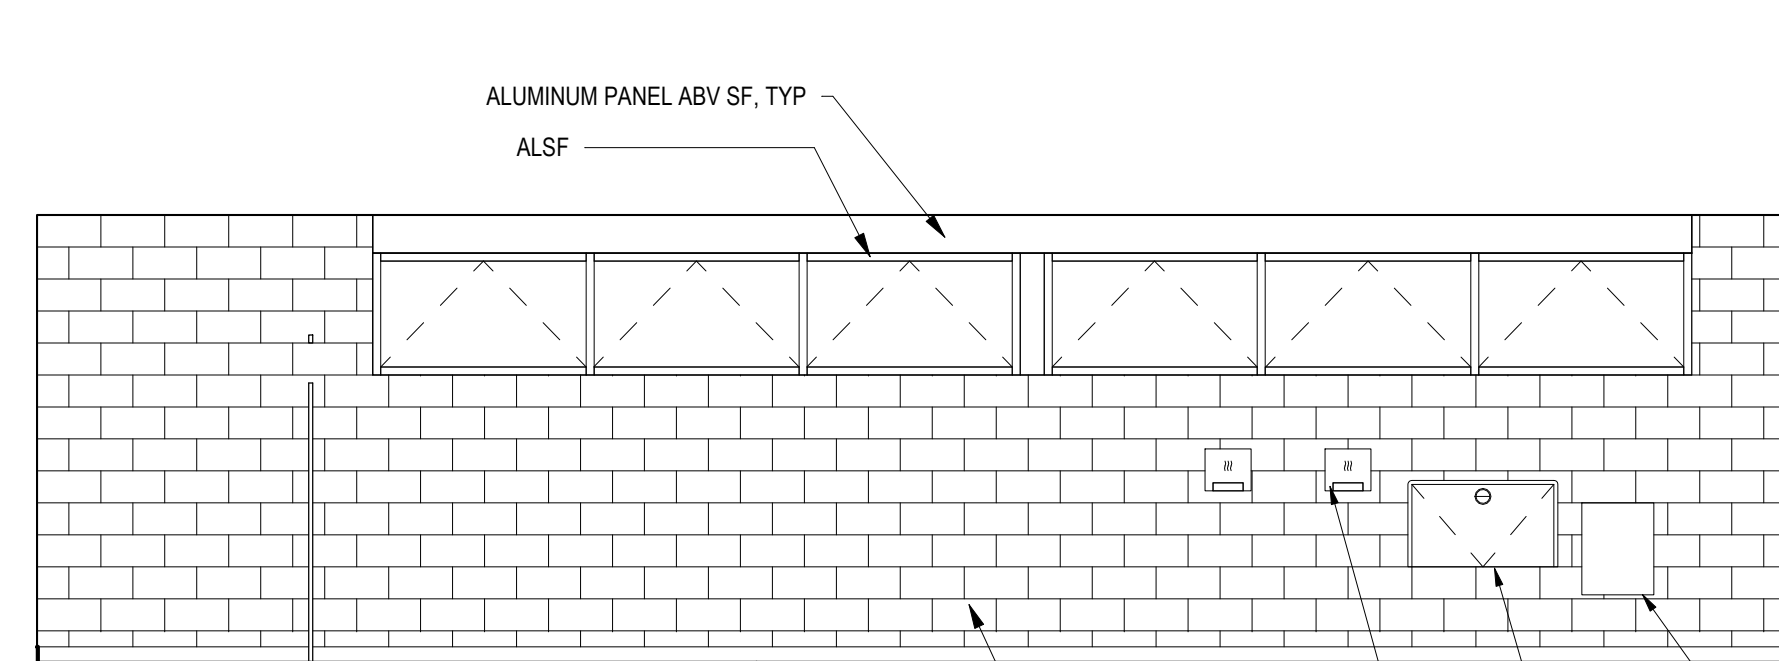


1D

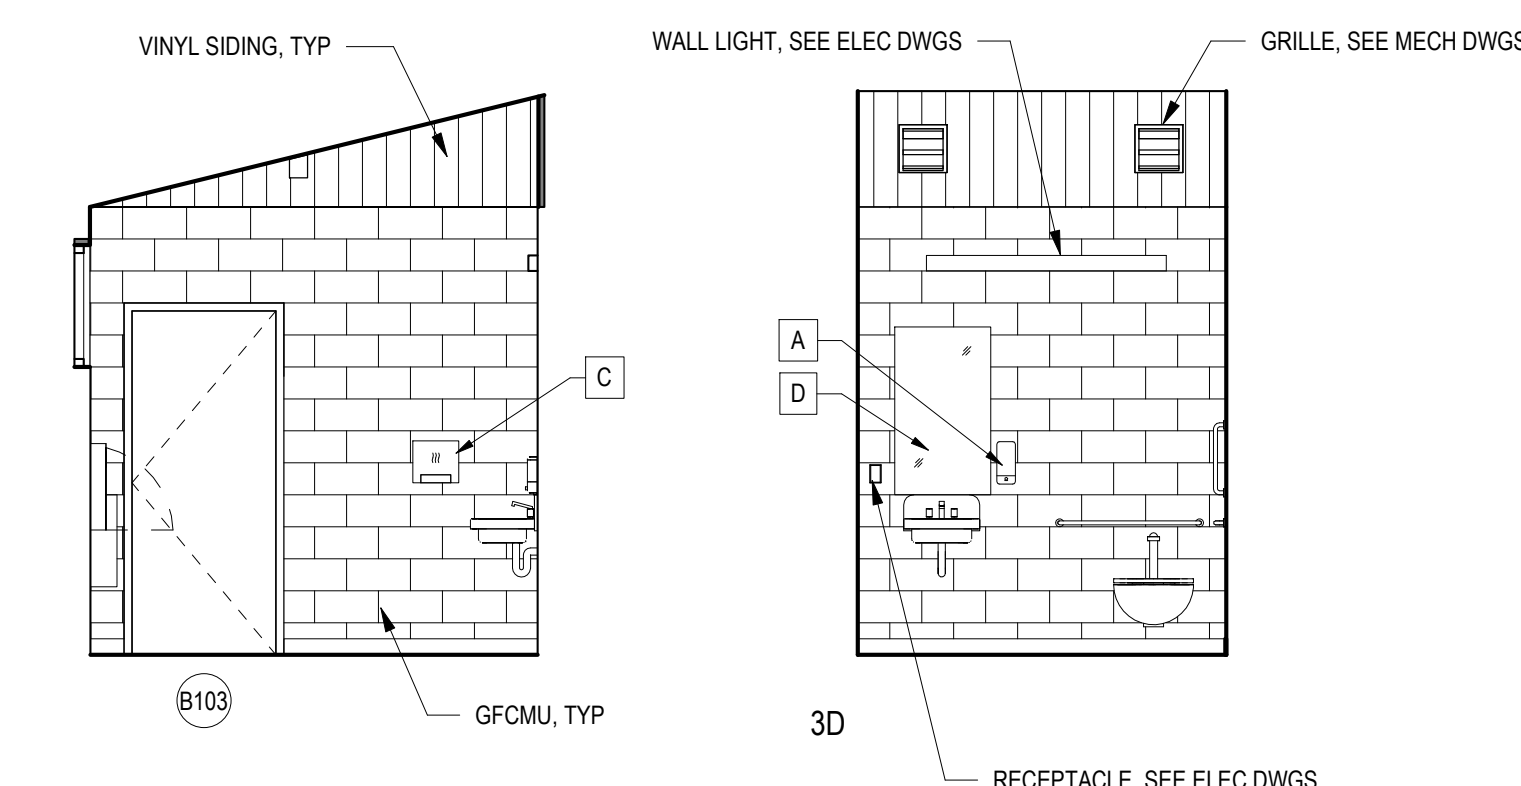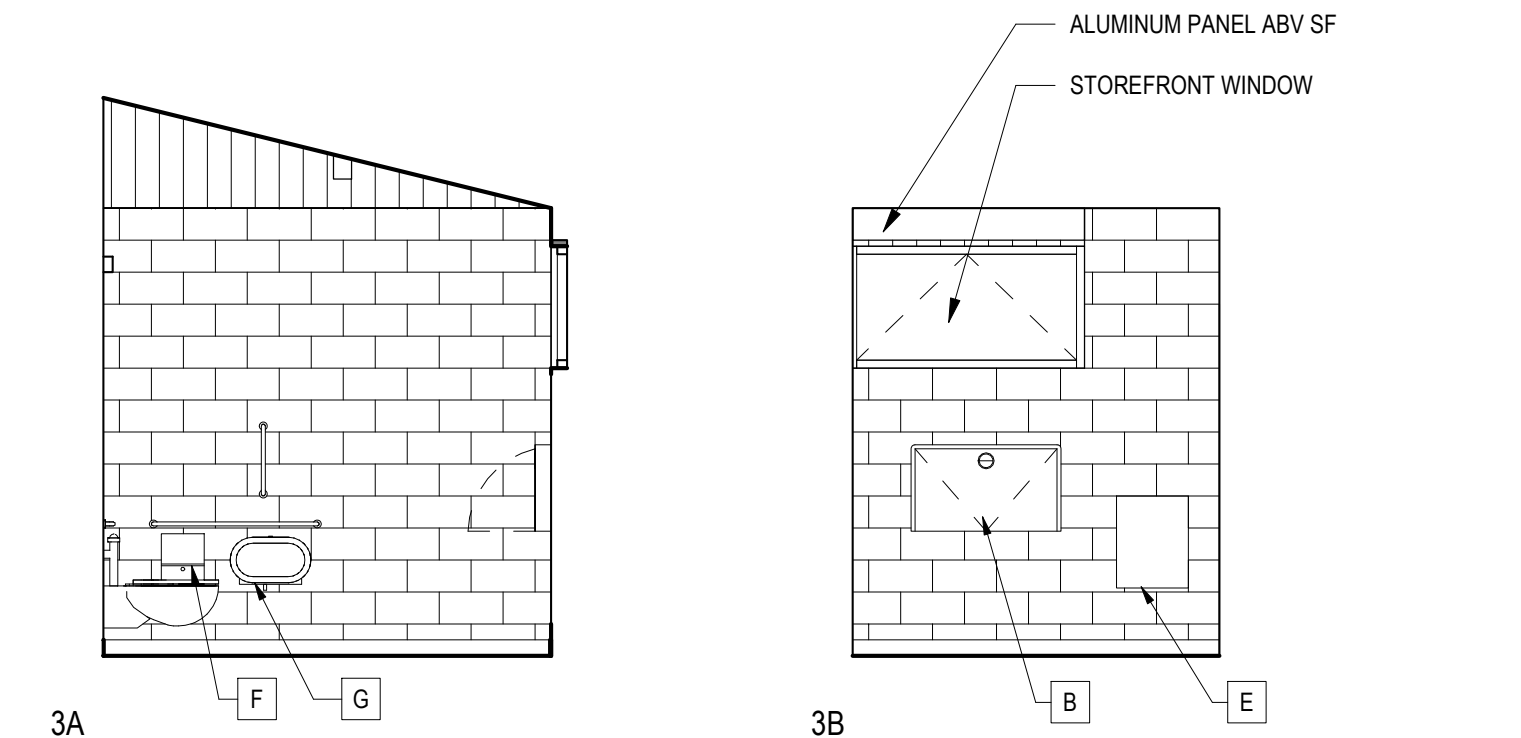

3C INTERIOR ELEVATIONS - RESTROOM B103
A-12 1/4" = 1'-0"

CONSTRUCTION DOCUMENTS

RECORD REVISIONS

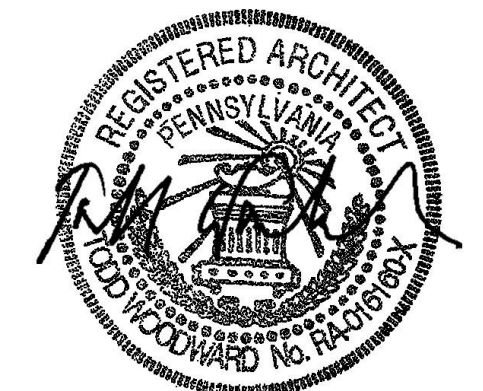

SIGNATURE DATE 03/05/2021

SMP ARCHITECTS
1600 WALNUT STREET, SECOND FLOOR
PHILADELPHIA, PENNSYLVANIA

COMMONWEALTH OF PENNSYLVANIA
DEPARTMENT OF GENERAL SERVICES
HARRISBURG, PENNSYLVANIA

D.G.S. PROJECT No. C-114-0006 PHASE 1

HICKORY RUN STATE PARK
LATRINE IMPROVEMENTS
DEPT of CONSERVATION AND NATURAL RESOURCES
WHITE HAVEN, CARBON COUNTY, PA

ORGANIZED GROUP TENT CAMPING - INTERIOR ELEVATIONS





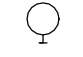
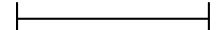





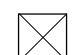
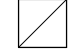
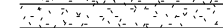

VERIFY SCALE
BAR IS ONE (1) INCH LONG
ON ORIGINAL DRAWING: 1
IF BAR IS NOT ONE (1) INCH LONG, ADJUST SCALE ACCORDINGLY
CONTRACTOR SHALL FIELD VERIFY ALL DIMENSIONS
VARIANCE FROM CONTRACT DOCUMENTS NOT PERMITTED WITHOUT PROFESSIONAL & BUREAU OF CONSTRUCTION APPROVAL.


DRAWN BY M STRENSKI
CHECKED BY T WOODWARD
DATE 06/17/2022
SCALE AS NOTED

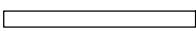DRAWING No. A-12

FILE PATH: I:\723_Hickory Run\A-12_Arch\Drawings\01-Rev\Hickory Run State Park Latrine Improvements - Interiors.dwg
PLOTTER: 2016.11.08 10:35 AM
LAST SAVER: 2020.06.04 12:14 PM

RCP LEGEND

-  4' x 4" SURFACED MOUNTED LED LIGHT
-  LED SHOWER LIGHT
-  EMERGENCY LIGHT
-  WALL MOUNTED LED UP/DOWN LIGHT
-  BUILDING MOUNTED EXTERIOR LED LIGHT
-  LED STRIP LIGHT
-  RECESSED EXTERIOR CAN LIGHT
-  OCCUPANCY SENSOR
-  OCCUPANCY SENSOR
-  POWER PACK
-  TUBULAR SKYLIGHT
-  SUPPLY DIFFUSER
-  RETURN DIFFUSER
-  VINYL PANELING
-  FIBER CEMENT SOFFIT PANELS

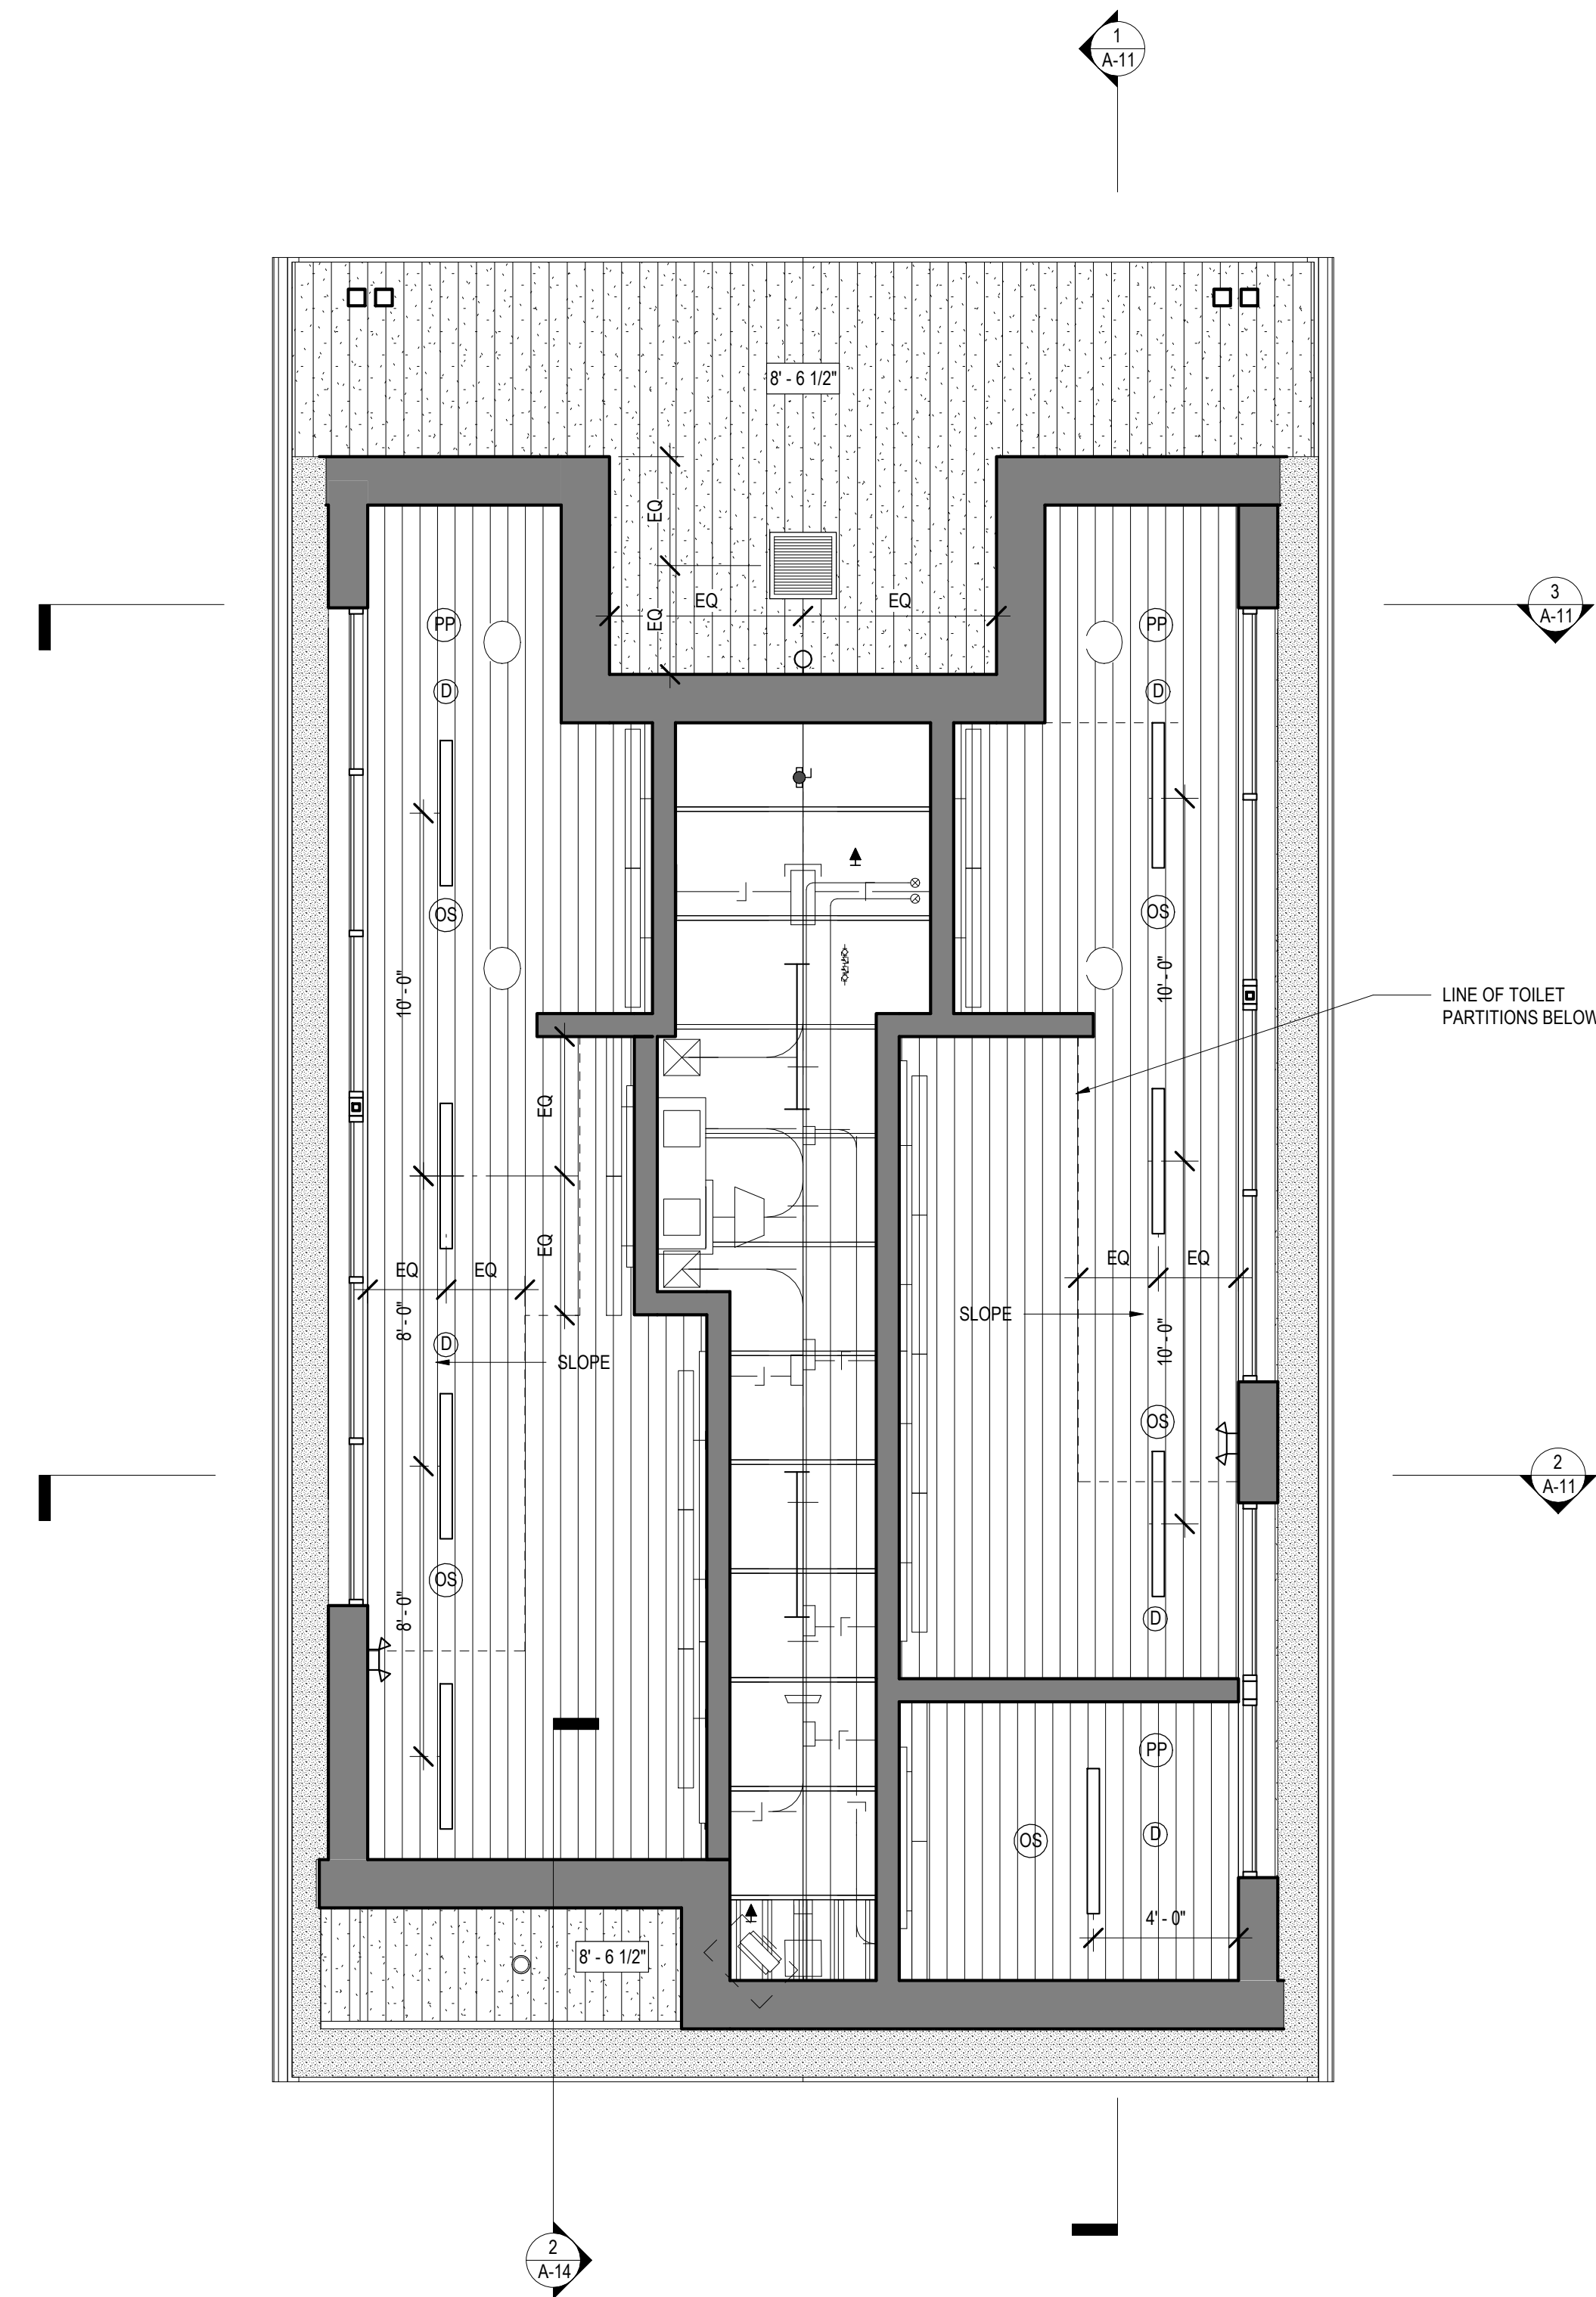

1 OG TENT CAMP
A-13 1/4" = 1'-0"

VERIFY SCALE

BAR IS ONE (1) INCH LONG
ON ORIGINAL DRAWING: 0 1


IF BAR IS NOT ONE (1) INCH LONG, ADJUST SCALE ACCORDINGLY


CONTRACTOR SHALL FIELD VERIFY ALL DIMENSIONS. VARIANCE FROM CONTRACT DOCUMENTS NOT PERMITTED WITHOUT PROFESSIONAL & BUREAU OF CONSTRUCTION APPROVAL.

DRAWN BY: M STRENSKI
CHECKED BY: T WOODWARD


DATE: 06/17/2022
SCALE: AS NOTED

DRAWING No. **A-13**


CONSTRUCTION DOCUMENTS	
RECORD	REVISIONS
 03/05/2021 SIGNATURE _____ DATE _____	
SMP ARCHITECTS 1600 WALNUT STREET, SECOND FLOOR PHILADELPHIA, PENNSYLVANIA	
COMMONWEALTH OF PENNSYLVANIA DEPARTMENT OF GENERAL SERVICES HARRISBURG, PENNSYLVANIA	
D.G.S. PROJECT No. C-114-0006 PHASE 1 HICKORY RUN STATE PARK LATRINE IMPROVEMENTS DEPT of CONSERVATION AND NATURAL RESOURCES WHITE HAVEN, CARBON COUNTY, PA	
ORGANIZED GROUP TENT CAMP - REFLECTED CEILING PLAN	

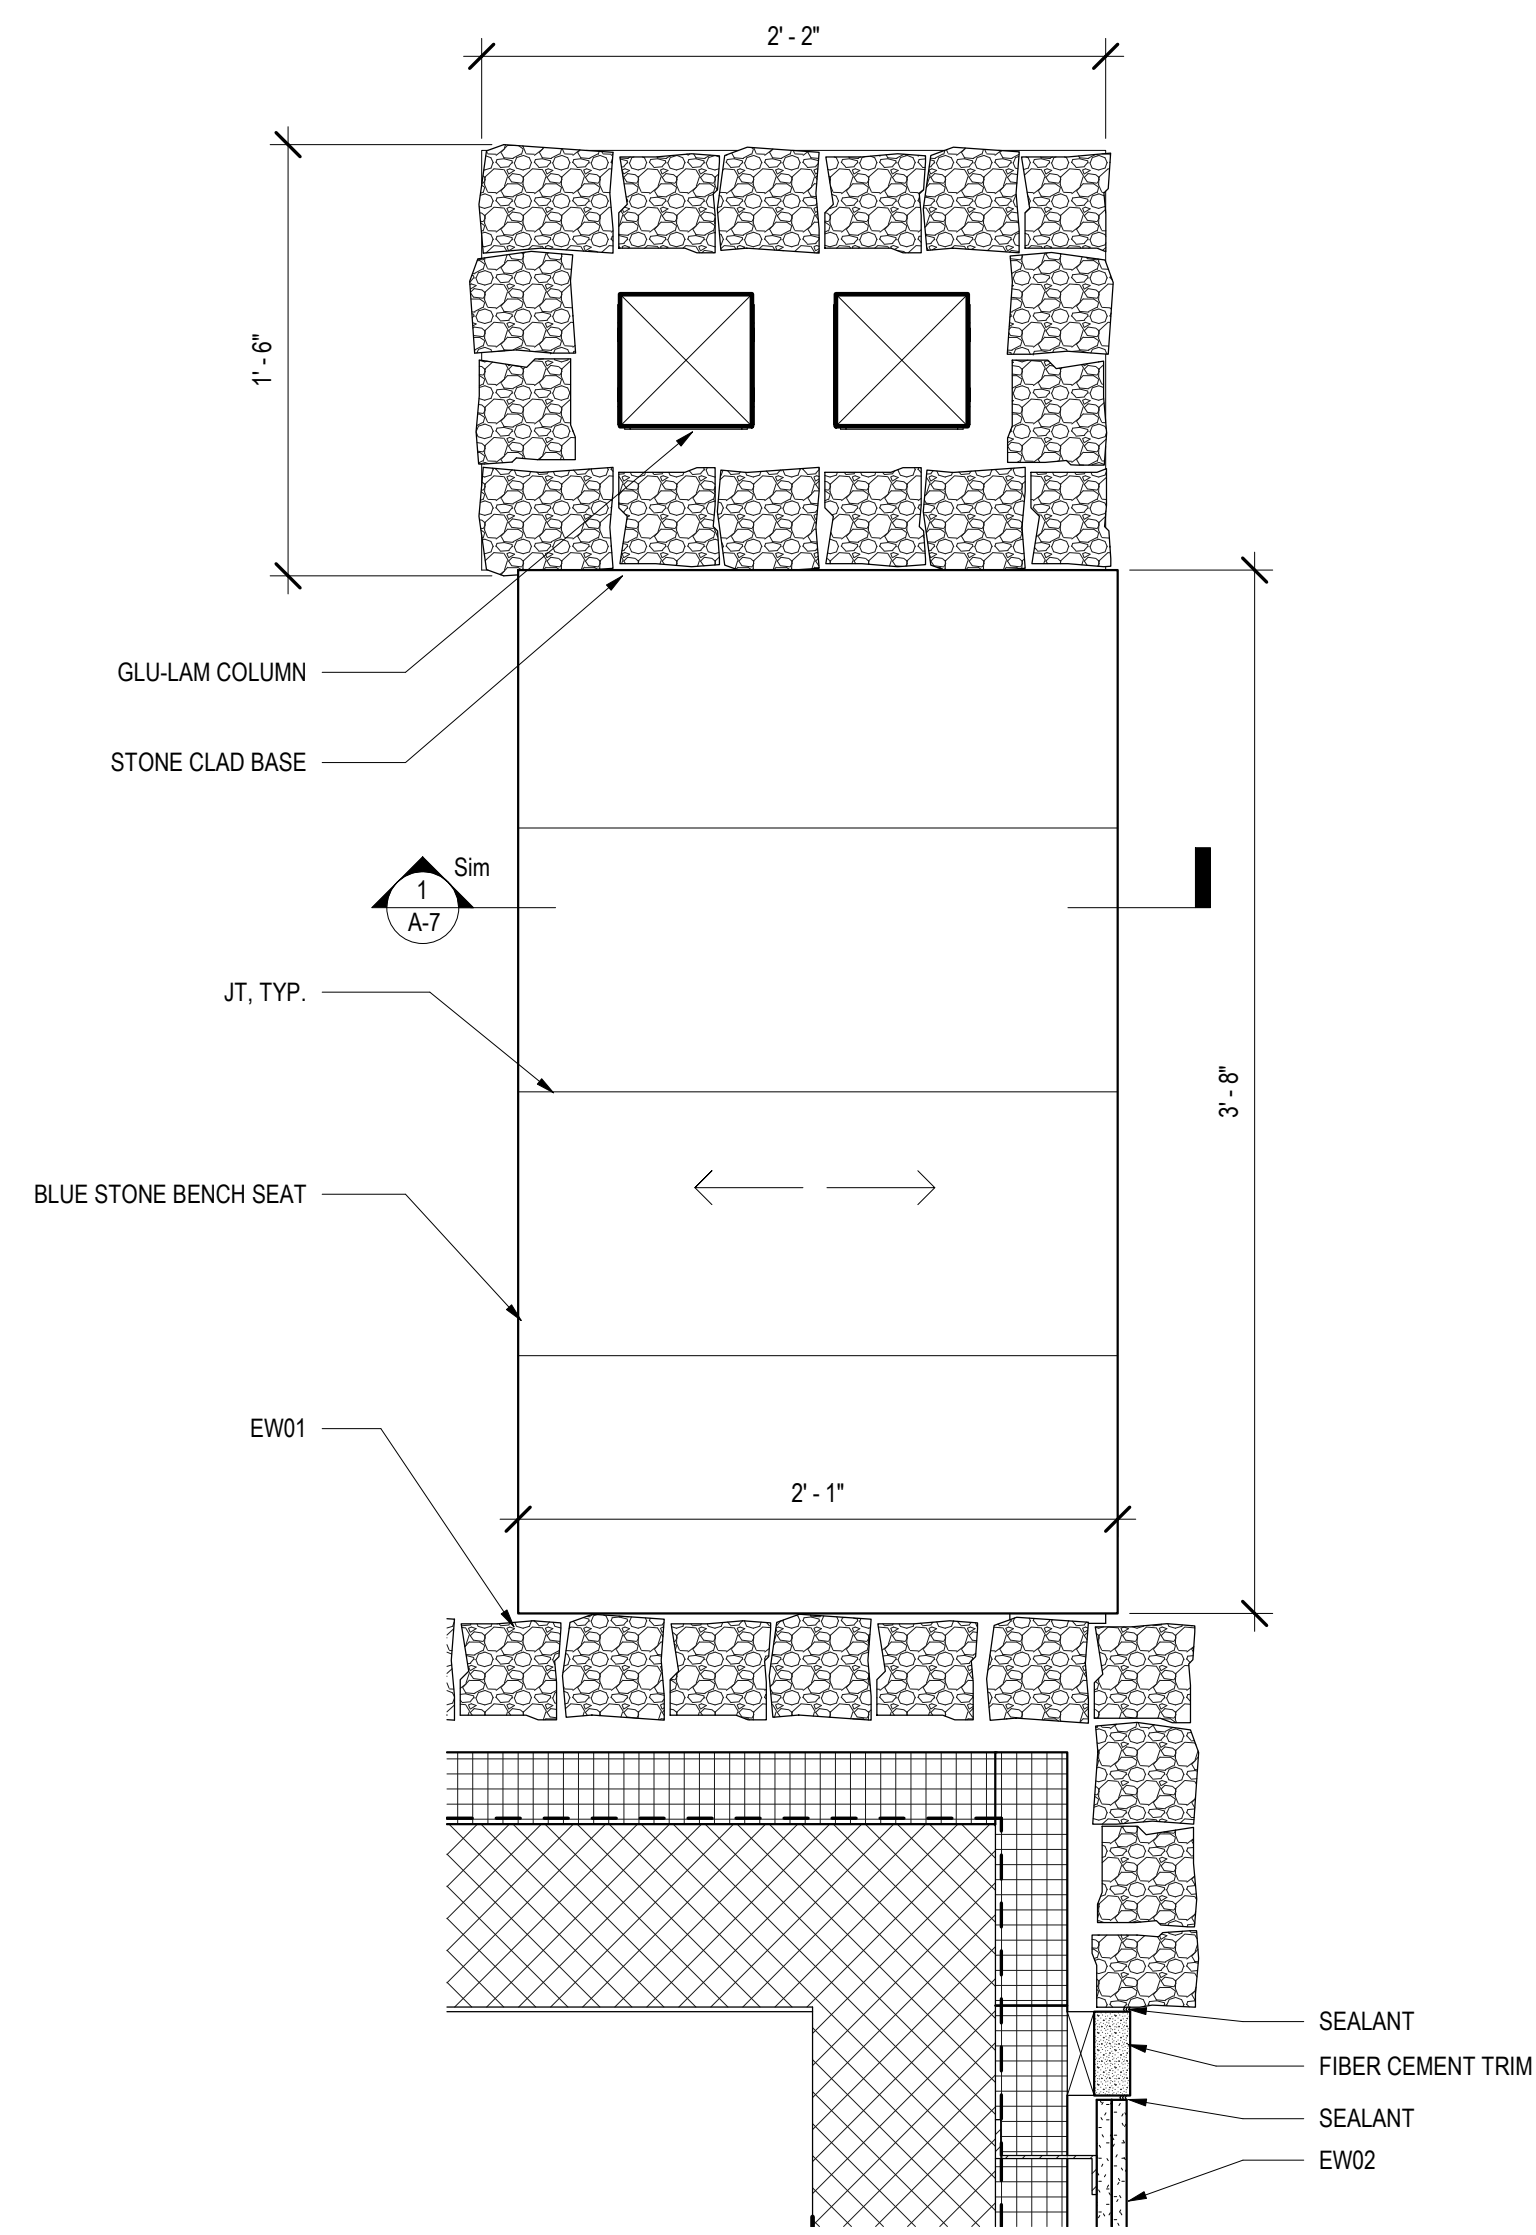

3 PLAN DETAIL - OGTC COLUMN BASE AND ENTRY BENCH
 A-14 1 1/2" = 1'-0"

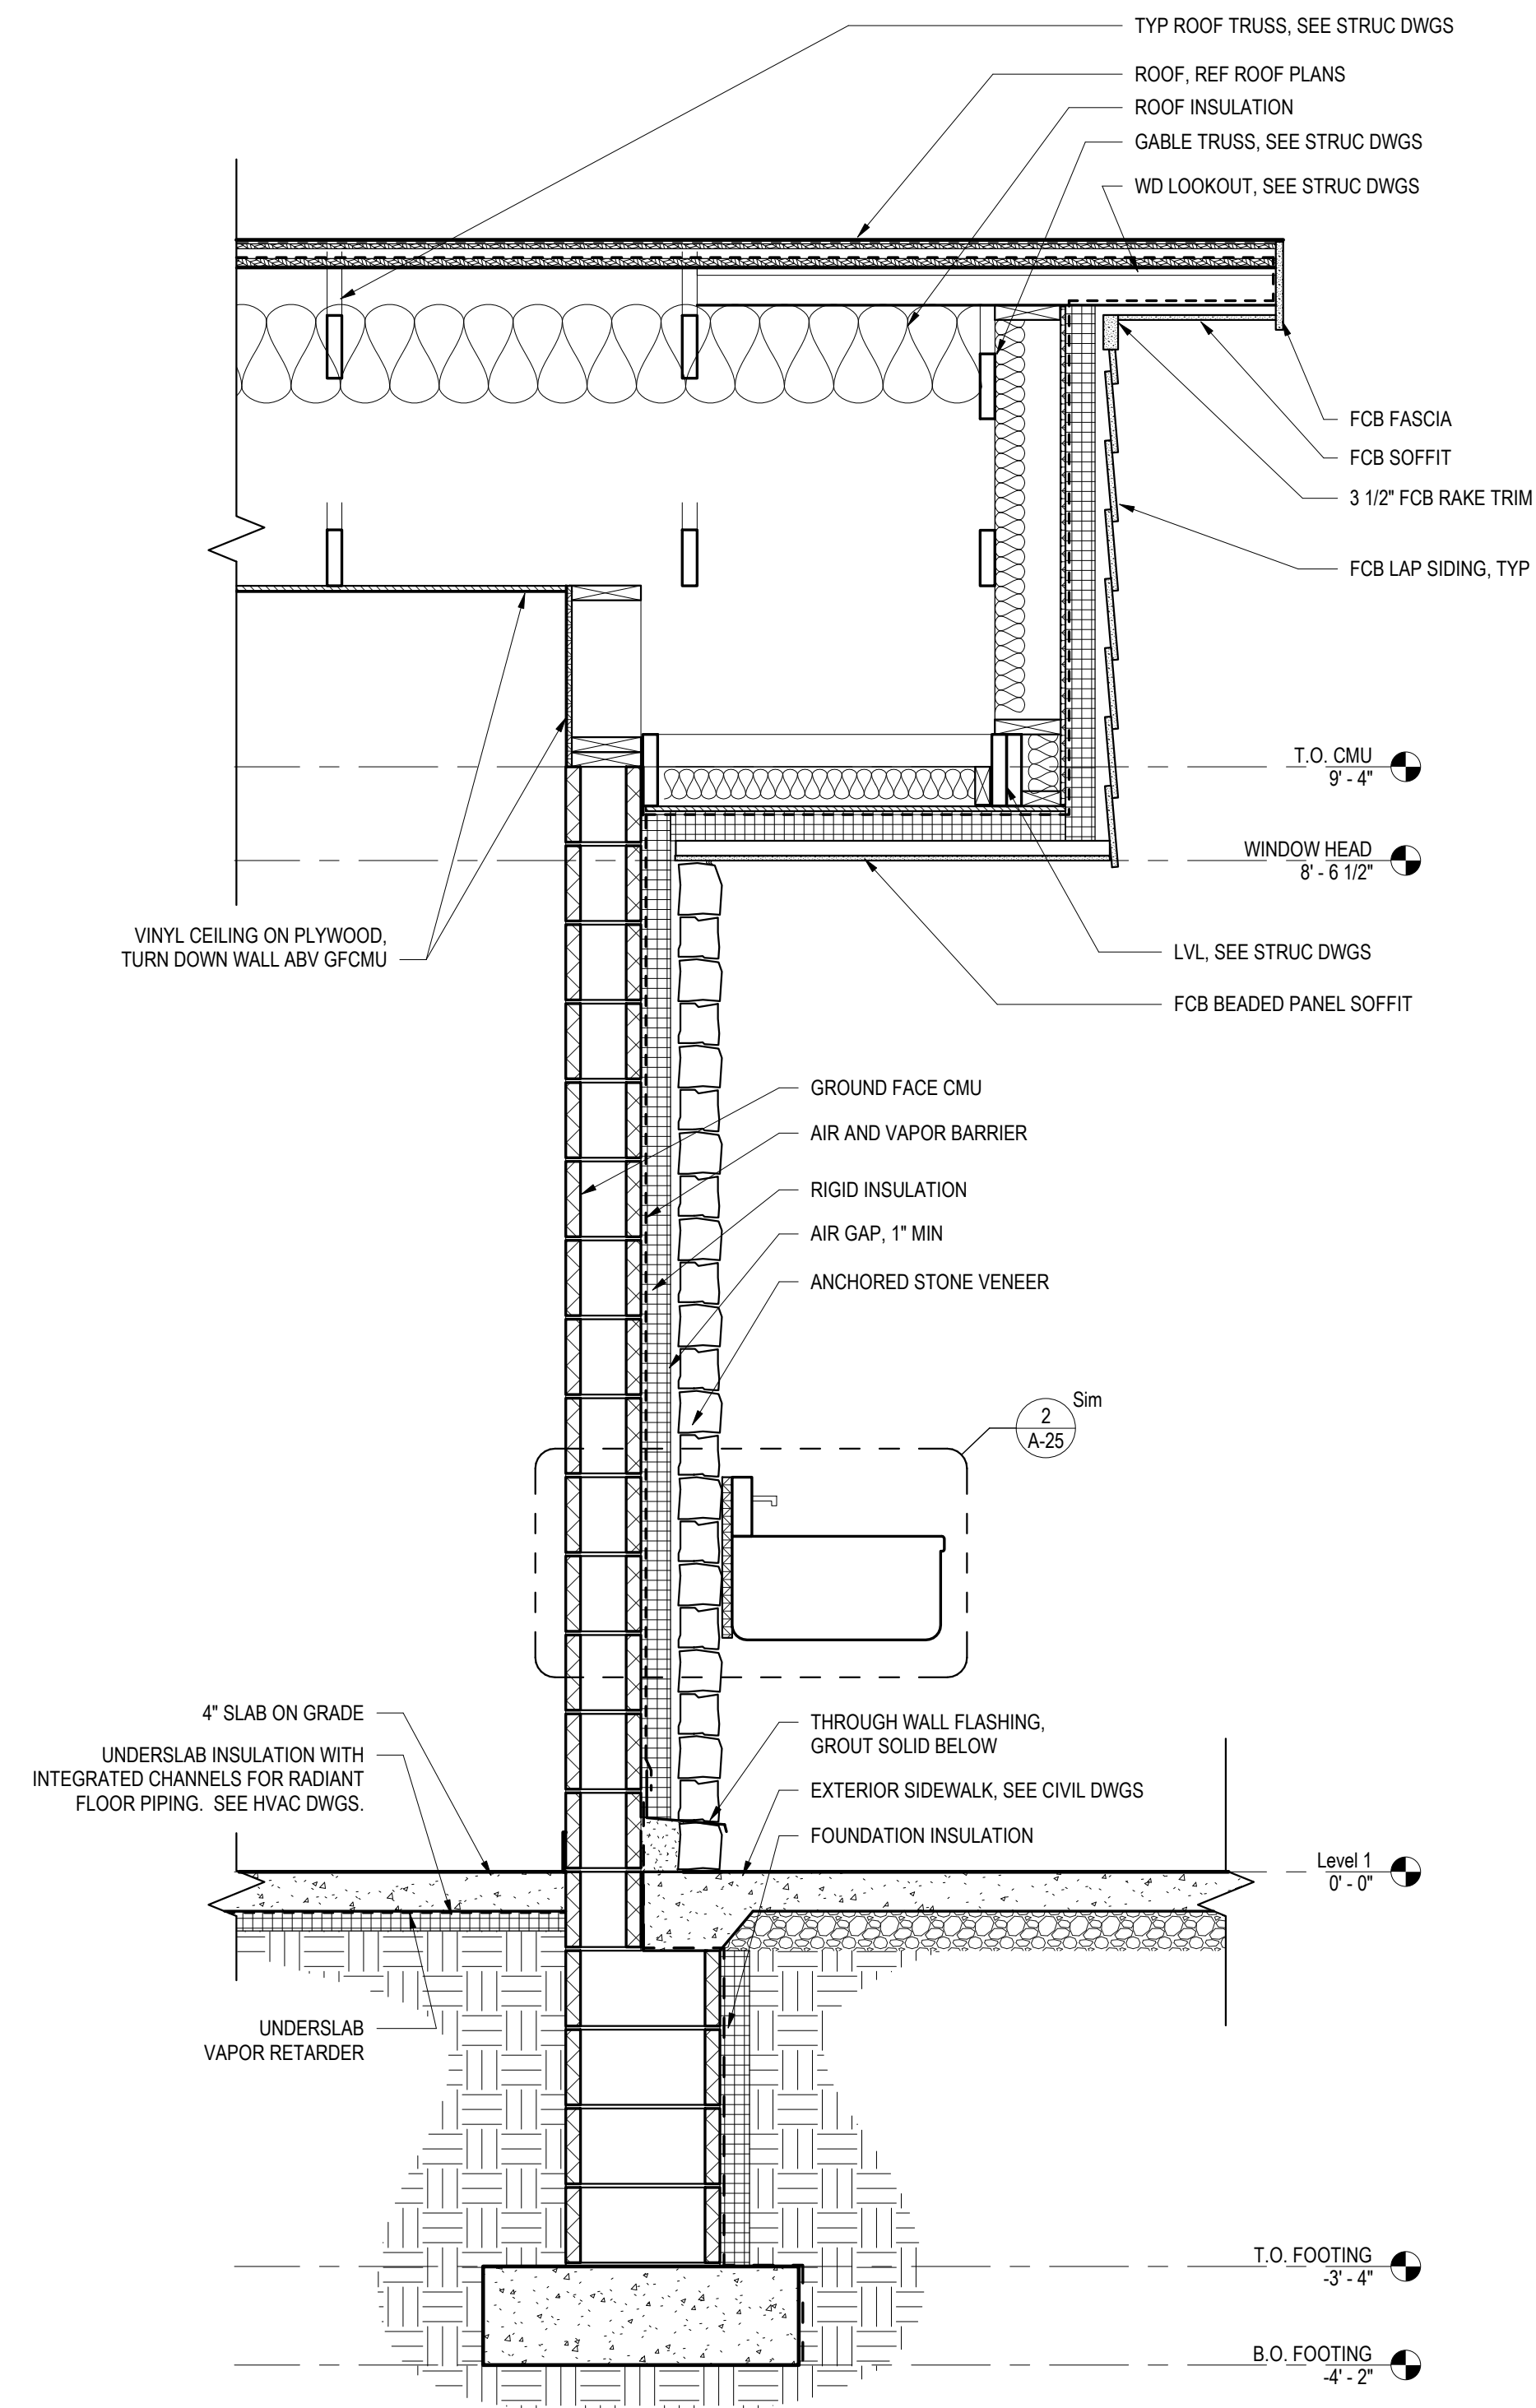


2 WALL SECTION - DISHWASHING SINK OVERHANG
 A-14 3/4" = 1'-0"

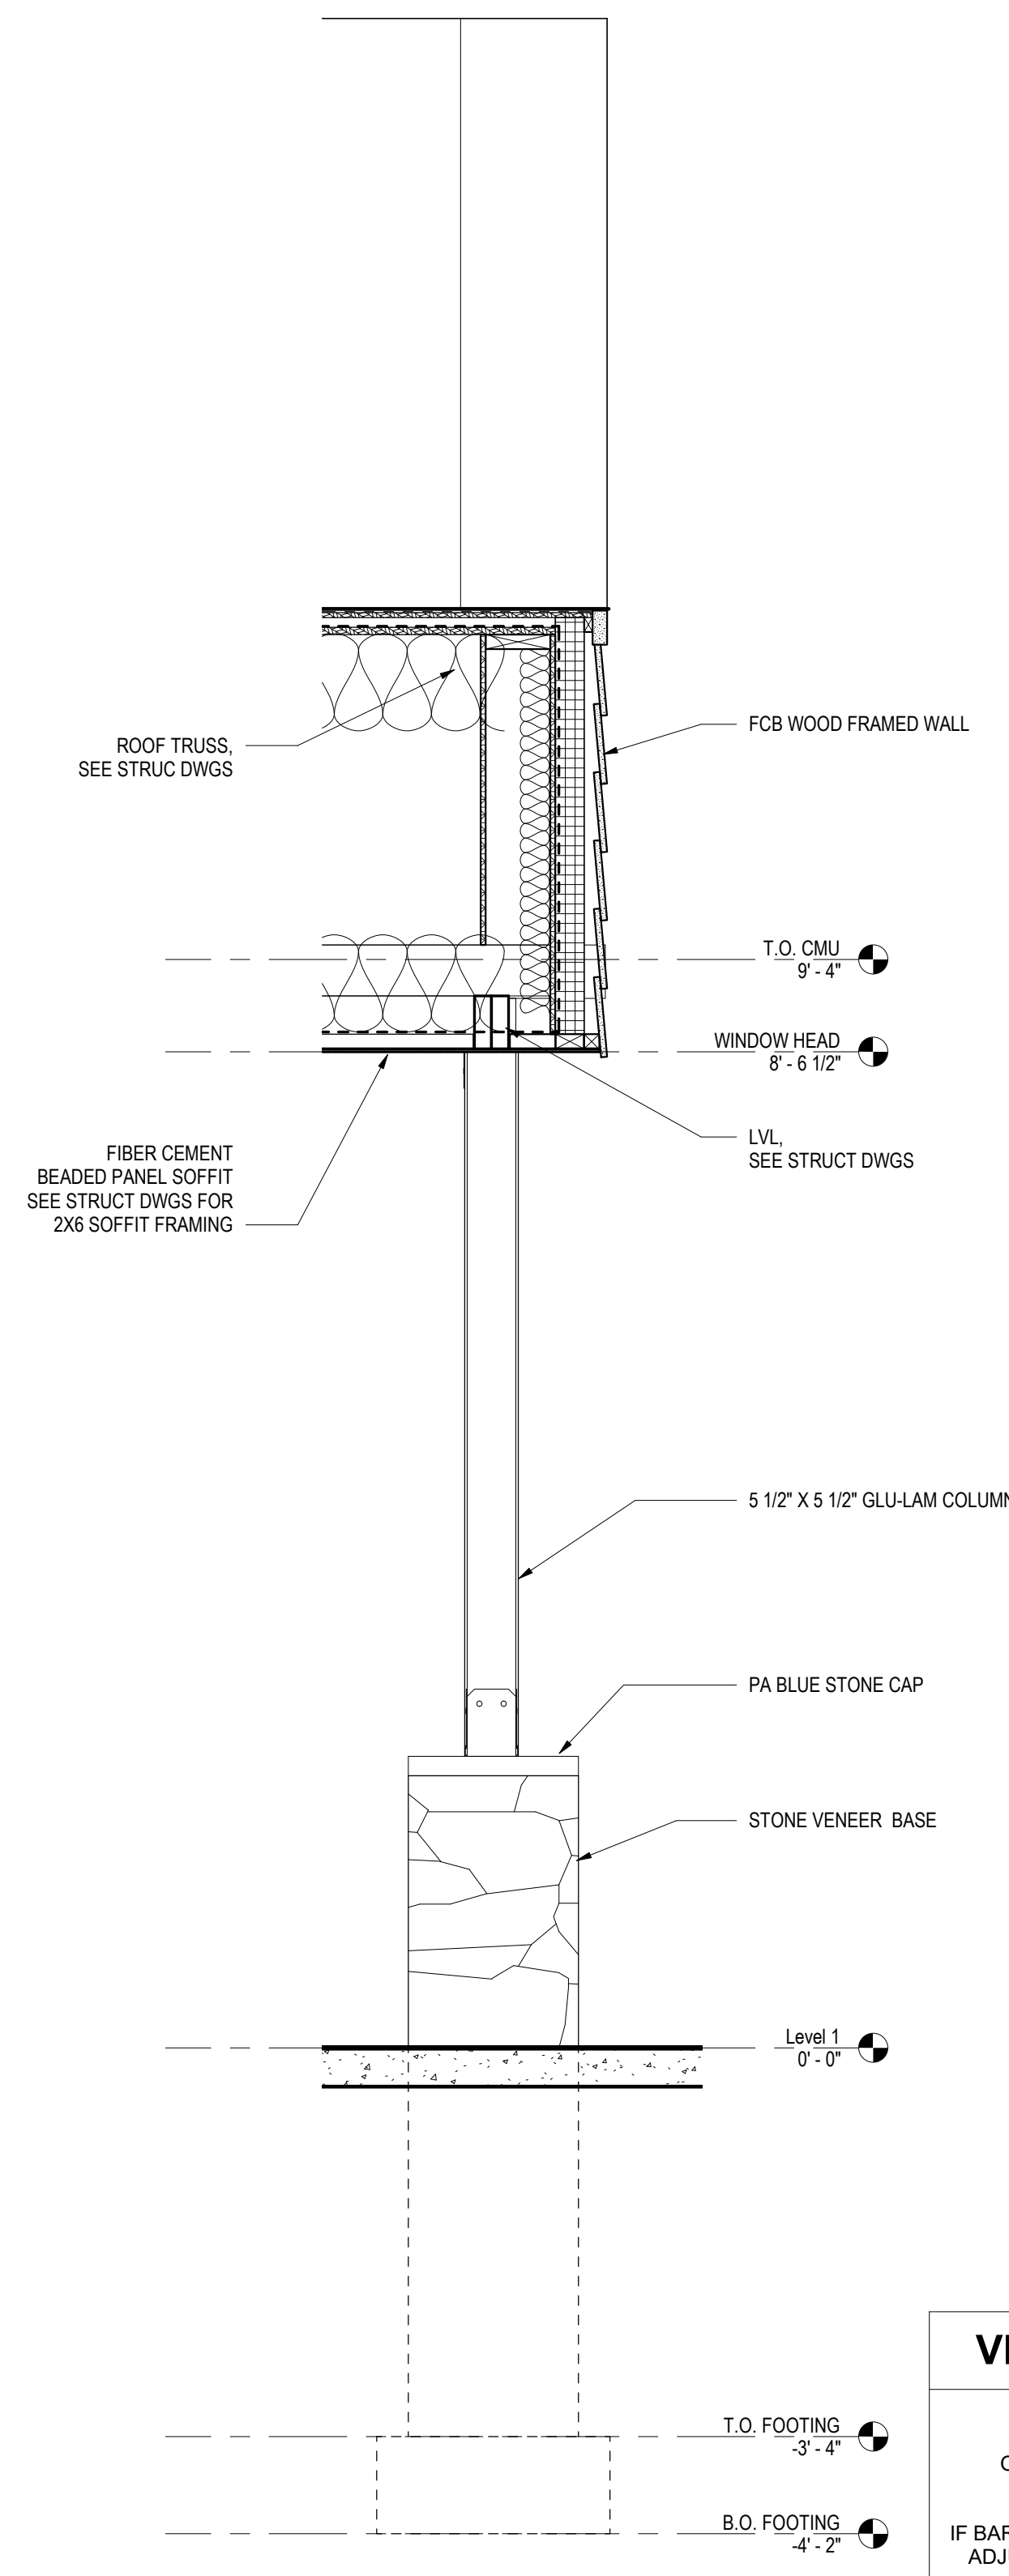

1 SECTION - OGTC ENTRY PORCH
 A-14 3/4" = 1'-0"

VERIFY SCALE
 BAR IS ONE (1) INCH LONG
 ON ORIGINAL DRAWING: 0 1
 IF BAR IS NOT ONE (1) INCH LONG, ADJUST SCALE ACCORDINGLY
 CONTRACTOR SHALL FIELD VERIFY ALL DIMENSIONS. VARIANCE FROM CONTRACT DOCUMENTS NOT PERMITTED WITHOUT PROFESSIONAL & BUREAU OF CONSTRUCTION APPROVAL.

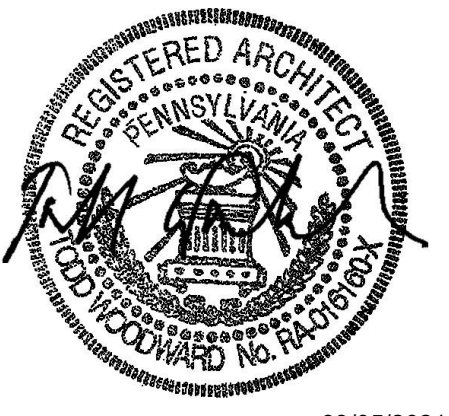CONSTRUCTION DOCUMENTS	
RECORD REVISIONS	
 03/05/2021 SIGNATURE DATE	
SMP ARCHITECTS 1600 WALNUT STREET, SECOND FLOOR PHILADELPHIA, PENNSYLVANIA	
COMMONWEALTH OF PENNSYLVANIA DEPARTMENT OF GENERAL SERVICES HARRISBURG, PENNSYLVANIA	
D.G.S. PROJECT No. C-114-0006 PHASE 1 HICKORY RUN STATE PARK LATRINE IMPROVEMENTS DEPT of CONSERVATION AND NATURAL RESOURCES WHITE HAVEN, CARBON COUNTY, PA	
ORGANIZED GROUP TENT CAMPING - SECTIONS AND DETAILS	
DATE 06/17/2022	DRAWING No. A-14
DRAWN BY M STRENSKI	CHECKED BY T WOODWARD
SCALE AS NOTED	68 OF 144


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GENERAL NOTES:

1. HVAC EQUIPMENT IS PROVIDED BY THE 2 CONTRACT.
2. PLUMBING FIXTURES ARE PROVIDED BY THE 3 CONTRACT.
3. LIGHT FIXTURES ARE PROVIDED BY THE 4 CONTRACT.
4. ALL EXPOSED SURFACES OF GFCMU BLOCKS IN OCCUPIED SPACES SHALL BE GROUND AND FINISHED.

CONSTRUCTION NOTES (CN)

- CN-1 STANDING SEAM METAL ROOF (R2)
- CN-2 TUBULAR SKYLIGHT
- CN-3 METAL DOWNSPOUT
- CN-4 METAL GUTTER
- CN-5 CONCRETE SIDEWALK. SEE CIVIL DWGS.
- CN-6 WATER FOUNTAIN. SEE CIVIL DWGS.
- CN-7 DISHWASHING SINK
- CN-8 EXTERIOR COUNTER
- CN-9 STONE VENEER BENCH WITH CAST STONE SEAT
- CN-10 NOT USED
- CN-11 WALL MOUNTED FIRE EXTINGUISHER
- CN-12 FLOOR DRAIN. SEE MEP DWGS.
- CN-13 CHANGING AREA PARTITION
- CN-14 BENCH BY PARTITION MANUFACTURER, HOOK (TYPE I) MOUNTED ABOVE
- CN-15 ADA FOLDING SHOWER SEAT
- CN-16 TRENCH DRAIN. SEE MEP DWGS.
- CN-17 EPOXY FLOOR. SLOPE TO DRAIN.
- CN-18 MOP SINK
- CN-19 QUARTZ COUNTERTOP
- CN-20 ELECTRIC HAND DRYER
- CN-21 SOAP DISPENSER
- CN-22 TOILET PARTITION
- CN-23 URINAL SCREEN
- CN-24 TOILET PAPER DISPENSER
- CN-25 ADA GRAB BARS
- CN-26 WASTE RECEPTACLE
- CN-27 BABY CHANGING STATION
- CN-28 ASPHALT SHINGLE ROOF (R1)
- CN-29 STONE VENEER COLUMN
- CN-30 WOOD COLUMNS WITH STONE VENEER BASE
- CN-31 SNOW GUARD
- CN-32 HDPE WALL MOUNTED BENCH
- CN-33 ROOFLINE ABOVE
- CN-34 SEE MEP DRAWINGS FOR EQUIPMENT IN UTILITY ROOM
- CN-35 CLEAR FLOOR SPACE FOR LADDER
- CN-36 UTILITY SHELF

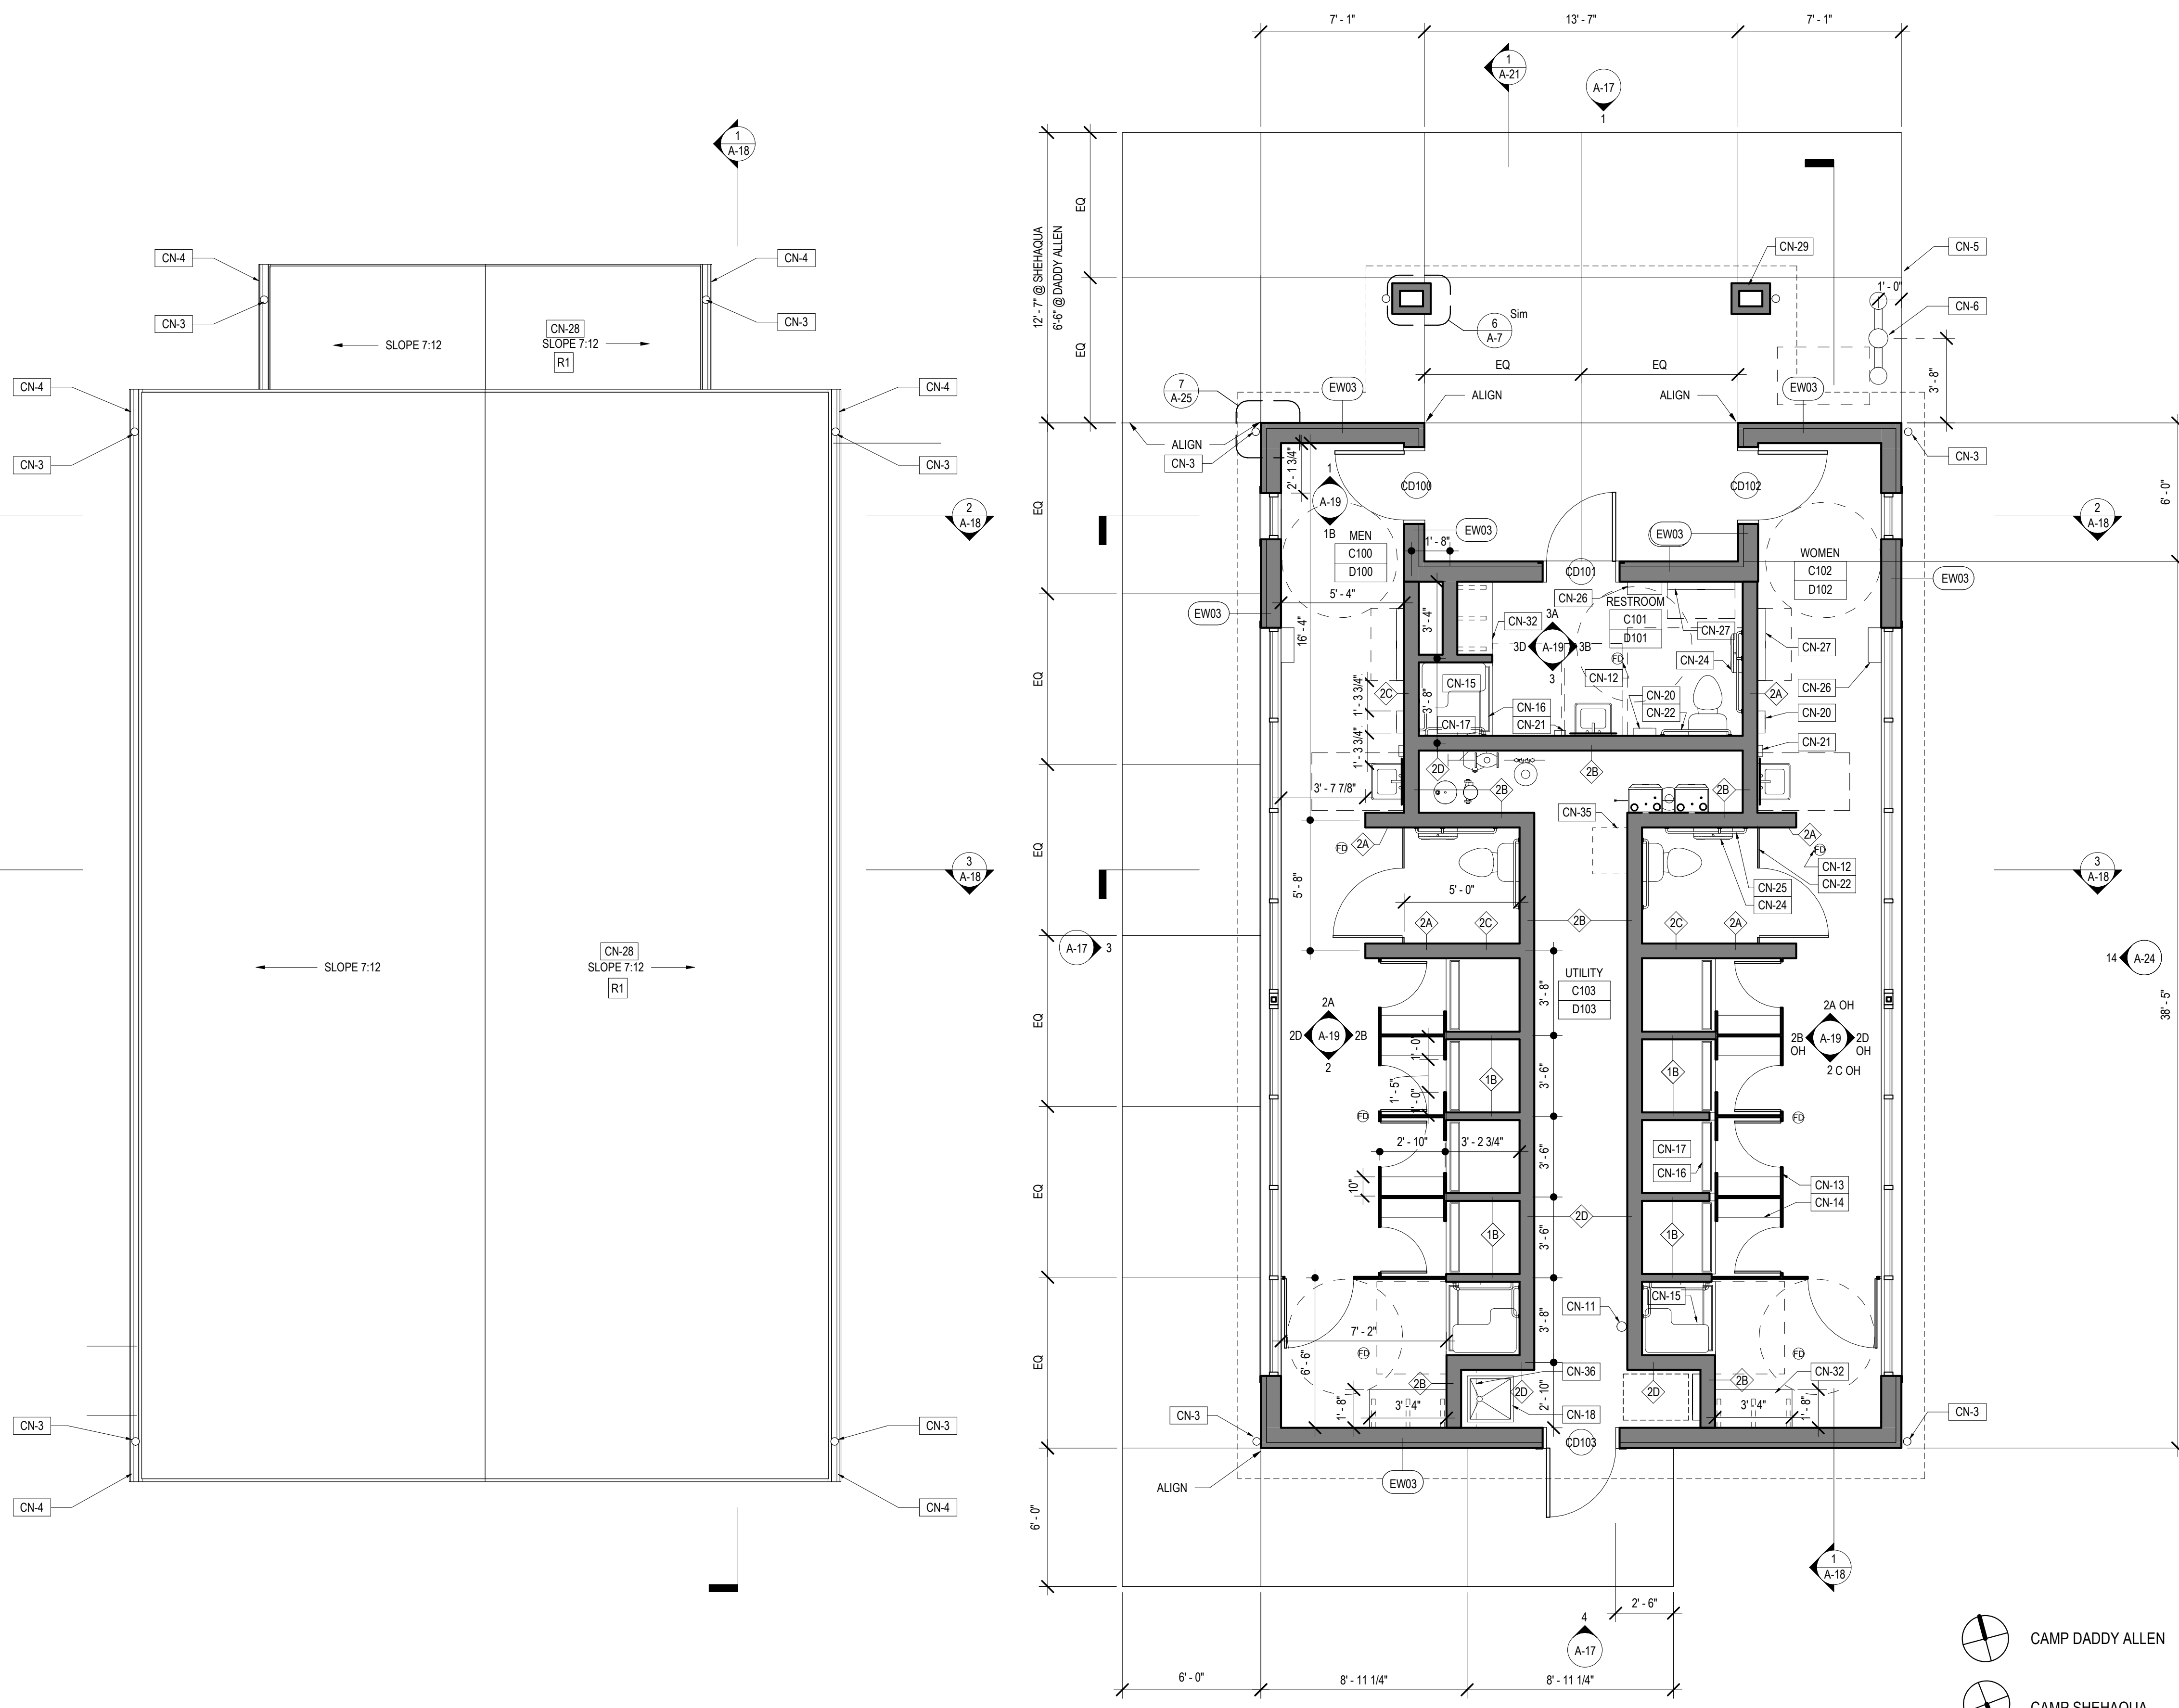

2 OGC TYPICAL ROOF PLAN
A-16 1/4" = 1'-0"

1 OGC TYPICAL - FLOOR PLAN
A-16 1/4" = 1'-0"


NOTE: 'C' ROOM NUMBER PREFIX REFERS TO CAMP DADDY ALLEN. 'D' ROOM NUMBER PREFIX REFERS TO CAMP SHEHAQUA

- CAMP DADDY ALLEN
- CAMP SHEHAQUA

CONSTRUCTION DOCUMENTS

NO.	DATE	REVISION

RECORD REVISIONS

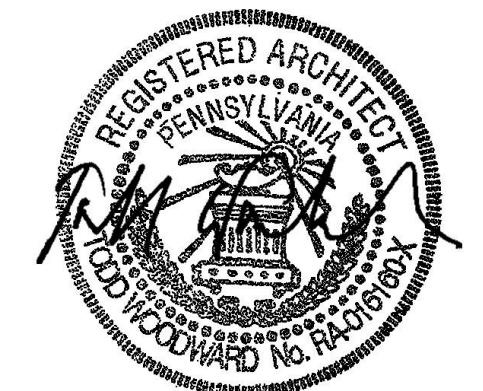

03/05/2021

SMP ARCHITECTS
1600 WALNUT STREET, SECOND FLOOR
PHILADELPHIA, PENNSYLVANIA

COMMONWEALTH OF PENNSYLVANIA
DEPARTMENT OF GENERAL SERVICES
HARRISBURG, PENNSYLVANIA

D.G.S. PROJECT No. **C-114-0006 PHASE 1**

HICKORY RUN STATE PARK
LATRINE IMPROVEMENTS
DEPT OF CONSERVATION AND NATURAL RESOURCES
WHITE HAVEN, CARBON COUNTY, PA


ORGANIZED GROUP CAMPING - TYPICAL PLANS

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ON ORIGINAL DRAWING: 1
IF BAR IS NOT ONE (1) INCH LONG, ADJUST SCALE ACCORDINGLY


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DATE: 06/17/2022
CHECKED BY: T WOODWARD
SCALE: AS NOTED

A-16
70 OF 144


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PLOTTED: 2022.06.04 10:35 AM
PLOTTER: HP DesignJet T1100e
PLOTTER BY: Megan M. Strenski

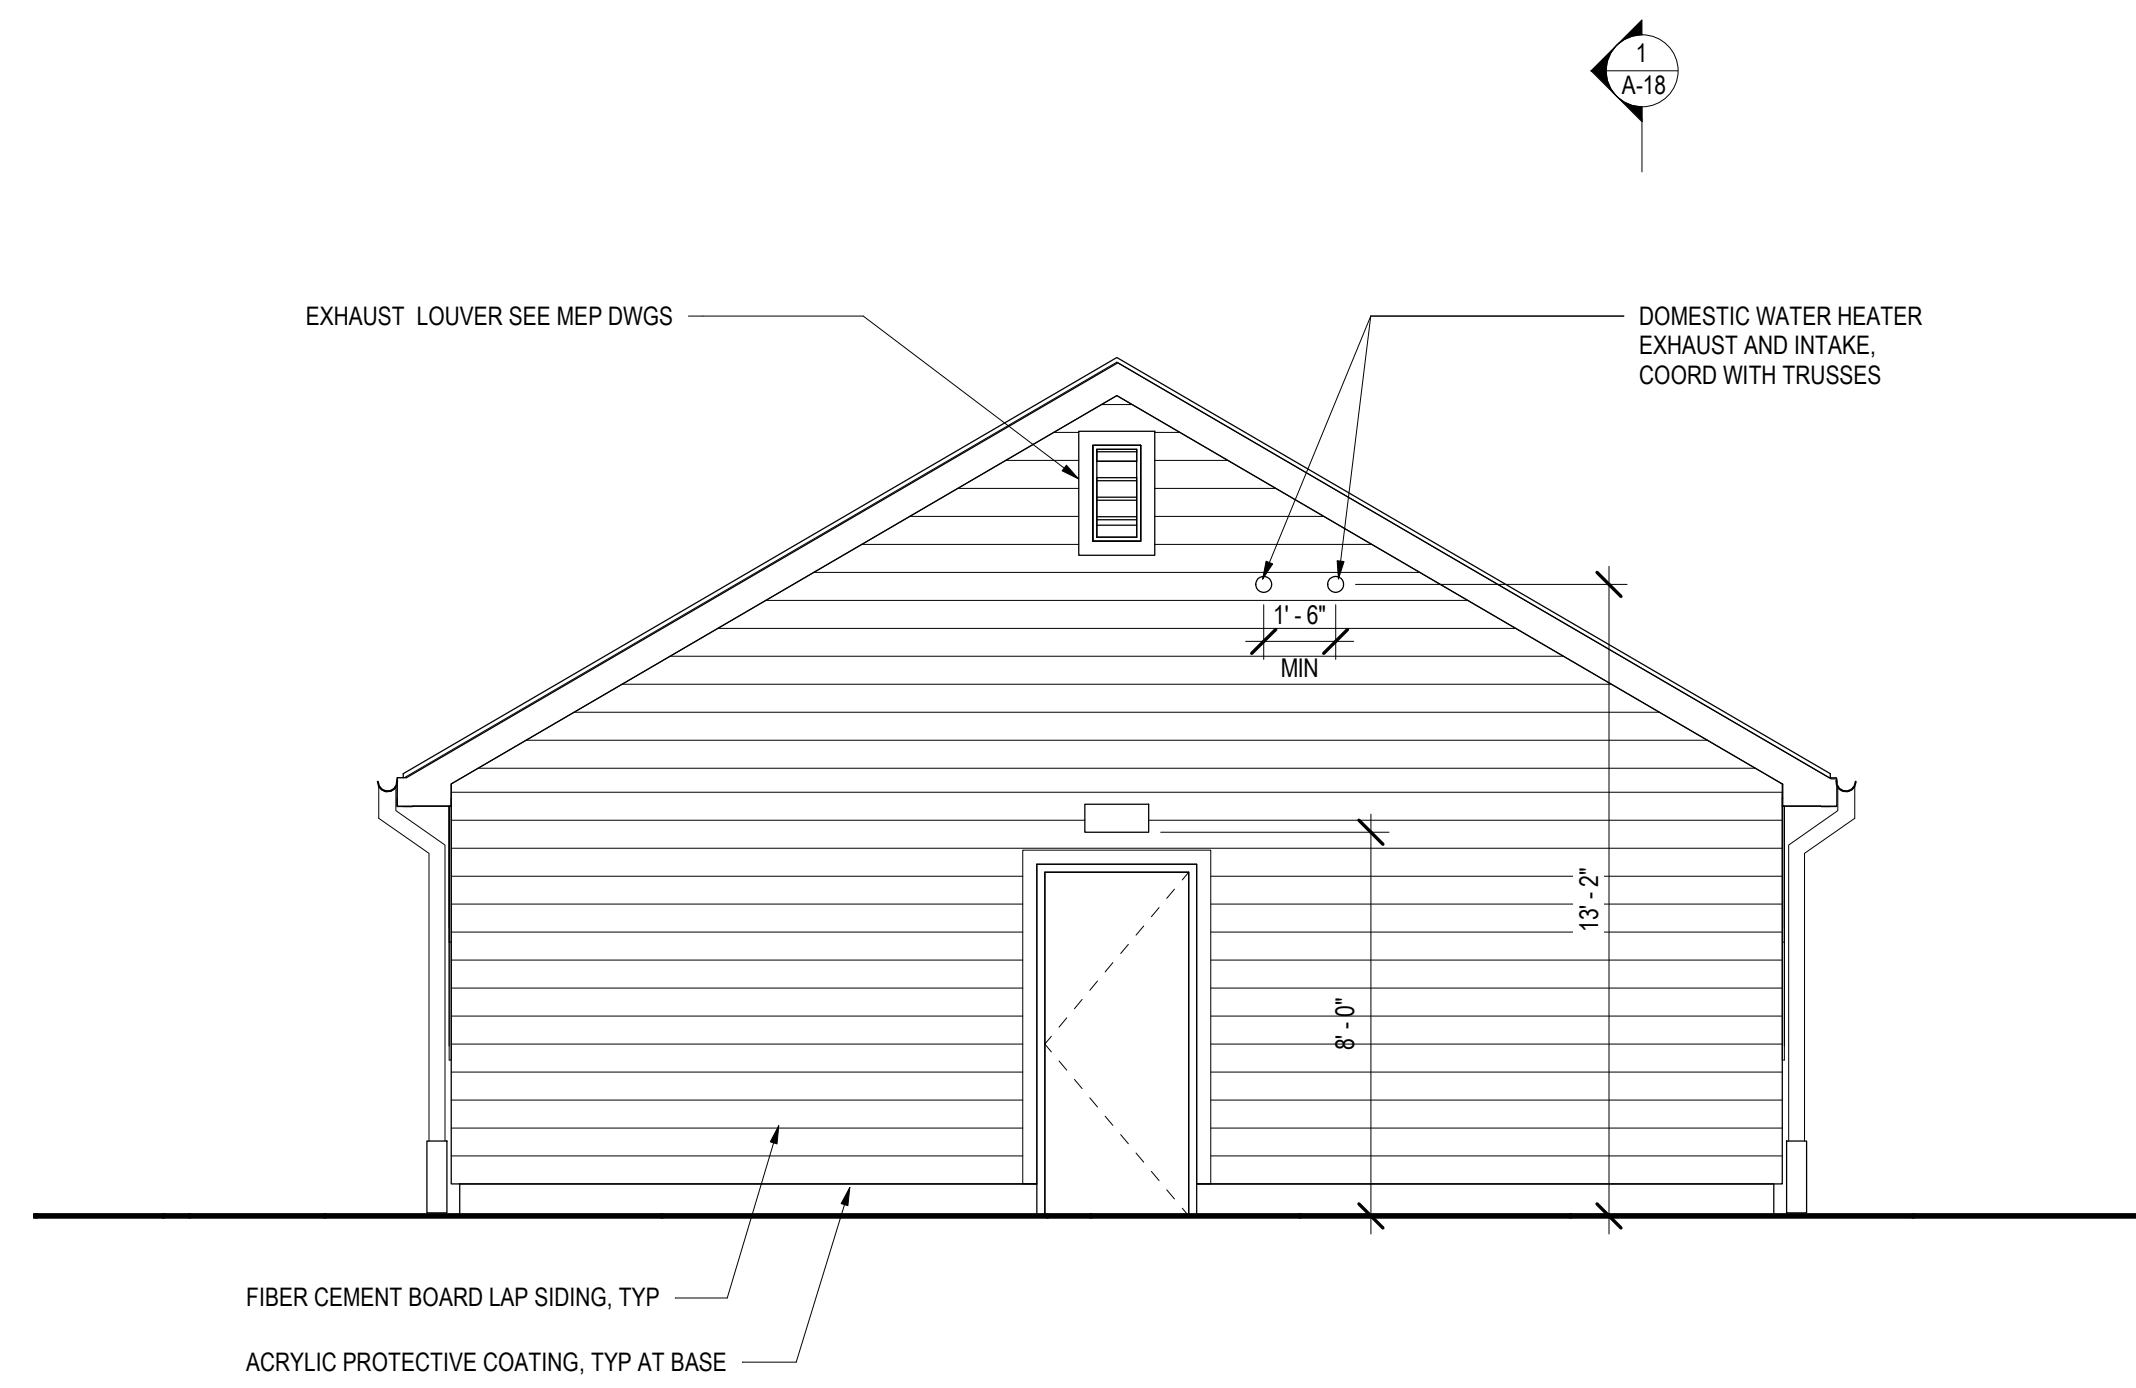


4 REAR ELEVATION
A-17 1/4" = 1'-0"

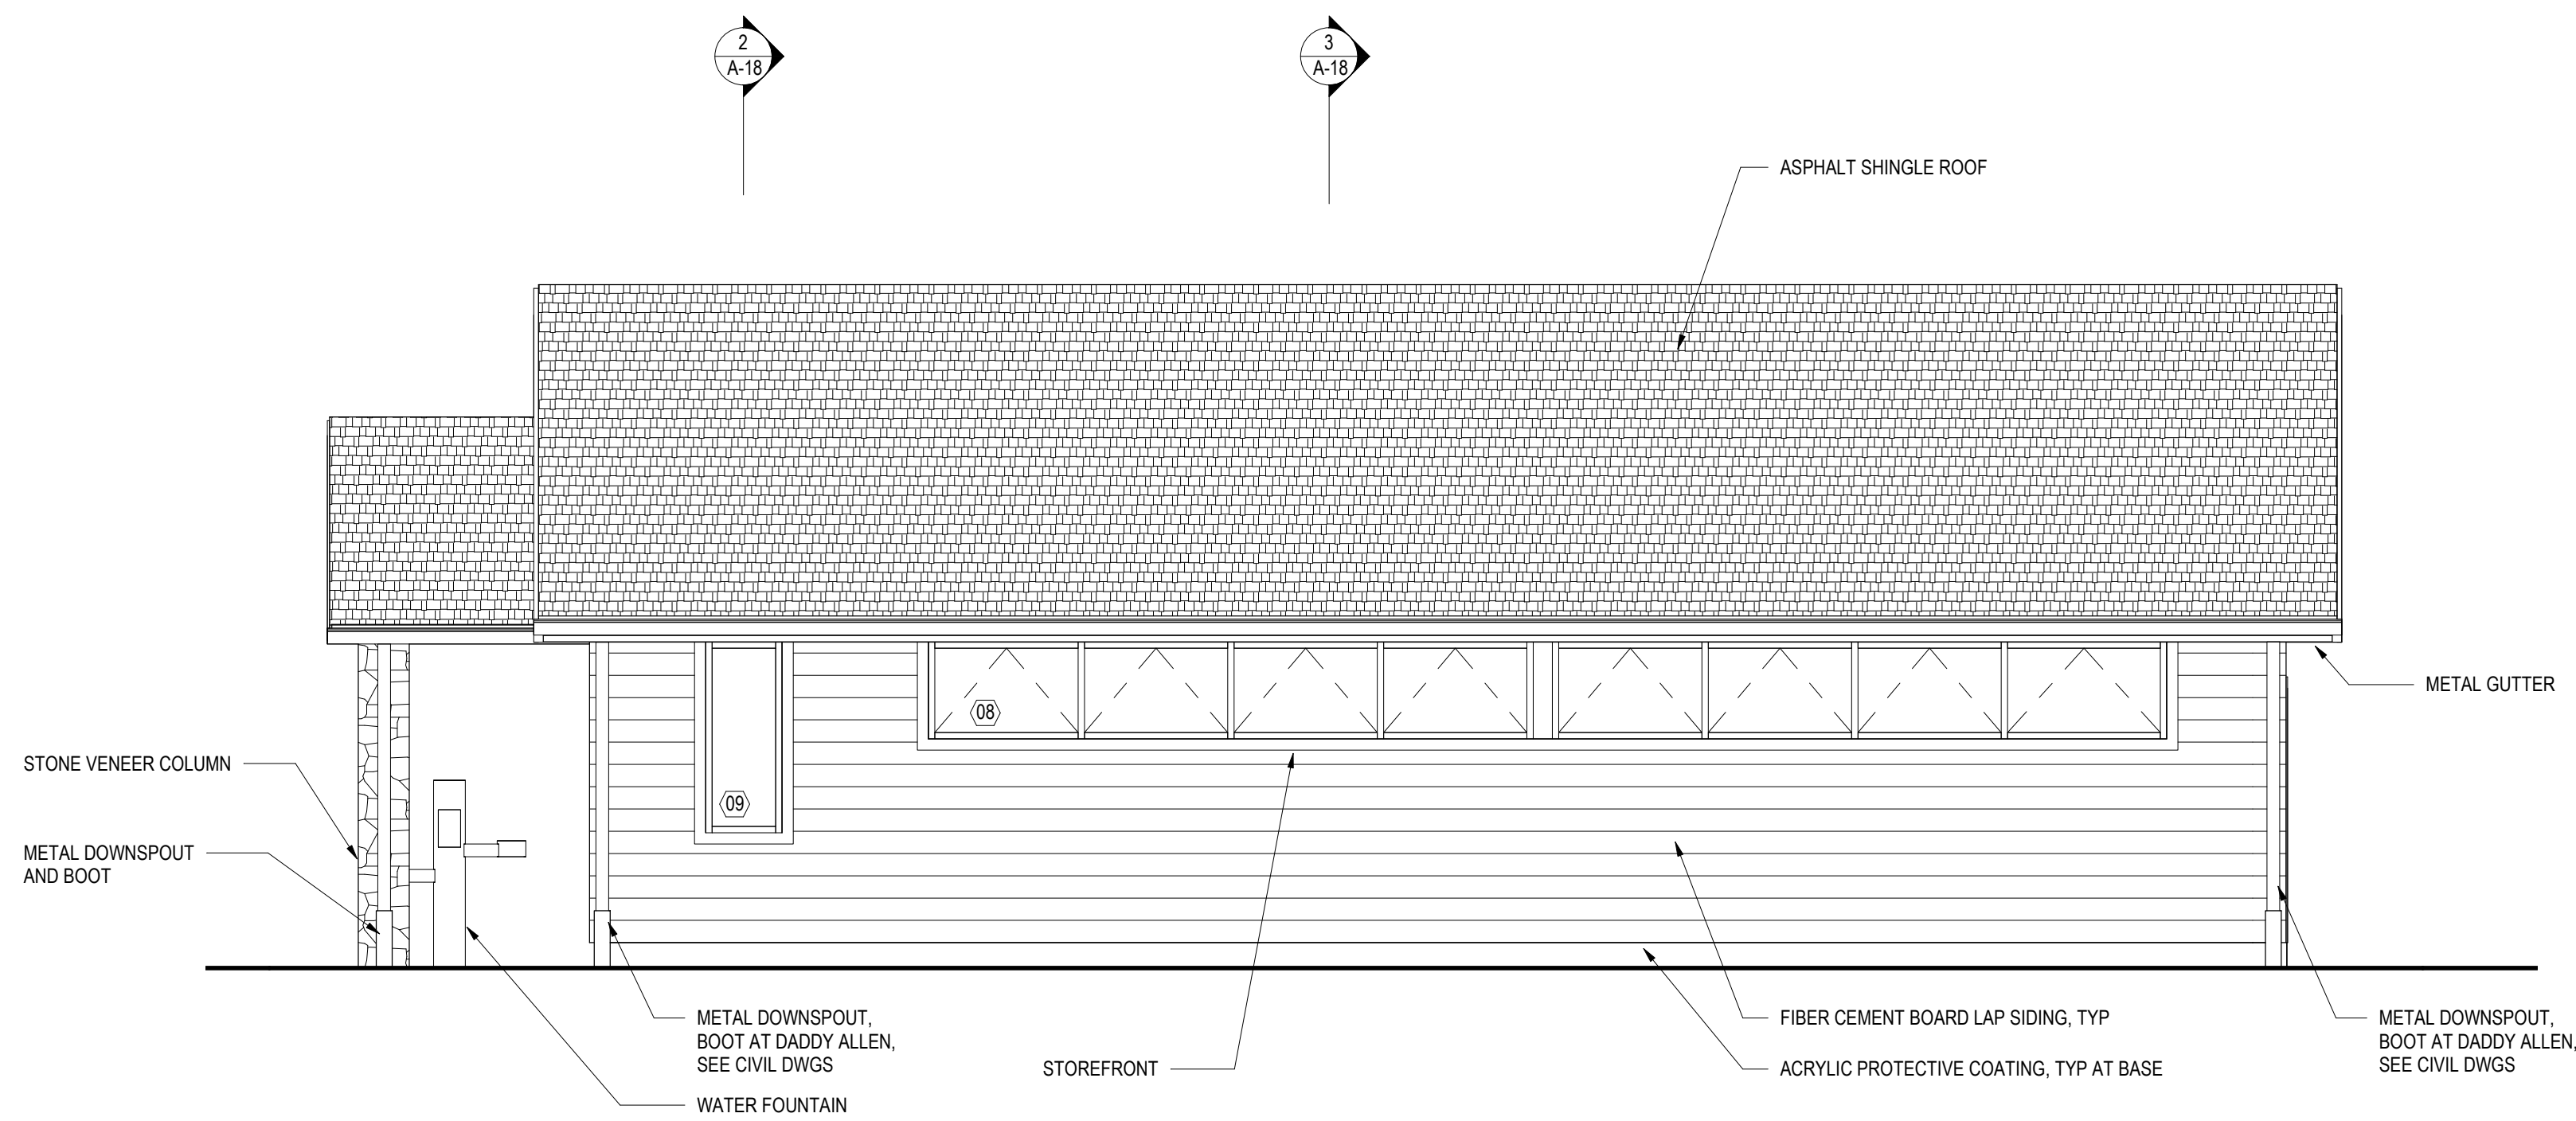

3 SIDE ELEVATION
A-17 1/4" = 1'-0"

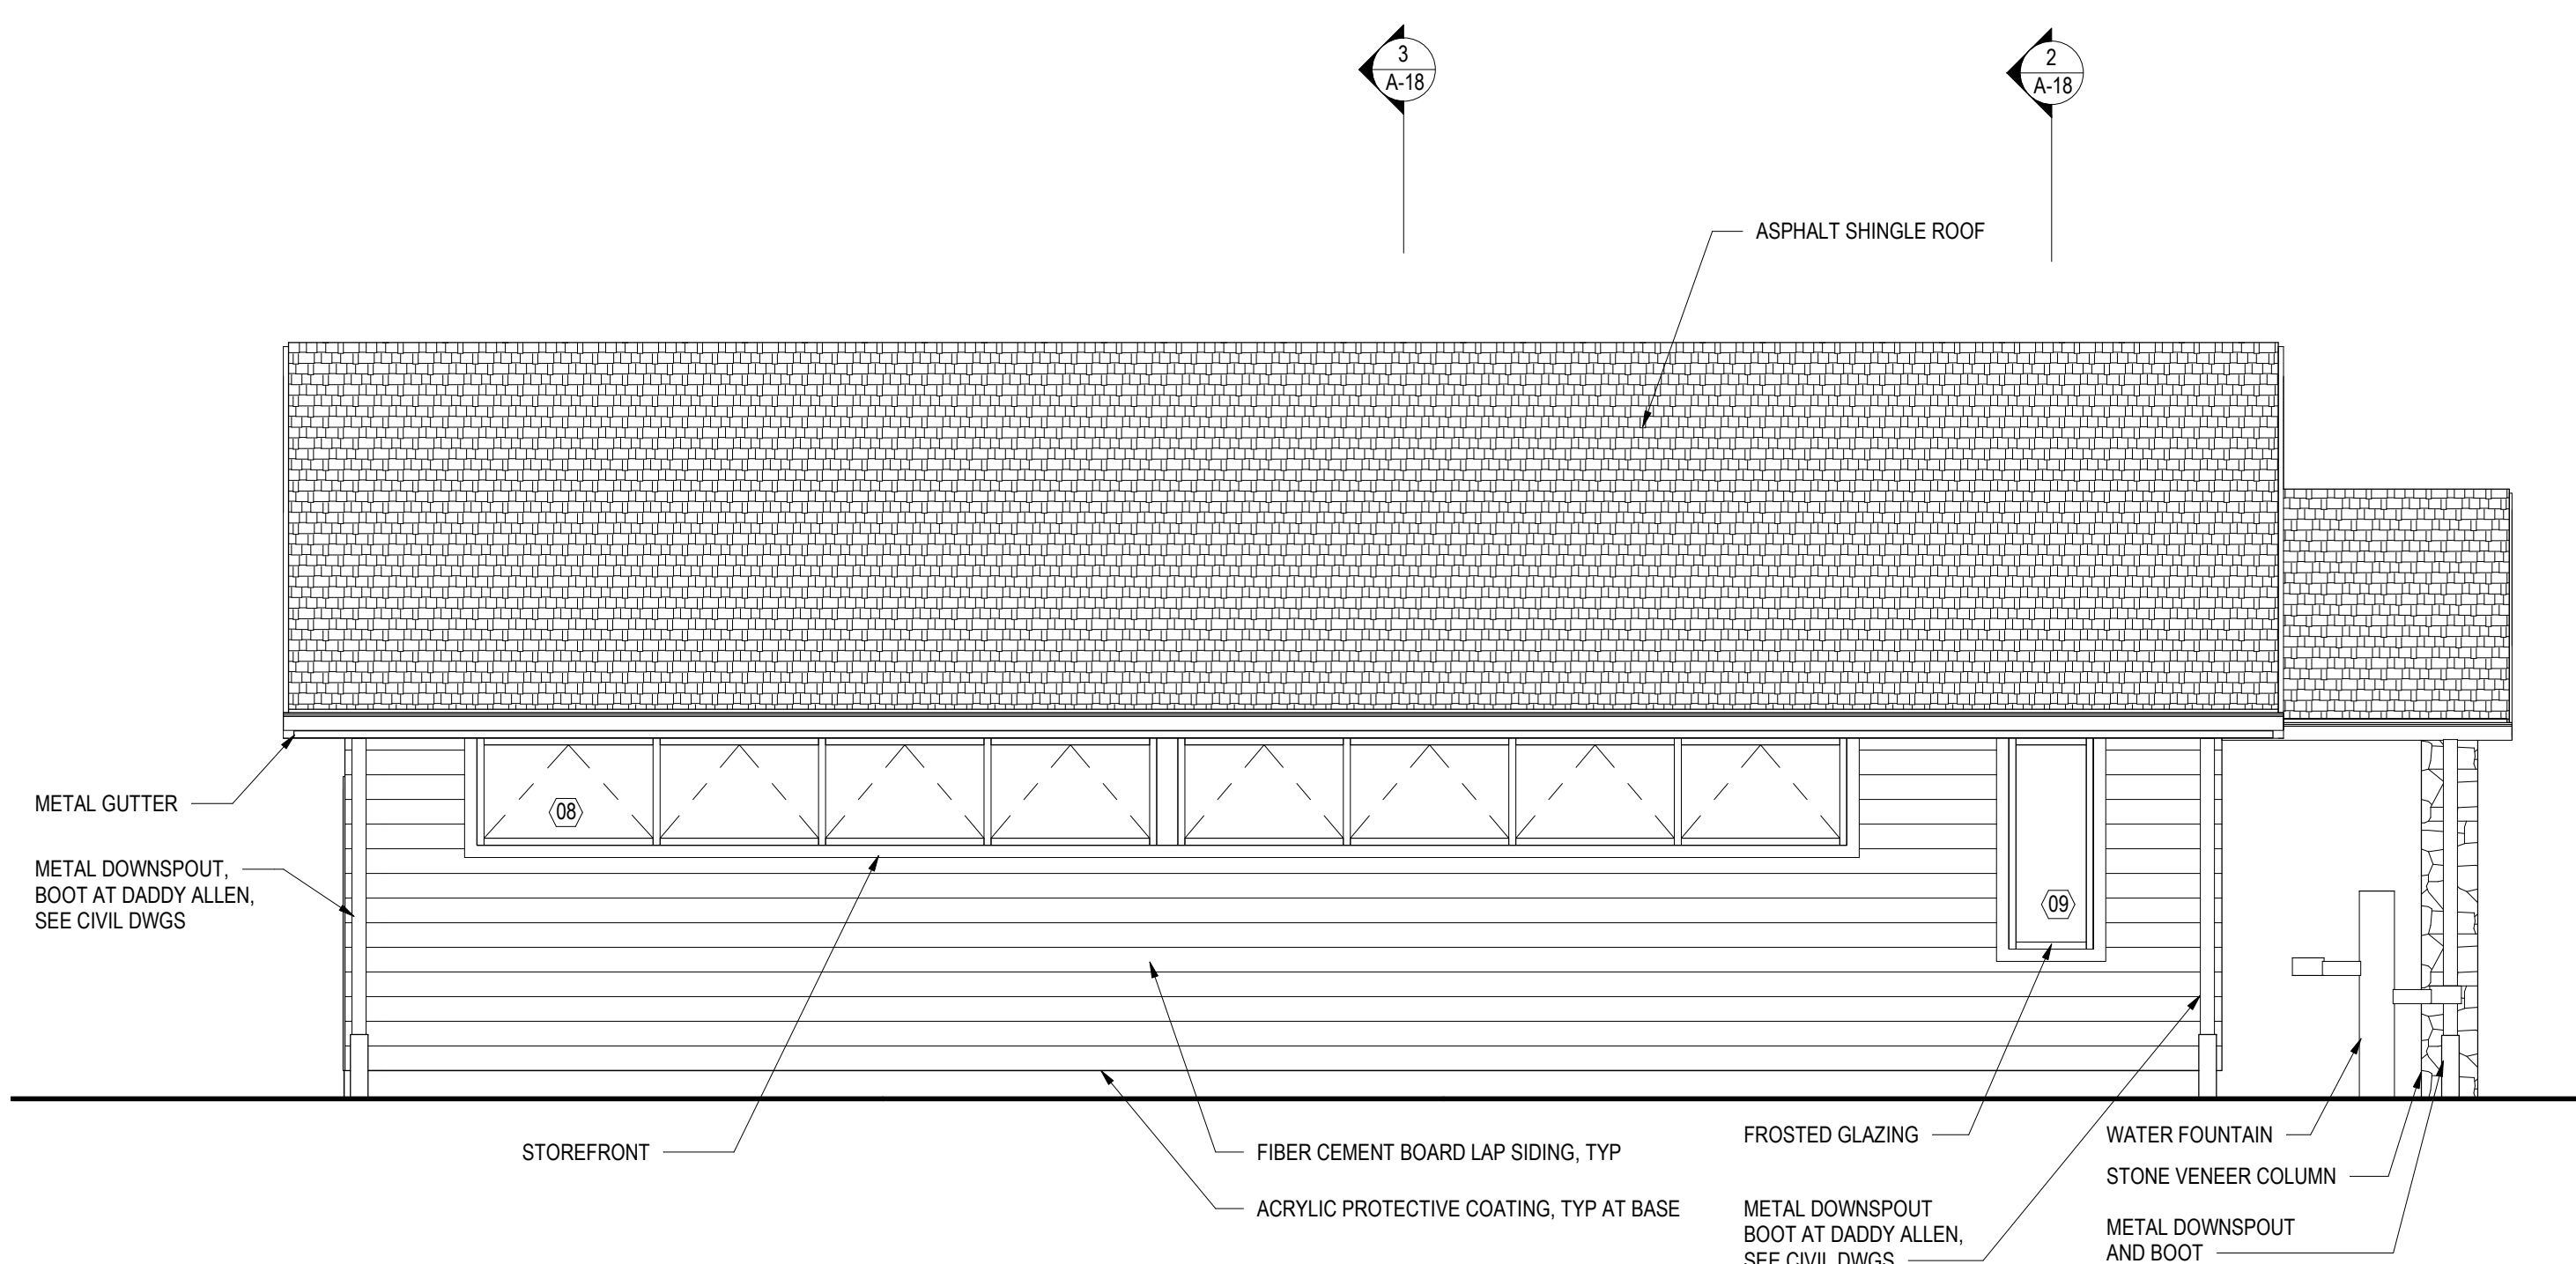


2 SIDE ELEVATION
A-17 1/4" = 1'-0"

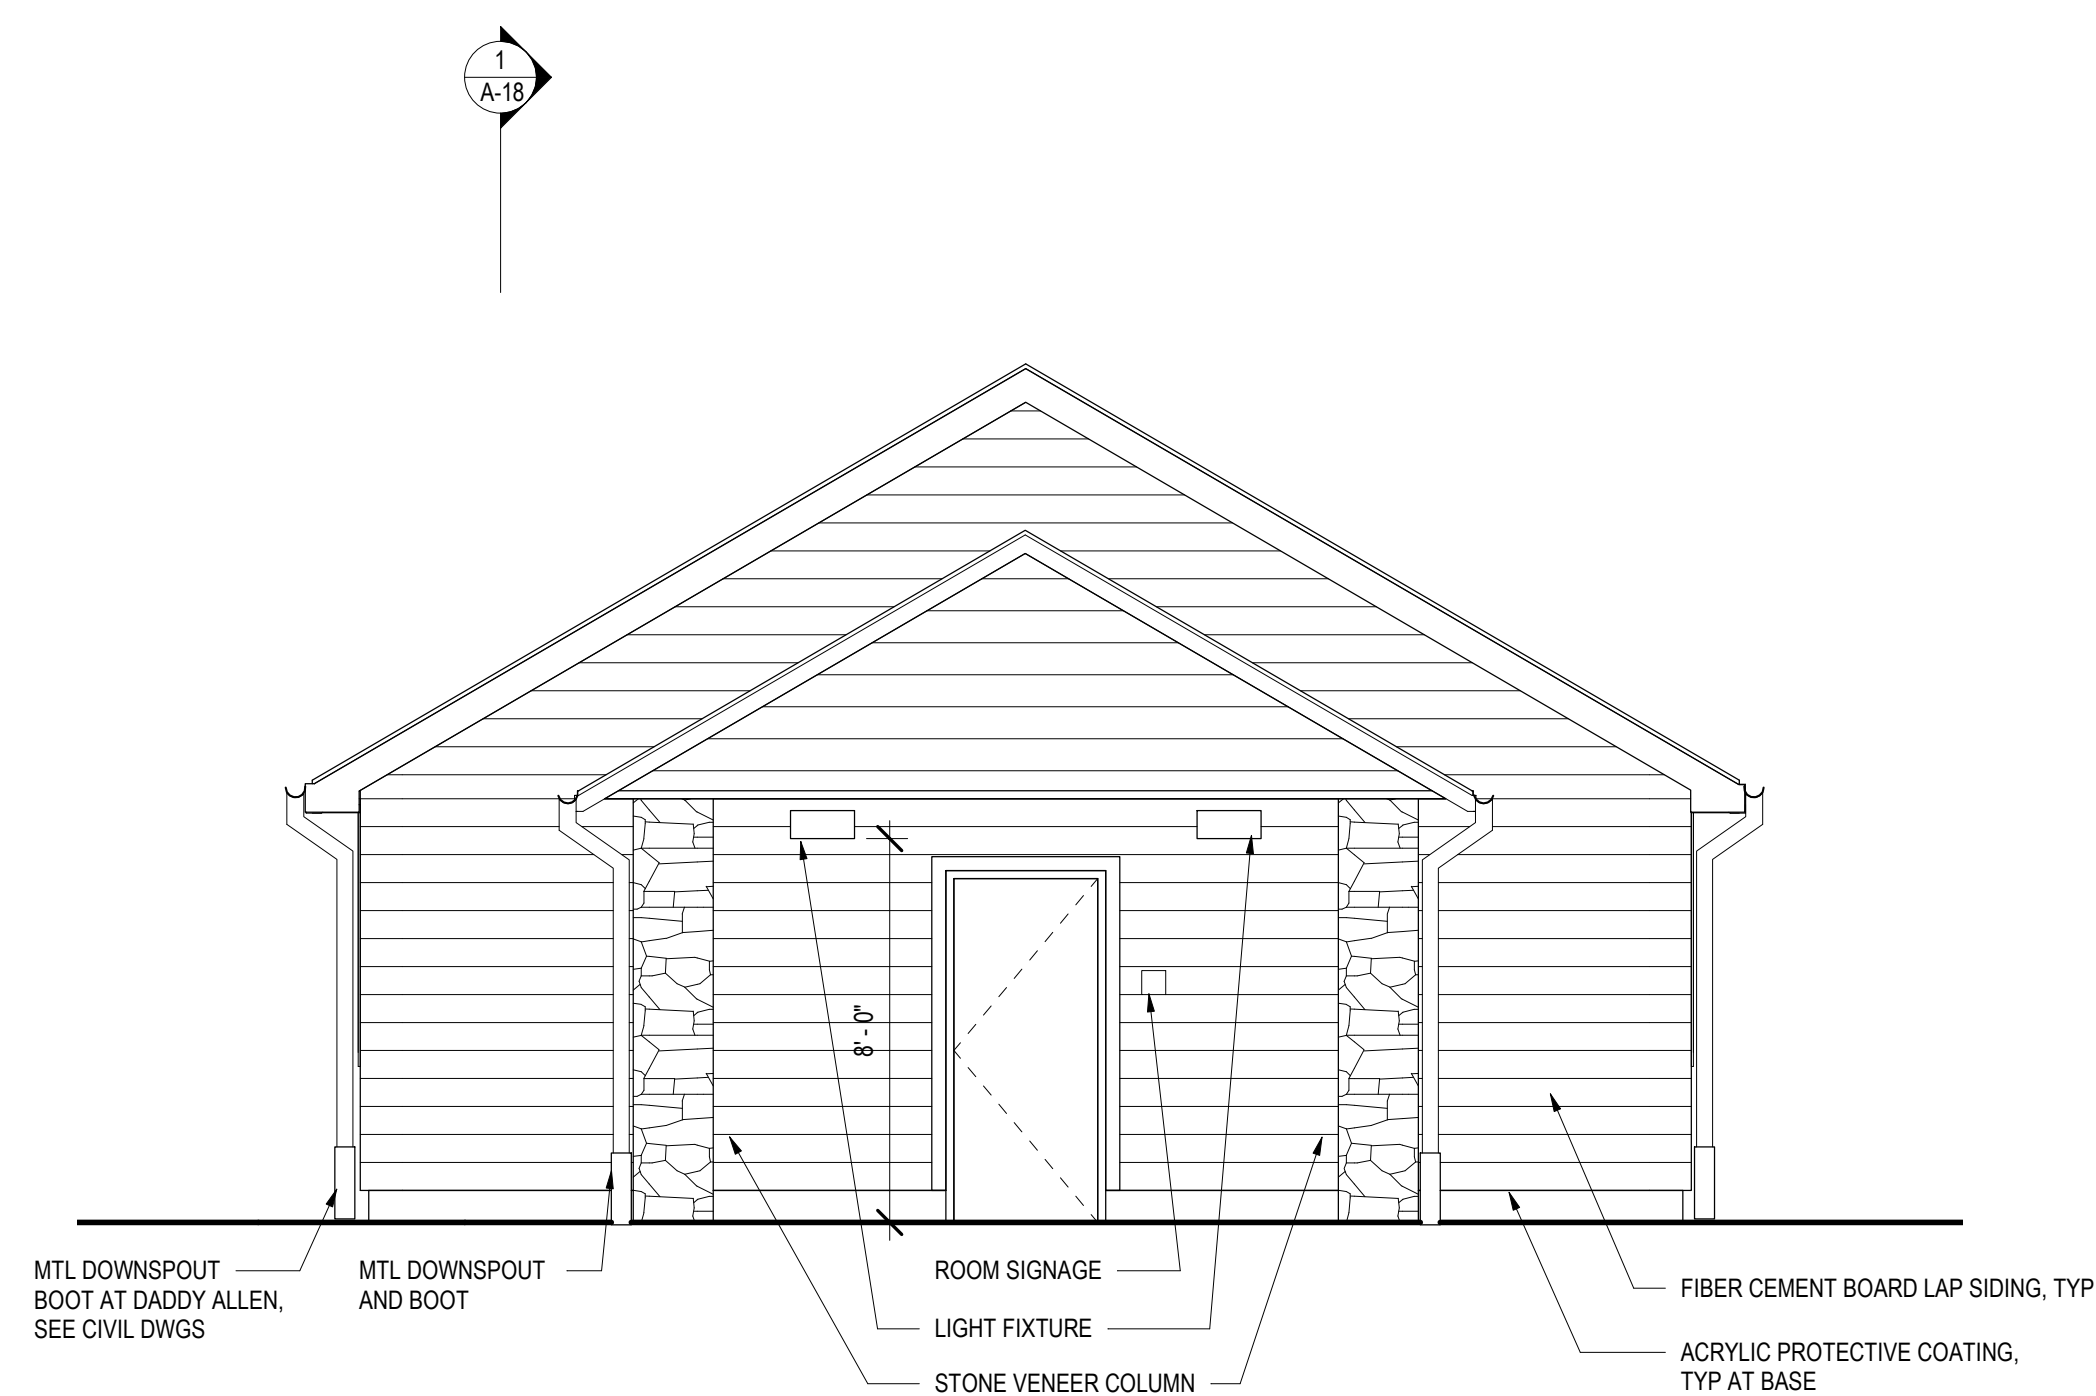

1 FRONT ELEVATION
A-17 1/4" = 1'-0"

CONSTRUCTION DOCUMENTS

RECORD REVISIONS

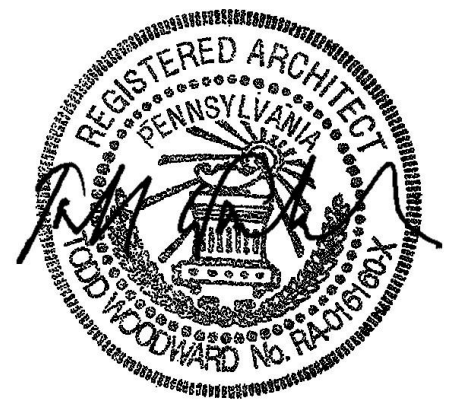

SIGNATURE DATE 03/05/2021

SMP ARCHITECTS
1600 WALNUT STREET, SECOND FLOOR
PHILADELPHIA, PENNSYLVANIA

COMMONWEALTH OF PENNSYLVANIA
DEPARTMENT OF GENERAL SERVICES
HARRISBURG, PENNSYLVANIA

D.G.S. PROJECT No. C-114-0006 PHASE 1

HICKORY RUN STATE PARK
LATRINE IMPROVEMENTS
DEPT of CONSERVATION AND NATURAL RESOURCES
WHITE HAVEN, CARBON COUNTY, PA

ORGANIZED GROUP CAMPING - TYPICAL
EXTERIOR ELEVATIONS

VERIFY SCALE


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ON ORIGINAL DRAWING: 0 1

IF BAR IS NOT ONE (1) INCH LONG, ADJUST SCALE ACCORDINGLY


CONTRACTOR SHALL FIELD VERIFY ALL DIMENSIONS. VARIANCE FROM CONTRACT DOCUMENTS NOT PERMITTED WITHOUT PROFESSIONAL & BUREAU OF CONSTRUCTION APPROVAL.

DRAWN BY M STRENSKI DATE 06/17/2022
CHECKED BY T WOODWARD SCALE AS NOTED


DRAWING No. A-17
71 OF 144

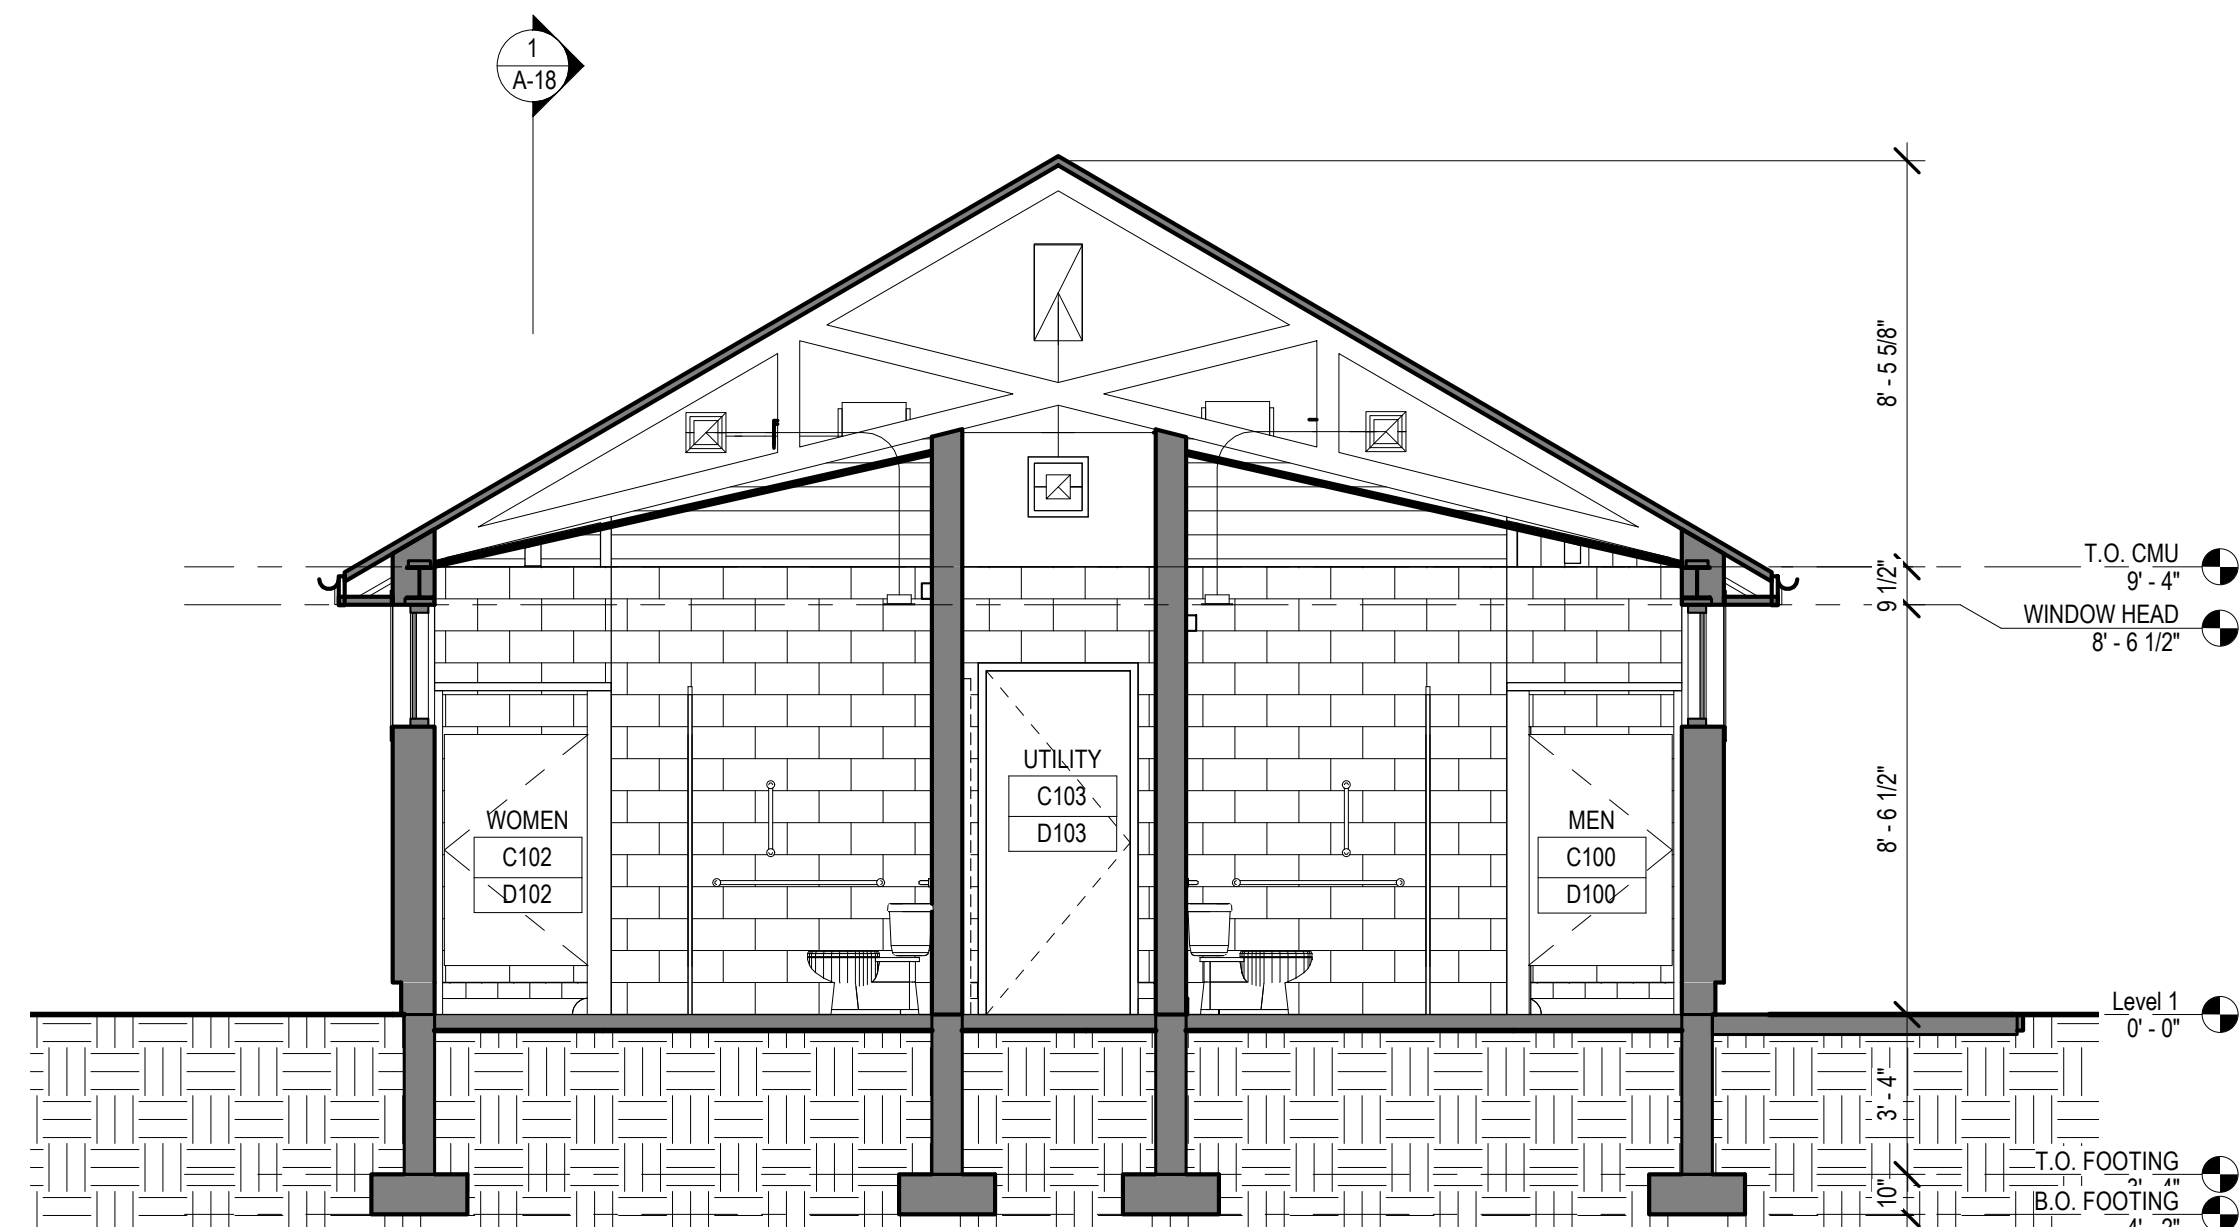

3 CROSS SECTION 2
A-18 1/4" = 1'-0"

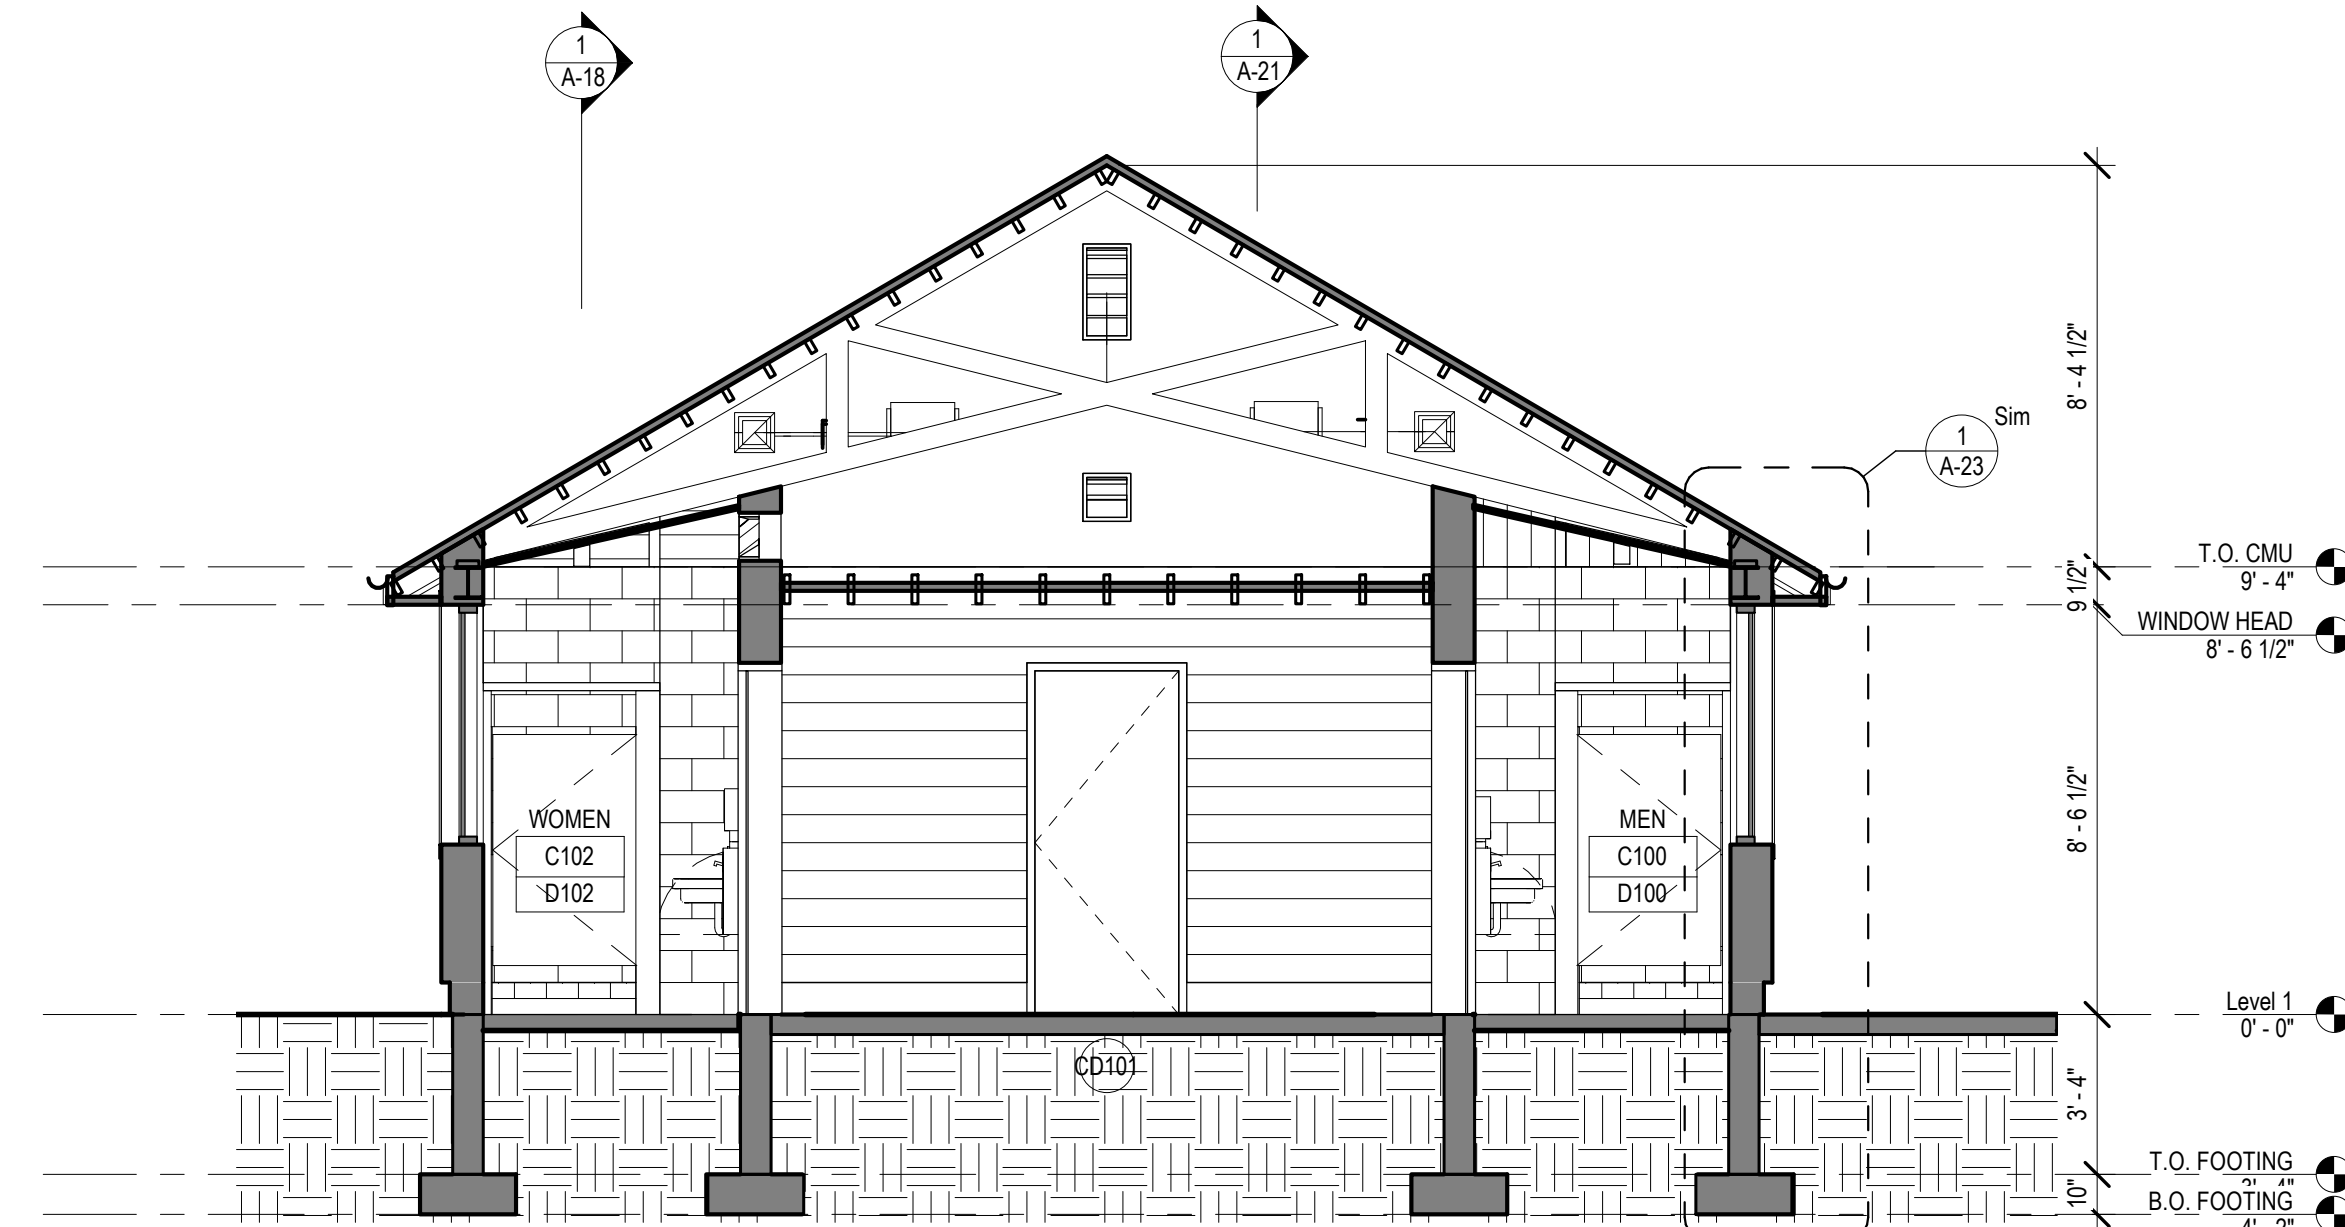

2 CROSS SECTION 1
A-18 1/4" = 1'-0"

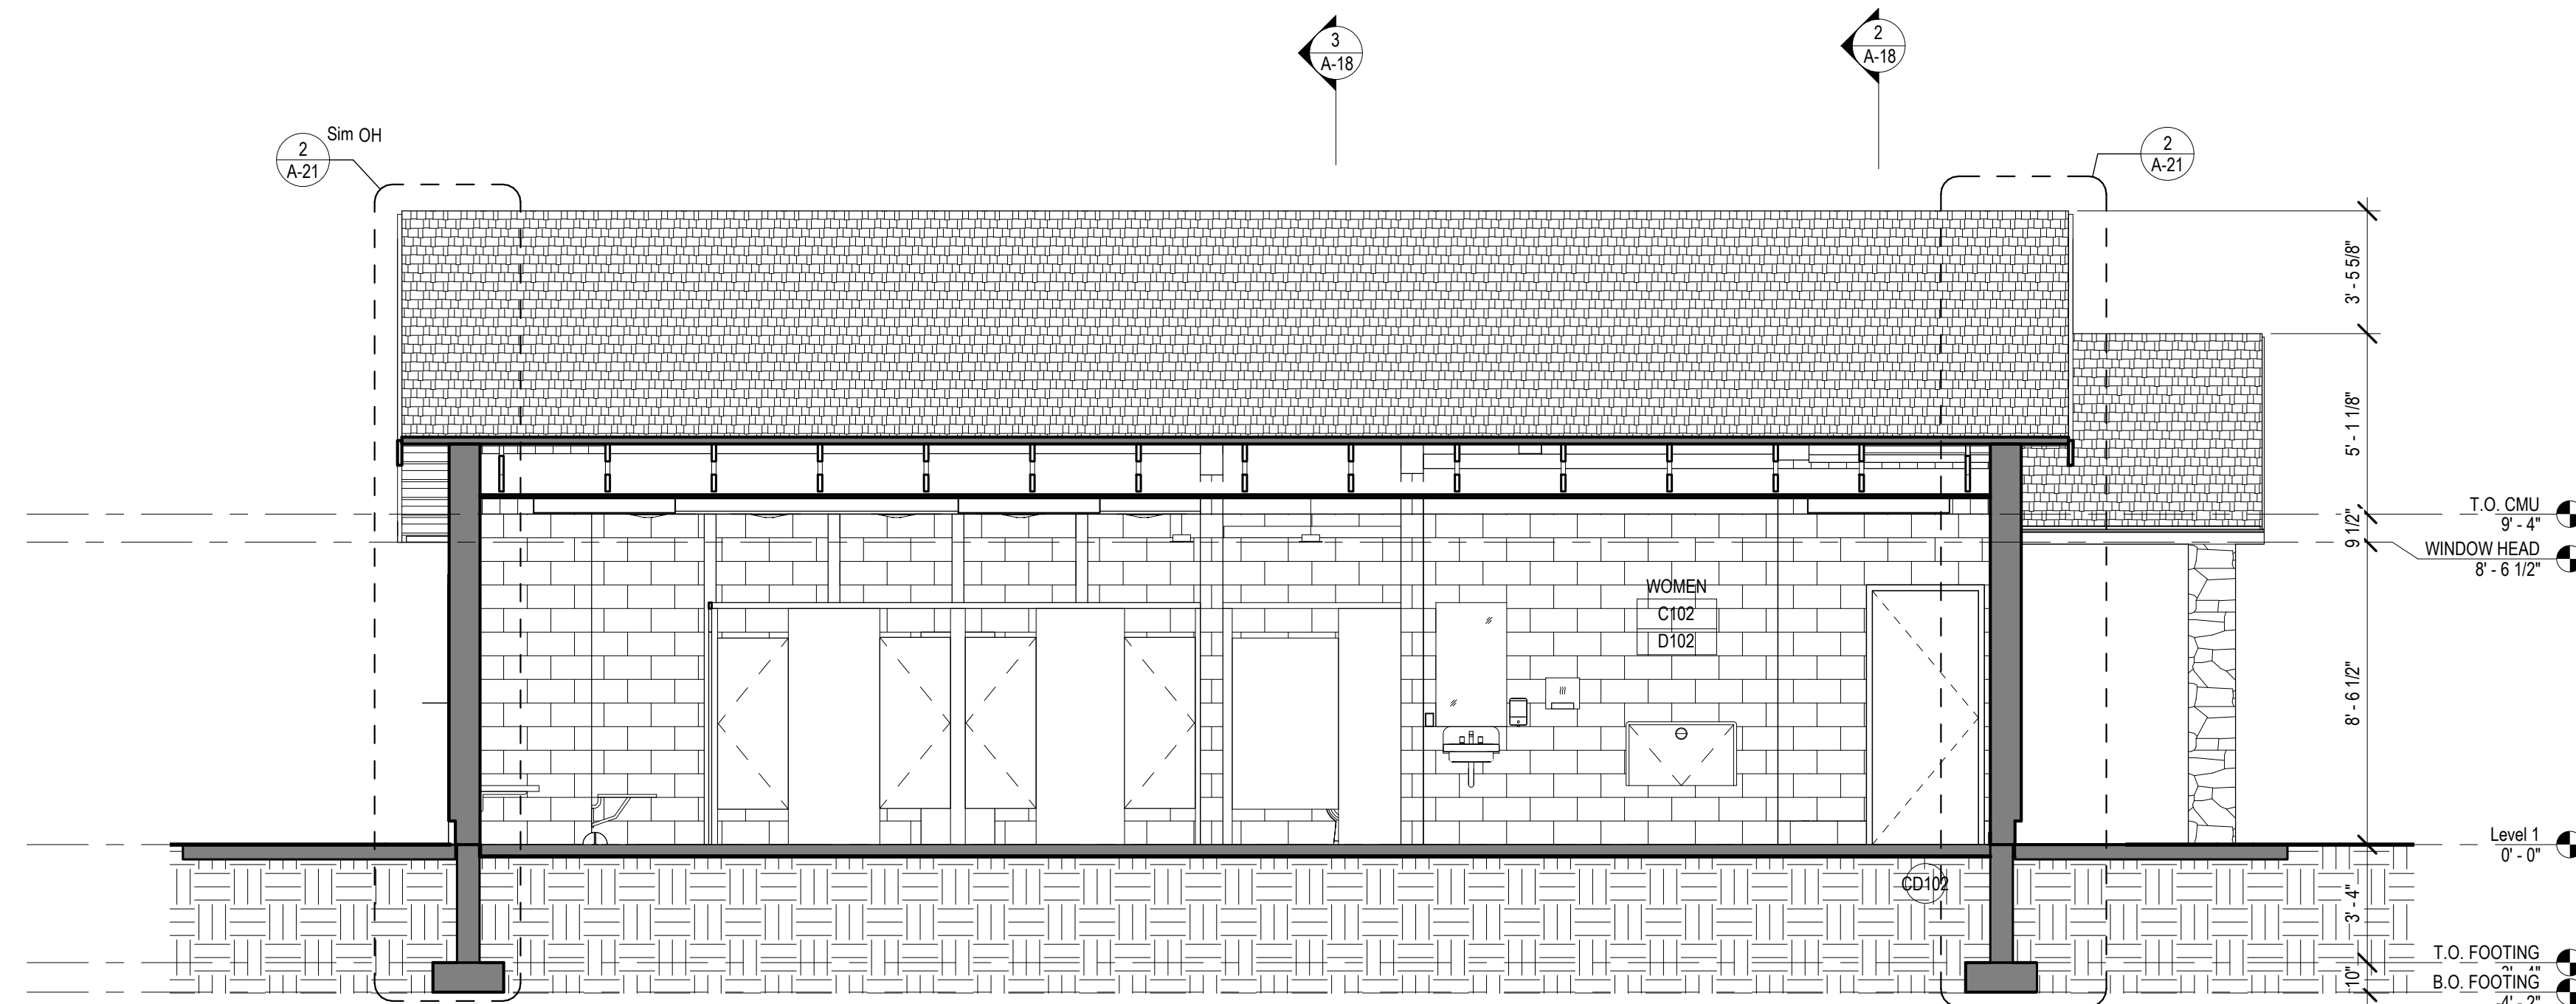

1 LONGITUDINAL SECTION
A-18 1/4" = 1'-0"

NOTE: 'C' ROOM NUMBER PREFIX REFERS TO CAMP DADDY ALLEN. 'D' ROOM NUMBER PREFIX REFERS TO CAMP SHEHAQUA

CONSTRUCTION DOCUMENTS

RECORD REVISIONS



SIGNATURE DATE 03/05/2021

SMP ARCHITECTS
1600 WALNUT STREET, SECOND FLOOR
PHILADELPHIA, PENNSYLVANIA

COMMONWEALTH OF PENNSYLVANIA
DEPARTMENT OF GENERAL SERVICES
HARRISBURG, PENNSYLVANIA

D.G.S. PROJECT No. C-114-0006 PHASE 1


HICKORY RUN STATE PARK
LATRINE IMPROVEMENTS
DEPT of CONSERVATION AND NATURAL RESOURCES
WHITE HAVEN, CARBON COUNTY, PA

ORGANIZED GROUP CAMPING - BUILDING SECTIONS


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ON ORIGINAL DRAWING: 0 1
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DRAWN BY M STRENSKI
CHECKED BY T WOODWARD
DATE 06/17/2022
SCALE AS NOTED

DRAWING No. A-18
72 OF 144

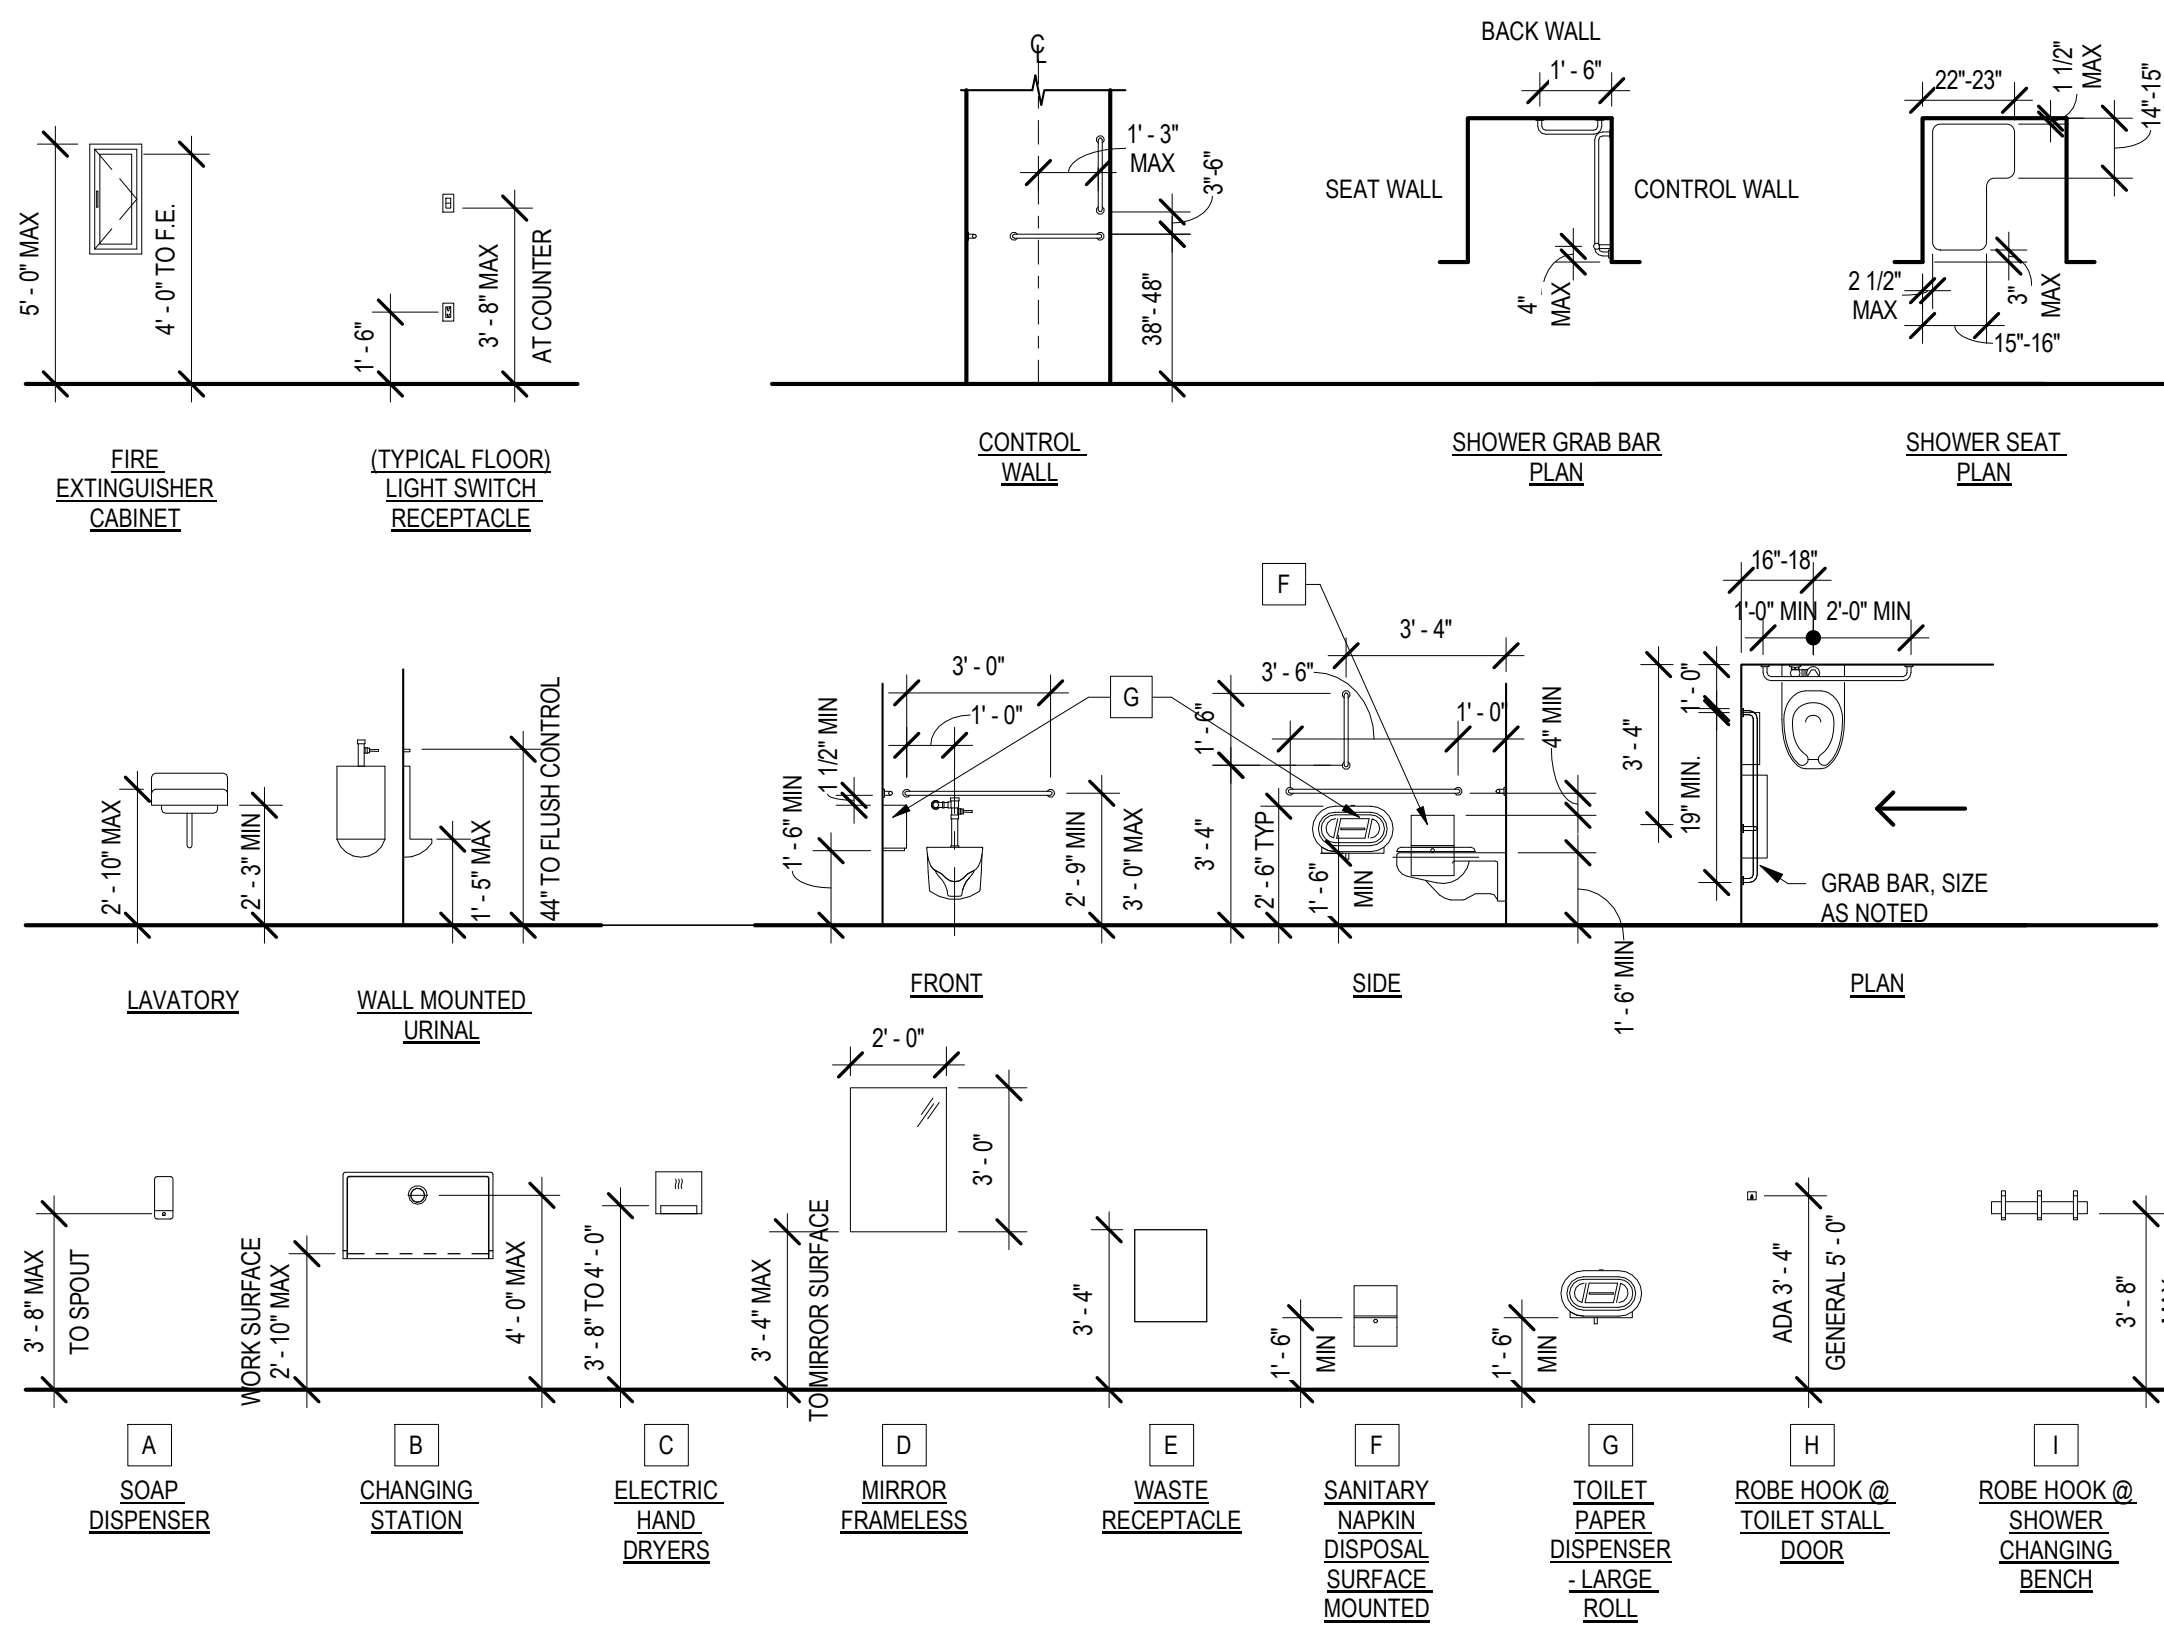


2 TYPICAL MOUNTING HEIGHTS
1/4" = 1'-0"

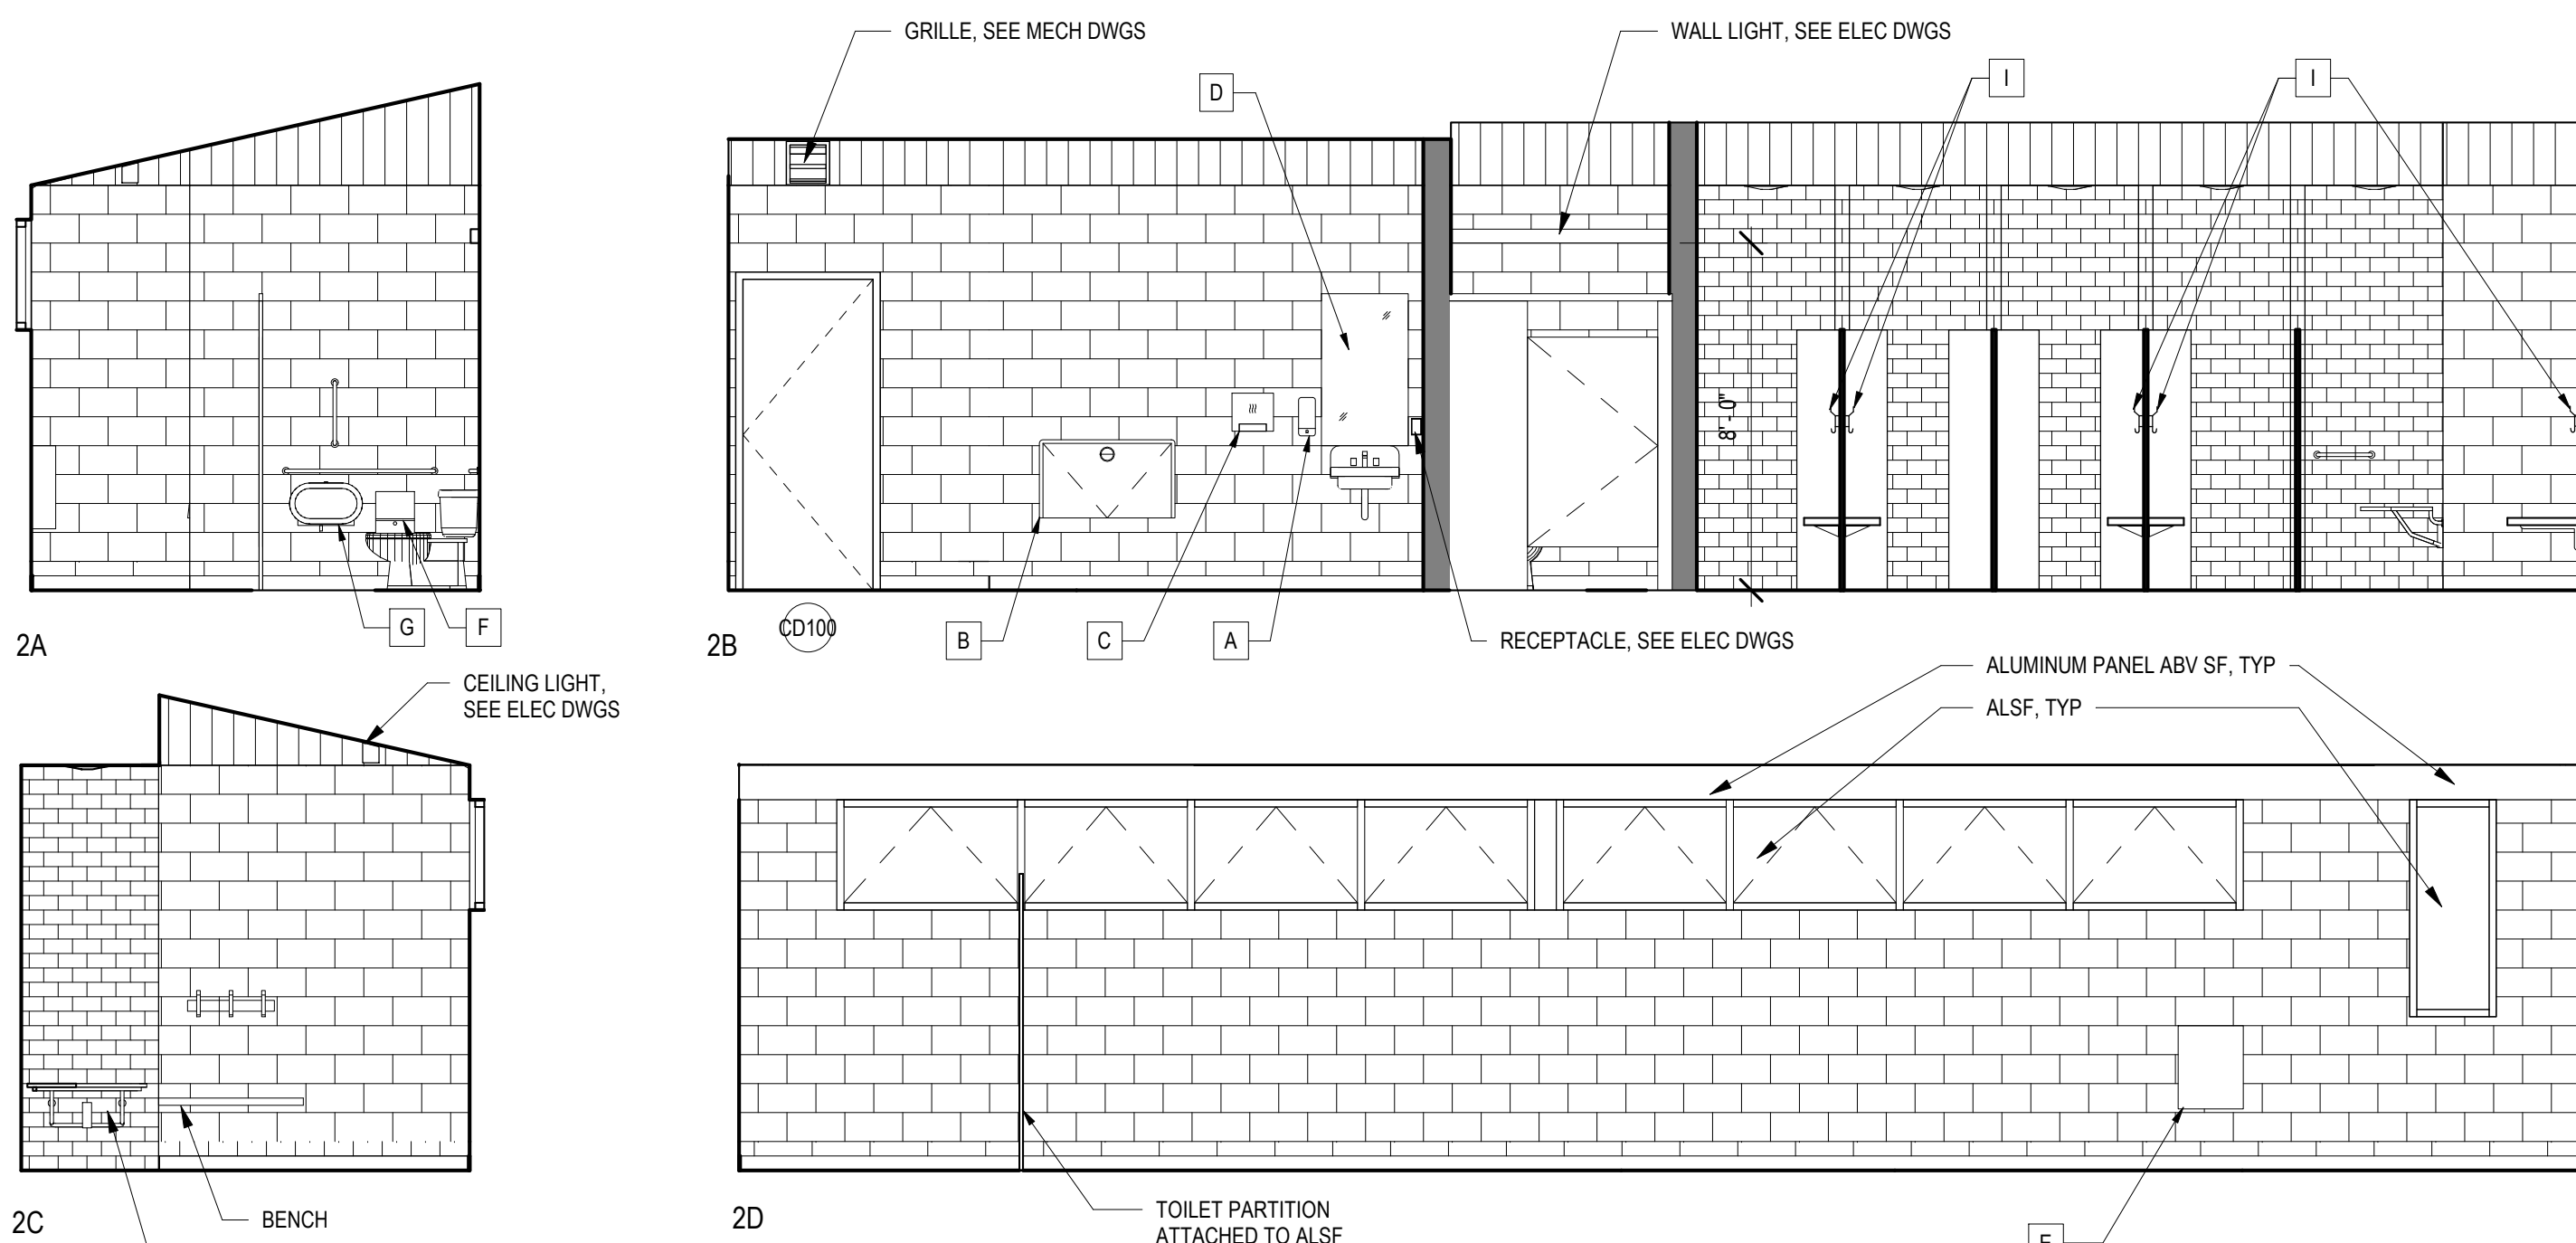


2 INTERIOR ELEVATIONS - C/D100 MEN/C/D102 WOMEN MAIN AREA
1/4" = 1'-0"

NOTE: 'C' ROOM NUMBER PREFIX REFERS TO CAMP DADDY ALLEN. 'D' ROOM NUMBER PREFIX REFERS TO CAMP SHEHAQUA

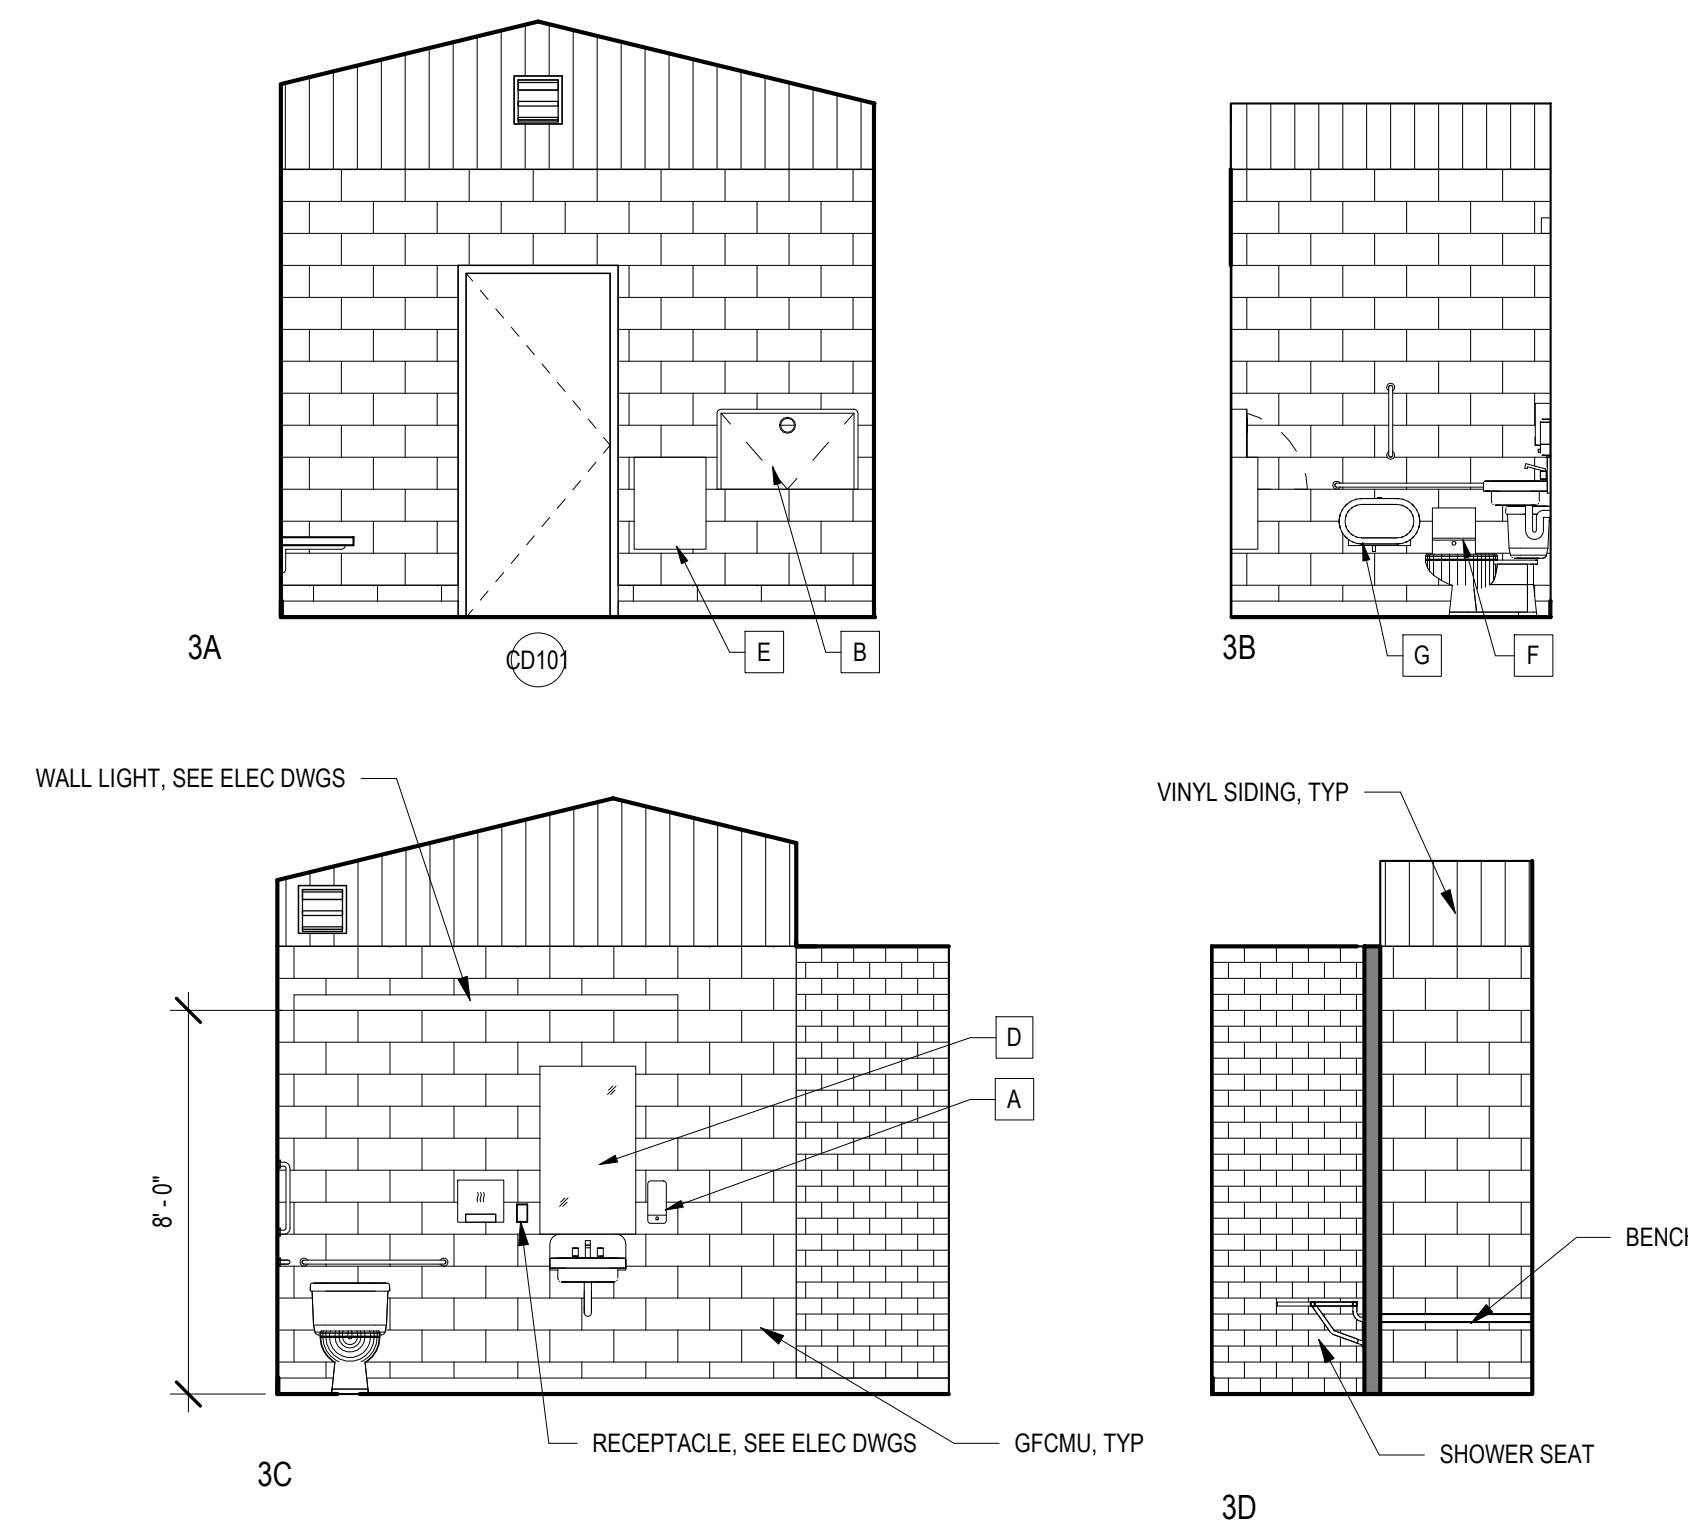

3 INTERIOR ELEVATIONS - C/D101 RESTROOM
1/4" = 1'-0"

NOTE: 'C' ROOM NUMBER PREFIX REFERS TO CAMP DADDY ALLEN. 'D' ROOM NUMBER PREFIX REFERS TO CAMP SHEHAQUA

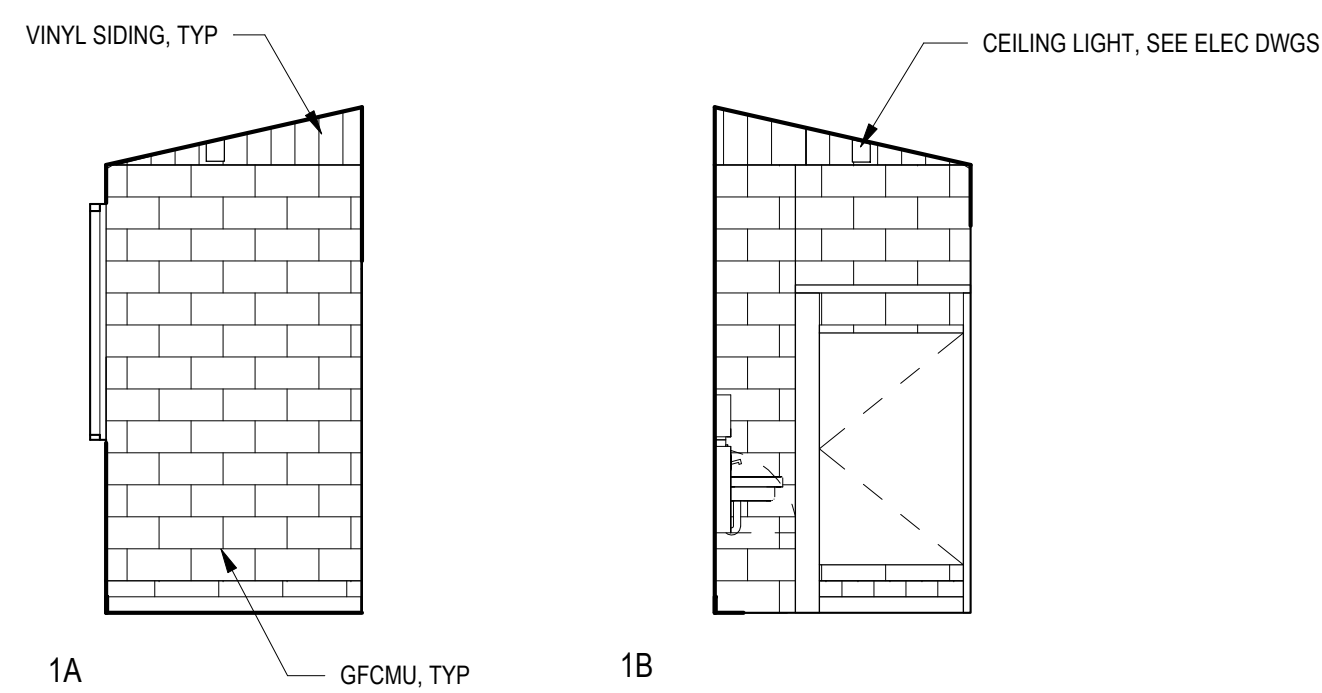


1 INT ELEVATIONS - C/D100 MEN/C/D102 WOMEN ENTRY AREA
1/4" = 1'-0"

NOTE: 'C' ROOM NUMBER PREFIX REFERS TO CAMP DADDY ALLEN. 'D' ROOM NUMBER PREFIX REFERS TO CAMP SHEHAQUA

CONSTRUCTION DOCUMENTS

RECORD REVISIONS

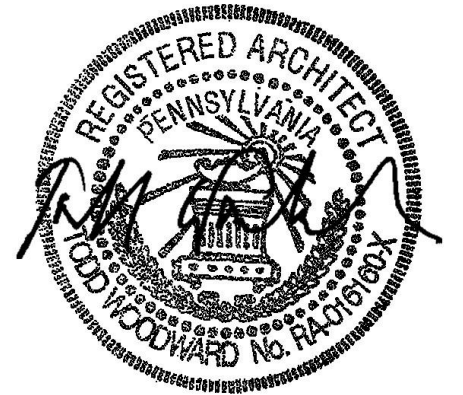

03/05/2021
DATE

SMP ARCHITECTS
1600 WALNUT STREET, SECOND FLOOR
PHILADELPHIA, PENNSYLVANIA

COMMONWEALTH OF PENNSYLVANIA
DEPARTMENT OF GENERAL SERVICES
HARRISBURG, PENNSYLVANIA

D.G.S. PROJECT No. C-114-0006 PHASE 1

HICKORY RUN STATE PARK
LATRINE IMPROVEMENTS
DEPT of CONSERVATION AND NATURAL RESOURCES
WHITE HAVEN, CARBON COUNTY, PA

ORGANIZED GROUP CAMPING - INTERIOR ELEVATIONS

VERIFY SCALE


BAR IS ONE (1) INCH LONG
ON ORIGINAL DRAWING: 0 1

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DRAWN BY: M STRENSKI
CHECKED BY: T WOODWARD
DATE: 06/17/2022
SCALE: AS NOTED

DRAWING No. **A-19**
73 OF 144



- RCP LEGEND**
- 4' x 4' SURFACED MOUNTED LED LIGHT
 - LED SHOWER LIGHT
 - EMERGENCY LIGHT
 - WALL MOUNTED LED UP/DOWN LIGHT
 - BUILDING MOUNTED EXTERIOR LED LIGHT
 - LED STRIP LIGHT
 - RECESSED EXTERIOR CAN LIGHT
 - OCCUPANCY SENSOR
 - OCCUPANCY SENSOR
 - POWER PACK
 - TUBULAR SKYLIGHT
 - SUPPLY DIFFUSER
 - RETURN DIFFUSER
 - VINYL PANELING
 - FIBER CEMENT SOFFIT PANELS

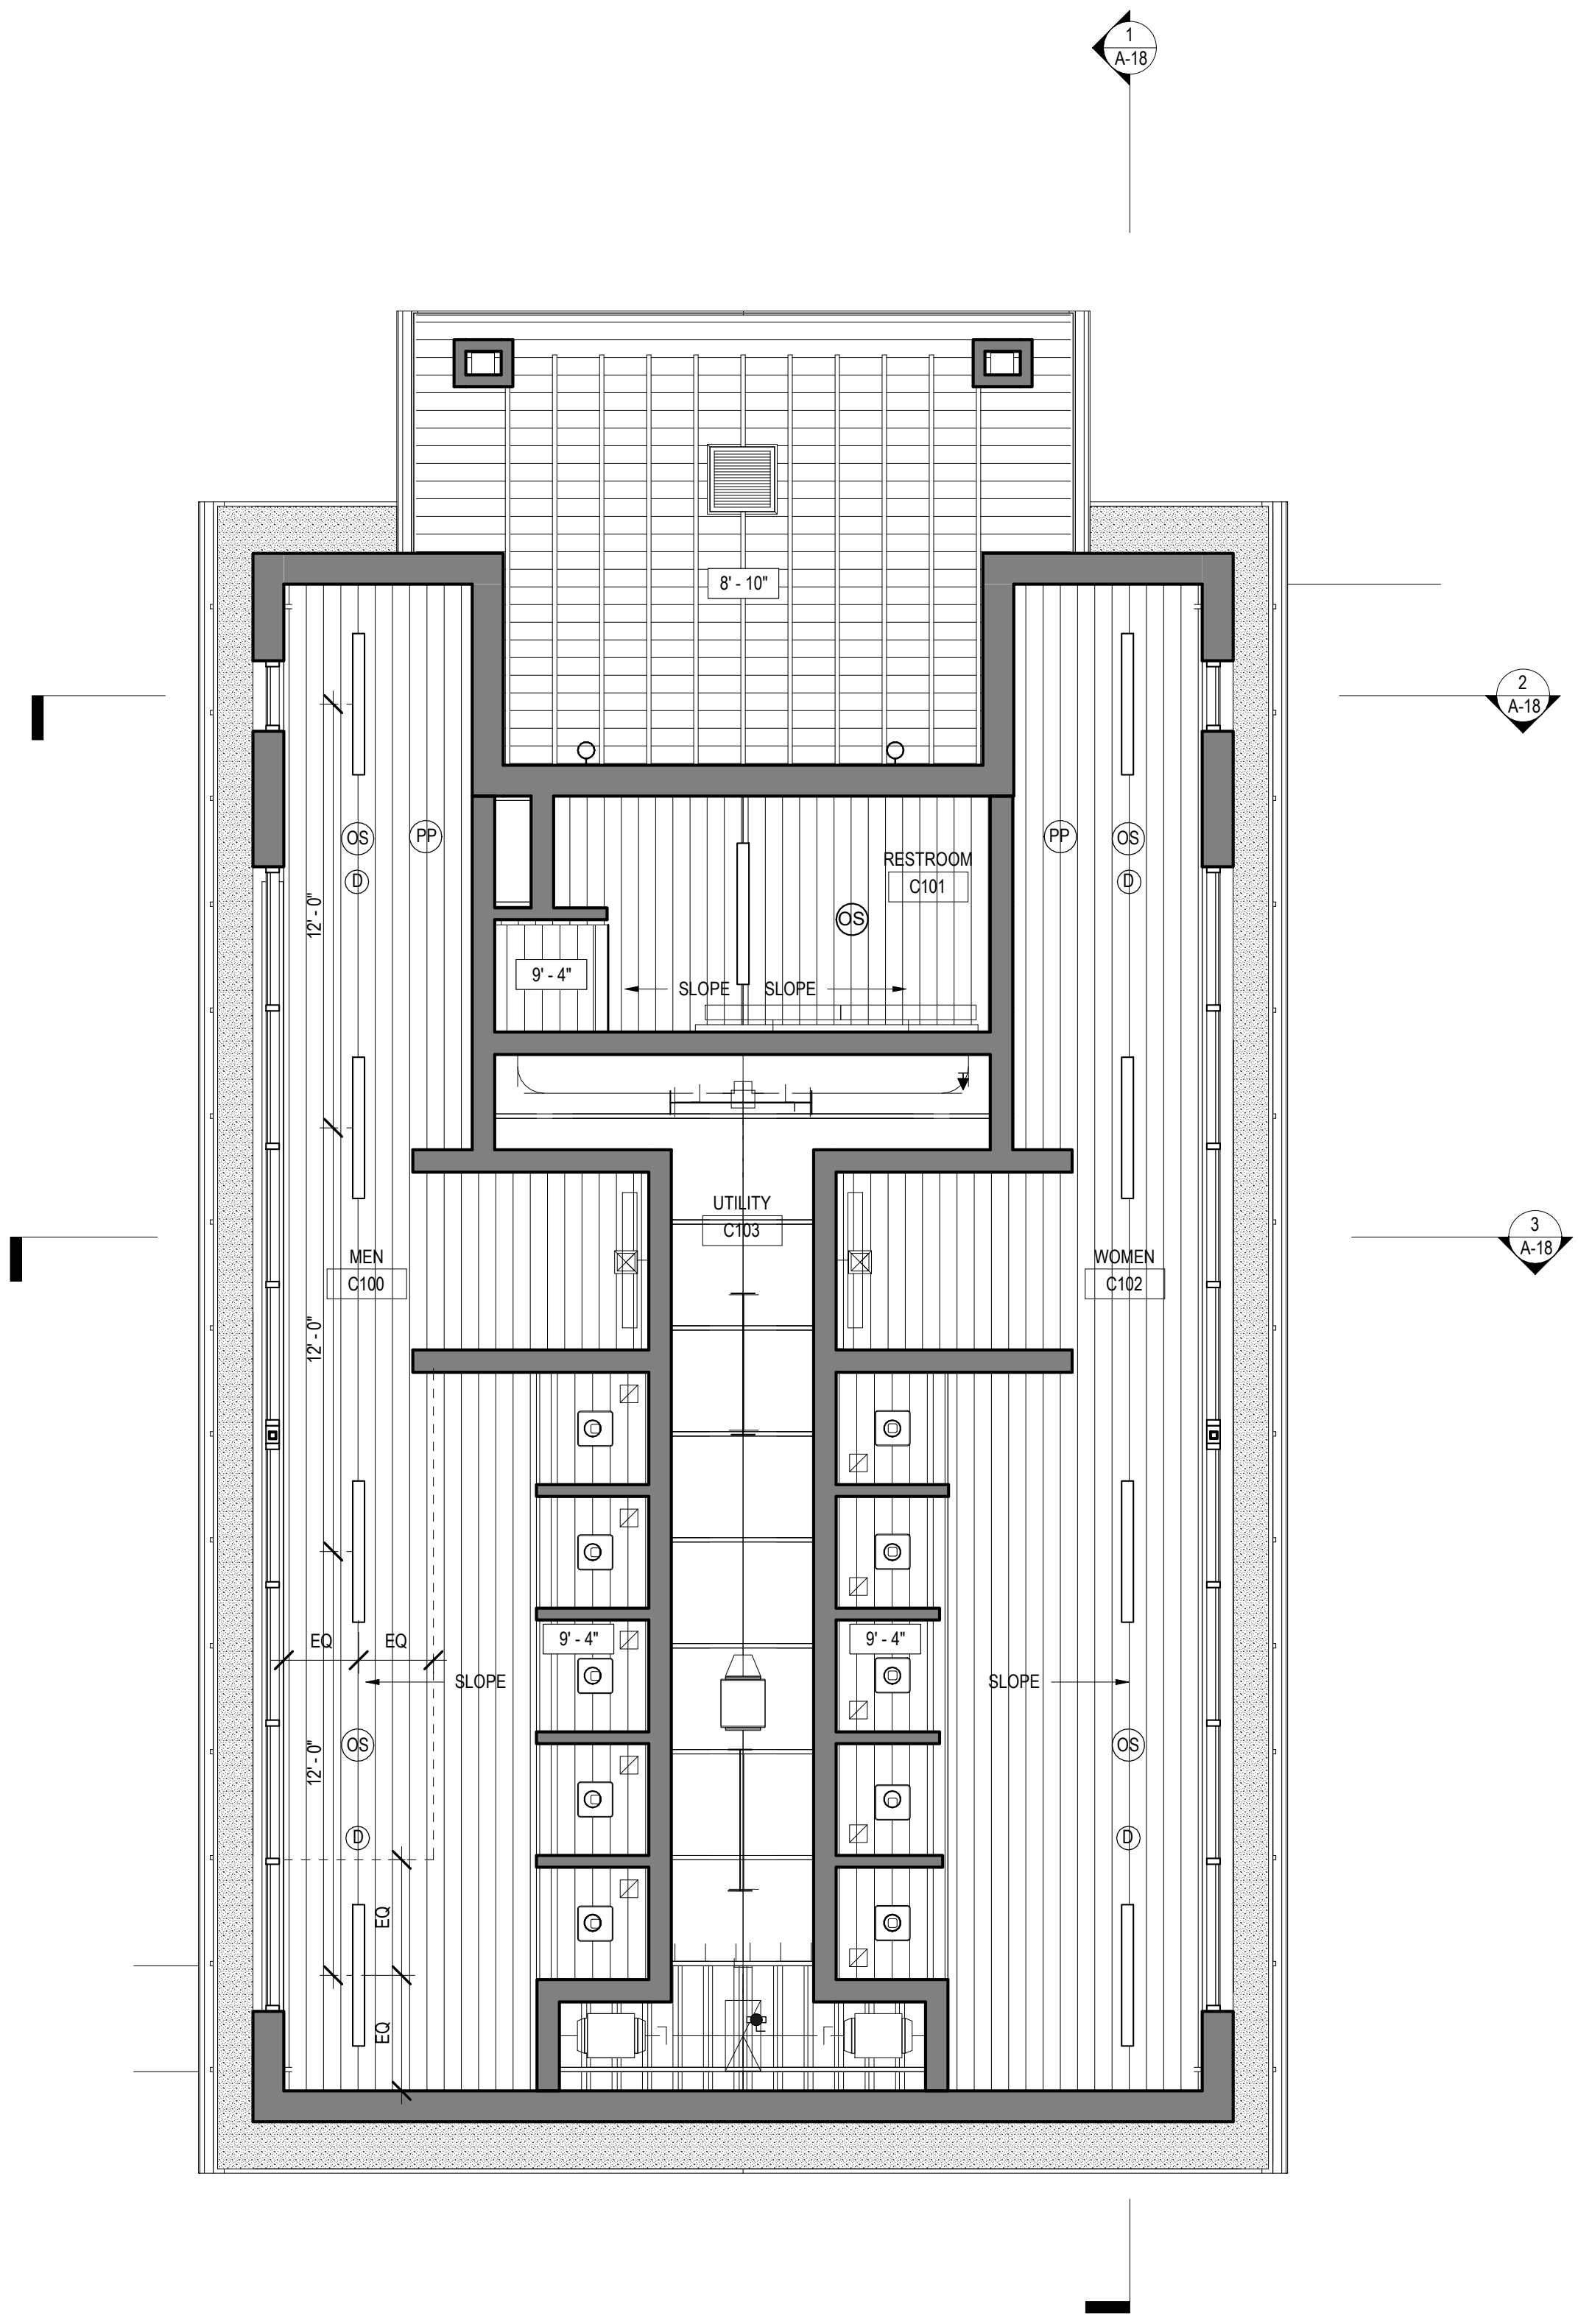CONSTRUCTION DOCUMENTS

RECORD REVISIONS



03/05/2021
SIGNATURE DATE

SMP ARCHITECTS
1600 WALNUT STREET, SECOND FLOOR
PHILADELPHIA, PENNSYLVANIA

COMMONWEALTH OF PENNSYLVANIA
DEPARTMENT OF GENERAL SERVICES
HARRISBURG, PENNSYLVANIA

D.G.S. PROJECT No. C-114-0006 PHASE 1

HICKORY RUN STATE PARK
LATRINE IMPROVEMENTS
DEPT of CONSERVATION AND NATURAL RESOURCES
WHITE HAVEN, CARBON COUNTY, PA

ORGANIZED GROUP CAMPING - REFLECTED
CEILING PLAN


VERIFY SCALE
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DRAWN BY	DATE
M STRENSKI	06/17/2022
CHECKED BY	SCALE
T WOODWARD	AS NOTED


DRAWING No.
A-20
74 OF 144

1 OGC - SHEHAQUA / DADDY ALLEN
A-20 1/4" = 1'-0"

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


2 WALL SECTION - OGc GABLE ENTRY SIDE
A-21 3/4" = 1'-0"

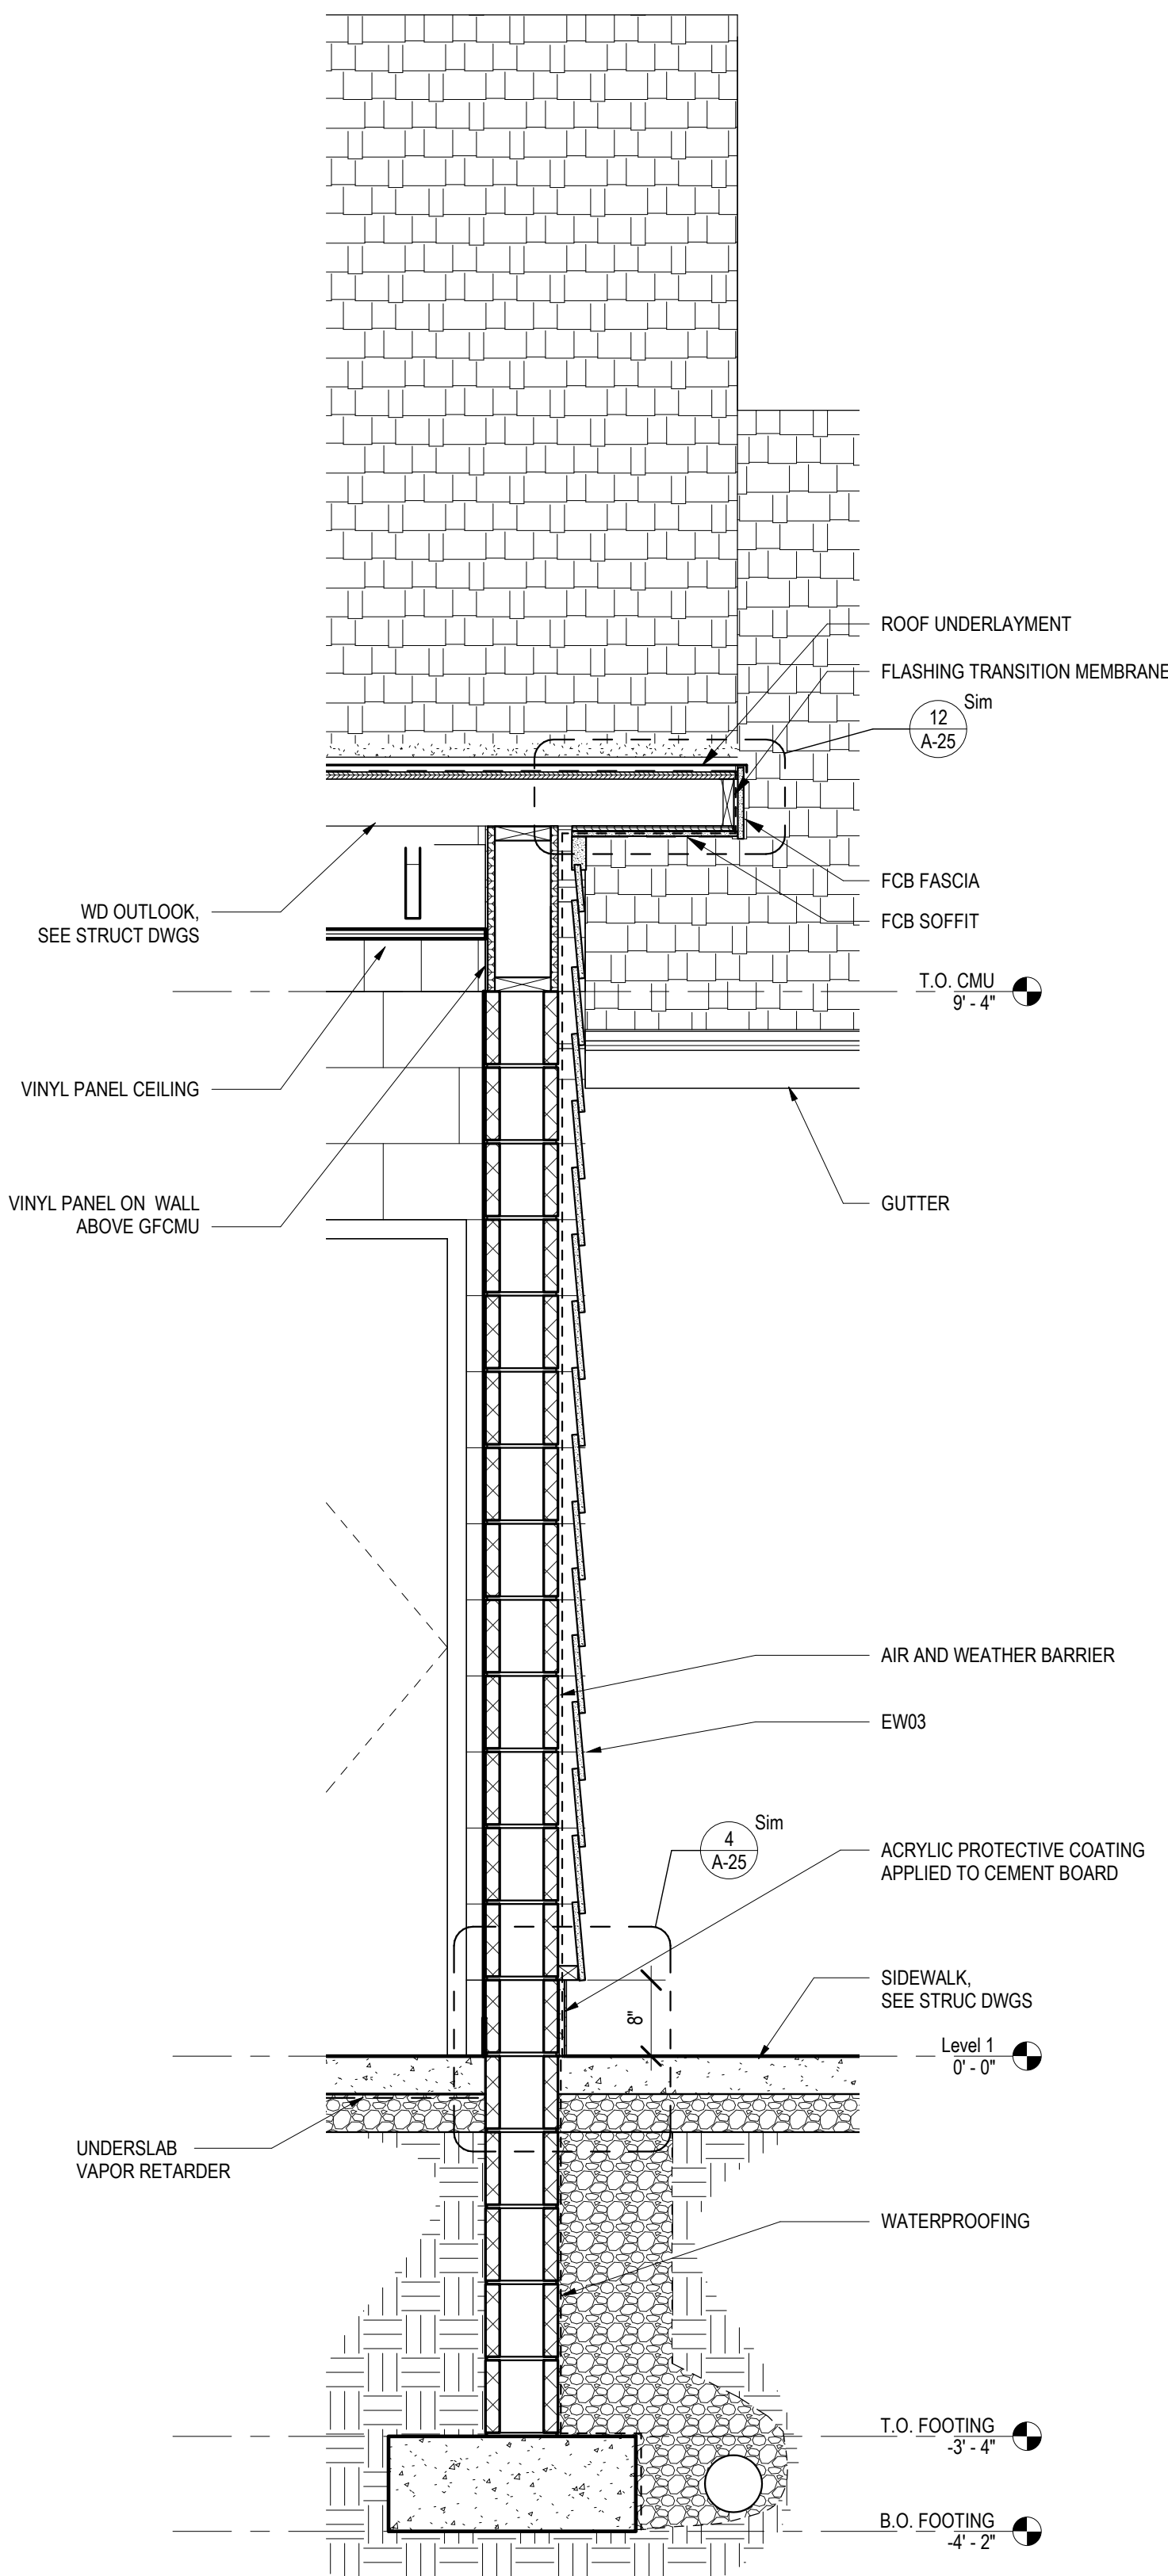


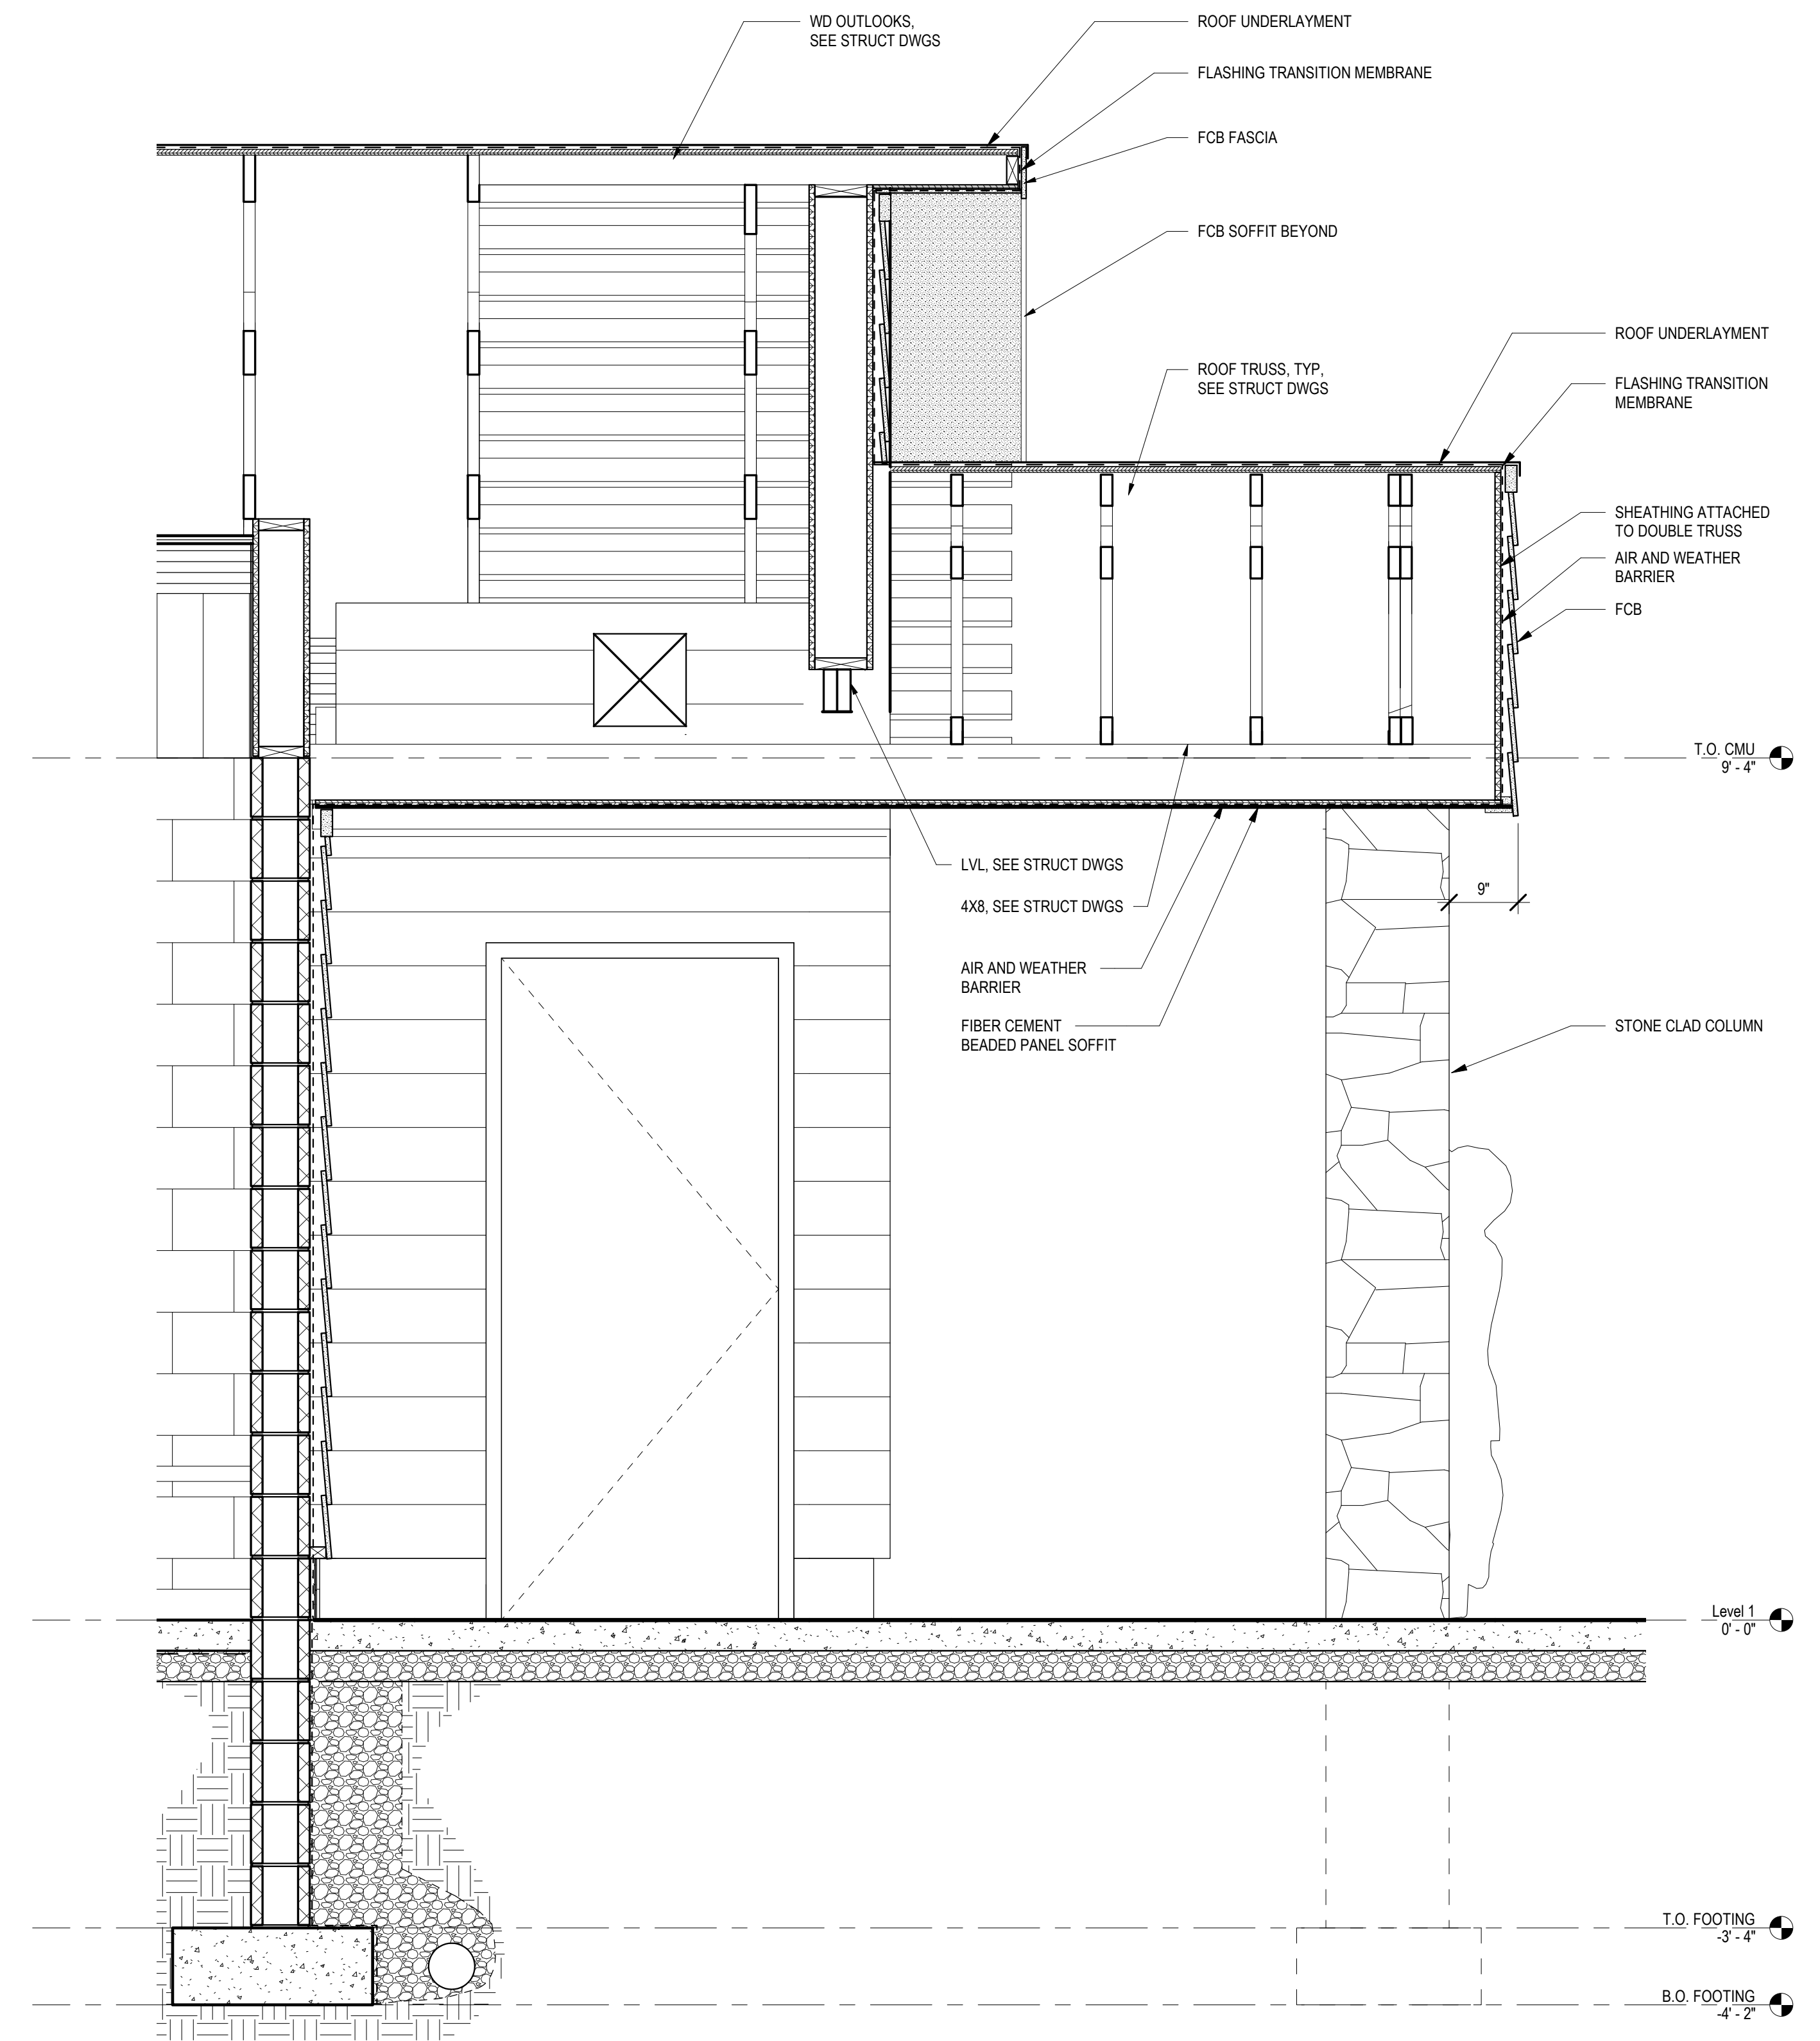1 WALL SECTION - OGc ENTRY PORCH
A-21 3/4" = 1'-0"


VERIFY SCALE
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CONSTRUCTION DOCUMENTS	
RECORD REVISIONS	
 SIGNATURE: T. WOODWARD DATE: 03/05/2021	
SMP ARCHITECTS 1600 WALNUT STREET, SECOND FLOOR PHILADELPHIA, PENNSYLVANIA	
COMMONWEALTH OF PENNSYLVANIA DEPARTMENT OF GENERAL SERVICES HARRISBURG, PENNSYLVANIA	
D.G.S. PROJECT No. C-114-0006 PHASE 1	
HICKORY RUN STATE PARK LATRINE IMPROVEMENTS DEPT of CONSERVATION AND NATURAL RESOURCES WHITE HAVEN, CARBON COUNTY, PA	
ORGANIZED GROUP CAMPING - WALL SECTIONS	
CONTRACTOR SHALL FIELD VERIFY ALL DIMENSIONS. VARIANCE FROM CONTRACT DOCUMENTS NOT PERMITTED WITHOUT PROFESSIONAL & BUREAU OF CONSTRUCTION APPROVAL.	DRAWN BY: M STRENSKI CHECKED BY: T WOODWARD DATE: 06/17/2022 SCALE: AS NOTED
DRAWING No. A-21 75 OF 144	

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 PLOTTED BY: Megan H. Sheehan
 LAST SAVER: 2022/06/04 12:14 PM
 PLOTTED: 2022/06/04 10:35 AM

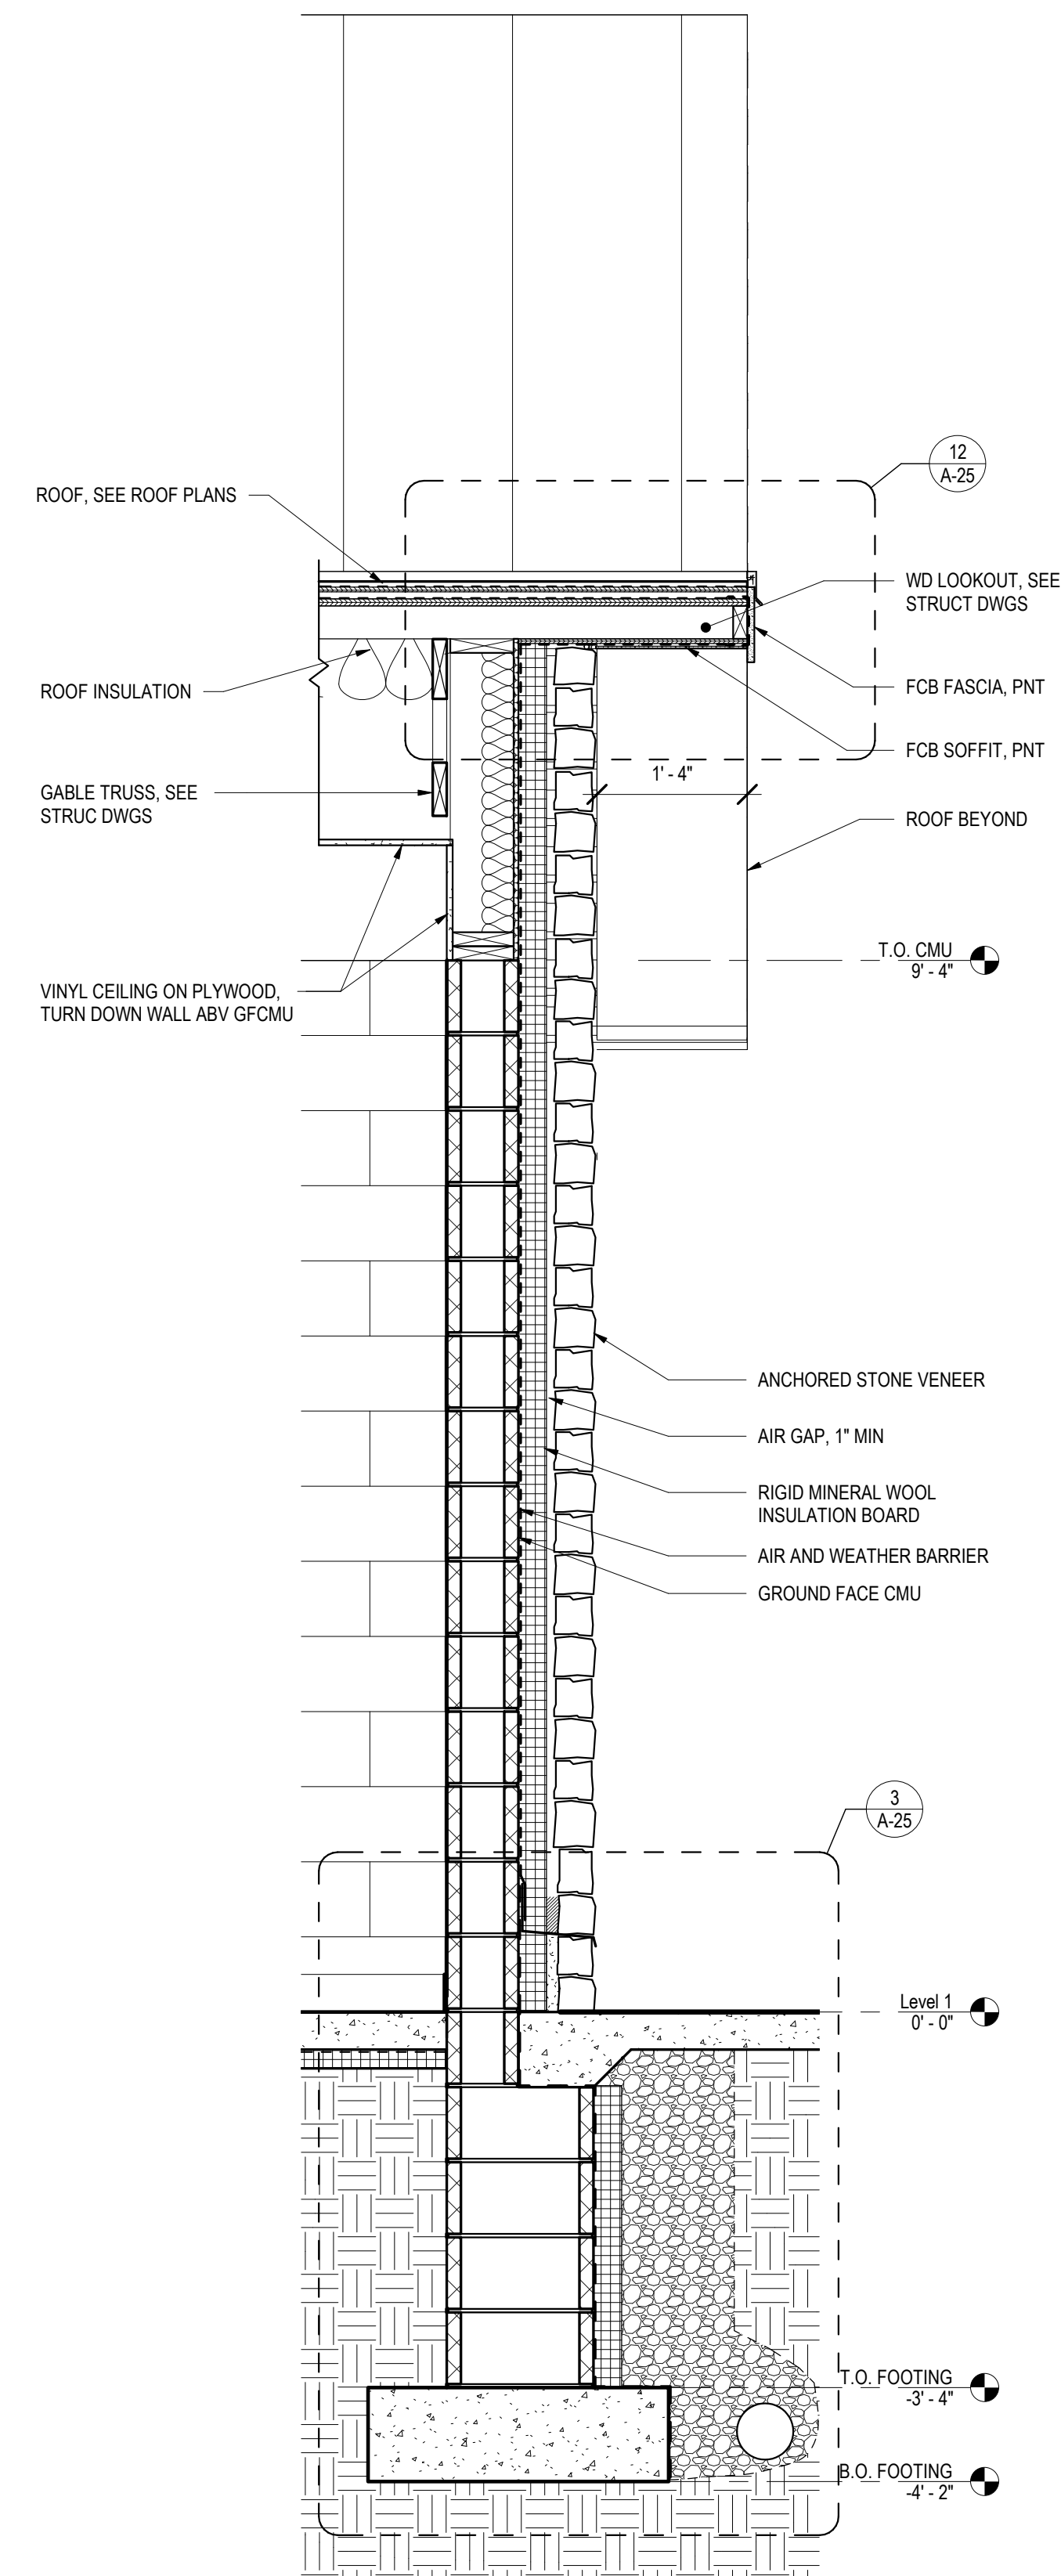

2 TYP WALL SECTION - STONE GABLE END
A-23 3/4" = 1'-0"

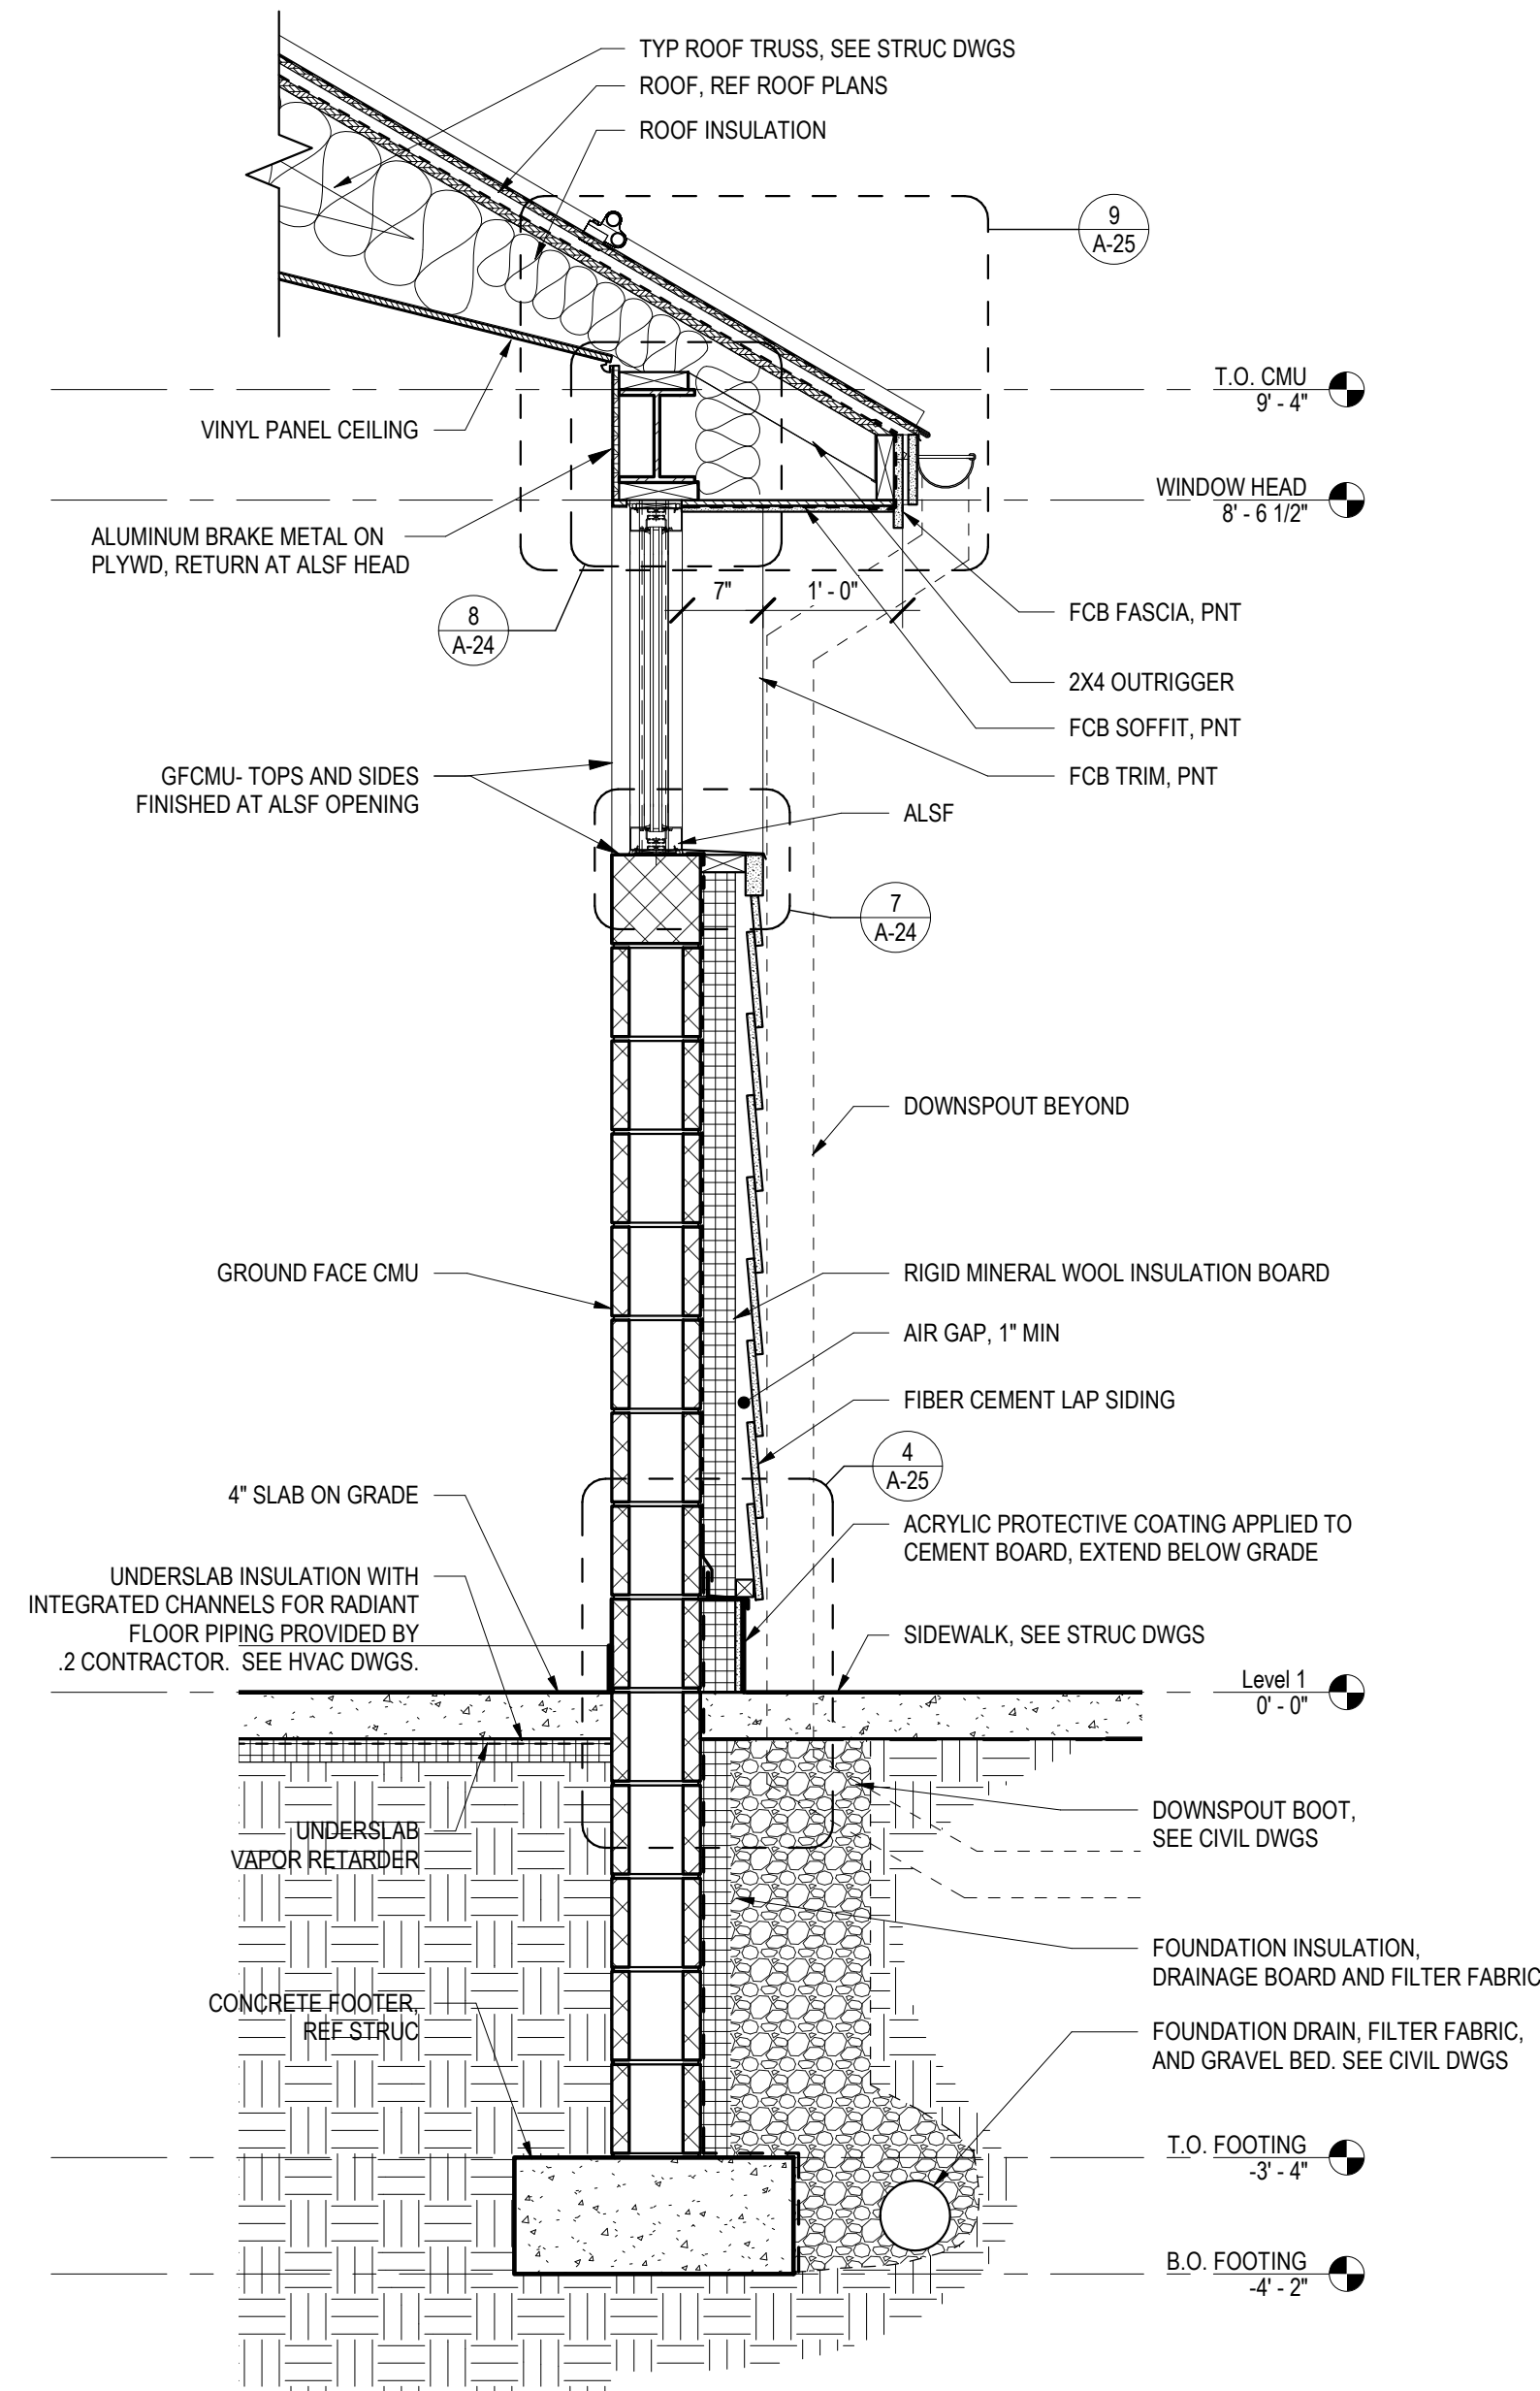

1 TYP WALL SECTION - FIBER CEMENT SIDING
A-23 3/4" = 1'-0"

VERIFY SCALE
BAR IS ONE (1) INCH LONG
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DRAWN BY: M STRENSKI
CHECKED BY: T WOODWARD
DATE: 06/17/2022
SCALE: AS NOTED
DRAWING No. A-23
77 OF 144

CONSTRUCTION DOCUMENTS

RECORD REVISIONS

SMP ARCHITECTS
1600 WALNUT STREET, SECOND FLOOR
PHILADELPHIA, PENNSYLVANIA

COMMONWEALTH OF PENNSYLVANIA
DEPARTMENT OF GENERAL SERVICES
HARRISBURG, PENNSYLVANIA


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HICKORY RUN STATE PARK
LATRINE IMPROVEMENTS
DEPT of CONSERVATION AND NATURAL RESOURCES
WHITE HAVEN, CARBON COUNTY, PA

TYPICAL WALL SECTIONS


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PENNSYLVANIA
T. WOODWARD No. 143100

03/05/2021
DATE


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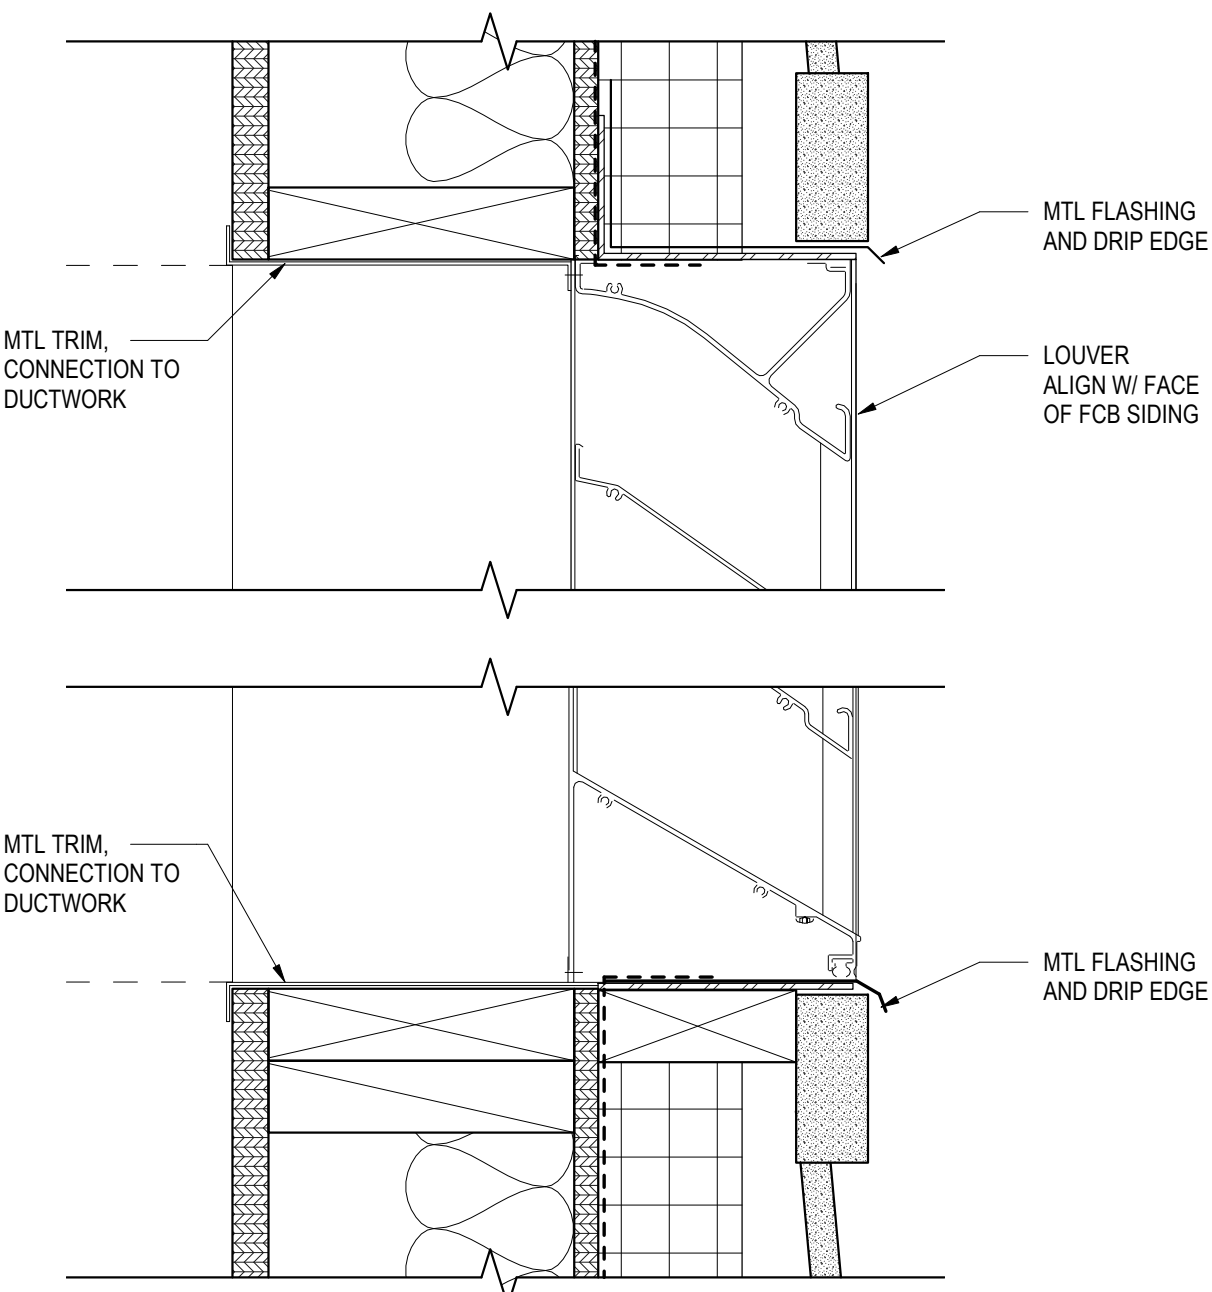
9 WINDOW TYPES
A-24 1/4" = 1'-0"

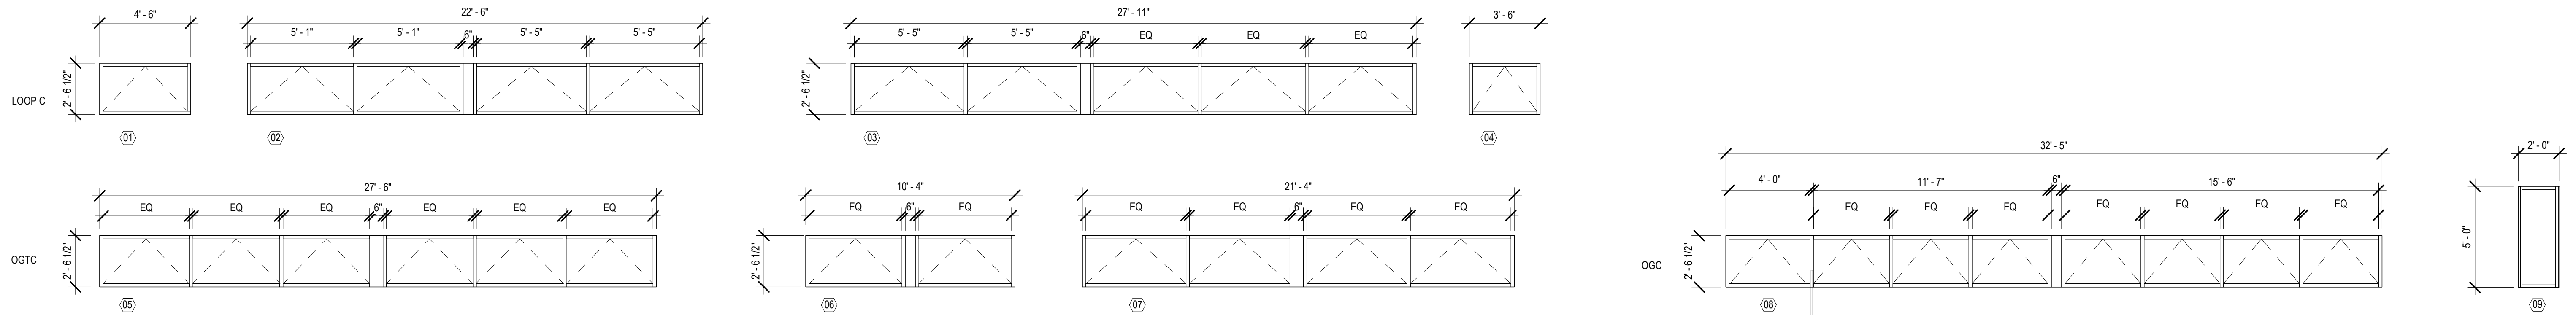


8 TYP STOREFRONT HEAD DETAIL
A-24 3" = 1'-0"

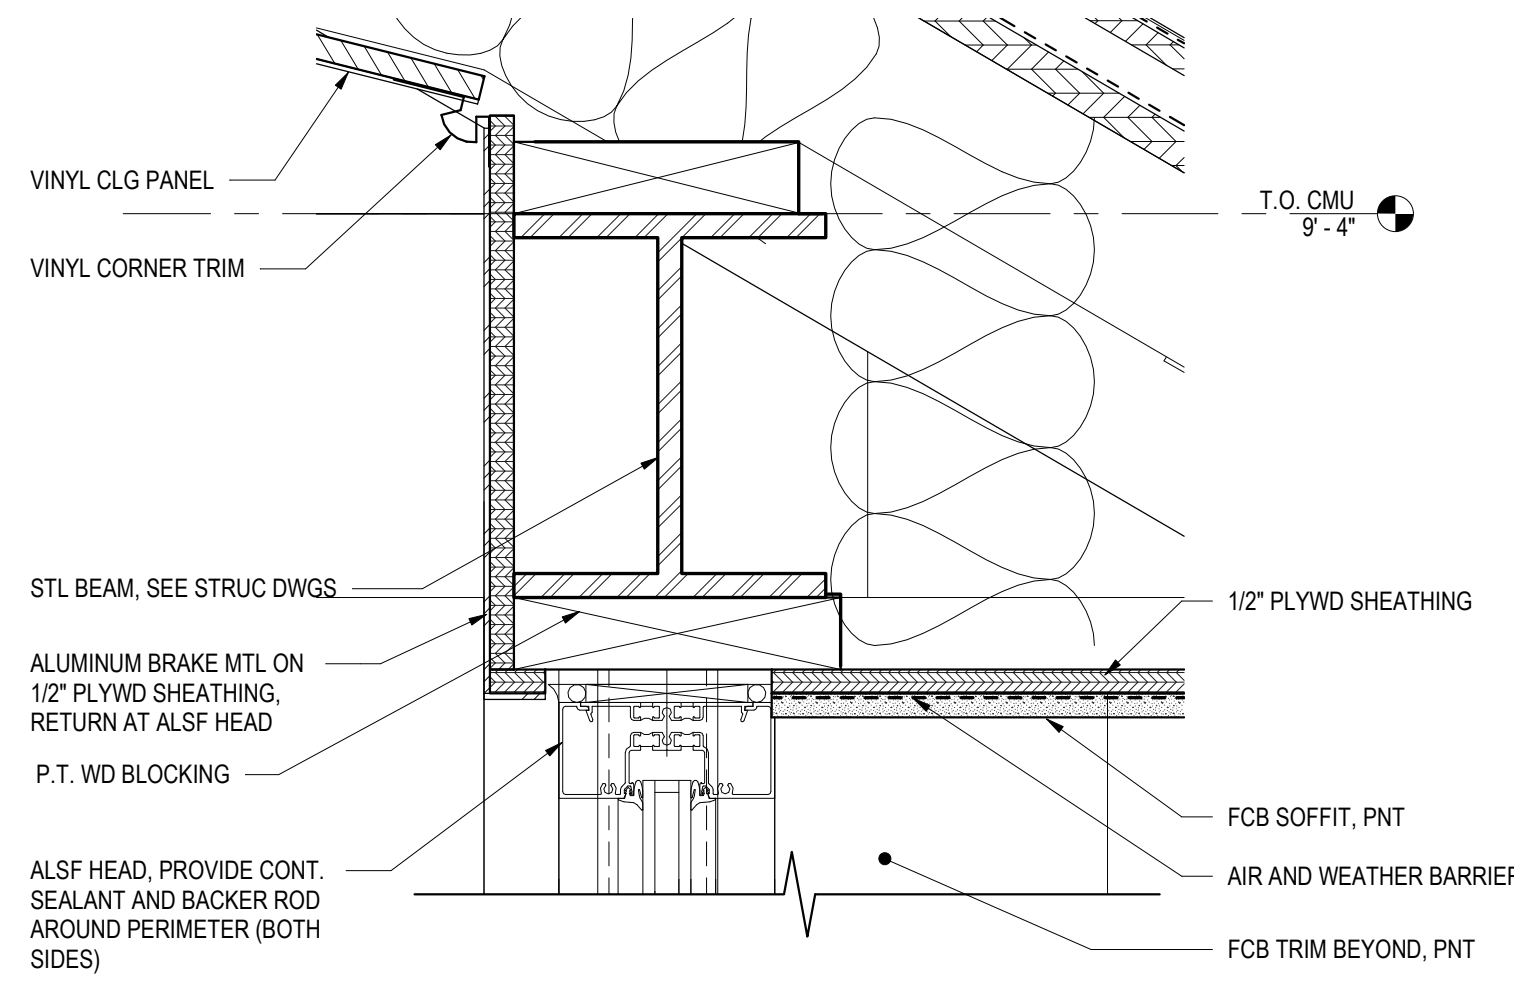


C JAMB DETAIL - EXT WALL WITH FCB
D HEAD DETAIL - EXT WALL WITH FCB

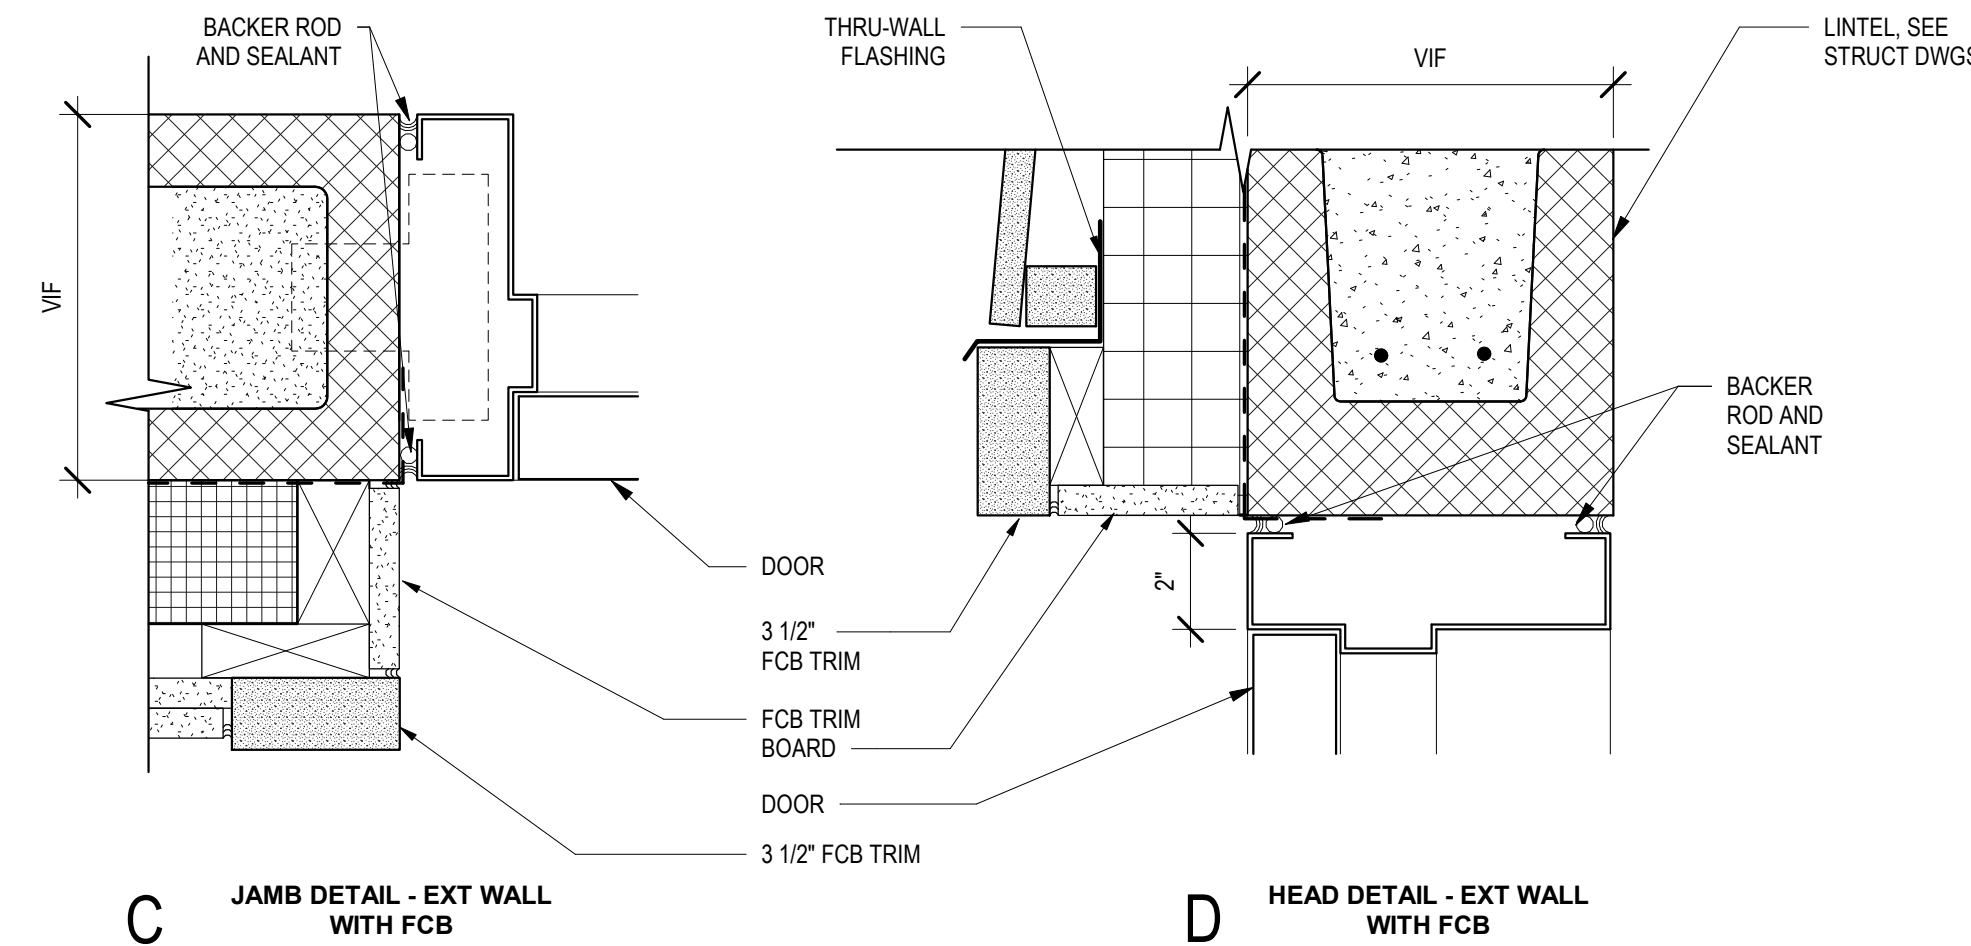


5 TYP HEAD / SILL DTL - LOUVER IN FCB WALL
A-24 3" = 1'-0" JAMB SIMILAR

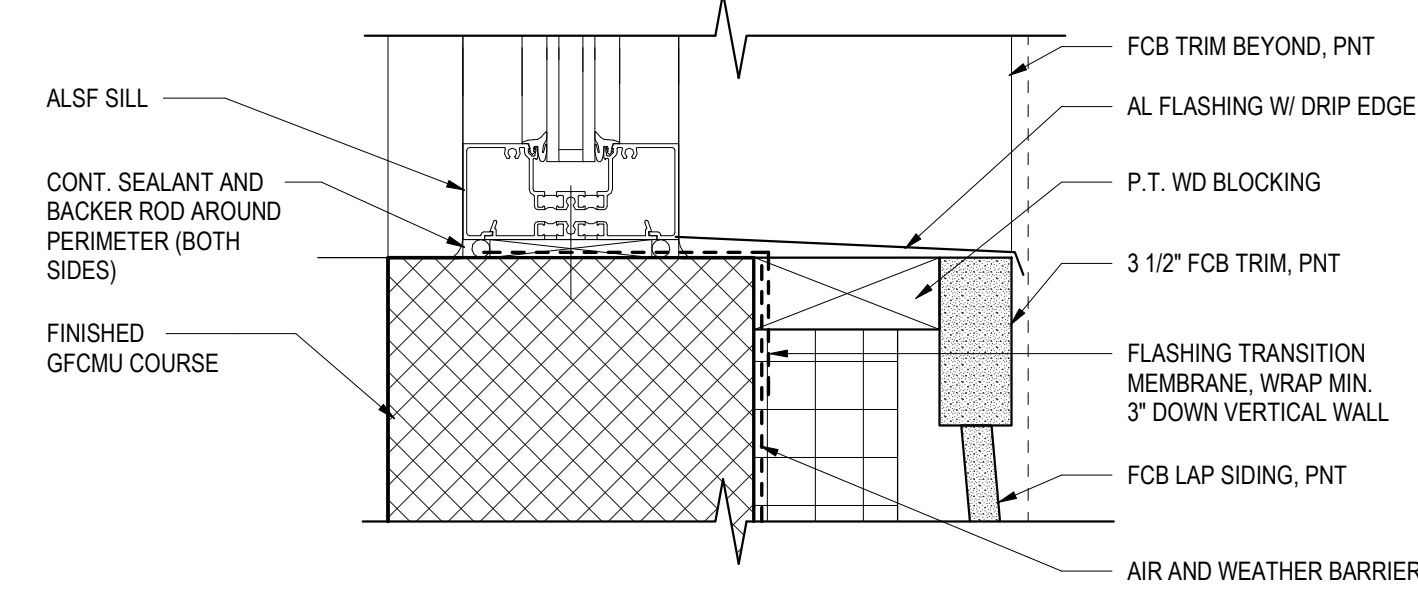


7 TYP STOREFRONT SILL DETAIL
A-24 3" = 1'-0"

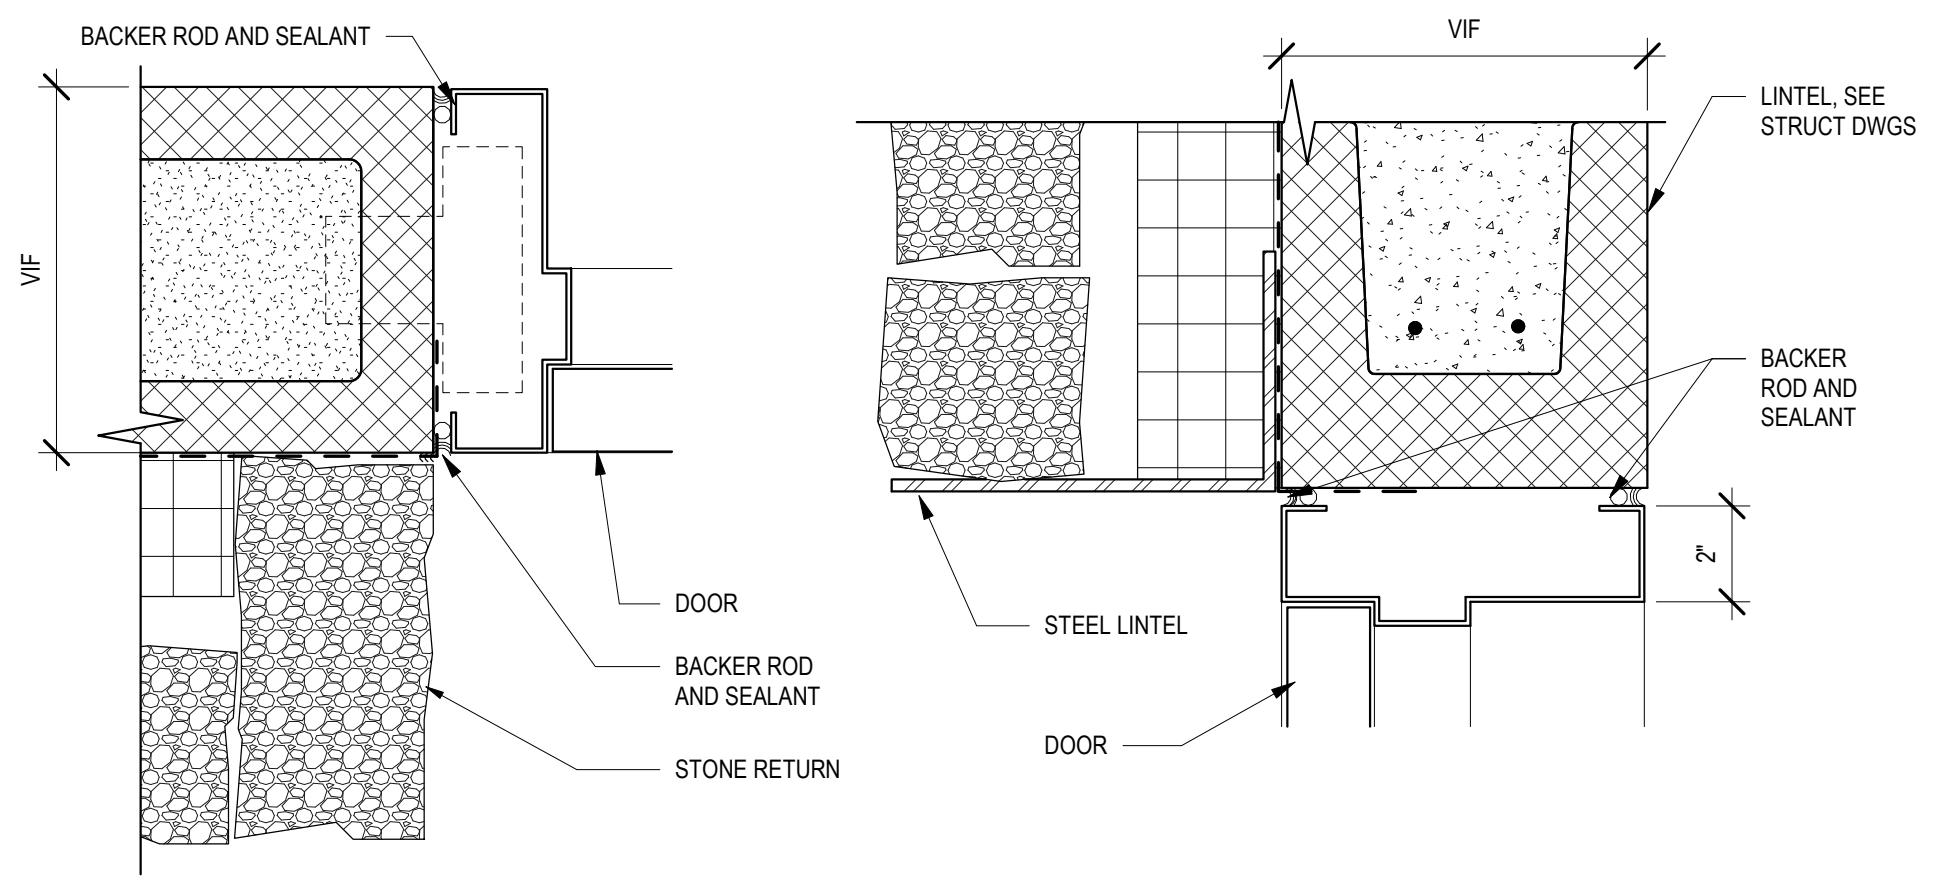


A JAMB DETAIL - EXT WALL WITH STONE
B HEAD DETAIL - EXT WALL WITH STONE

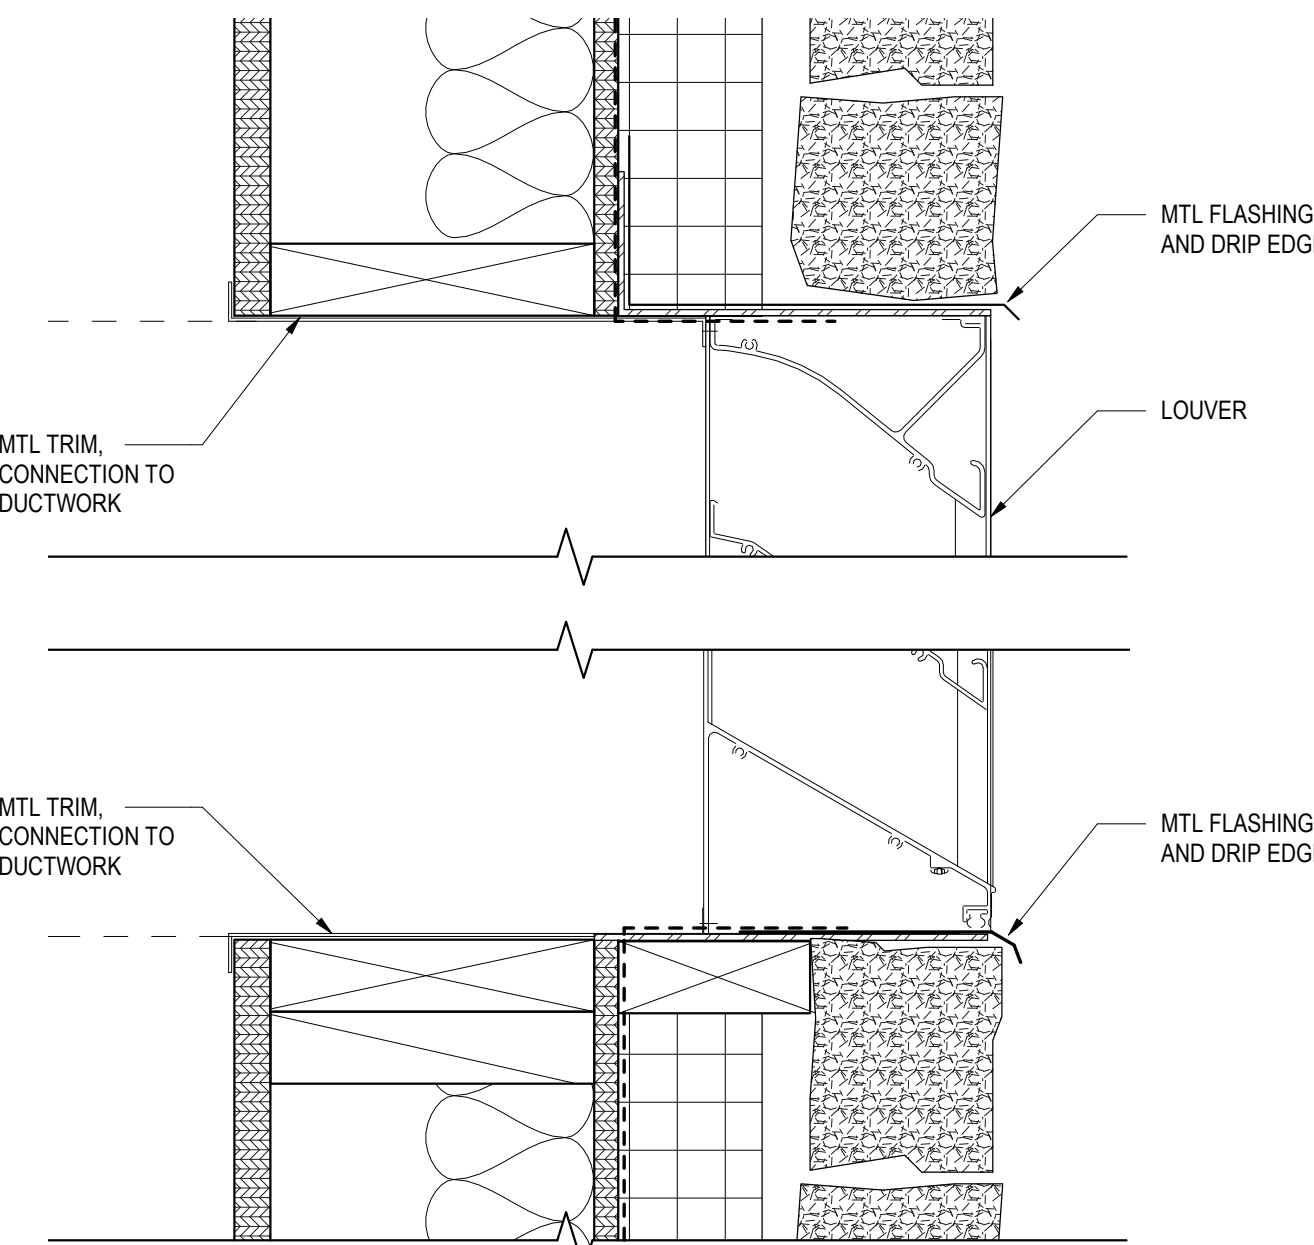

1 TYP HEAD / SILL DTL - LOUVER IN STONE WALL
A-24 3" = 1'-0" JAMB SIMILAR

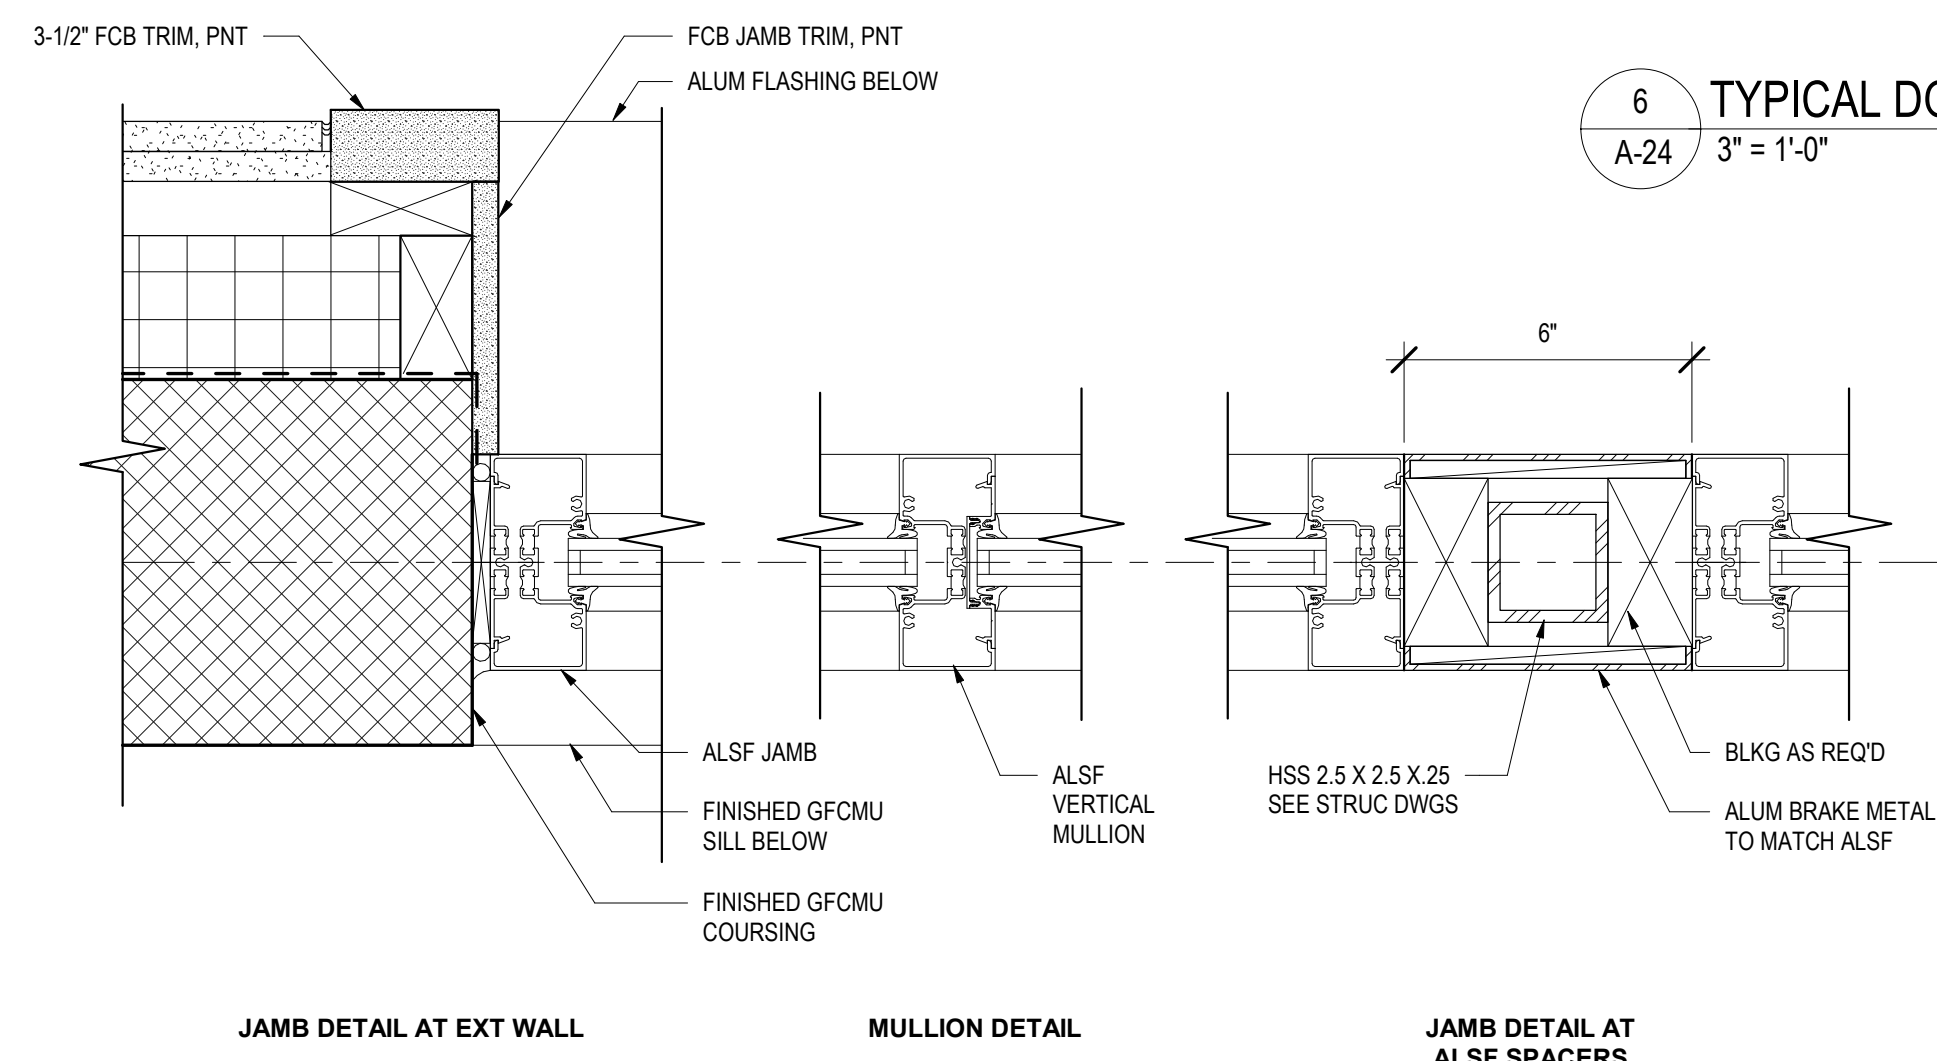

4 TYPICAL STOREFRONT DETAILS
A-24 3" = 1'-0"

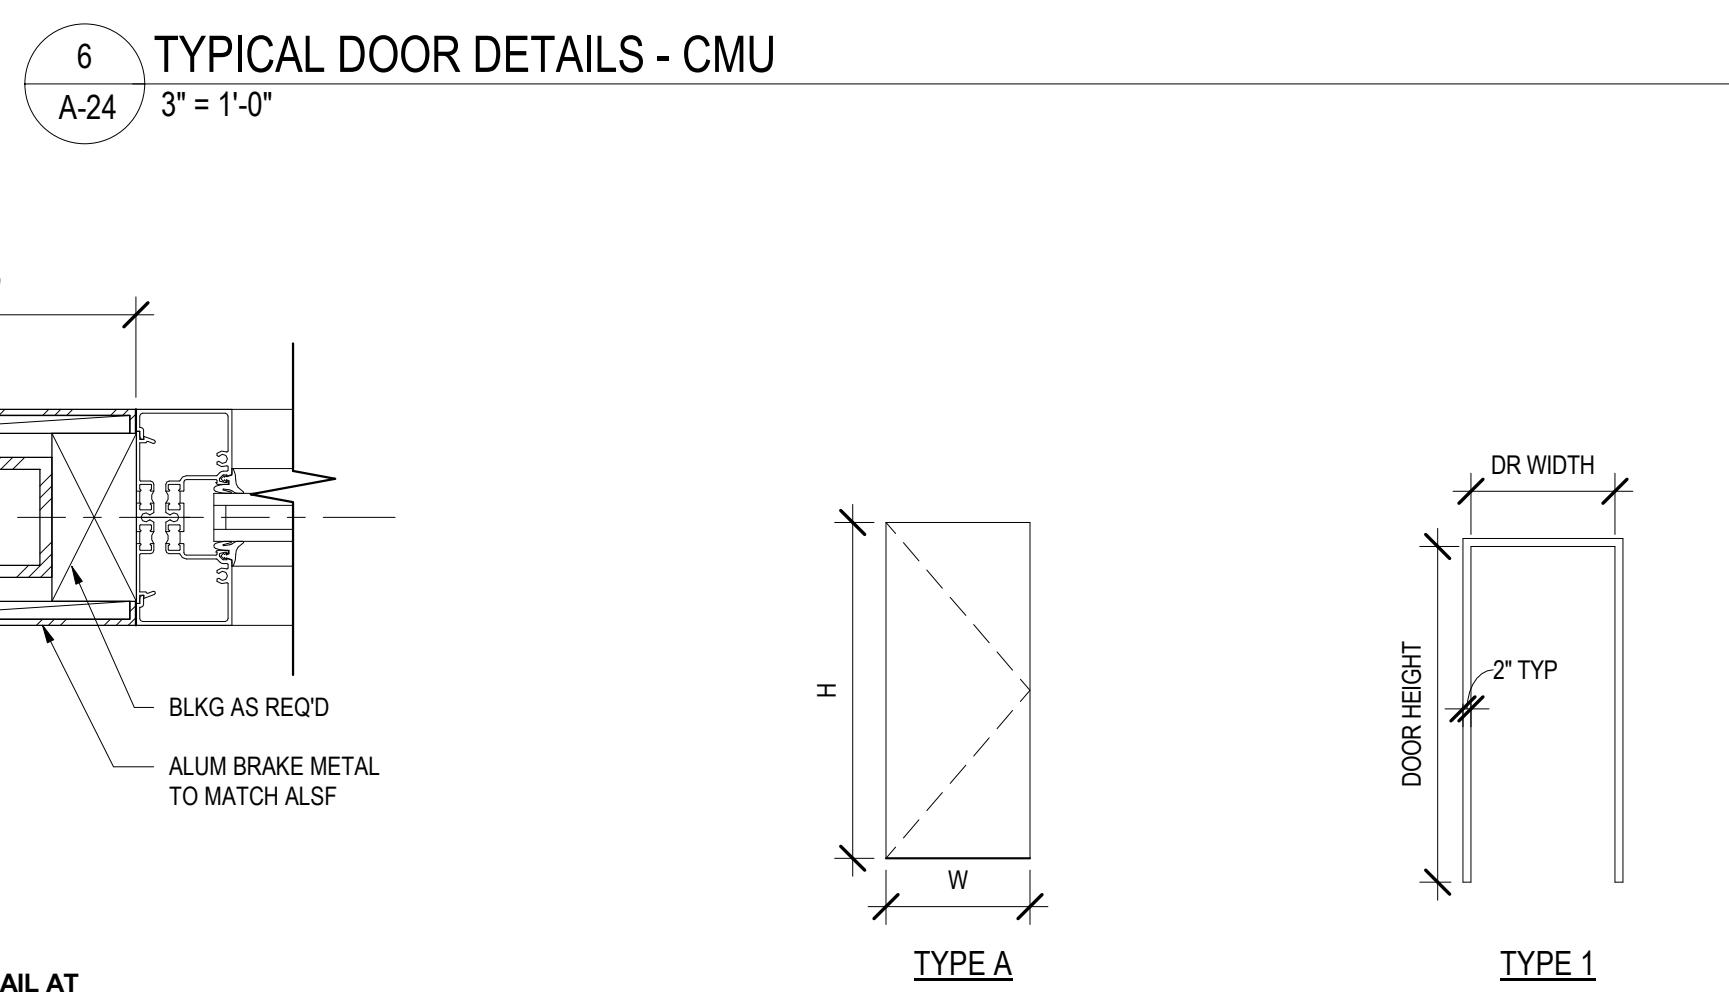

6 TYPICAL DOOR DETAILS - CMU
A-24 3" = 1'-0"


3 DOOR TYPES
A-24 1/4" = 1'-0"

2 DOOR FRAME TYPES
A-24 1/4" = 1'-0"


CONSTRUCTION DOCUMENTS

 <p style="text-align: right; font-size: small;">SIGNATURE: _____ DATE: 03/05/2021</p>	<p>SMP ARCHITECTS 1600 WALNUT STREET, SECOND FLOOR PHILADELPHIA, PENNSYLVANIA</p> <p>COMMONWEALTH OF PENNSYLVANIA DEPARTMENT OF GENERAL SERVICES HARRISBURG, PENNSYLVANIA</p> <p>D.G.S. PROJECT No. C-114-0006 PHASE 1</p> <p>HICKORY RUN STATE PARK LATRINE IMPROVEMENTS</p> <p>DEPT of CONSERVATION AND NATURAL RESOURCES WHITE HAVEN, CARBON COUNTY, PA</p> <p>TYPICAL DOOR, WINDOW, AND MISC DETAILS</p>
<p>VERIFY SCALE</p> <p>BAR IS ONE (1) INCH LONG ON ORIGINAL DRAWING: 0 1</p> <p>IF BAR IS NOT ONE (1) INCH LONG, ADJUST SCALE ACCORDINGLY</p>	
<p>CONTRACTOR SHALL FIELD VERIFY ALL DIMENSIONS. VARIANCE FROM CONTRACT DOCUMENTS NOT PERMITTED WITHOUT PROFESSIONAL & BUREAU OF CONSTRUCTION APPROVAL.</p>	<p>DRAWN BY: M STRENSKI CHECKED BY: T WOODWARD</p> <p>DATE: 06/17/2022 SCALE: AS NOTED</p>
<p style="font-size: 2em; font-weight: bold;">A-24</p> <p style="font-size: x-small;">78 OF 144</p>	


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LAST SAVED: 2020/06/04 12:14 PM PLOTTED BY: Megan M. Strenski

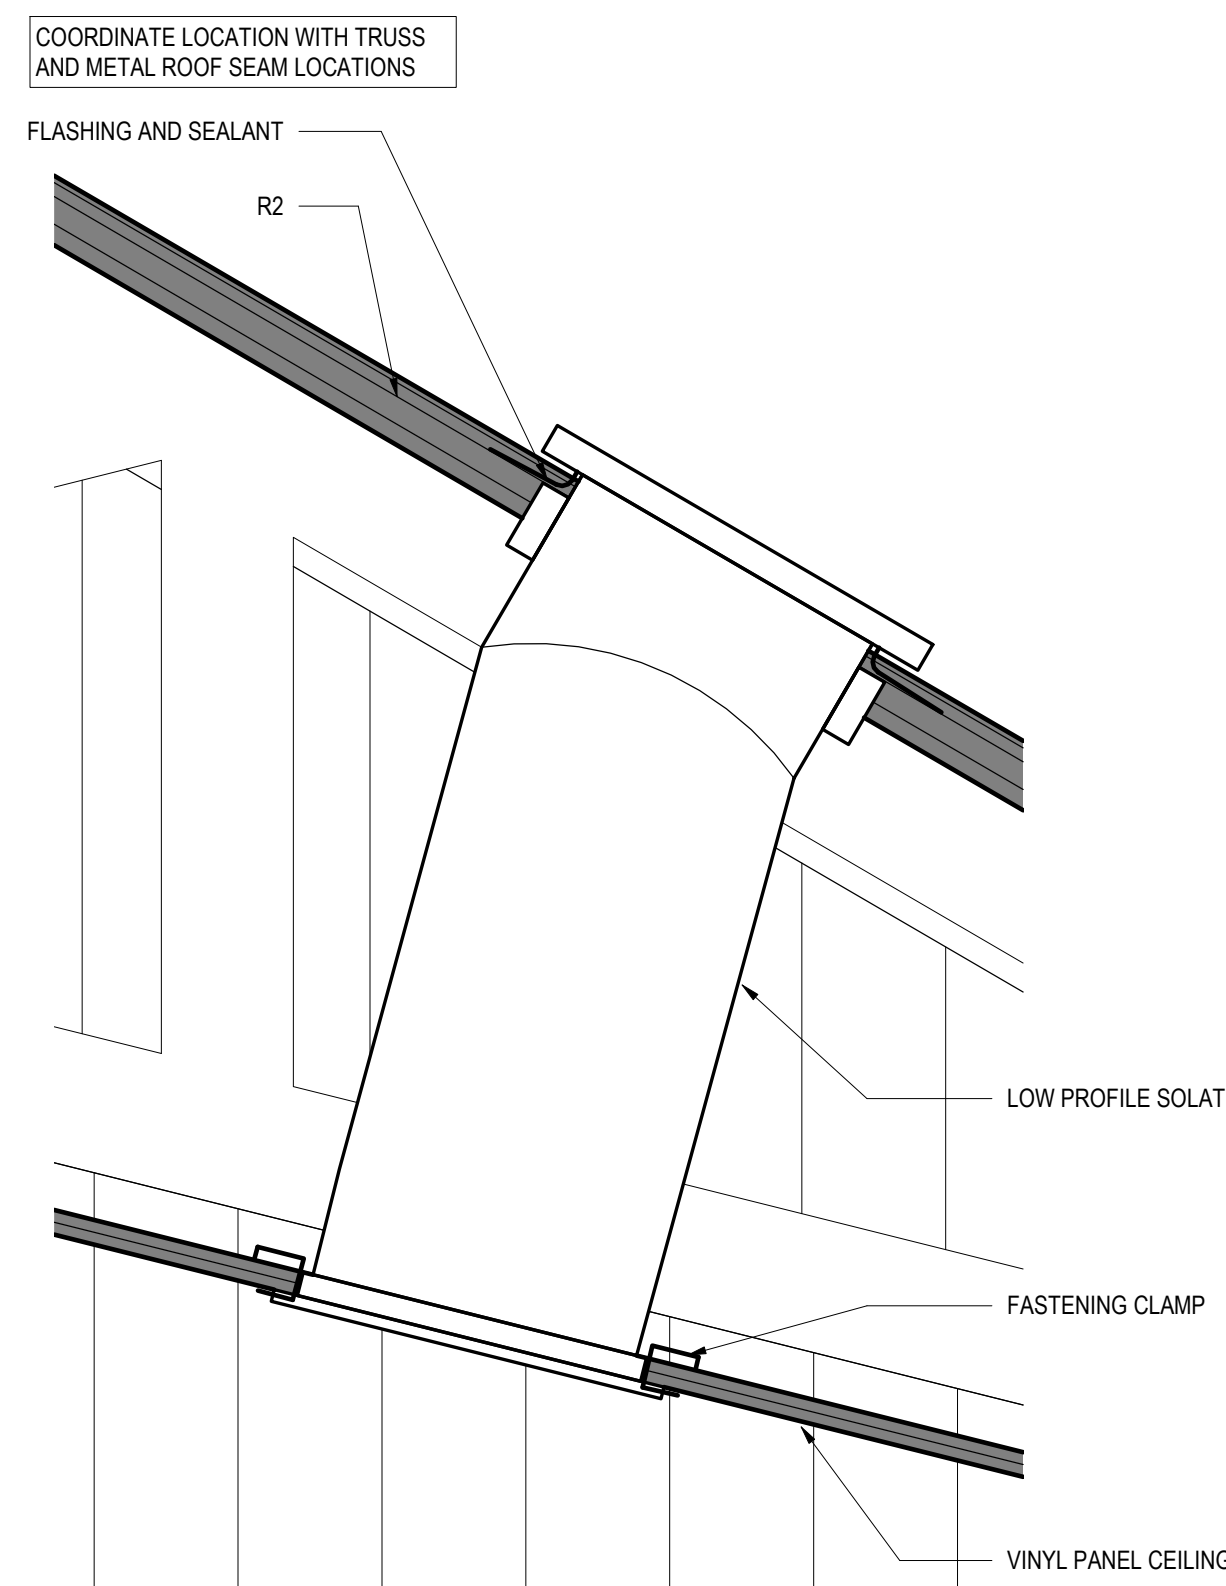


8 ROOF DETAIL - TUBULAR SKYLIGHT
A-25 1 1/2" = 1'-0"

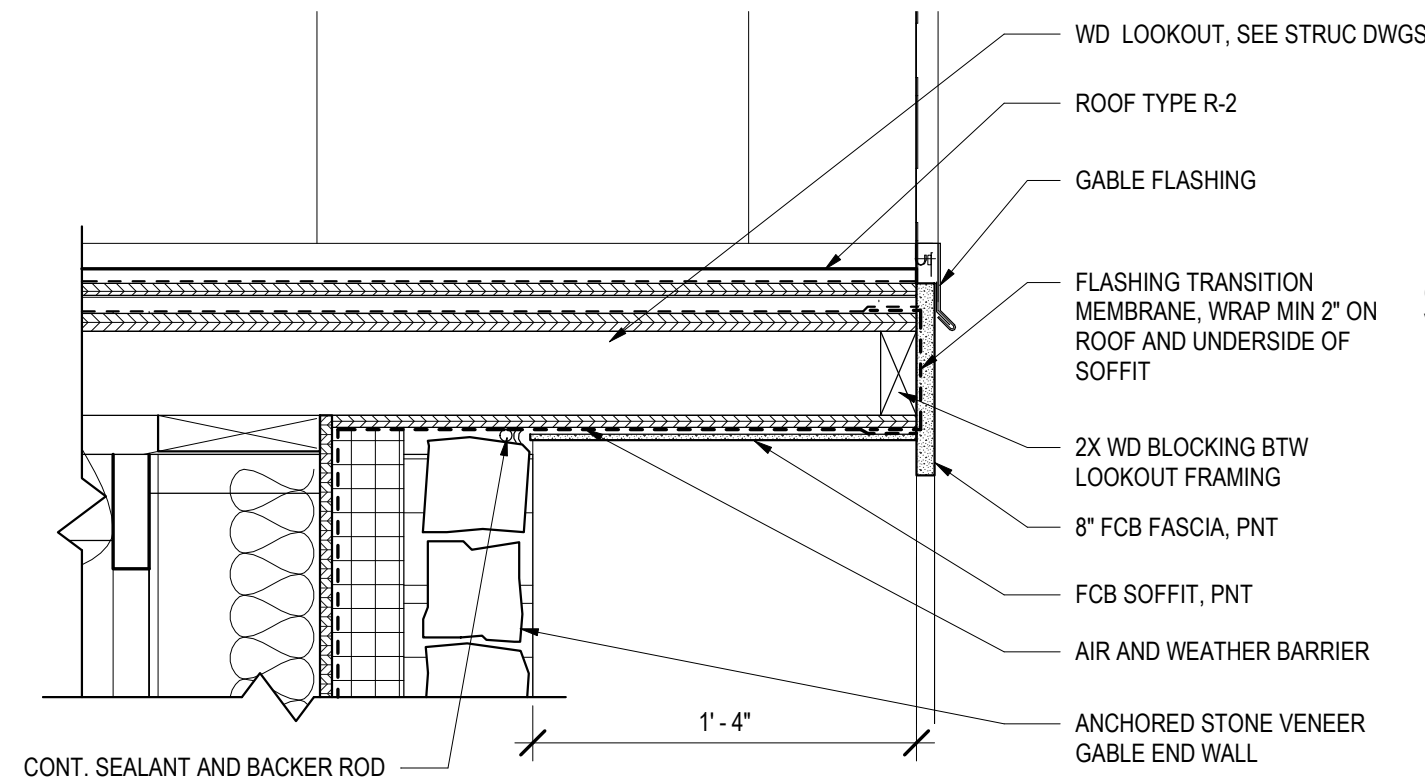


12 ROOF DETAIL - R-2 RAKE, TYP.
A-25 1 1/2" = 1'-0"

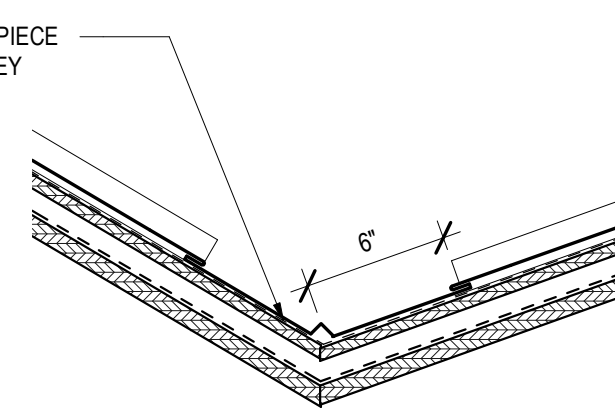


11 ROOF DETAIL - R2 VALLEY, TYP
A-25 1 1/2" = 1'-0"

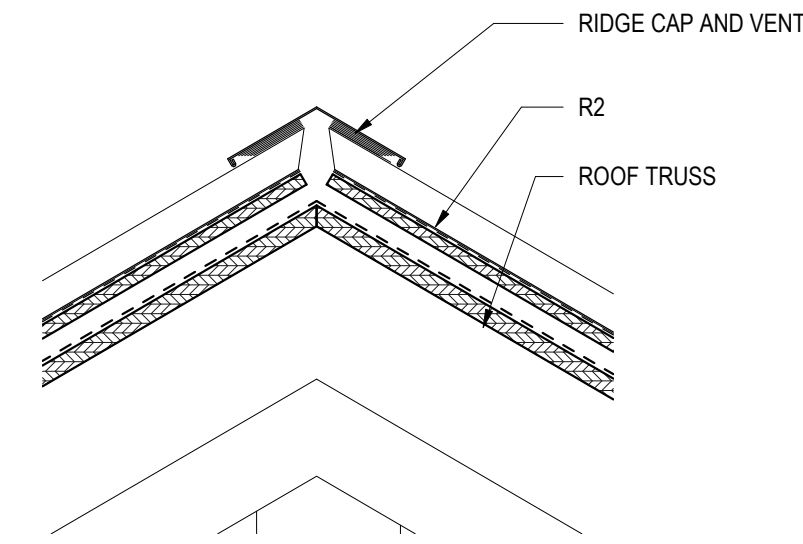


10 ROOF DETAIL - R2 RIDGE, TYP
A-25 1 1/2" = 1'-0"

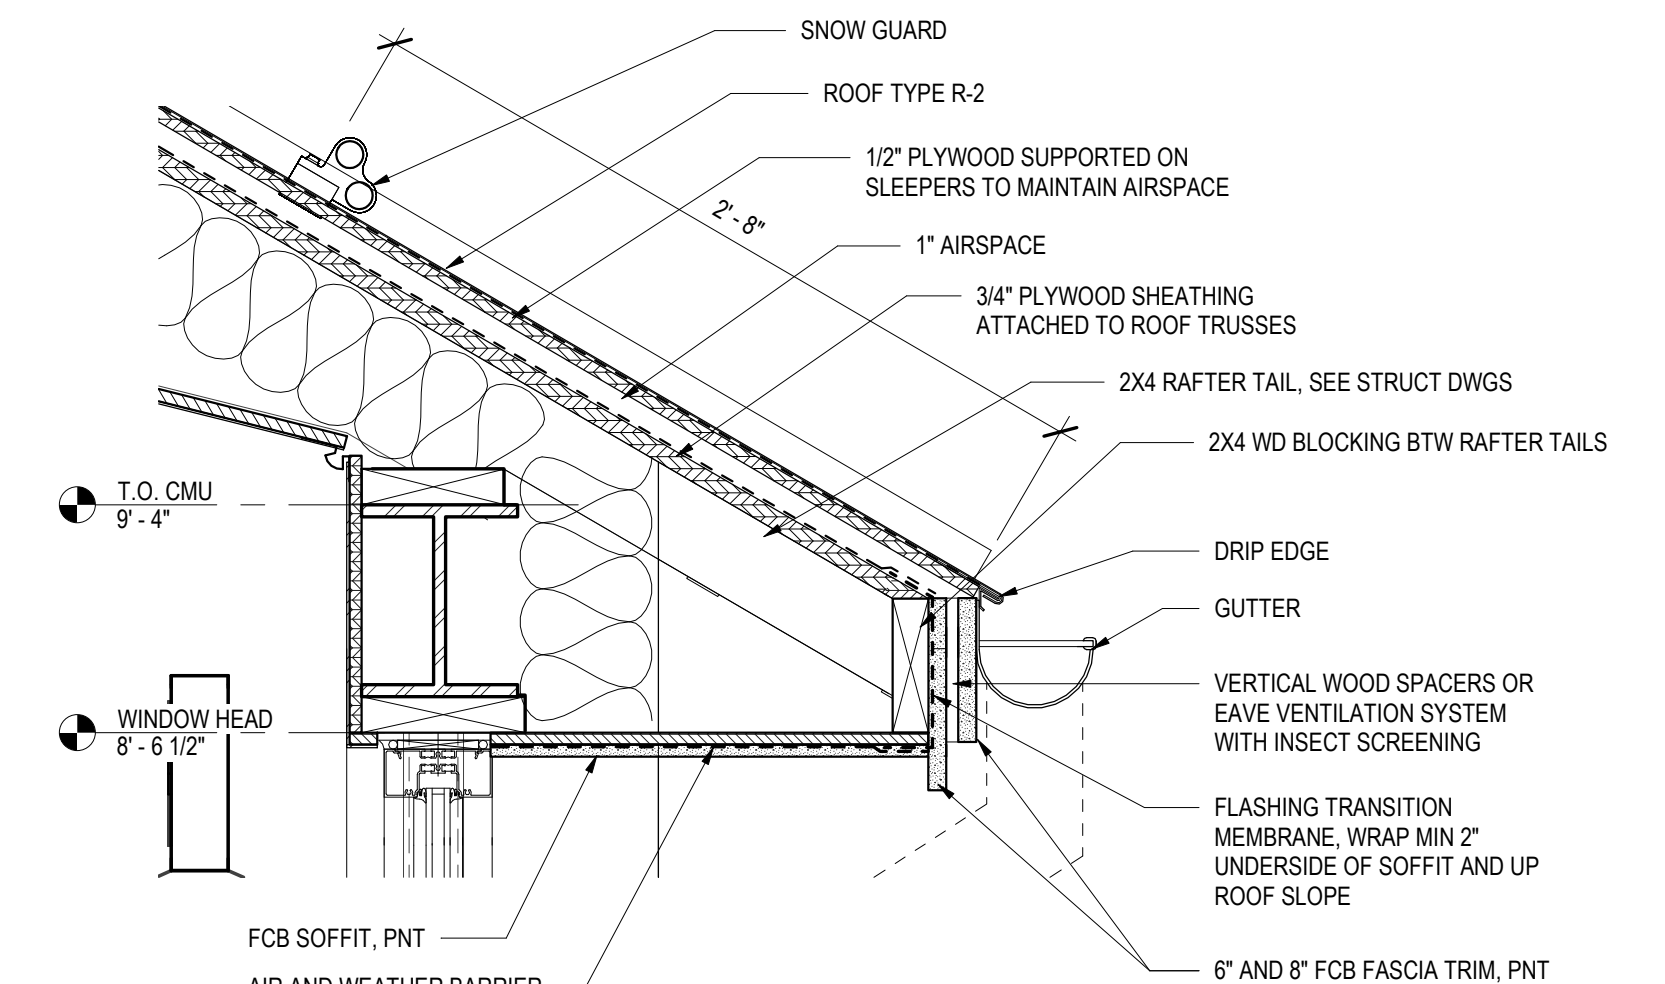


9 ROOF DETAIL - R-2 EAVE, TYP
A-25 1 1/2" = 1'-0"

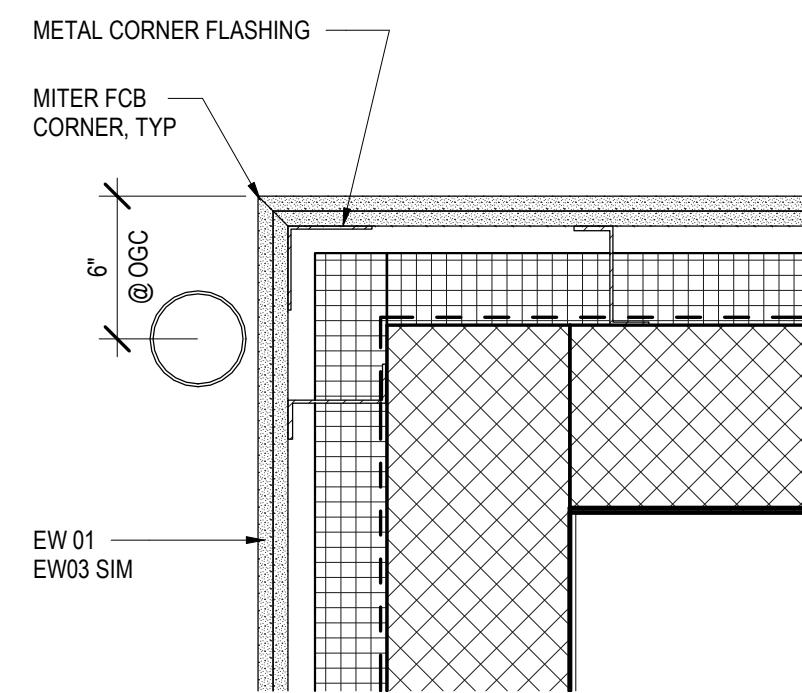


7 PLAN DETAIL - FIBER CEMENT MITERED CORNER
A-25 1 1/2" = 1'-0"

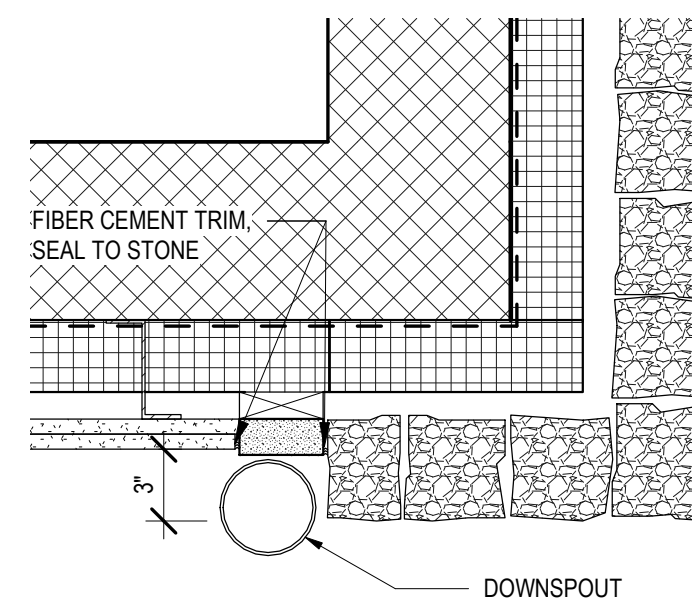


6 PLAN DETAIL - STONE AND FIBER CEMENT CORNER
A-25 1 1/2" = 1'-0"

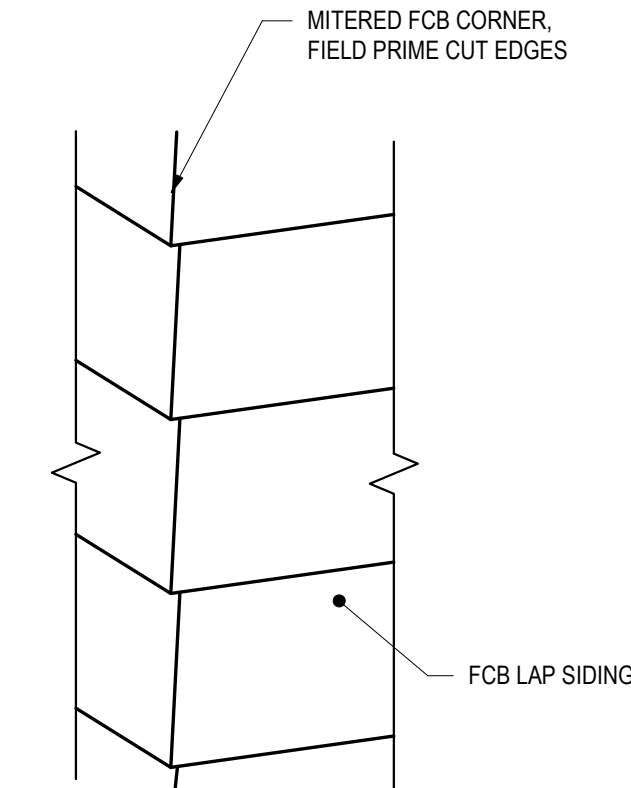


5 DETAIL - FCB CORNER
A-25 1 1/2" = 1'-0"

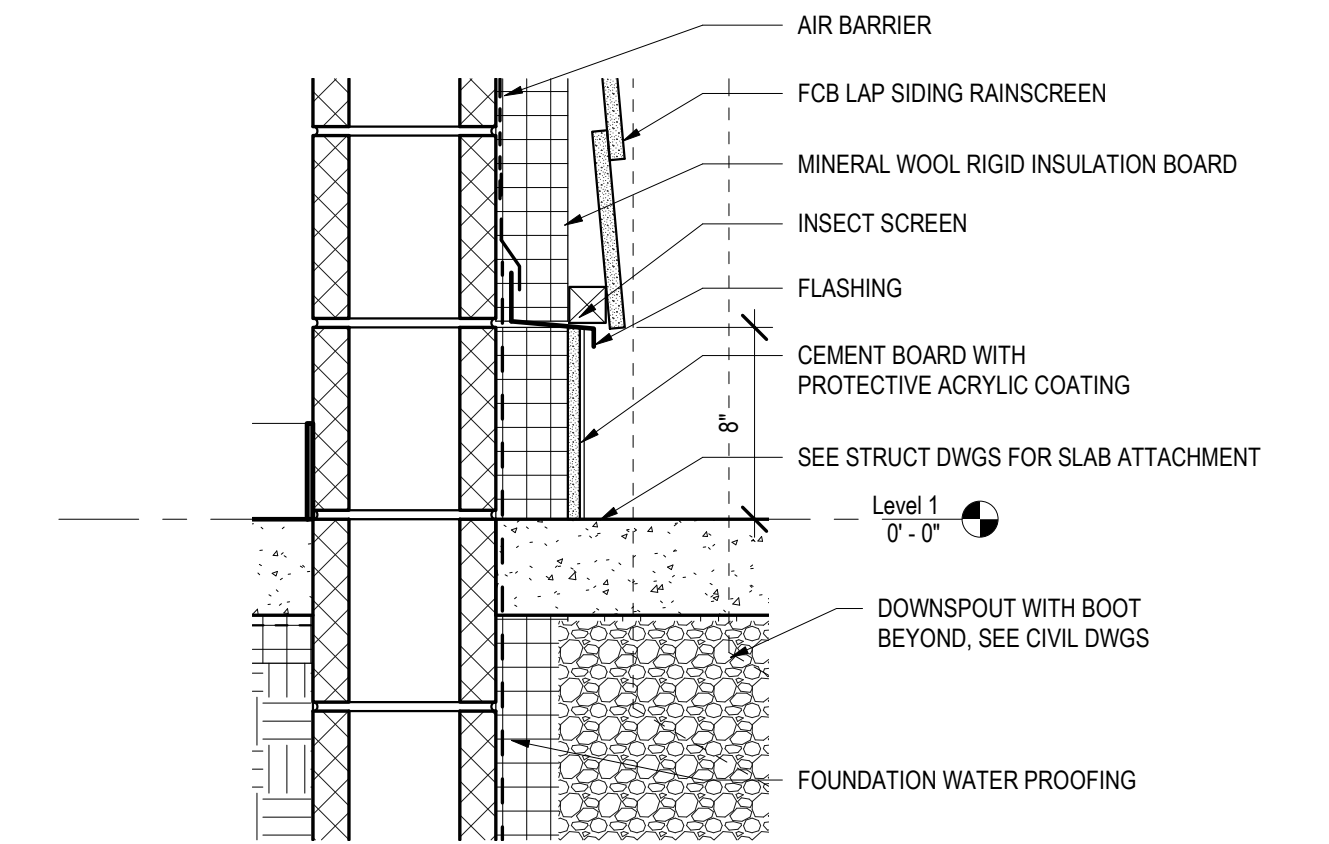


4 SECTION - FIBER CEMENT TRANSITION AT GRADE
A-25 1 1/2" = 1'-0"

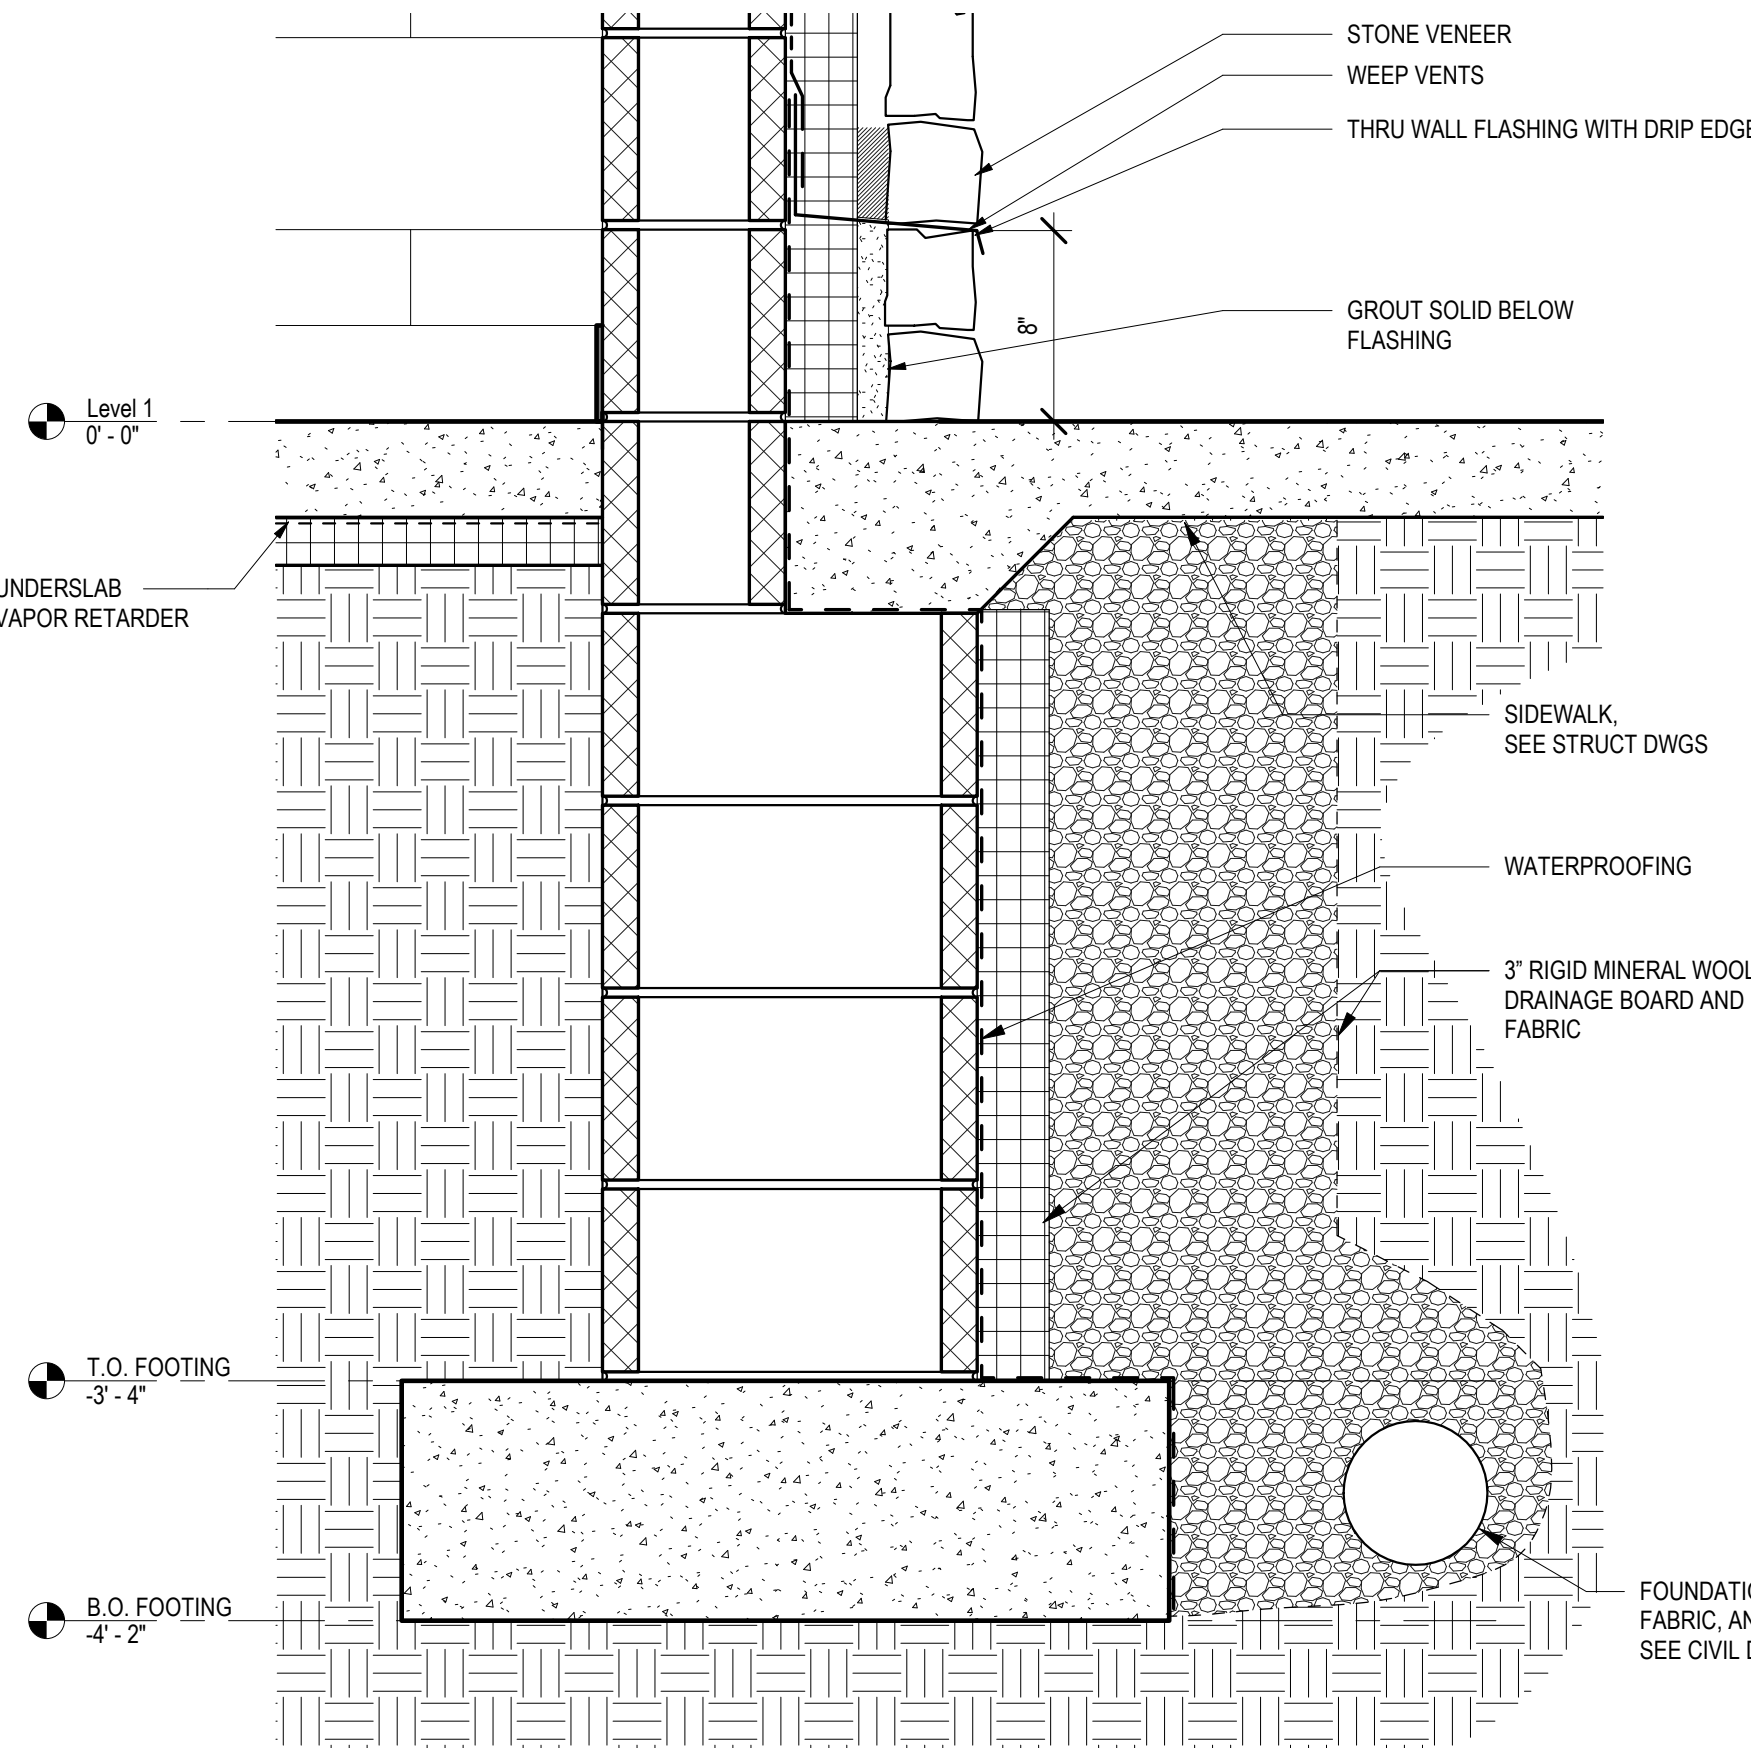

3 SECTION - FOUNDATION DETAIL AT STONE WALL, TYP
A-25 1 1/2" = 1'-0"

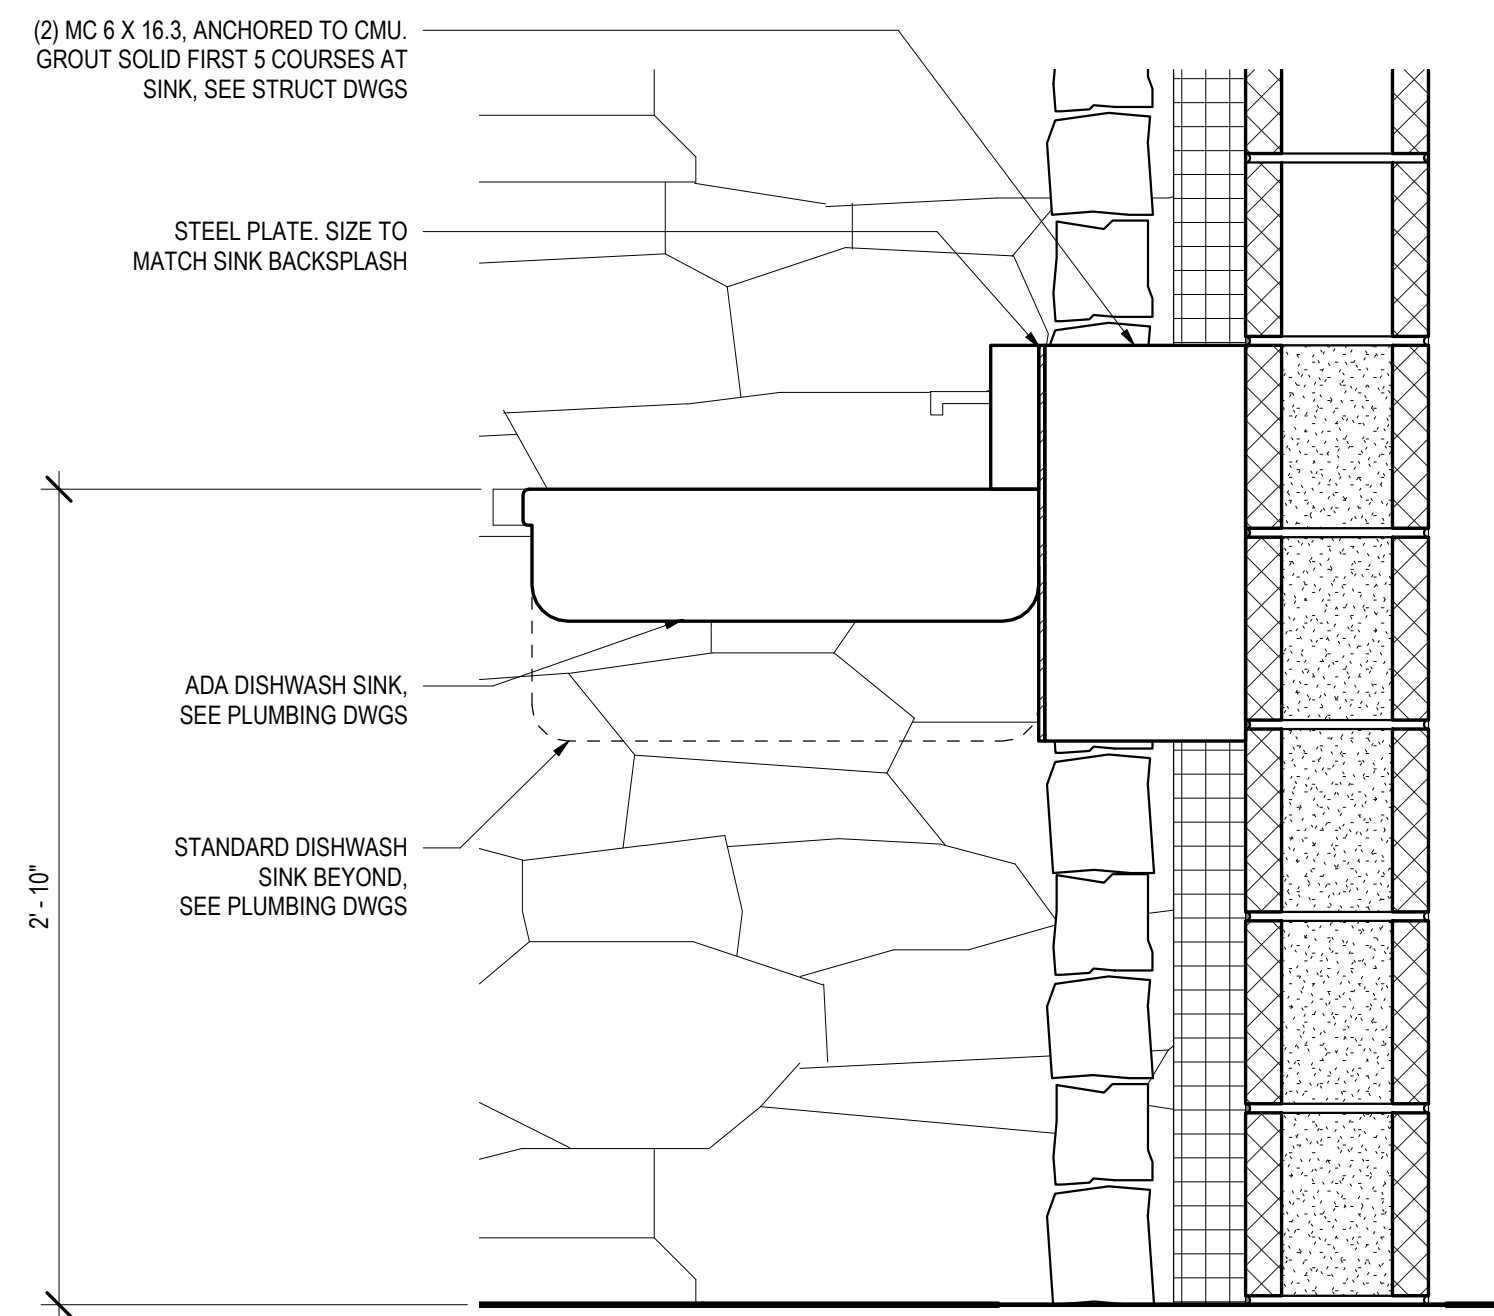


2 SECTION - DISHWASHING SINK
A-25 1 1/2" = 1'-0"

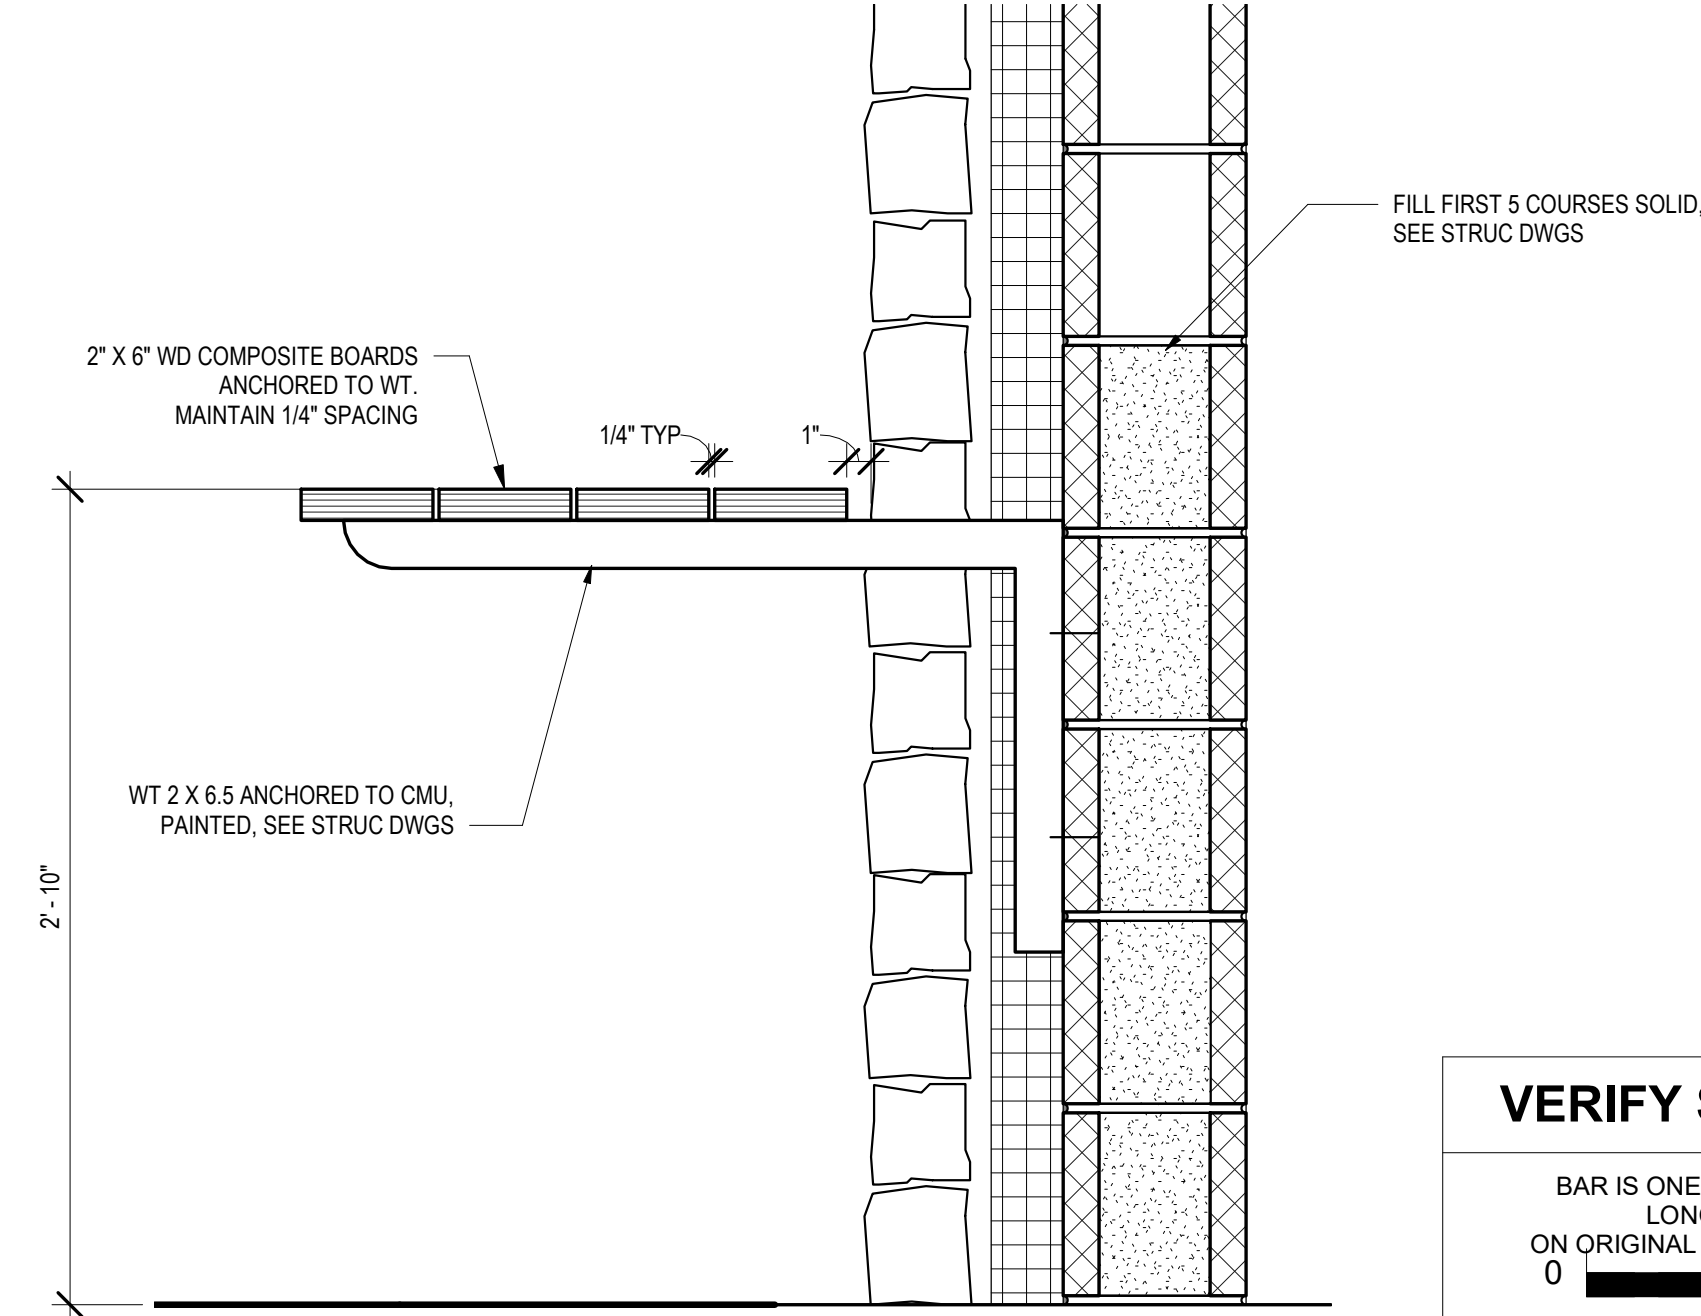

1 SECTION - OUTDOOR COUNTER
A-25 1 1/2" = 1'-0"

CONSTRUCTION DOCUMENTS

RECORD REVISIONS

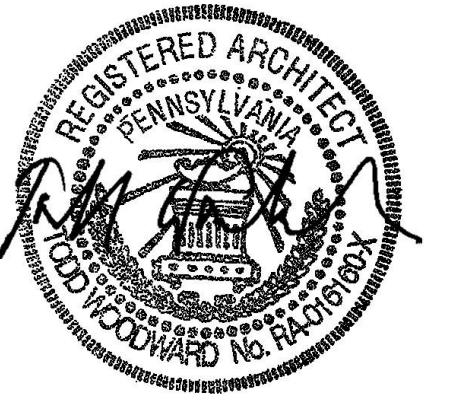

SIGNATURE DATE 03/05/2021

SMP ARCHITECTS
1600 WALNUT STREET, SECOND FLOOR
PHILADELPHIA, PENNSYLVANIA

COMMONWEALTH OF PENNSYLVANIA
DEPARTMENT OF GENERAL SERVICES
HARRISBURG, PENNSYLVANIA

D.G.S. PROJECT No. C-114-0006 PHASE 1

HICKORY RUN STATE PARK
LATRINE IMPROVEMENTS
DEPT OF CONSERVATION AND NATURAL RESOURCES
WHITE HAVEN, CARBON COUNTY, PA

TYPICAL EXTERIOR DETAILS




VERIFY SCALE

BAR IS ONE (1) INCH LONG
ON ORIGINAL DRAWING: 0 1
IF BAR IS NOT ONE (1) INCH LONG, ADJUST SCALE ACCORDINGLY

CONTRACTOR SHALL FIELD VERIFY ALL DIMENSIONS. VARIANCE FROM CONTRACT DOCUMENTS NOT PERMITTED WITHOUT PROFESSIONAL & BUREAU OF CONSTRUCTION APPROVAL.

DRAWN BY M STRENSKI DATE 06/17/2022
CHECKED BY T WOODWARD SCALE AS NOTED

DRAWING No. A-25
79 OF 144

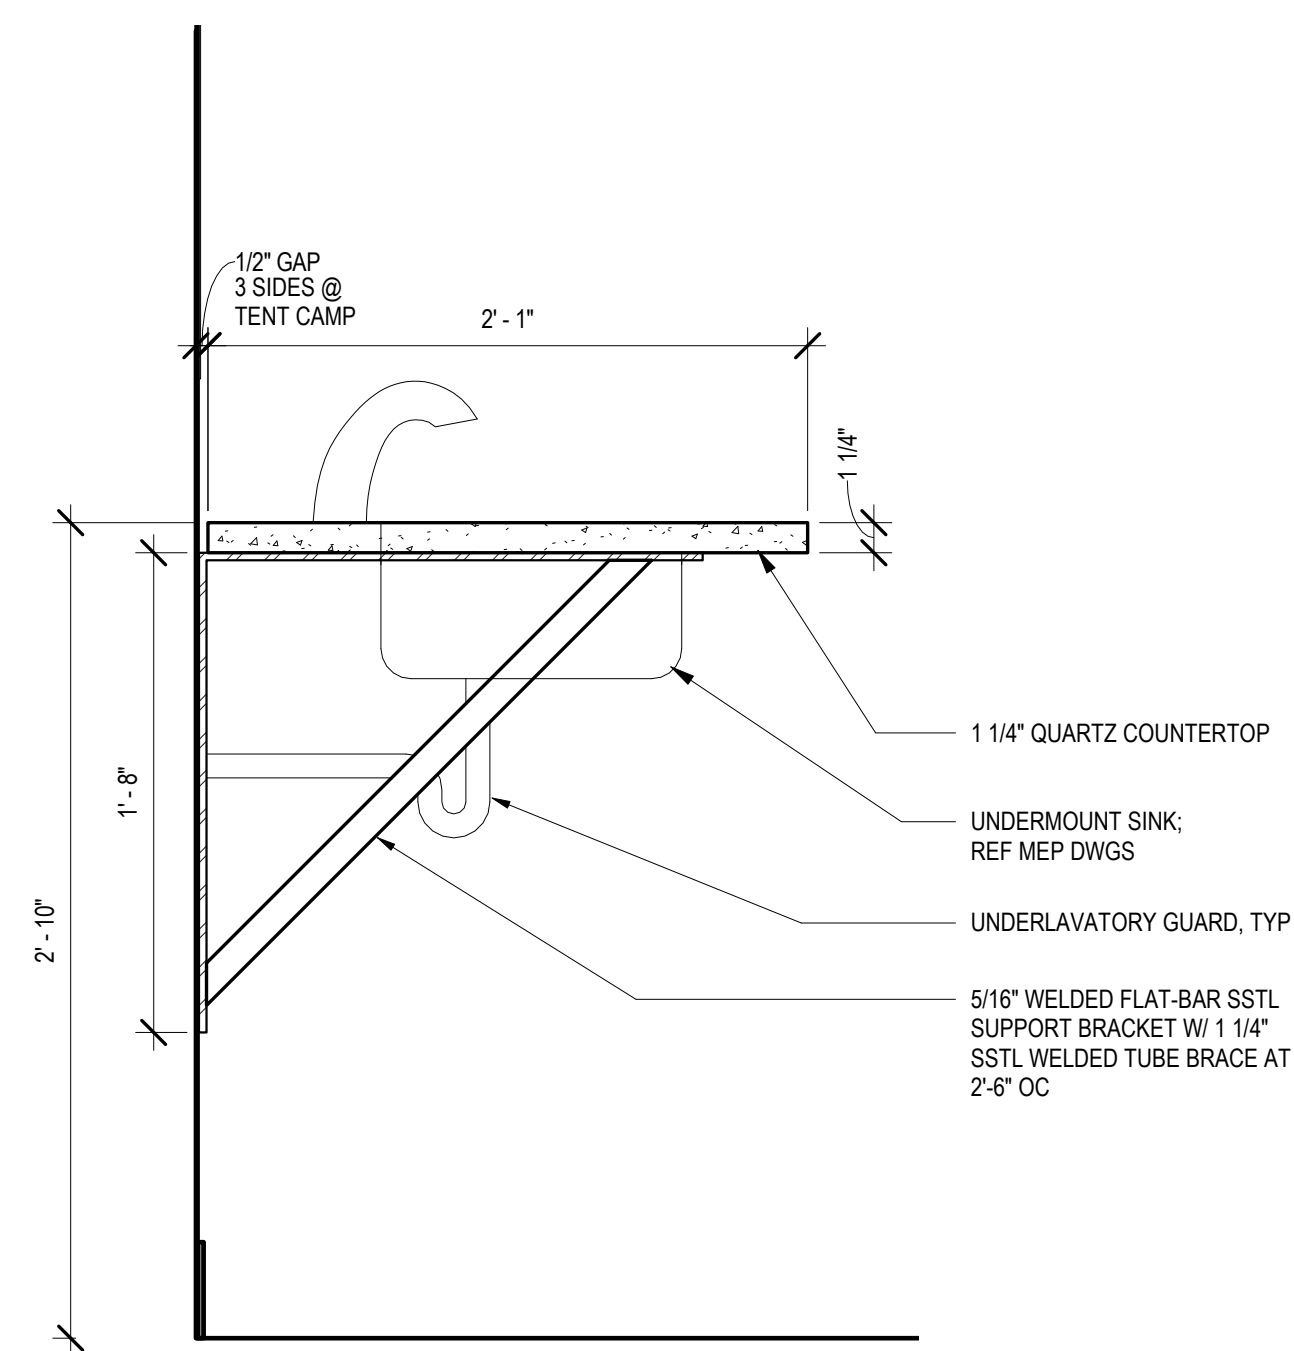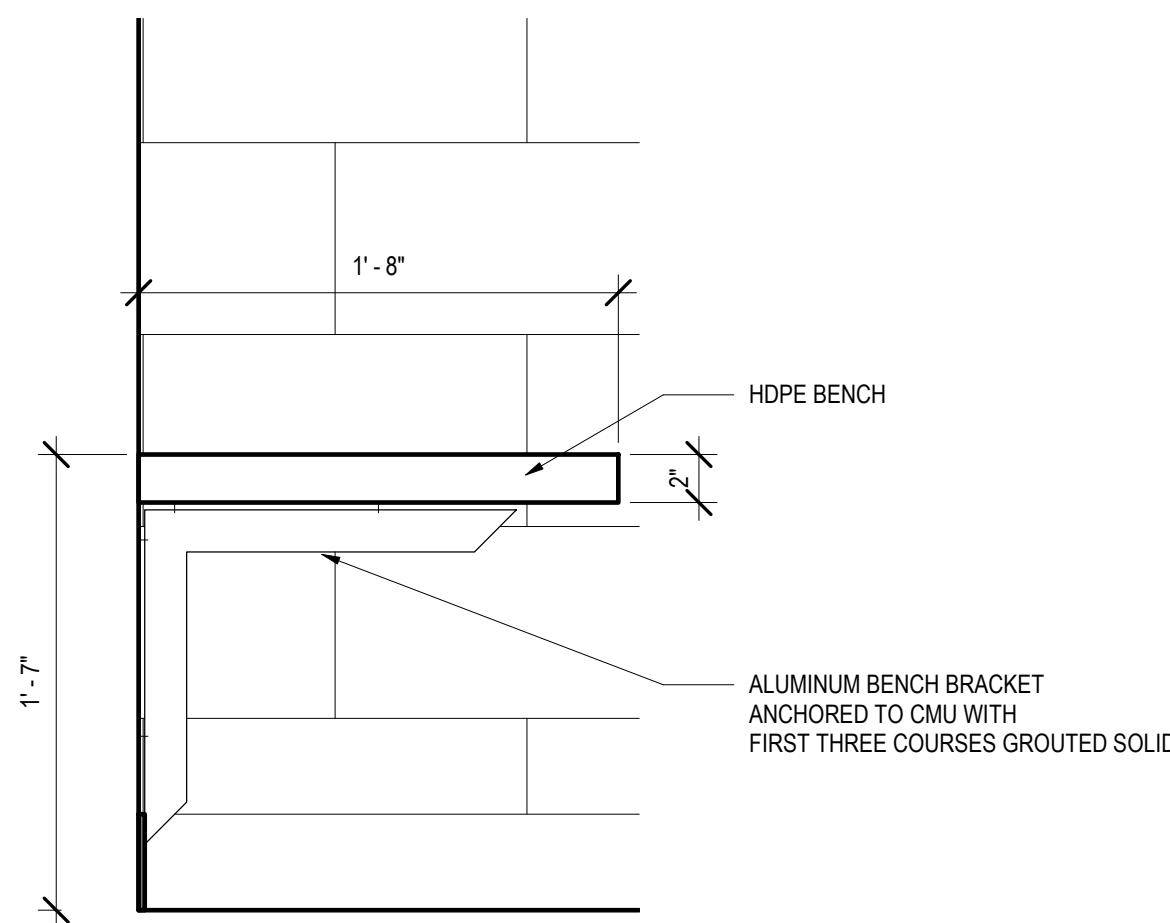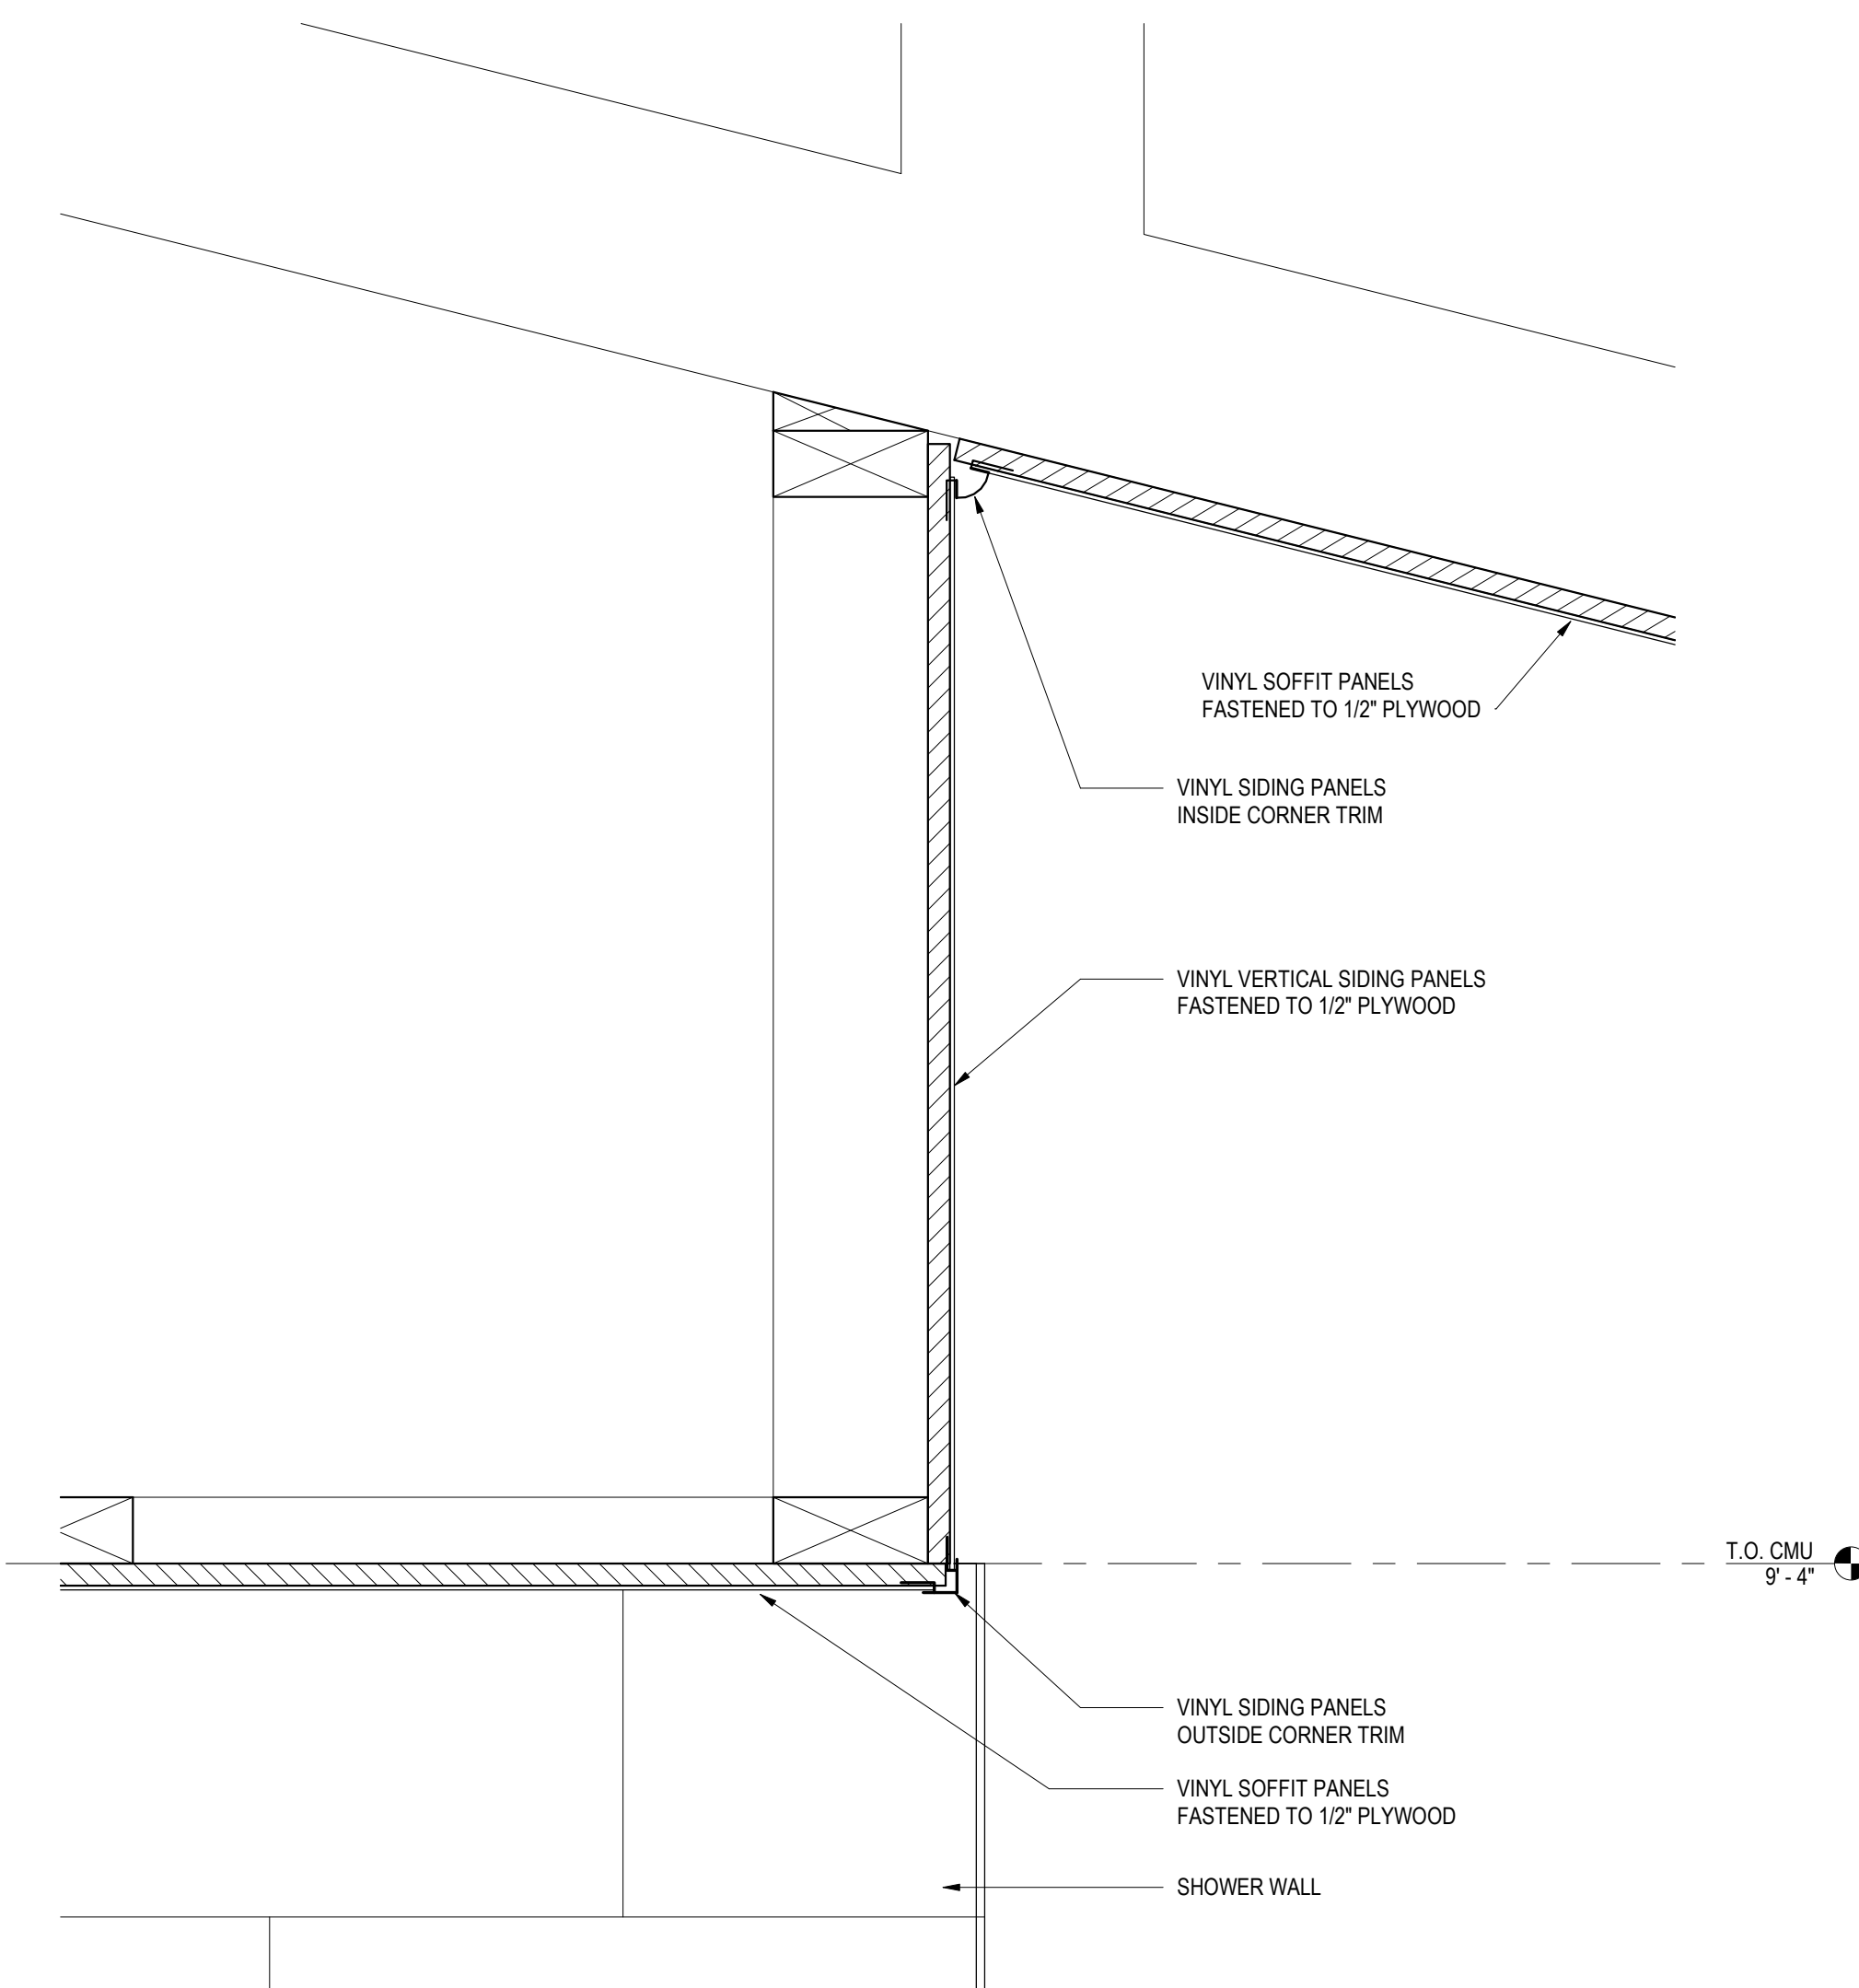


3 SECTION - CEILING AT SHOWER, TYP
A-26 3" = 1'-0"

2 SECTION AT ADA SHOWER STALL CHANGING BENCH
A-26 1 1/2" = 1'-0"

1 SECTION - SINK COUNTER, TYP
A-26 1 1/2" = 1'-0"

CONSTRUCTION DOCUMENTS

RECORD REVISIONS

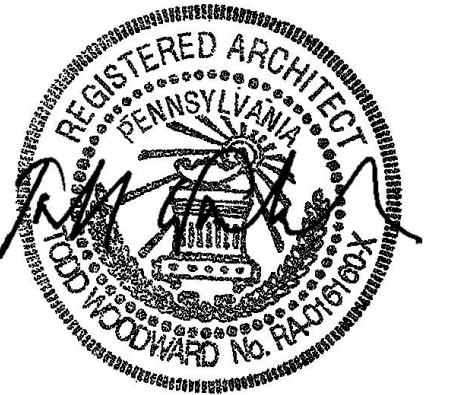

03/05/2021
DATE

SMP ARCHITECTS
1600 WALNUT STREET, SECOND FLOOR
PHILADELPHIA, PENNSYLVANIA

COMMONWEALTH OF PENNSYLVANIA
DEPARTMENT OF GENERAL SERVICES
HARRISBURG, PENNSYLVANIA

D.G.S. PROJECT No.
C-114-0006 PHASE 1

HICKORY RUN STATE PARK
LATRINE IMPROVEMENTS
DEPT of CONSERVATION AND NATURAL RESOURCES
WHITE HAVEN, CARBON COUNTY, PA

TYPICAL INTERIOR DETAILS


VERIFY SCALE

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DRAWN BY M STRENSKI	DATE 06/17/2022
CHECKED BY T WOODWARD	SCALE AS NOTED


DRAWING No.
A-26
80 OF 144




SIGN TYPE A, B, C, D

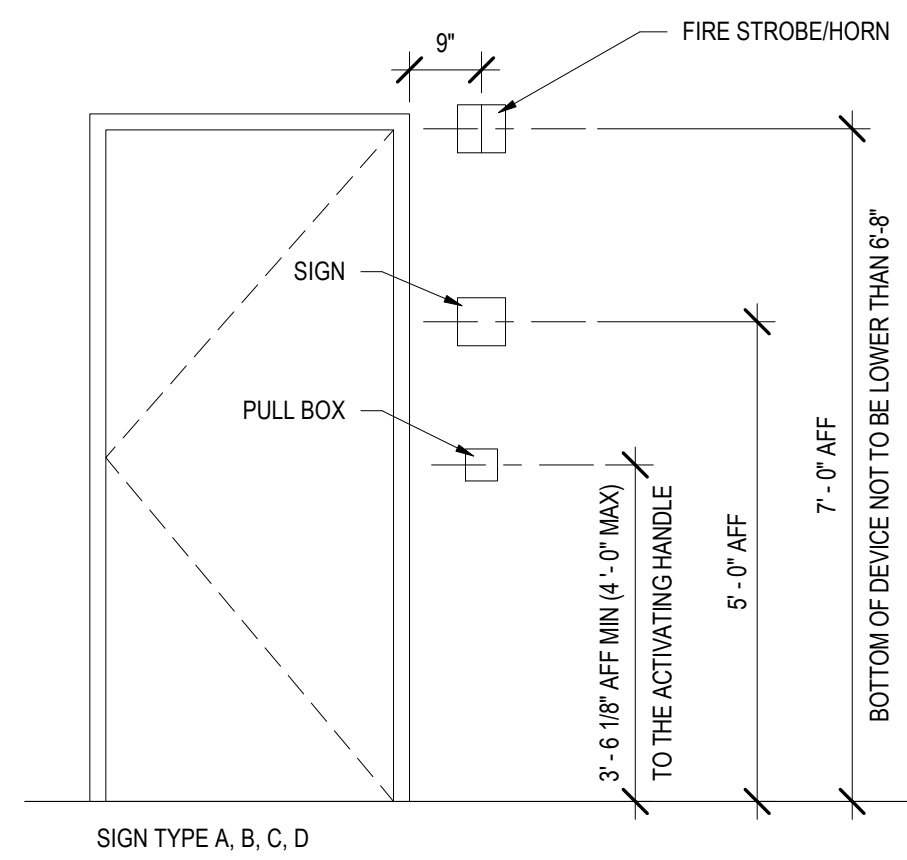SIGNAGE SCHEDULE				
DOOR NO.	ROOM	SIGN TYPE	SIGN TEXT	Notes
Level 1				
A101	WOMEN	A & D	WOMEN & EXIT	
A101B	WOMEN	A & D	WOMEN & EXIT	
A102	RESTROOM	C	RESTROOM	
A104	RESTROOM	C	RESTROOM	
A105	MEN	B & D	MEN & EXIT	
A105B	MEN	B & D	MEN & EXIT	
B100	MEN	B & D	MEN & EXIT	
B102	WOMEN	A & D	WOMEN & EXIT	
B103	RESTROOM	C	RESTROOM	*CONCEALED MOUNTING BRACKET AT STONE WALL
CD100	MEN	B & D	MEN & EXIT	C = DADDY ALLEN / D = SHEHAQUA
CD101	RESTROOM	C	RESTROOM	C = DADDY ALLEN / D = SHEHAQUA
CD102	WOMEN	A & D	WOMEN & EXIT	C = DADDY ALLEN / D = SHEHAQUA


2 SIGNAGE AND DEVICE PLACEMENT
A-27 1/2" = 1'-0"

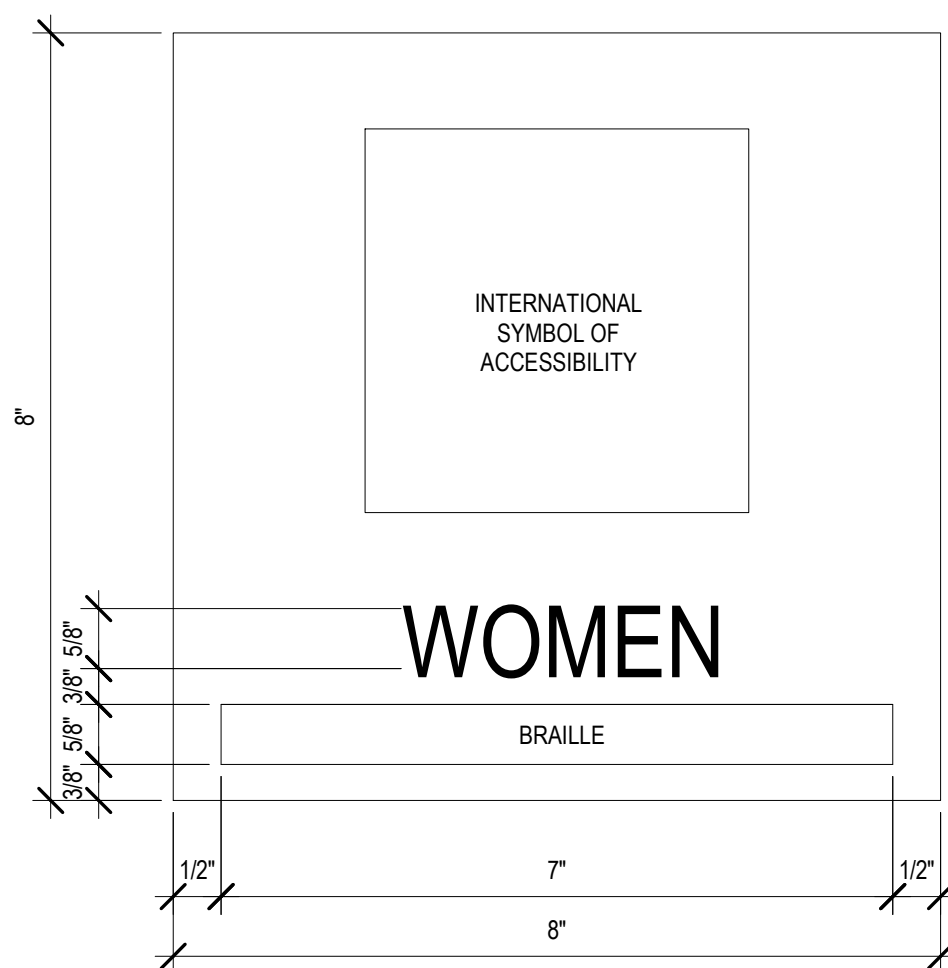


TYPE A

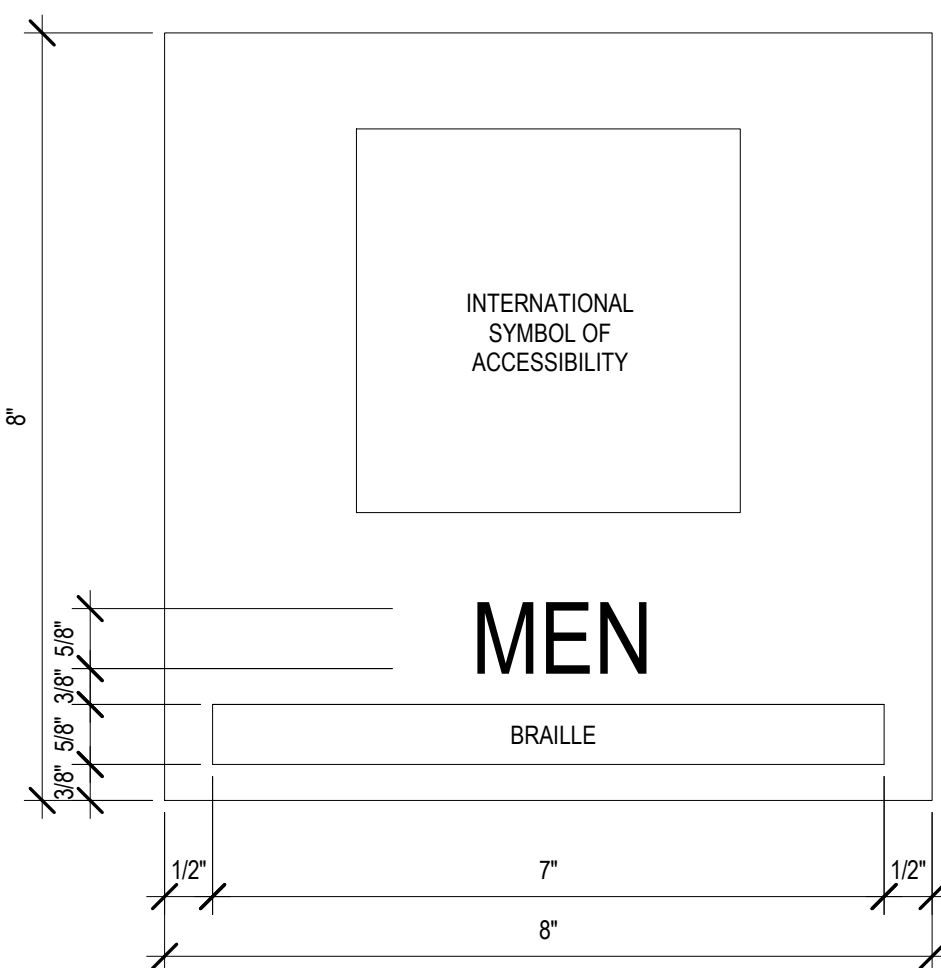

TYPE B

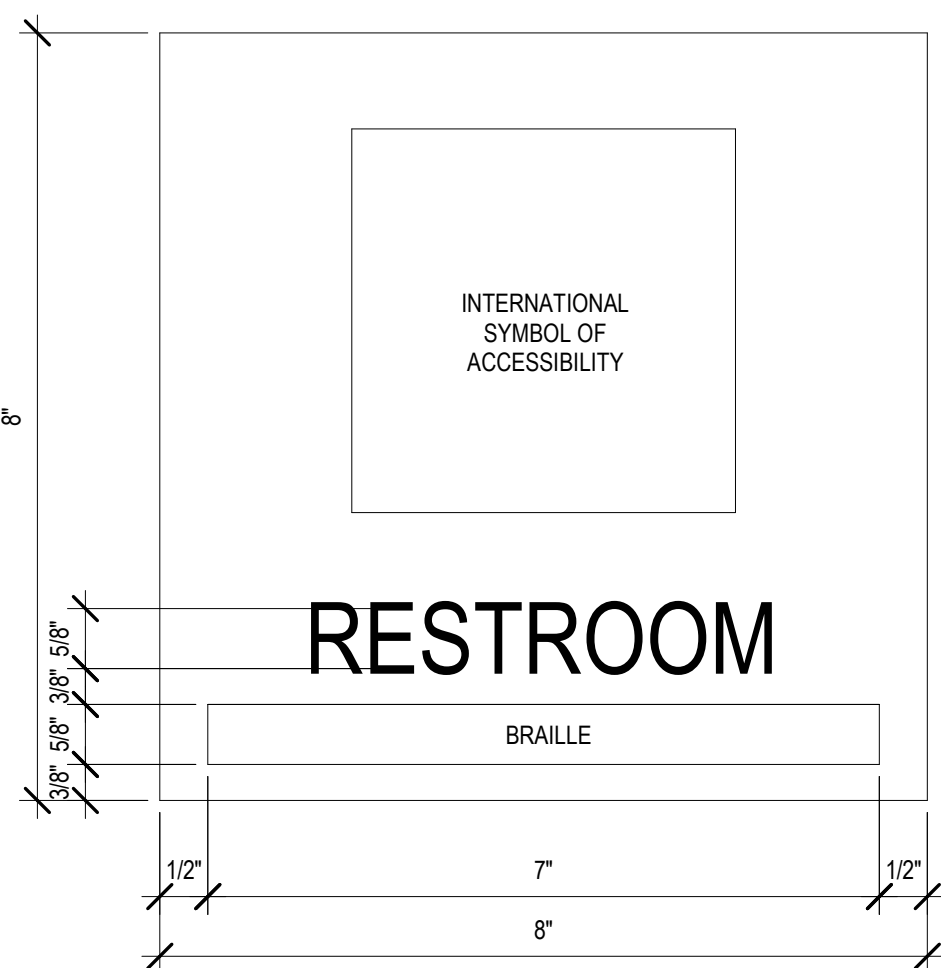

TYPE C

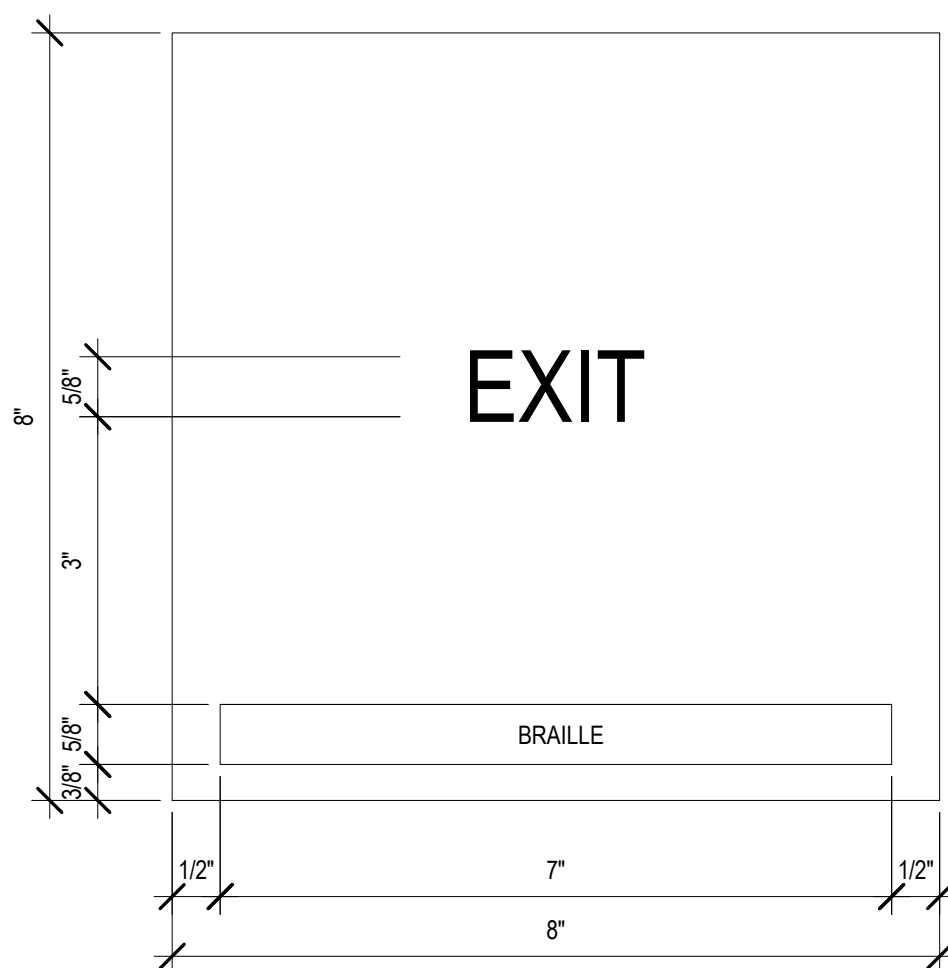

TYPE D

1 SIGNAGE TYPES
A-27 6" = 1'-0"

VERIFY SCALE

BAR IS ONE (1) INCH LONG
ON ORIGINAL DRAWING: 0 1
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DRAWN BY: M STRENSKI
CHECKED BY: T WOODWARD

DATE: 06/17/2022
SCALE: AS NOTED

DRAWING No. **A-27**

81 OF 144

CONSTRUCTION DOCUMENTS

RECORD	REVISIONS

REGISTERED ARCHITECT
PENNSYLVANIA
SMP ARCHITECTS
1600 WALNUT STREET, SECOND FLOOR
PHILADELPHIA, PENNSYLVANIA

HARRISBURG, PENNSYLVANIA

D.G.S. PROJECT No. C-114-0006 PHASE 1
HICKORY RUN STATE PARK
LATRINE IMPROVEMENTS
DEPT of CONSERVATION AND NATURAL RESOURCES
WHITE HAVEN, CARBON COUNTY, PA

SIGNAGE

03/05/2021
DATE

PRIMARY CODES AND SPECIFICATIONS

1. GENERAL BUILDING CODE:

a. 2015 INTERNATIONAL BUILDING CODE AND REFERENCED STANDARDS.

2. CONCRETE CODES:

a. LATEST EDITION OF THE BUILDING CODE REQUIREMENTS FOR STRUCTURAL CONCRETE (ACI 318).
b. LATEST EDITION OF THE SPECIFICATIONS FOR STRUCTURAL CONCRETE FOR BUILDINGS (ACI 301).
c. LATEST EDITION OF THE CRSI MANUAL OF STANDARD PRACTICE WITH ALL SUPPLEMENTS.

3. STRUCTURAL STEEL CODES:

a. LATEST EDITION OF THE SPECIFICATION FOR STRUCTURAL STEEL BUILDINGS, (AISC 360).
b. LATEST EDITION OF THE CODE OF STANDARD PRACTICE FOR STEEL BUILDINGS AND BRIDGES, (AISC 303).

4. OPEN WEB STEEL JOISTS:

a. LATEST EDITION OF THE STANDARD SPECIFICATION FOR STEEL JOISTS (SJI 100).
b. LATEST EDITION OF THE CODE OF STANDARD PRACTICE FOR STEEL JOISTS AND JOIST GIRDERS (SJI COSP).

5. MASONRY CONSTRUCTION:

a. BUILDING CODE REQUIREMENTS FOR MASONRY STRUCTURES (ACI 530).
b. SPECIFICATIONS FOR MASONRY STRUCTURES (ACI 530.1).

6. STEEL DECK:

a. LATEST EDITION OF THE SDI DESIGN MANUALS FOR COMPOSITE DECKS, FORM DECKS AND ROOF DECKS.

7. COLD FORMED METAL FRAMING:

a. NORTH AMERICAN SPECIFICATION FOR THE DESIGN OF COLD FORMED STEEL STRUCTURAL MEMBERS, (AISI S100).

DESIGN LOADS

1. ROOF LIVE LOADS:

a. UNIFORMLY DISTRIBUTED LIVE LOAD
i. ON HORIZONTAL PROJECTION 20 PSF
b. SEE ROOF FRAMING PLAN FOR OTHER CONCENTRATED EQUIPMENT LOADS.

2. FLOOR LIVE LOADS:

a. UNIFORMLY DISTRIBUTED LIVE LOADS:
i. PUBLIC ROOM 100 PSF

3. SUPERIMPOSED DEAD LOADS:

c. TYPICAL FLOORS 25 PSF

5. WIND LOADS:

a. LOADS BASED ON ASCE 7-10 WIND LOAD CRITERIA.
BASIC WIND SPEED, 3 SECOND GUST 109 MPH
HURRICANE PRONE REGION NO
WINDBORNE DEBRIS REGION NO
BUILDING CLASSIFICATION CATEGORY II
IMPORTANCE FACTOR 1.00
INTERNAL PRESSURE COEFFICIENT +/- 0.18
WIND EXPOSURE CATEGORY B
WIND TOPOGRAPHIC FACTOR, Kzt 1.0

6. SNOW LOADS

a. GROUND SNOW LOAD = 40 PSF PER LOCAL BUILDING CODE (KIDDER TOWNSHIP) & DRIFTING PER ASCE 7-10

7. SEE LOADING NOTES, TABLES AND DIAGRAMS FOR DESIGN FORCES FOR COMPONENTS DESIGNED BY DELEGATED ENGINEERS.

8. SEISMIC: DESIGN CATEGORY A

Table with 2 columns: Abbreviation and Description. Includes entries like AB Anchor Bolt, ACI American Concrete Institute, ADDNL Additional, etc.


Table with 2 columns: Abbreviation and Description. Includes entries like LDH Hook Development Length, LL Live Load, LLH Long Leg Horizontal, etc.

CONSTRUCTION DOCUMENTS



Table with 2 columns and 2 rows for record revisions.

RECORD REVISIONS

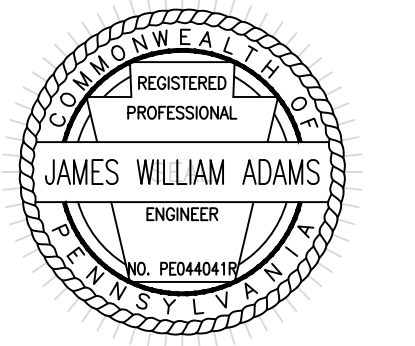

Signature: James W. Adams, Date: 11/19/21

SMP ARCHITECTS

1600 WALNUT STREET, SECOND FLOOR
PHILADELPHIA, PENNSYLVANIA

COMMONWEALTH OF PENNSYLVANIA
DEPARTMENT OF GENERAL SERVICES

D.G.S. PROJECT No. C-114-0006 PHASE 1

HICKORY RUN STATE PARK
LATRINE IMPROVEMENTS

DEPT of CONSERVATION AND NATURAL RESOURCES
WHITE HAVEN, CARBON COUNTY, PA

PRIMARY CODES, SYMBOLS AND ABBREVIATIONS

VERIFY SCALE


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IF BAR IS NOT ONE (1) INCH LONG, ADJUST SCALE ACCORDINGLY

CONTRACTOR SHALL FIELD VERIFY ALL DIMENSIONS. VARIANCE FROM CONTRACT DOCUMENTS NOT PERMITTED WITHOUT PROFESSIONAL & BUREAU OF CONSTRUCTION APPROVAL.

DRAWN BY: M DIMONTE, DATE: 06/17/2022, CHECKED BY: J ADAMS, SCALE: AS NOTED

DRAWING No. S-1


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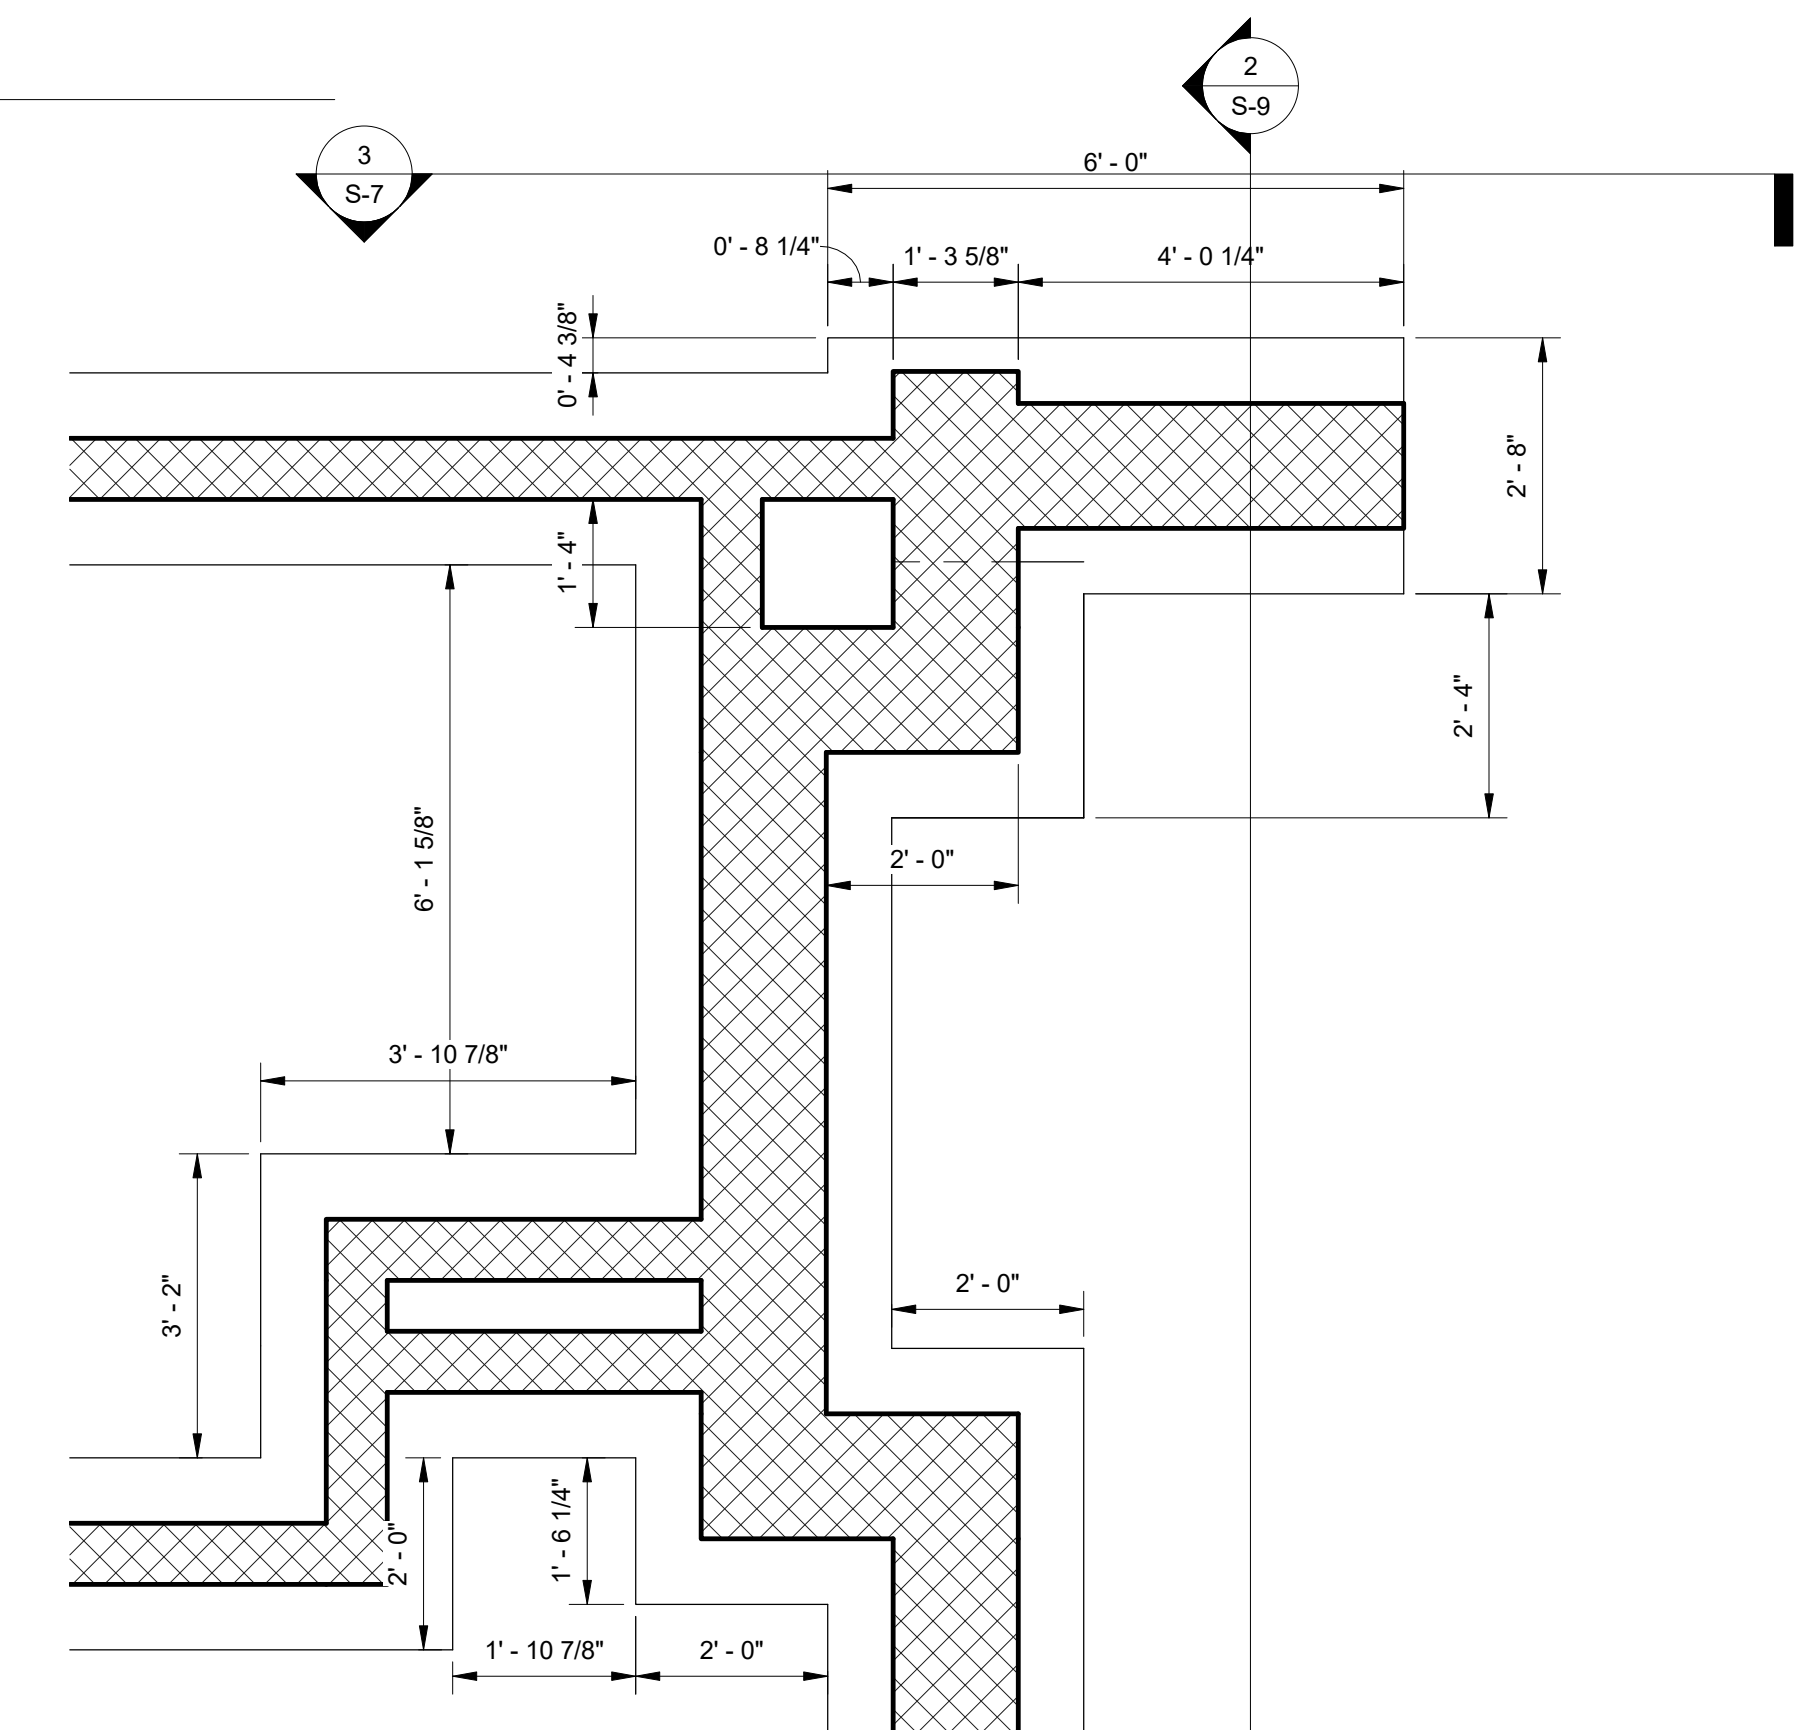
N 318285.3226
E 2539518.6850

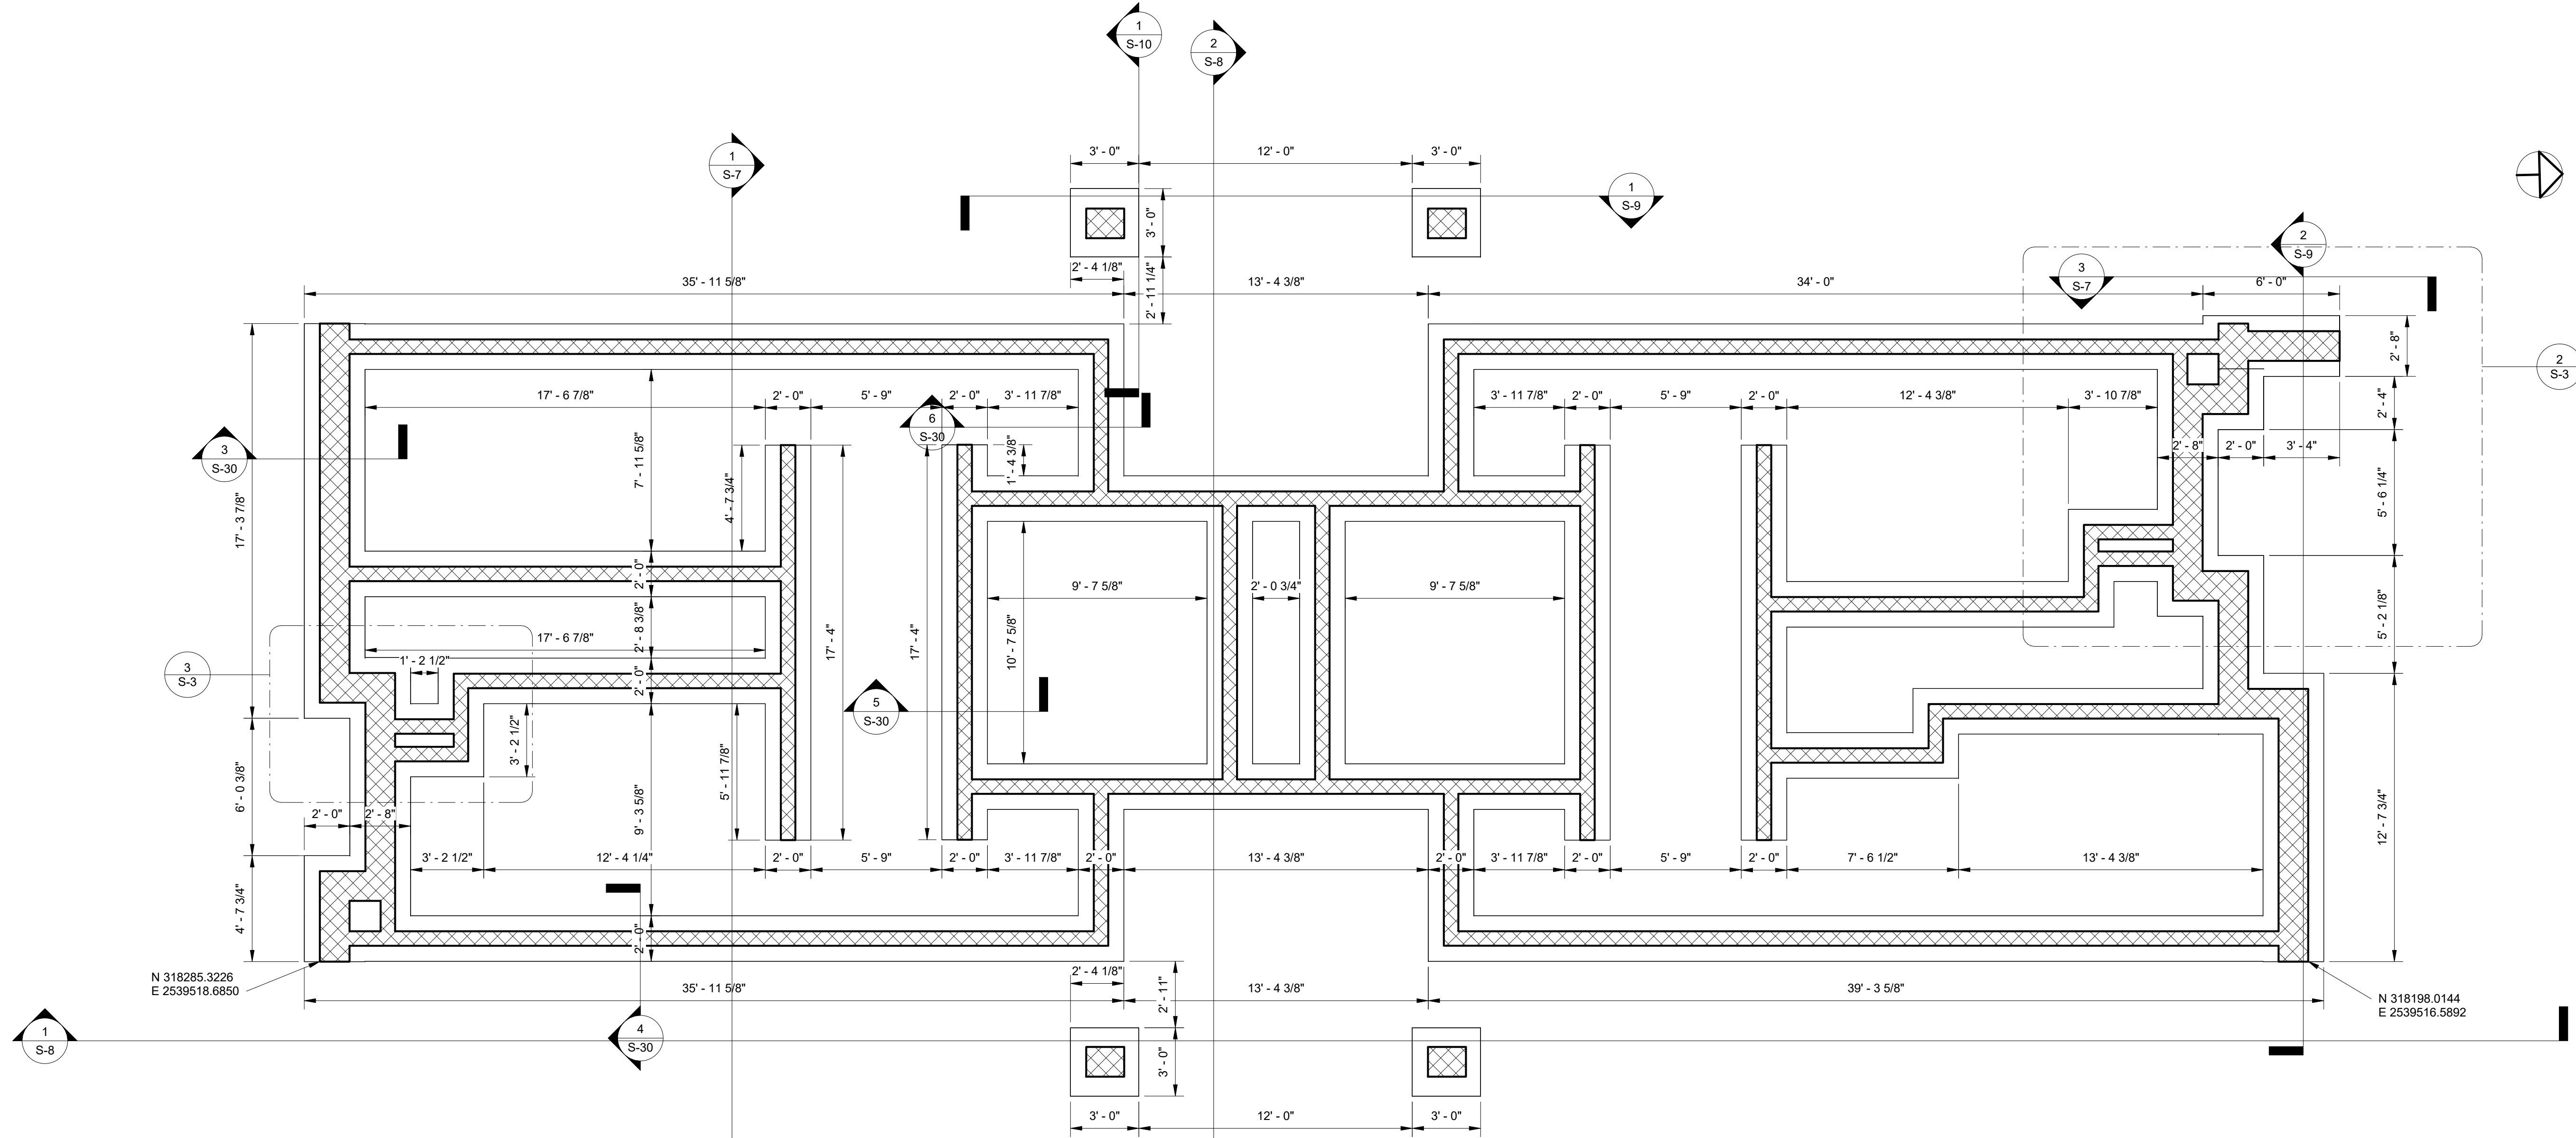N 318198.0144
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① Footing - Loop C
1/4" = 1'-0"



③ Footing - Loop C - Callout 1
3/4" = 1'-0"

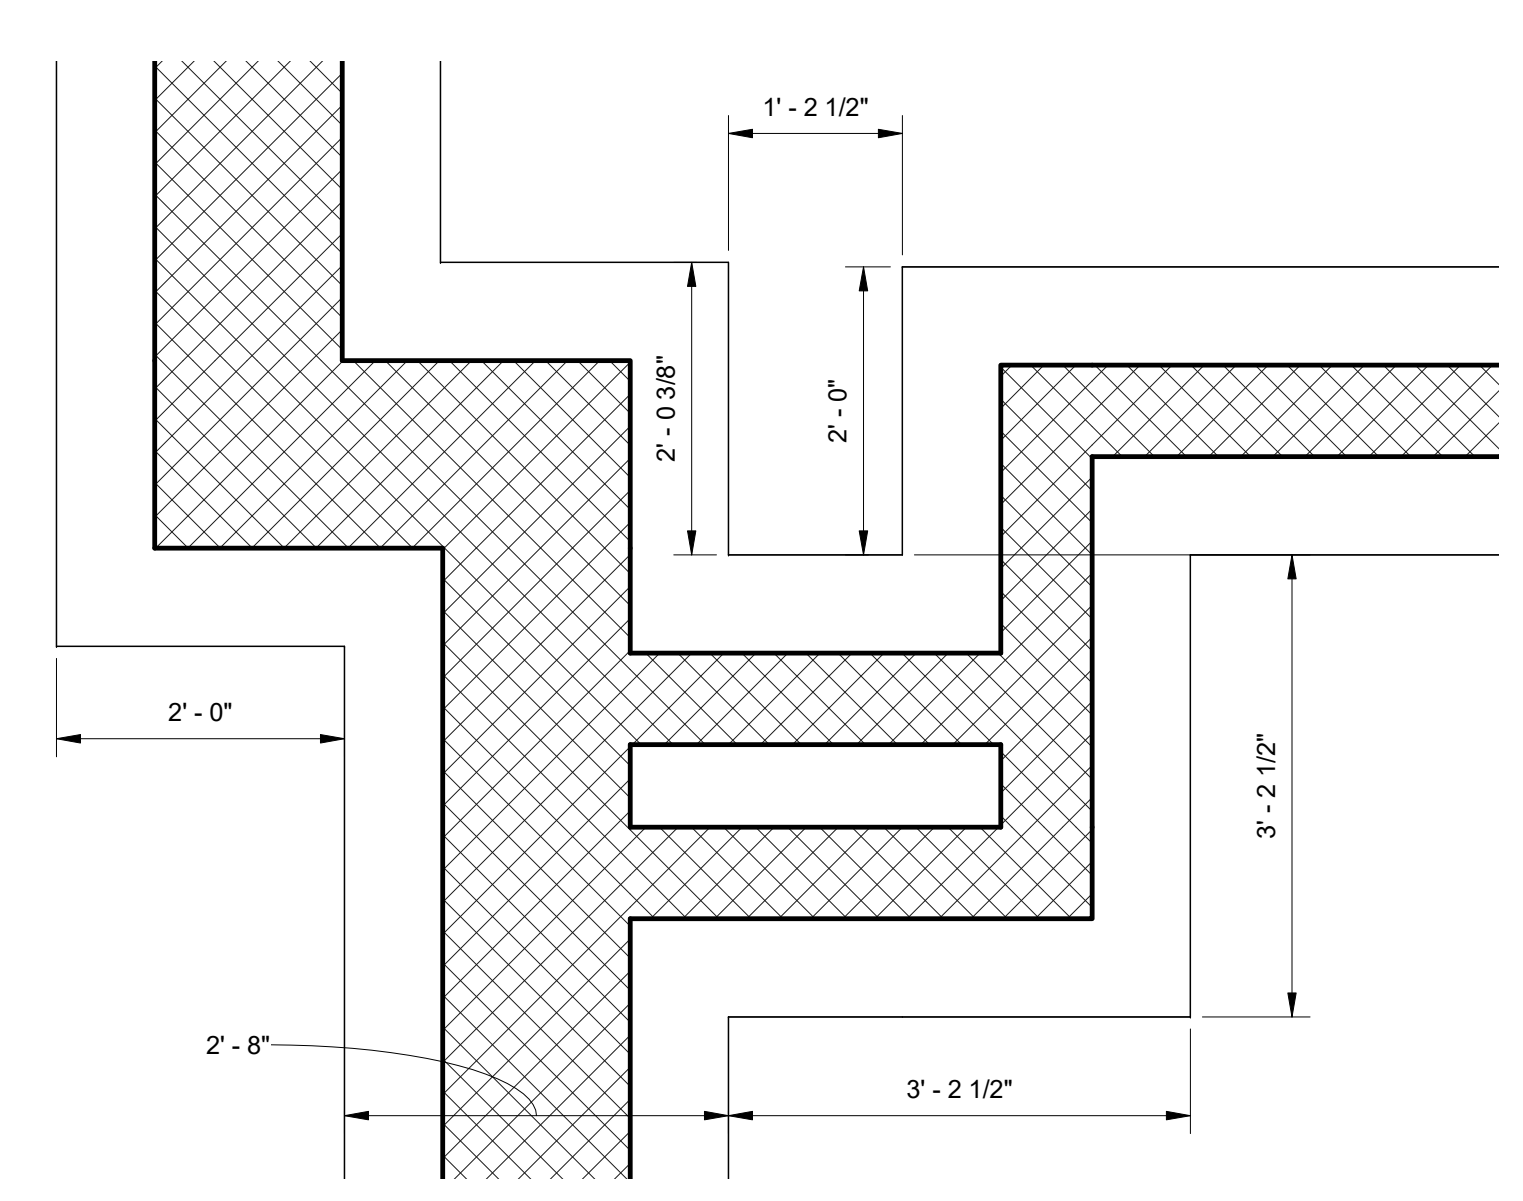


② Loop C Bench Foundation
1/2" = 1'-0"

NOTES:
1. FOR GENERAL NOTES SEE SHEET S-2
2. FOR SYMBOLS AND ABBREVIATIONS SEE SHEET S-1

CONSTRUCTION DOCUMENTS



NO.	DATE	REVISIONS

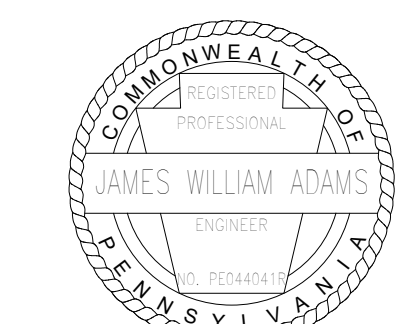

James W. Adams
SIGNATURE DATE 11/19/2021

SMP ARCHITECTS
1600 WALNUT STREET, SECOND FLOOR
PHILADELPHIA, PENNSYLVANIA

COMMONWEALTH OF PENNSYLVANIA
DEPARTMENT OF GENERAL SERVICES
HARRISBURG, PENNSYLVANIA


D.G.S. PROJECT No.
C-114-0006 PHASE 1

HICKORY RUN STATE PARK
LATRINE IMPROVEMENTS
DEPT of CONSERVATION AND NATURAL RESOURCES
WHITE HAVEN, CARBON COUNTY, PA


LOOP C FOOTING PLAN

VERIFY SCALE	
BAR IS ONE (1) INCH LONG	ON ORIGINAL DRAWING: 1
IF BAR IS NOT ONE (1) INCH LONG, ADJUST SCALE ACCORDINGLY	0
CONTRACTOR SHALL FIELD VERIFY ALL DIMENSIONS VARIANCE FROM PERMITTED DOCUMENTS NOT PERMITTED WITHOUT PROFESSIONAL & BUREAU OF CONSTRUCTION APPROVAL.	


DRAWN BY J ADAMS	DATE 06/17/2022	DRAWING No. S-3
CHECKED BY J ADAMS	SCALE AS NOTED	84 OF 144

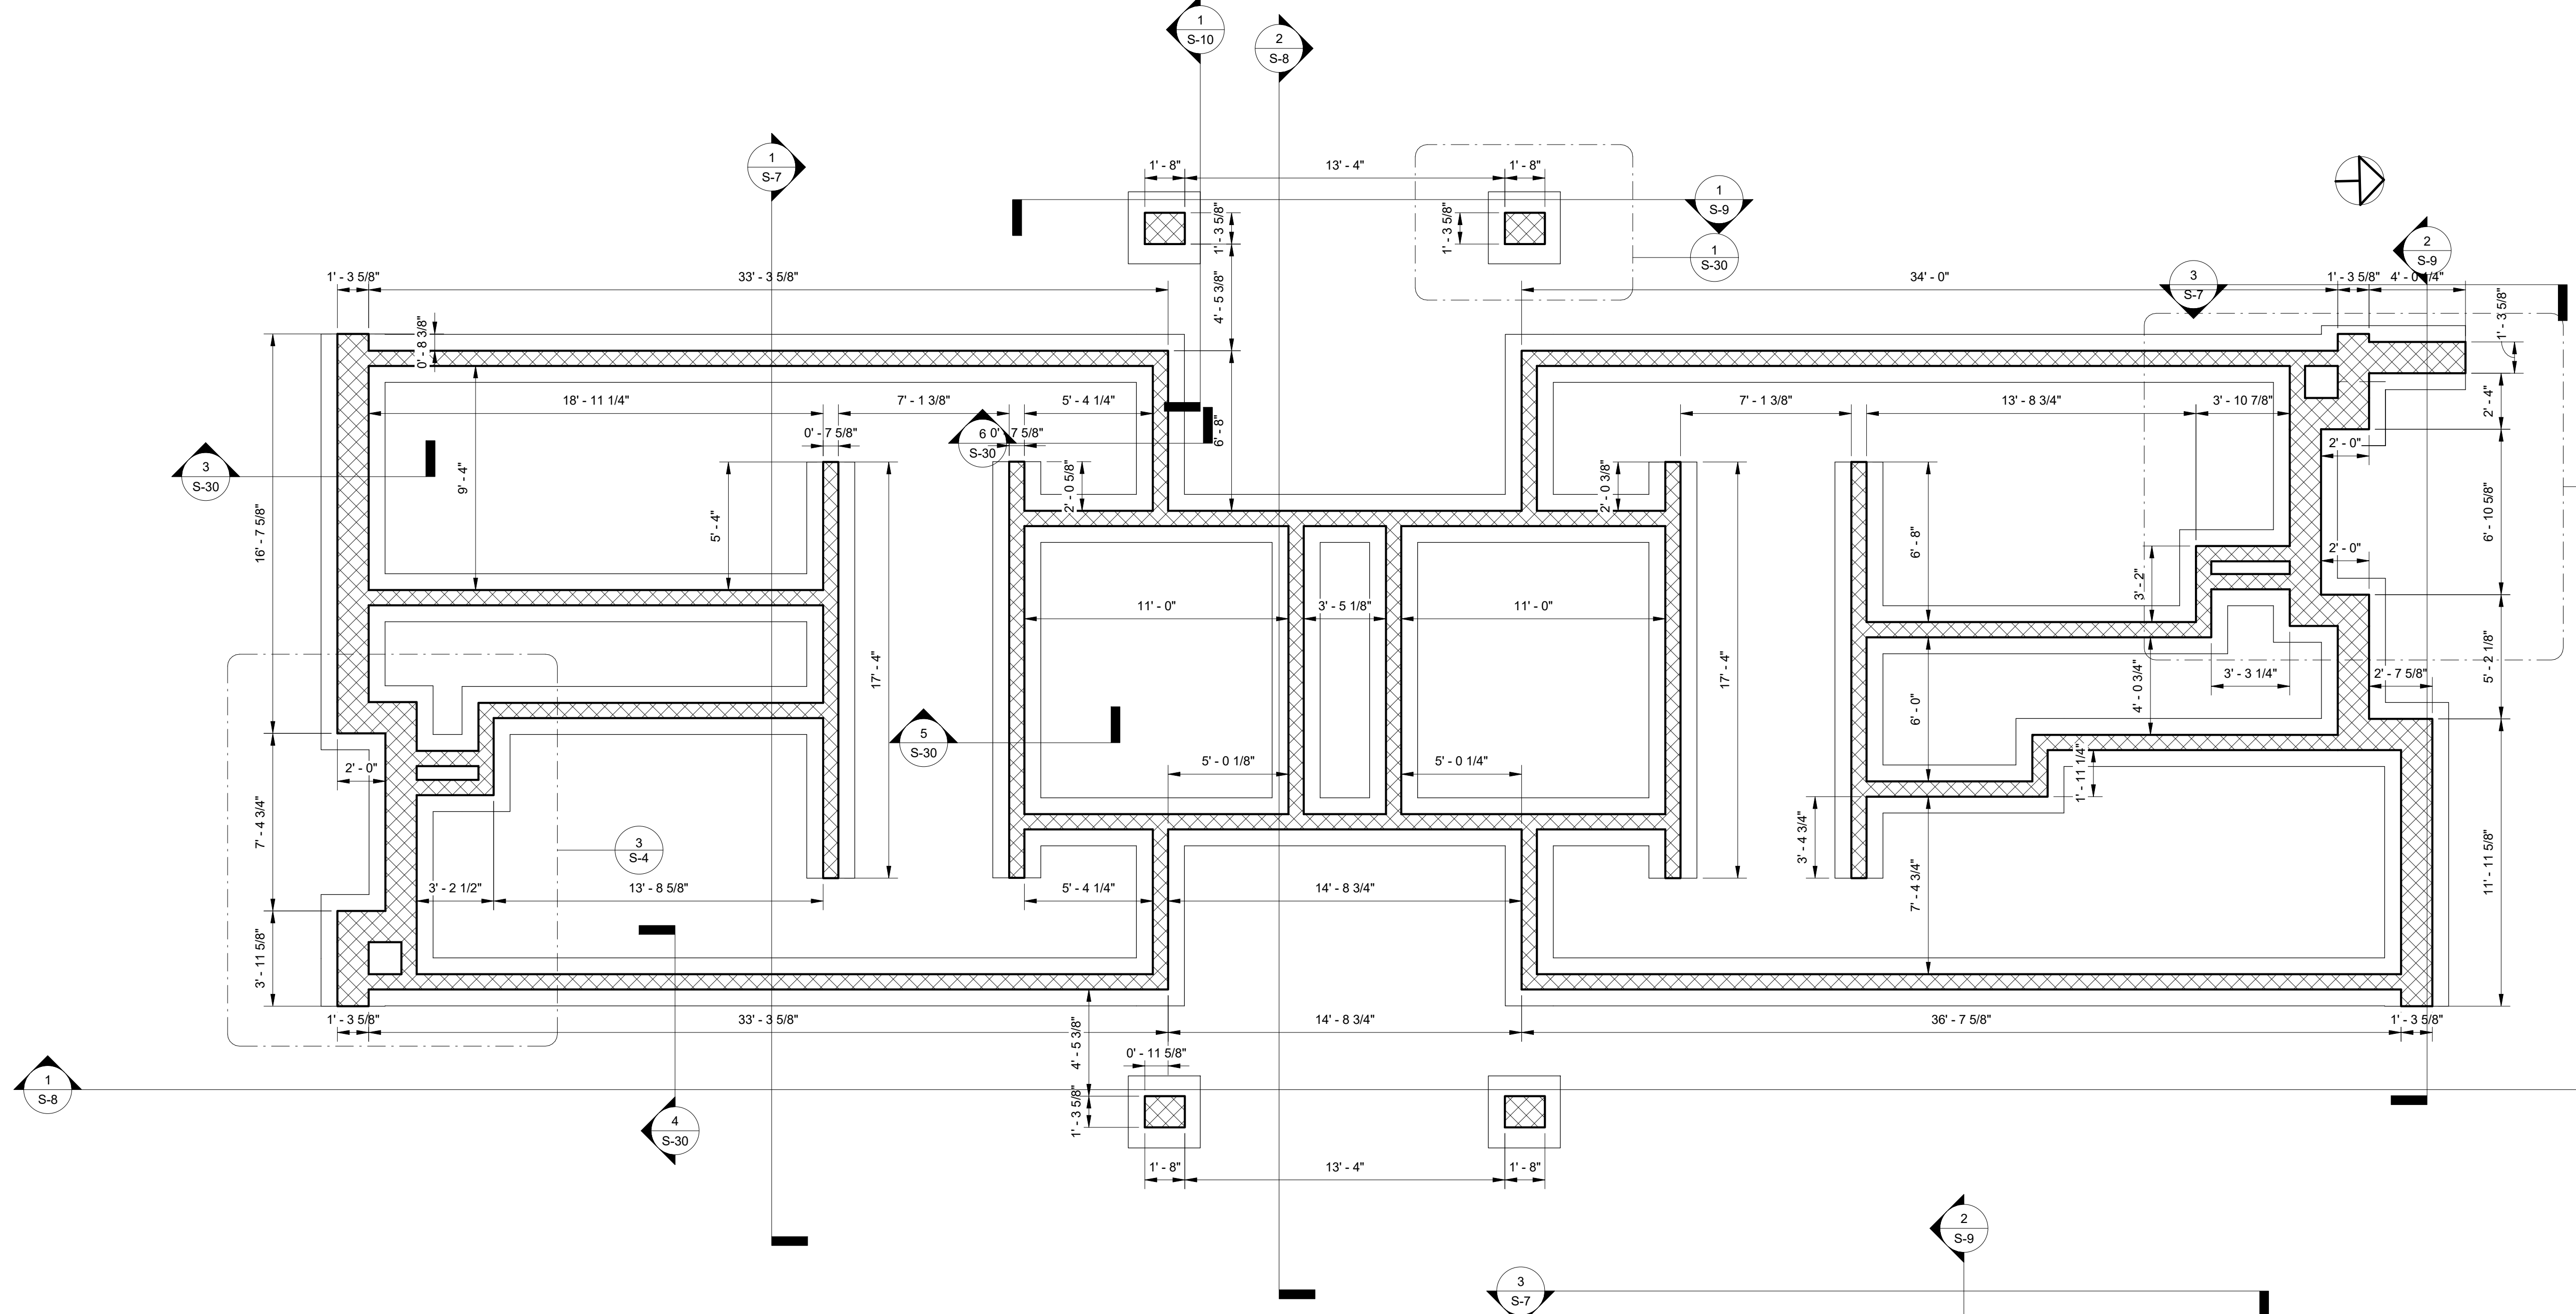

① Foundation Wall - Loop C
1/4" = 1'-0"

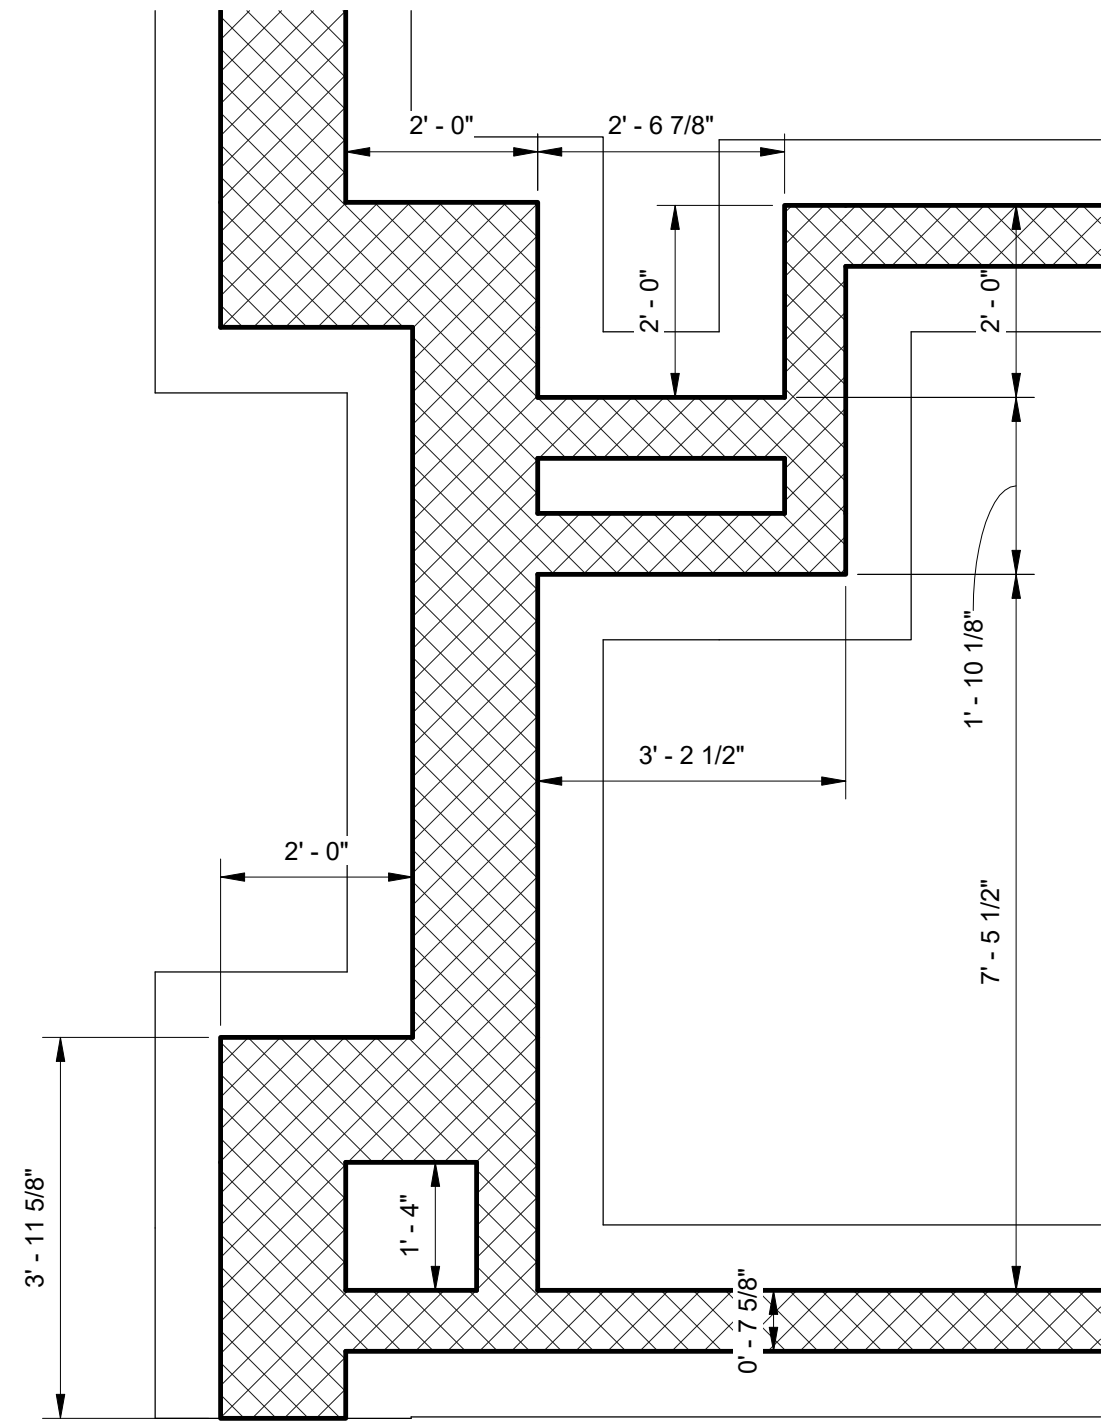

③ Foundation Wall - Loop C - Callout 2
1/2" = 1'-0"

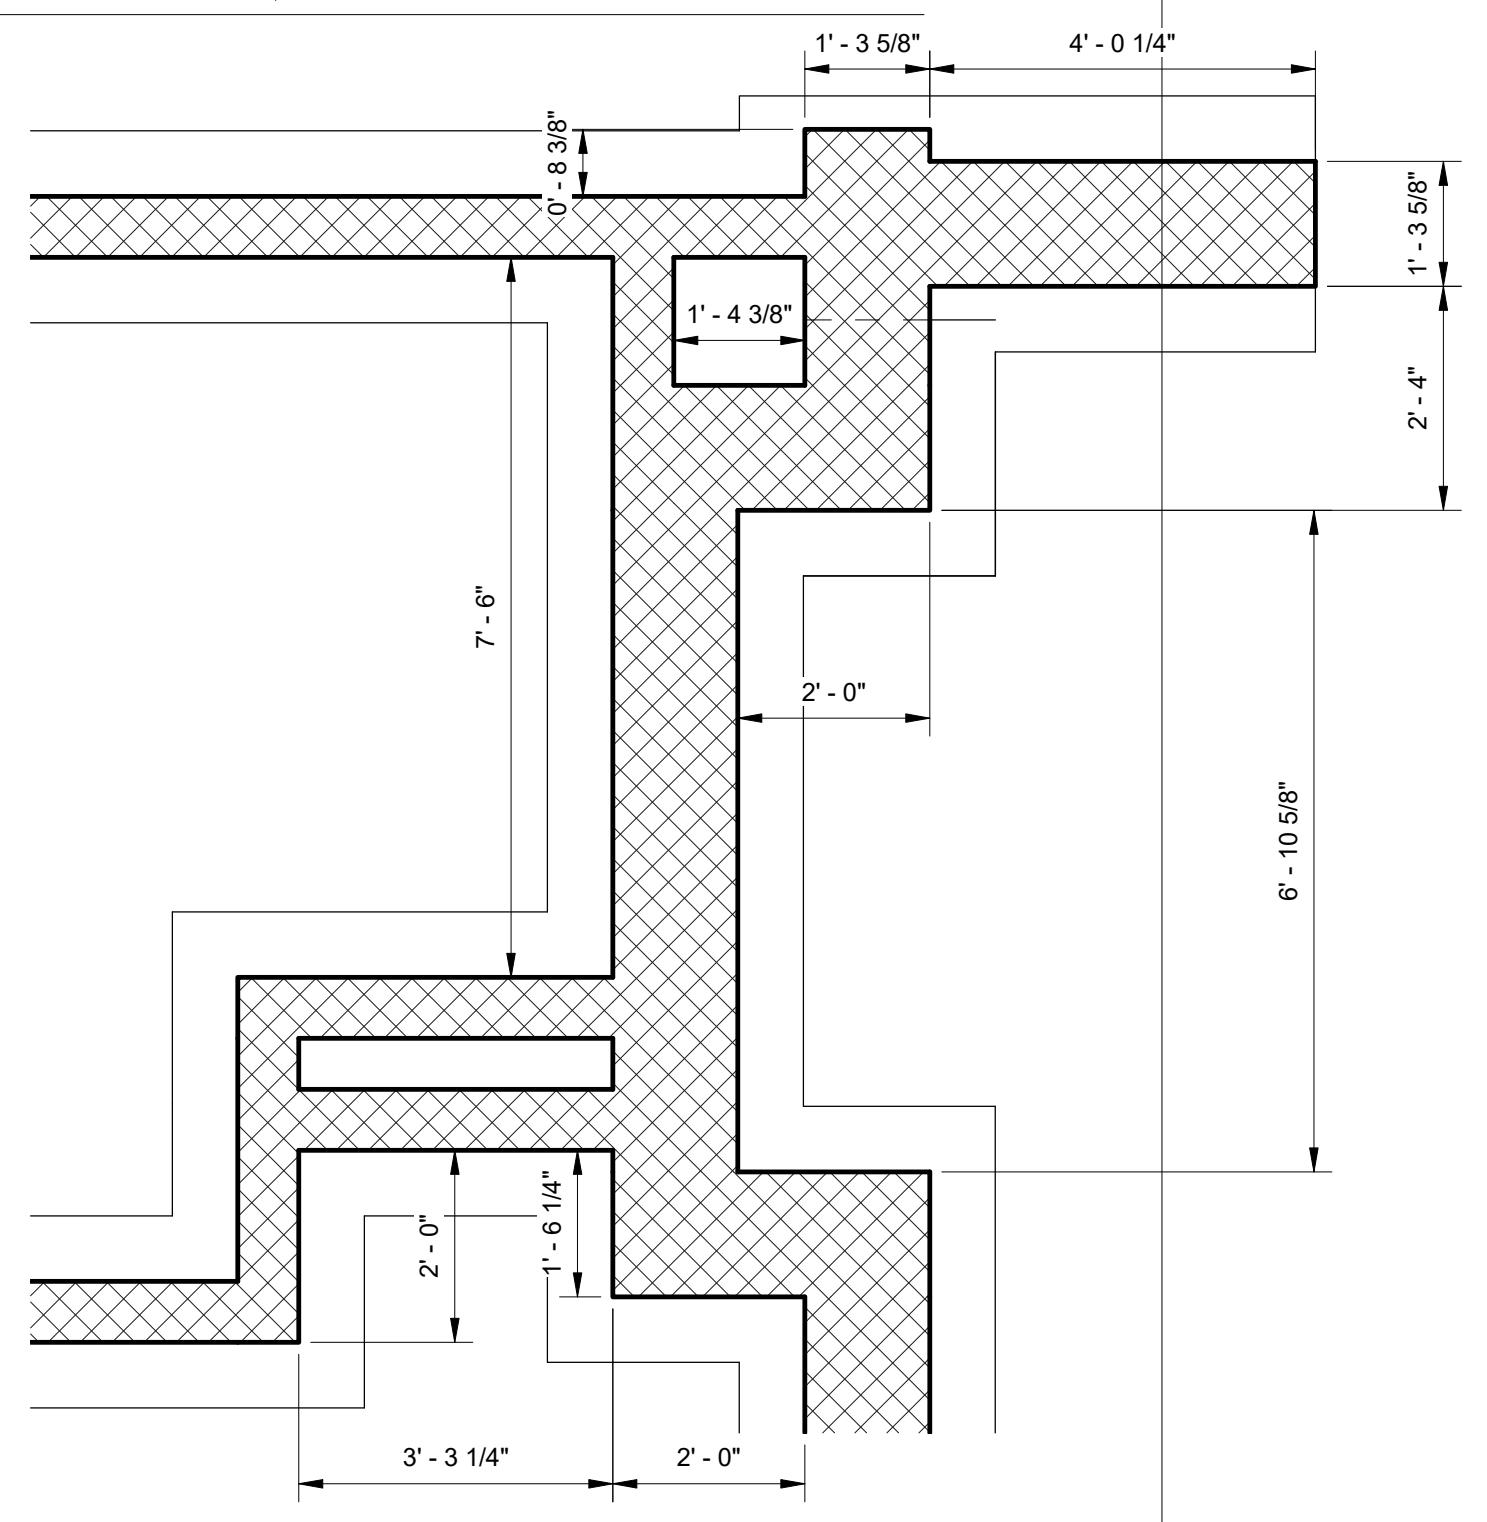


② Foundation Wall - Loop C - Callout 1
1/2" = 1'-0"

NOTES:
1. FOR GENERAL NOTES SEE SHEET S-2
2. FOR SYMBOLS AND ABBREVIATIONS SEE SHEET S-1

CONSTRUCTION DOCUMENTS



NO.	REVISION	DATE

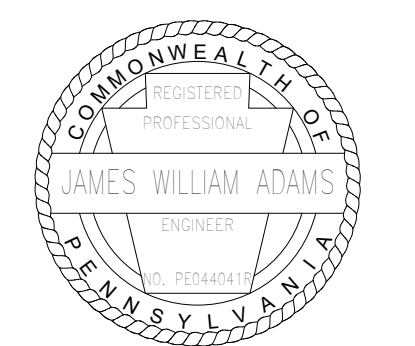

James W. Adams
SIGNATURE DATE 11/19/2021

SMP ARCHITECTS
1600 WALNUT STREET, SECOND FLOOR
PHILADELPHIA, PENNSYLVANIA

COMMONWEALTH OF PENNSYLVANIA
DEPARTMENT OF GENERAL SERVICES
HARRISBURG, PENNSYLVANIA


D.G.S. PROJECT No. C-114-0006 PHASE 1

HICKORY RUN STATE PARK
LATRINE IMPROVEMENTS
DEPT of CONSERVATION AND NATURAL RESOURCES
WHITE HAVEN, CARBON COUNTY, PA

LOOP C FOUNDATION WALL PLAN

VERIFY SCALE
BAR IS ONE (1) INCH LONG
ON ORIGINAL DRAWING: 1
IF BAR IS NOT ONE (1) INCH LONG, ADJUST SCALE ACCORDINGLY
CONTRACTOR SHALL FIELD VERIFY ALL DIMENSIONS
VARIANCE FROM CONTRACT DOCUMENTS NOT PERMITTED WITHOUT PROFESSIONAL & BUREAU OF CONSTRUCTION APPROVAL.

DRAWN BY J ADAMS	DATE 06/17/2022	DRAWING No. S-4
CHECKED BY J ADAMS	SCALE AS NOTED	85 OF 144

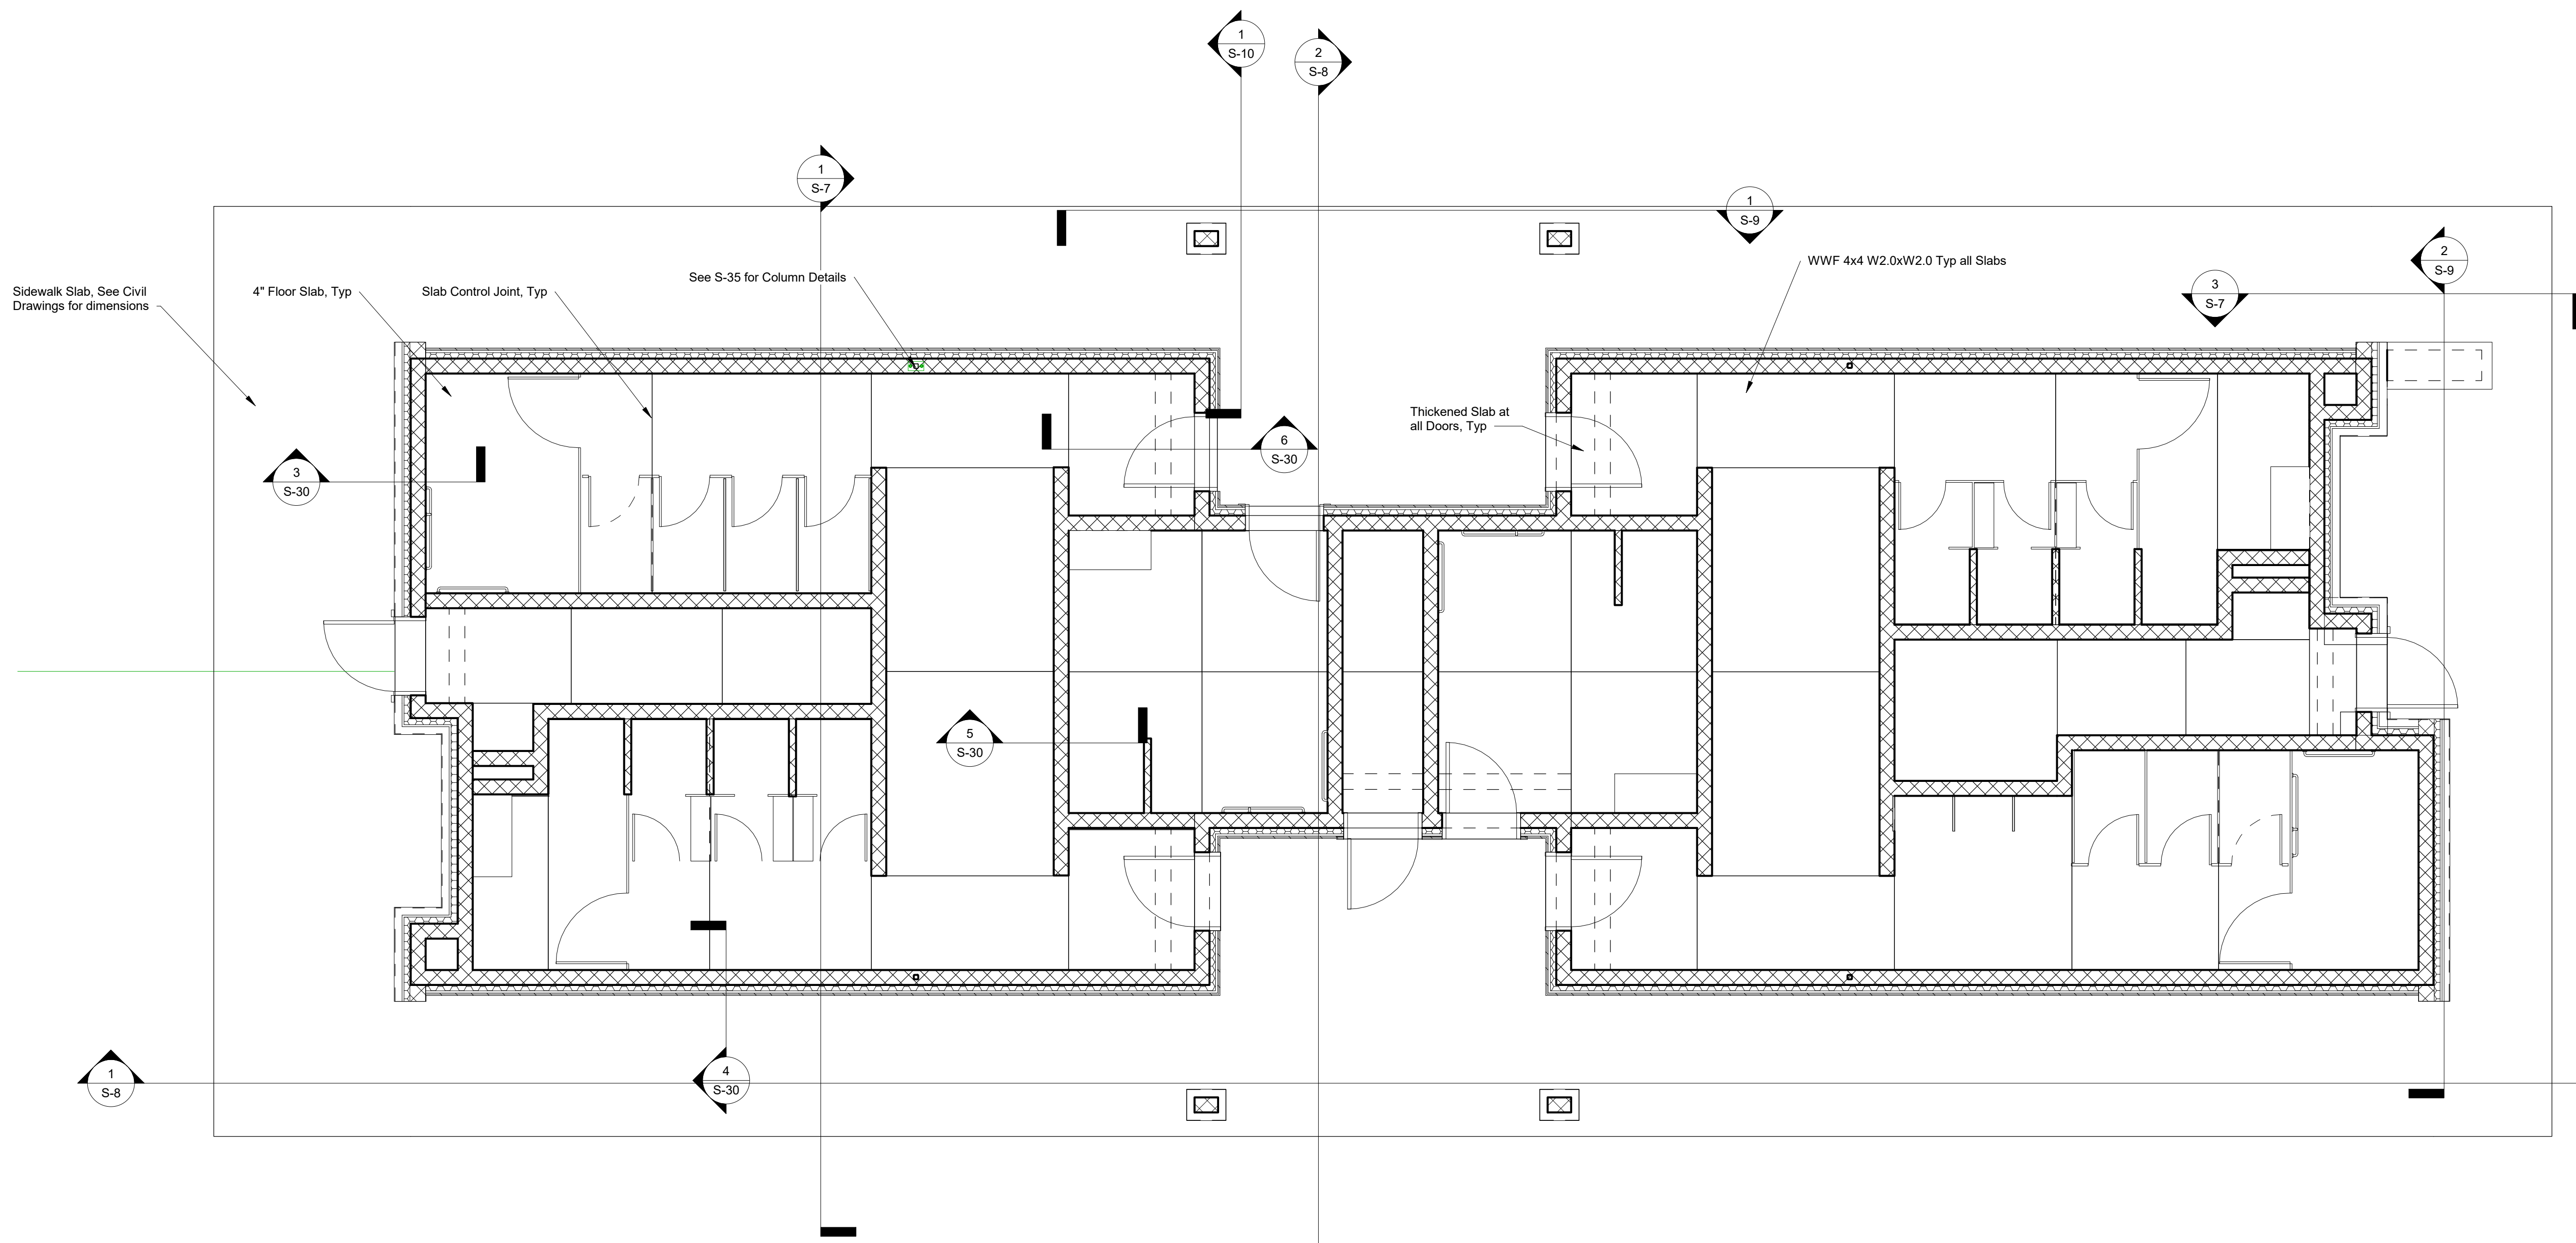


1 Slab and Wall Plan - Loop C
1/4" = 1'-0"

CONSTRUCTION DOCUMENTS



NO.	REVISION

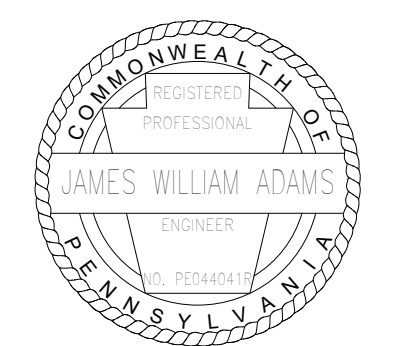

James W. Adams
SIGNATURE DATE 11/19/2021

SMP ARCHITECTS
1600 WALNUT STREET, SECOND FLOOR
PHILADELPHIA, PENNSYLVANIA

COMMONWEALTH OF PENNSYLVANIA
DEPARTMENT OF GENERAL SERVICES
HARRISBURG, PENNSYLVANIA

D.G.S. PROJECT No.
C-114-0006 PHASE 1

HICKORY RUN STATE PARK
LATRINE IMPROVEMENTS
DEPT of CONSERVATION AND NATURAL RESOURCES
WHITE HAVEN, CARBON COUNTY, PA

LOOP C SLAB AND WALL PLAN



VERIFY SCALE
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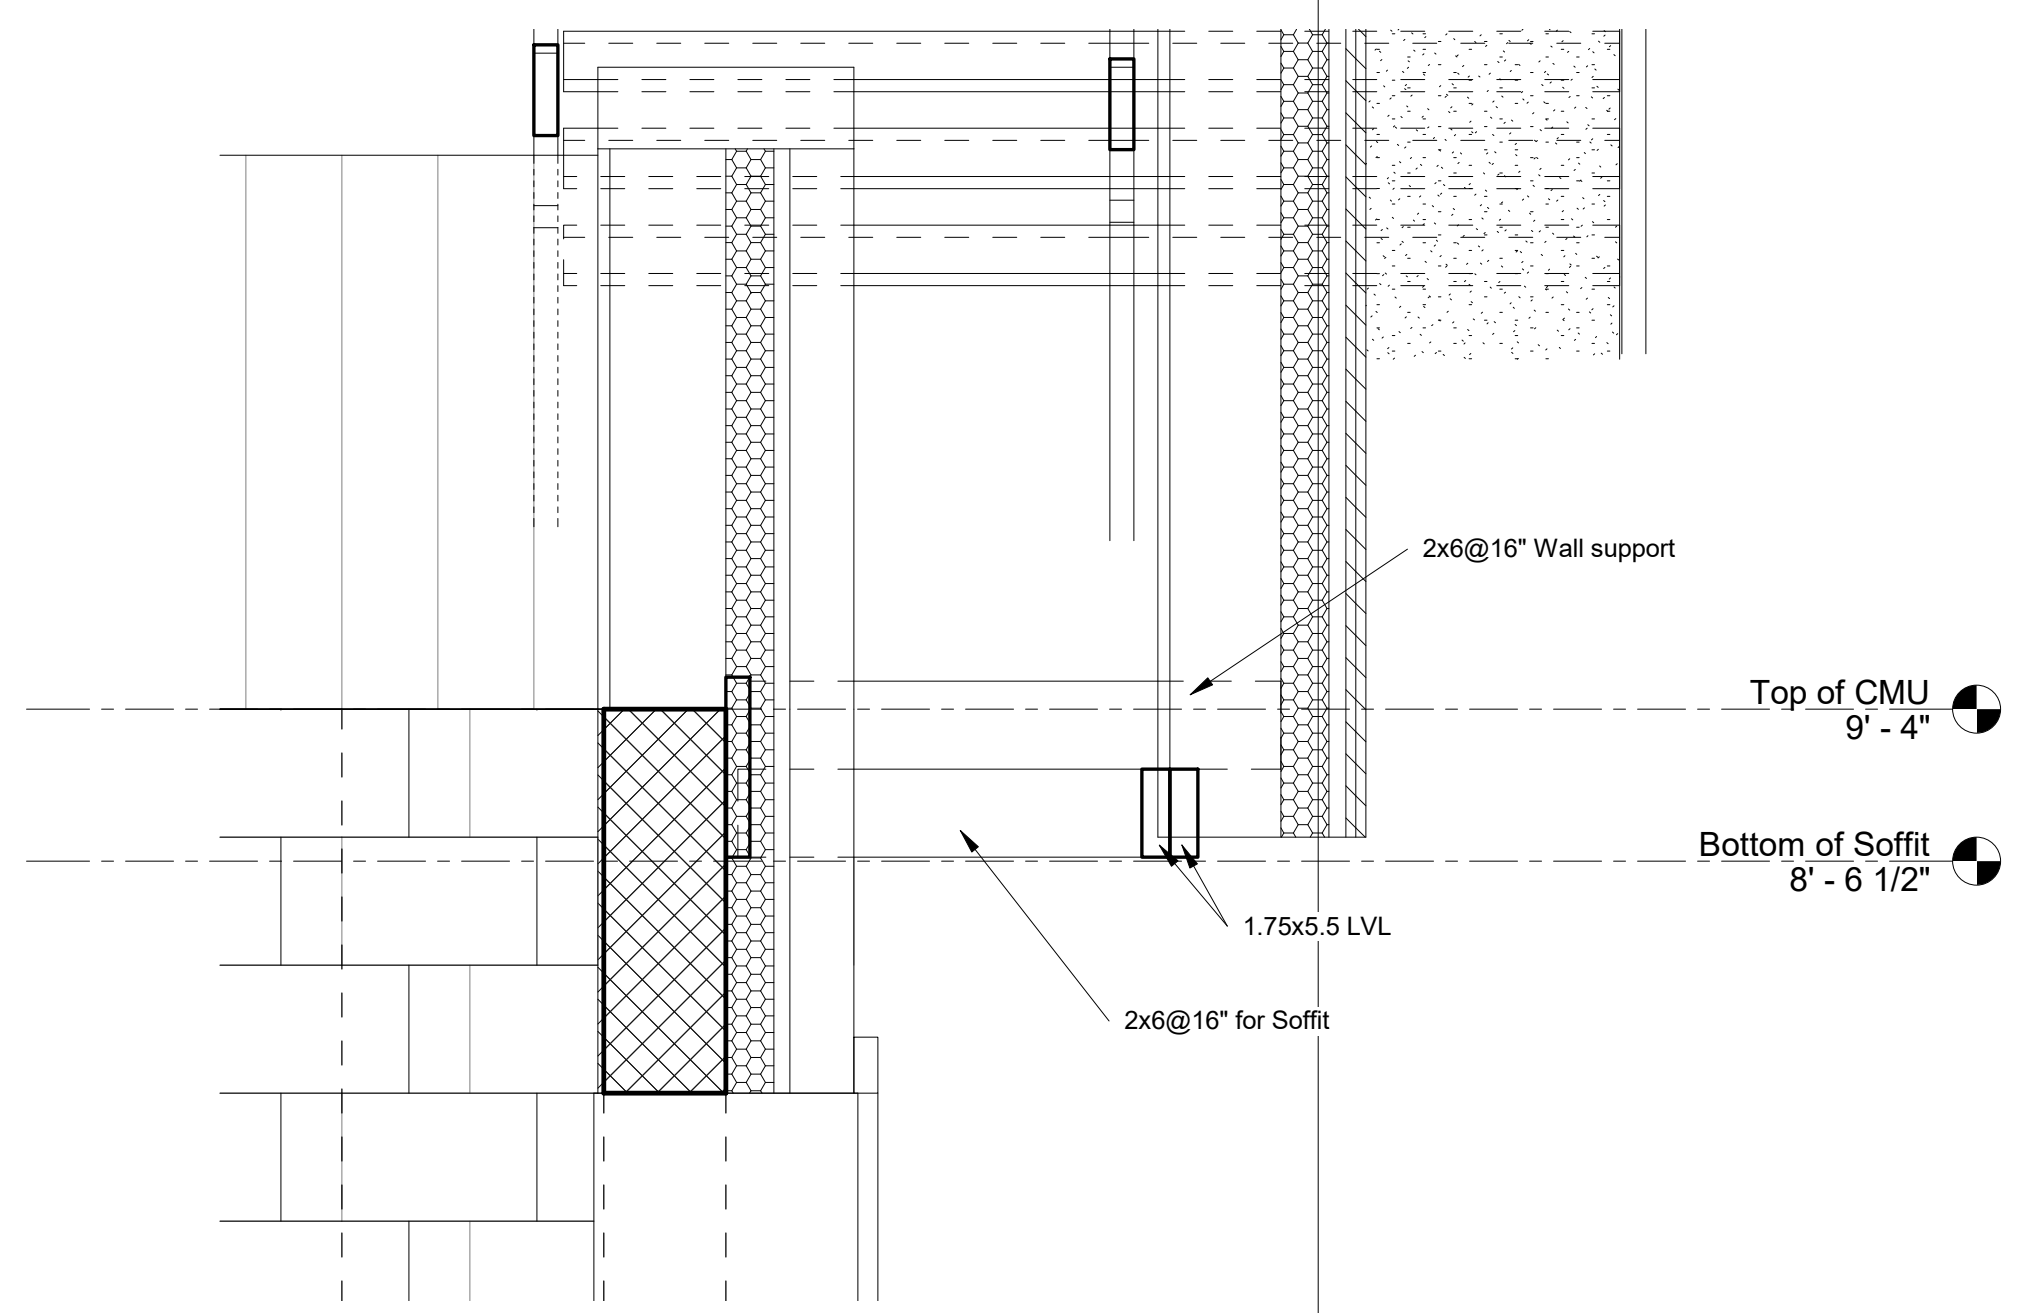
DRAWN BY J ADAMS	DATE 06/17/2022
CHECKED BY J ADAMS	SCALE AS NOTED

DRAWING No.
S-5
86 OF 144

NOTES:
1. FOR GENERAL NOTES SEE SHEET S-2
2. FOR SYMBOLS AND ABBREVIATIONS SEE SHEET S-1



② End Wall and Soffit Framing
1" = 1'-0"

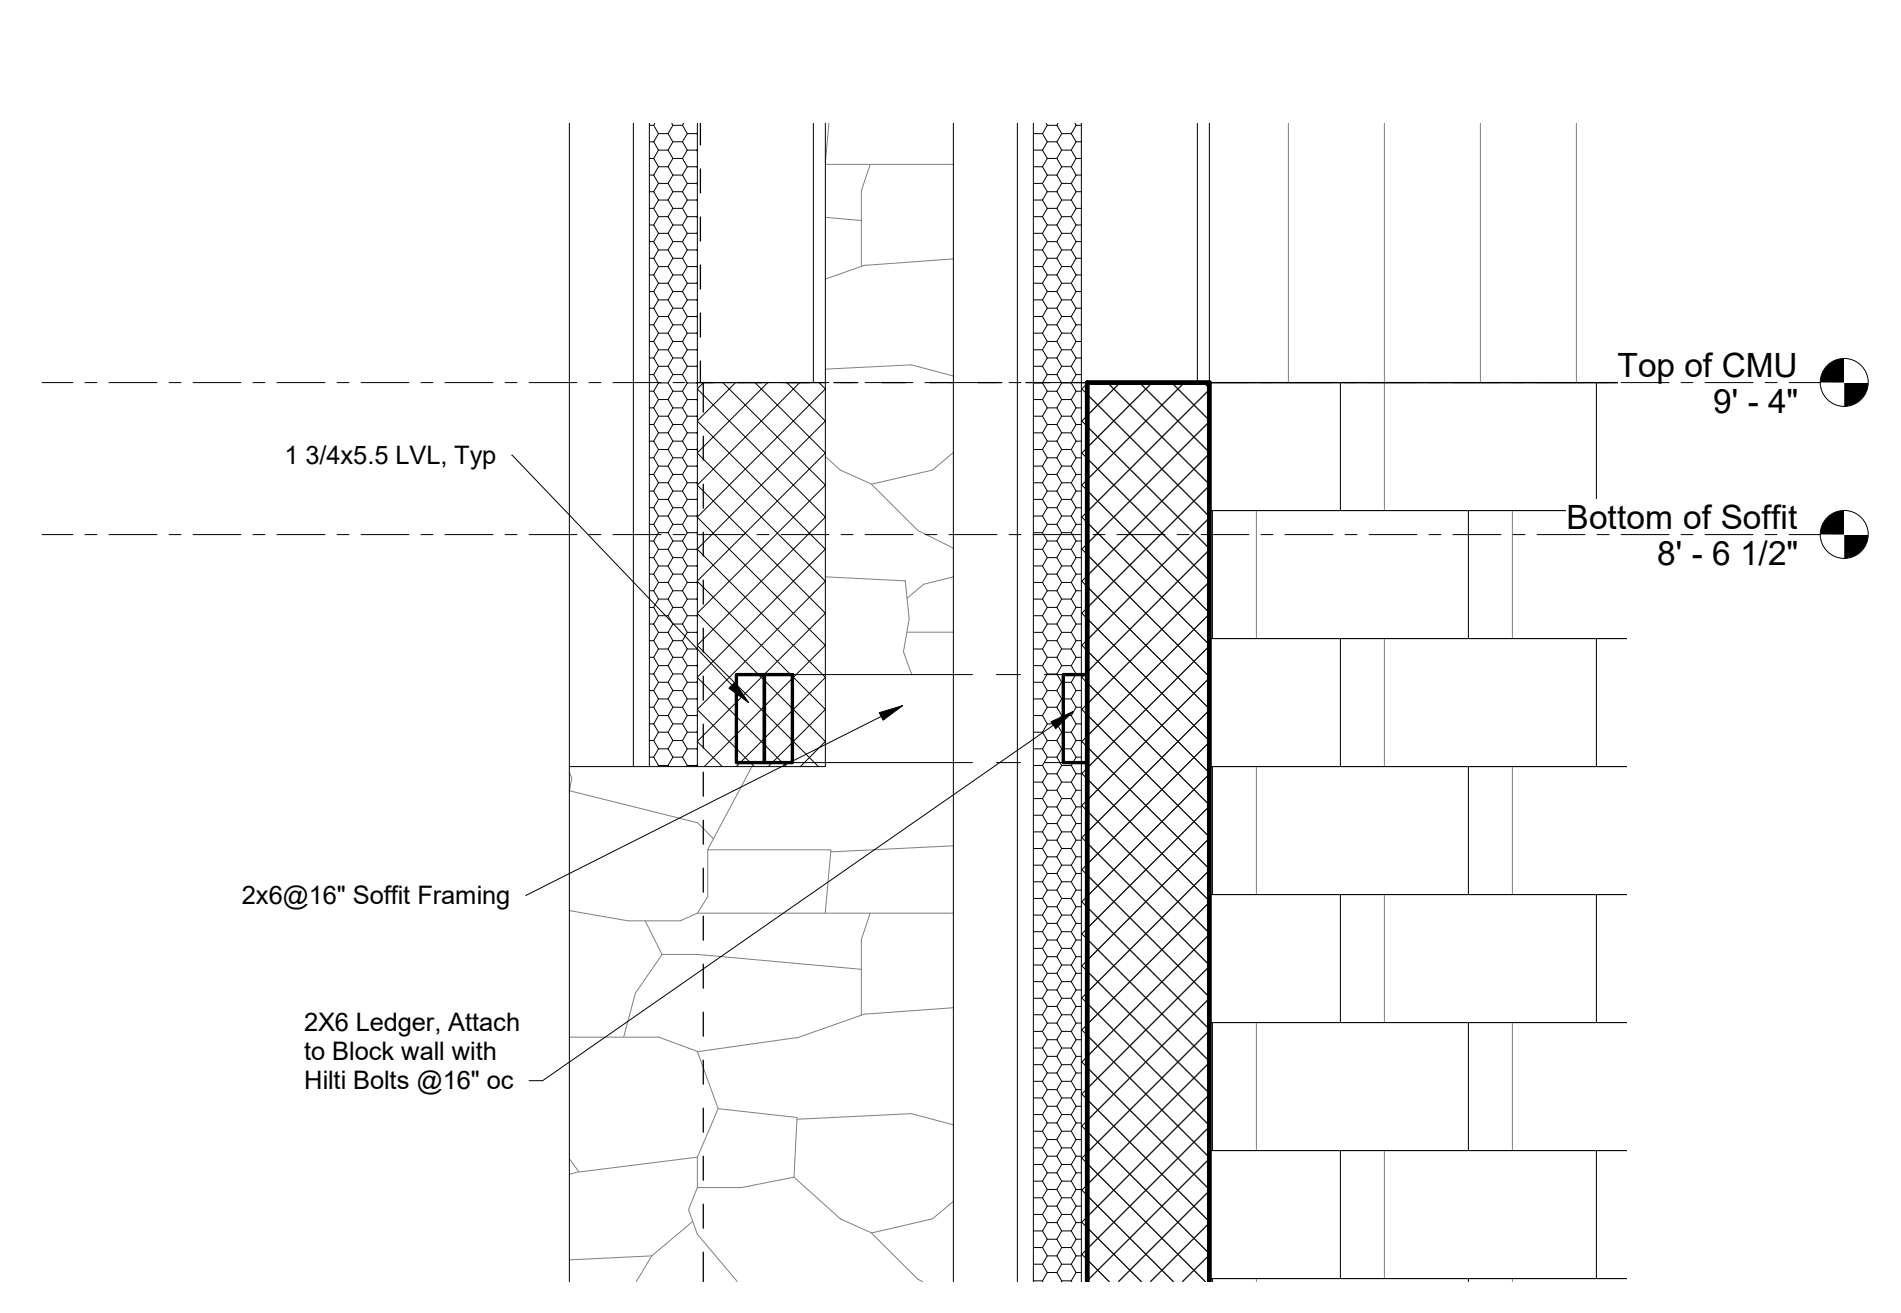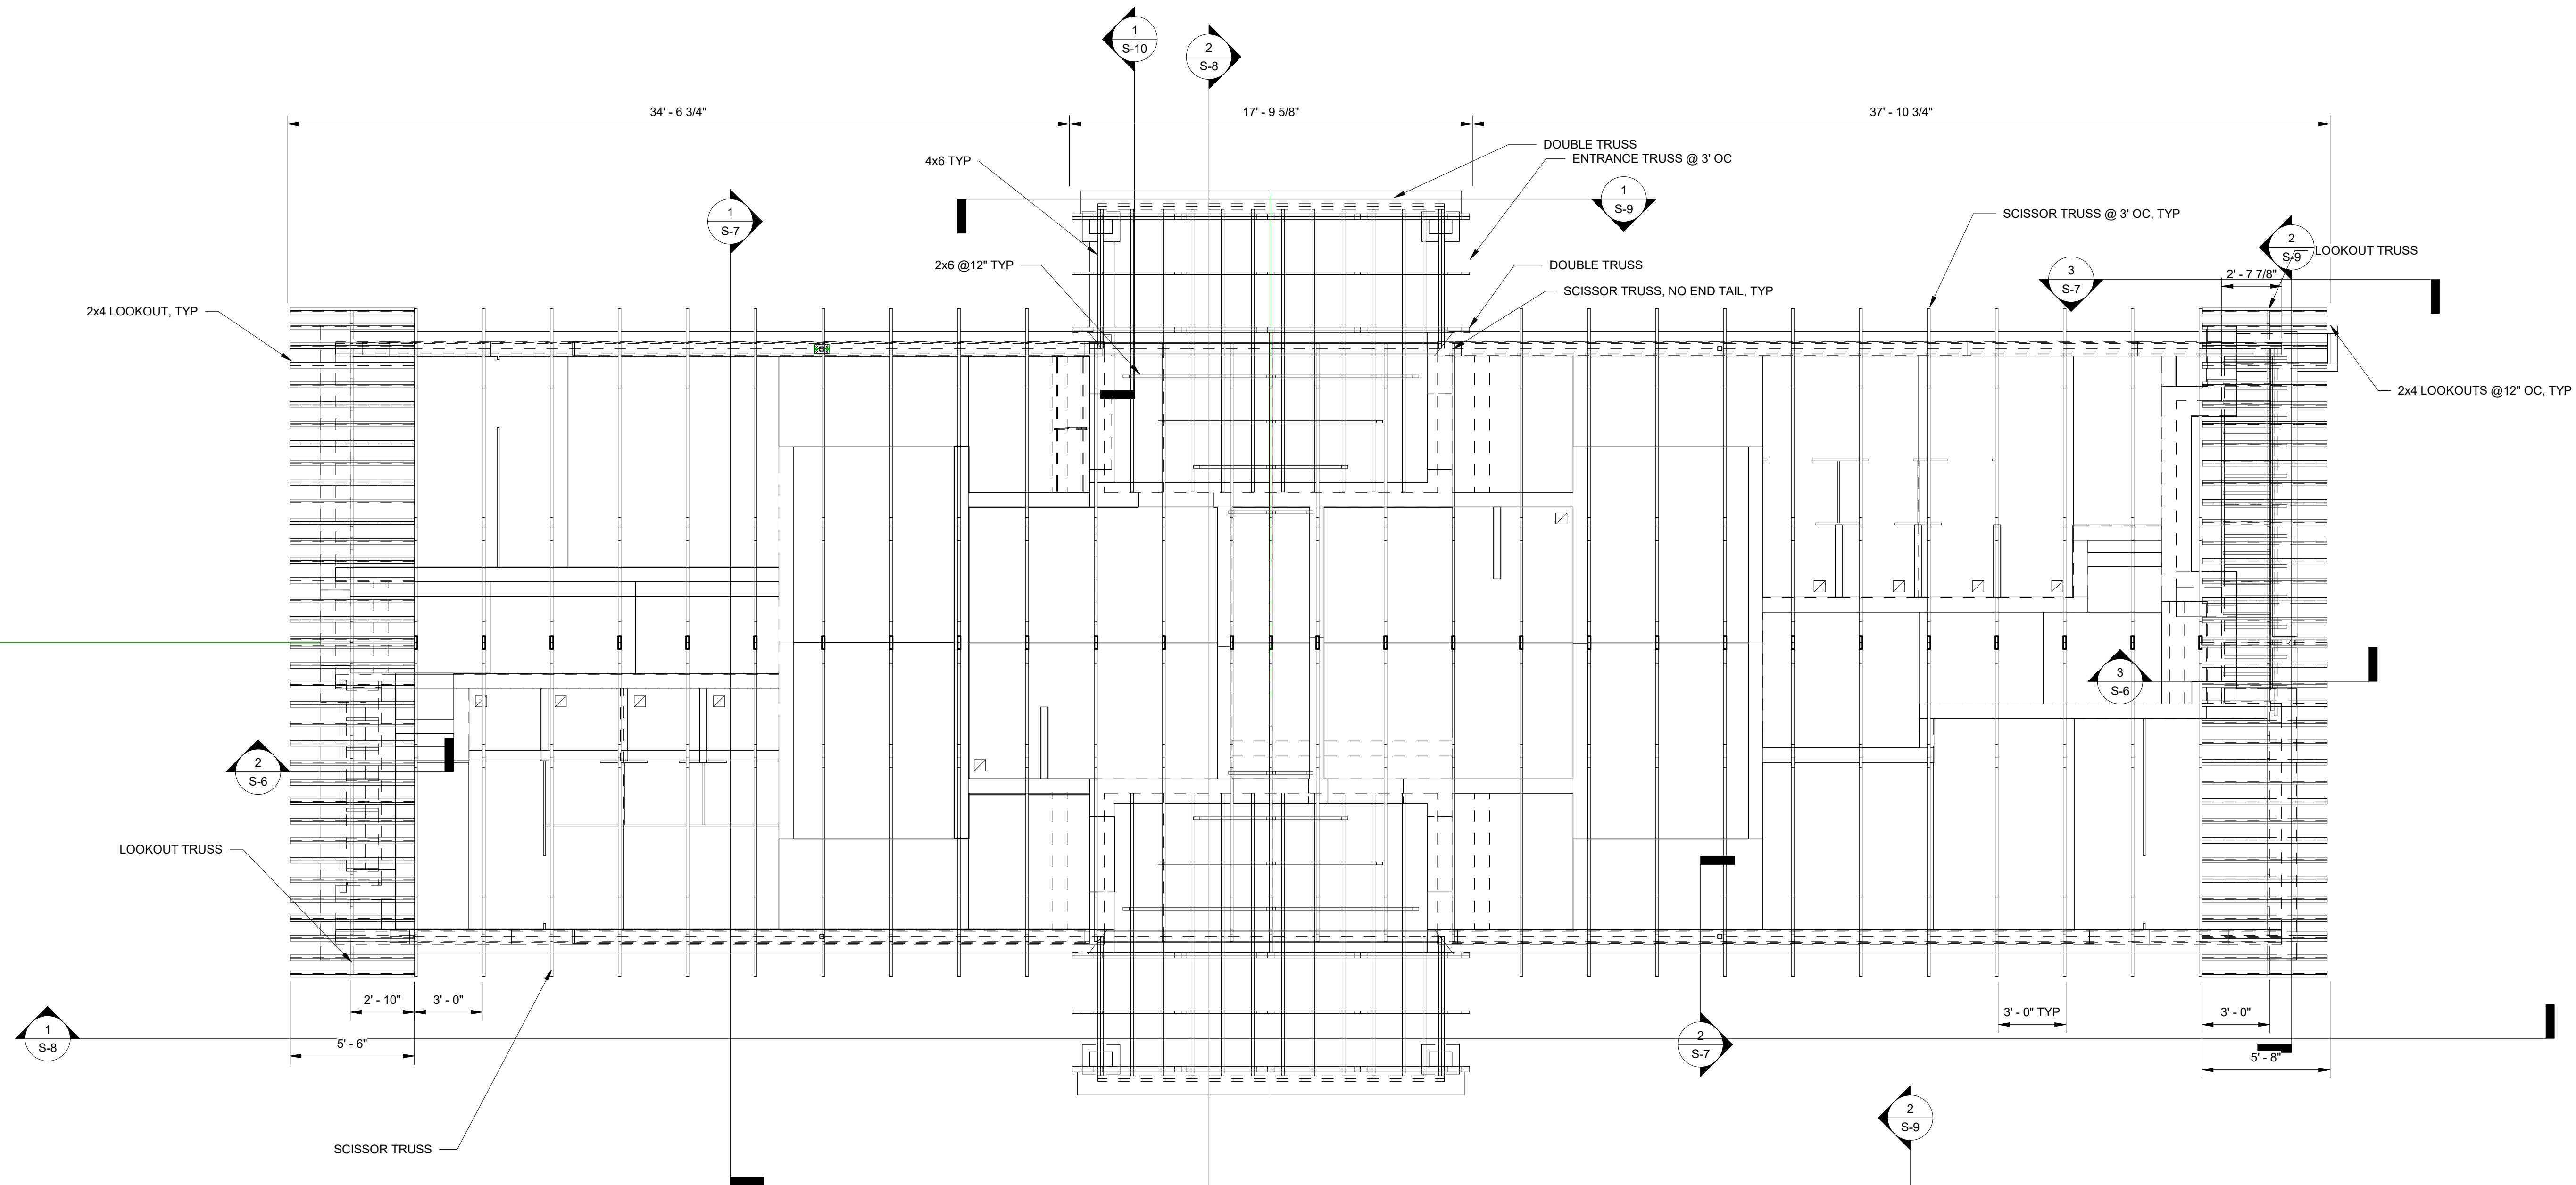


③ Soffit Framing and End Wall Support
1" = 1'-0"

CONSTRUCTION DOCUMENTS



NO.	REVISION	DATE

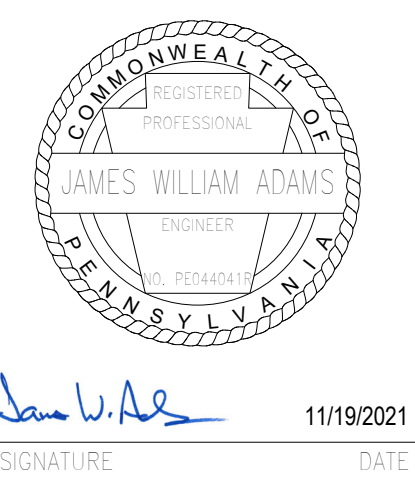

SMP ARCHITECTS
1600 WALNUT STREET, SECOND FLOOR
PHILADELPHIA, PENNSYLVANIA


COMMONWEALTH OF PENNSYLVANIA
DEPARTMENT OF GENERAL SERVICES
HARRISBURG, PENNSYLVANIA

D.G.S. PROJECT No.
C-114-0006 PHASE 1
HICKORY RUN STATE PARK
LATRINE IMPROVEMENTS
DEPT of CONSERVATION AND NATURAL RESOURCES
WHITE HAVEN, CARBON COUNTY, PA


VERIFY SCALE	
BAR IS ONE (1) INCH LONG	ON ORIGINAL DRAWING: 0 1
IF BAR IS NOT ONE (1) INCH LONG, ADJUST SCALE ACCORDINGLY	
CONTRACTOR SHALL FIELD VERIFY ALL DIMENSIONS. VARIANCE FROM CONTRACT DOCUMENTS NOT PERMITTED WITHOUT PROFESSIONAL & BUREAU OF CONSTRUCTION APPROVAL.	

DRAWN BY J ADAMS	DATE 06/17/2022	DRAWING No. S-6
CHECKED BY J ADAMS	SCALE AS NOTED	87 OF 144


NOTES:
1. FOR GENERAL NOTES SEE SHEET S-2
2. FOR SYMBOLS AND ABBREVIATIONS SEE SHEET S-1

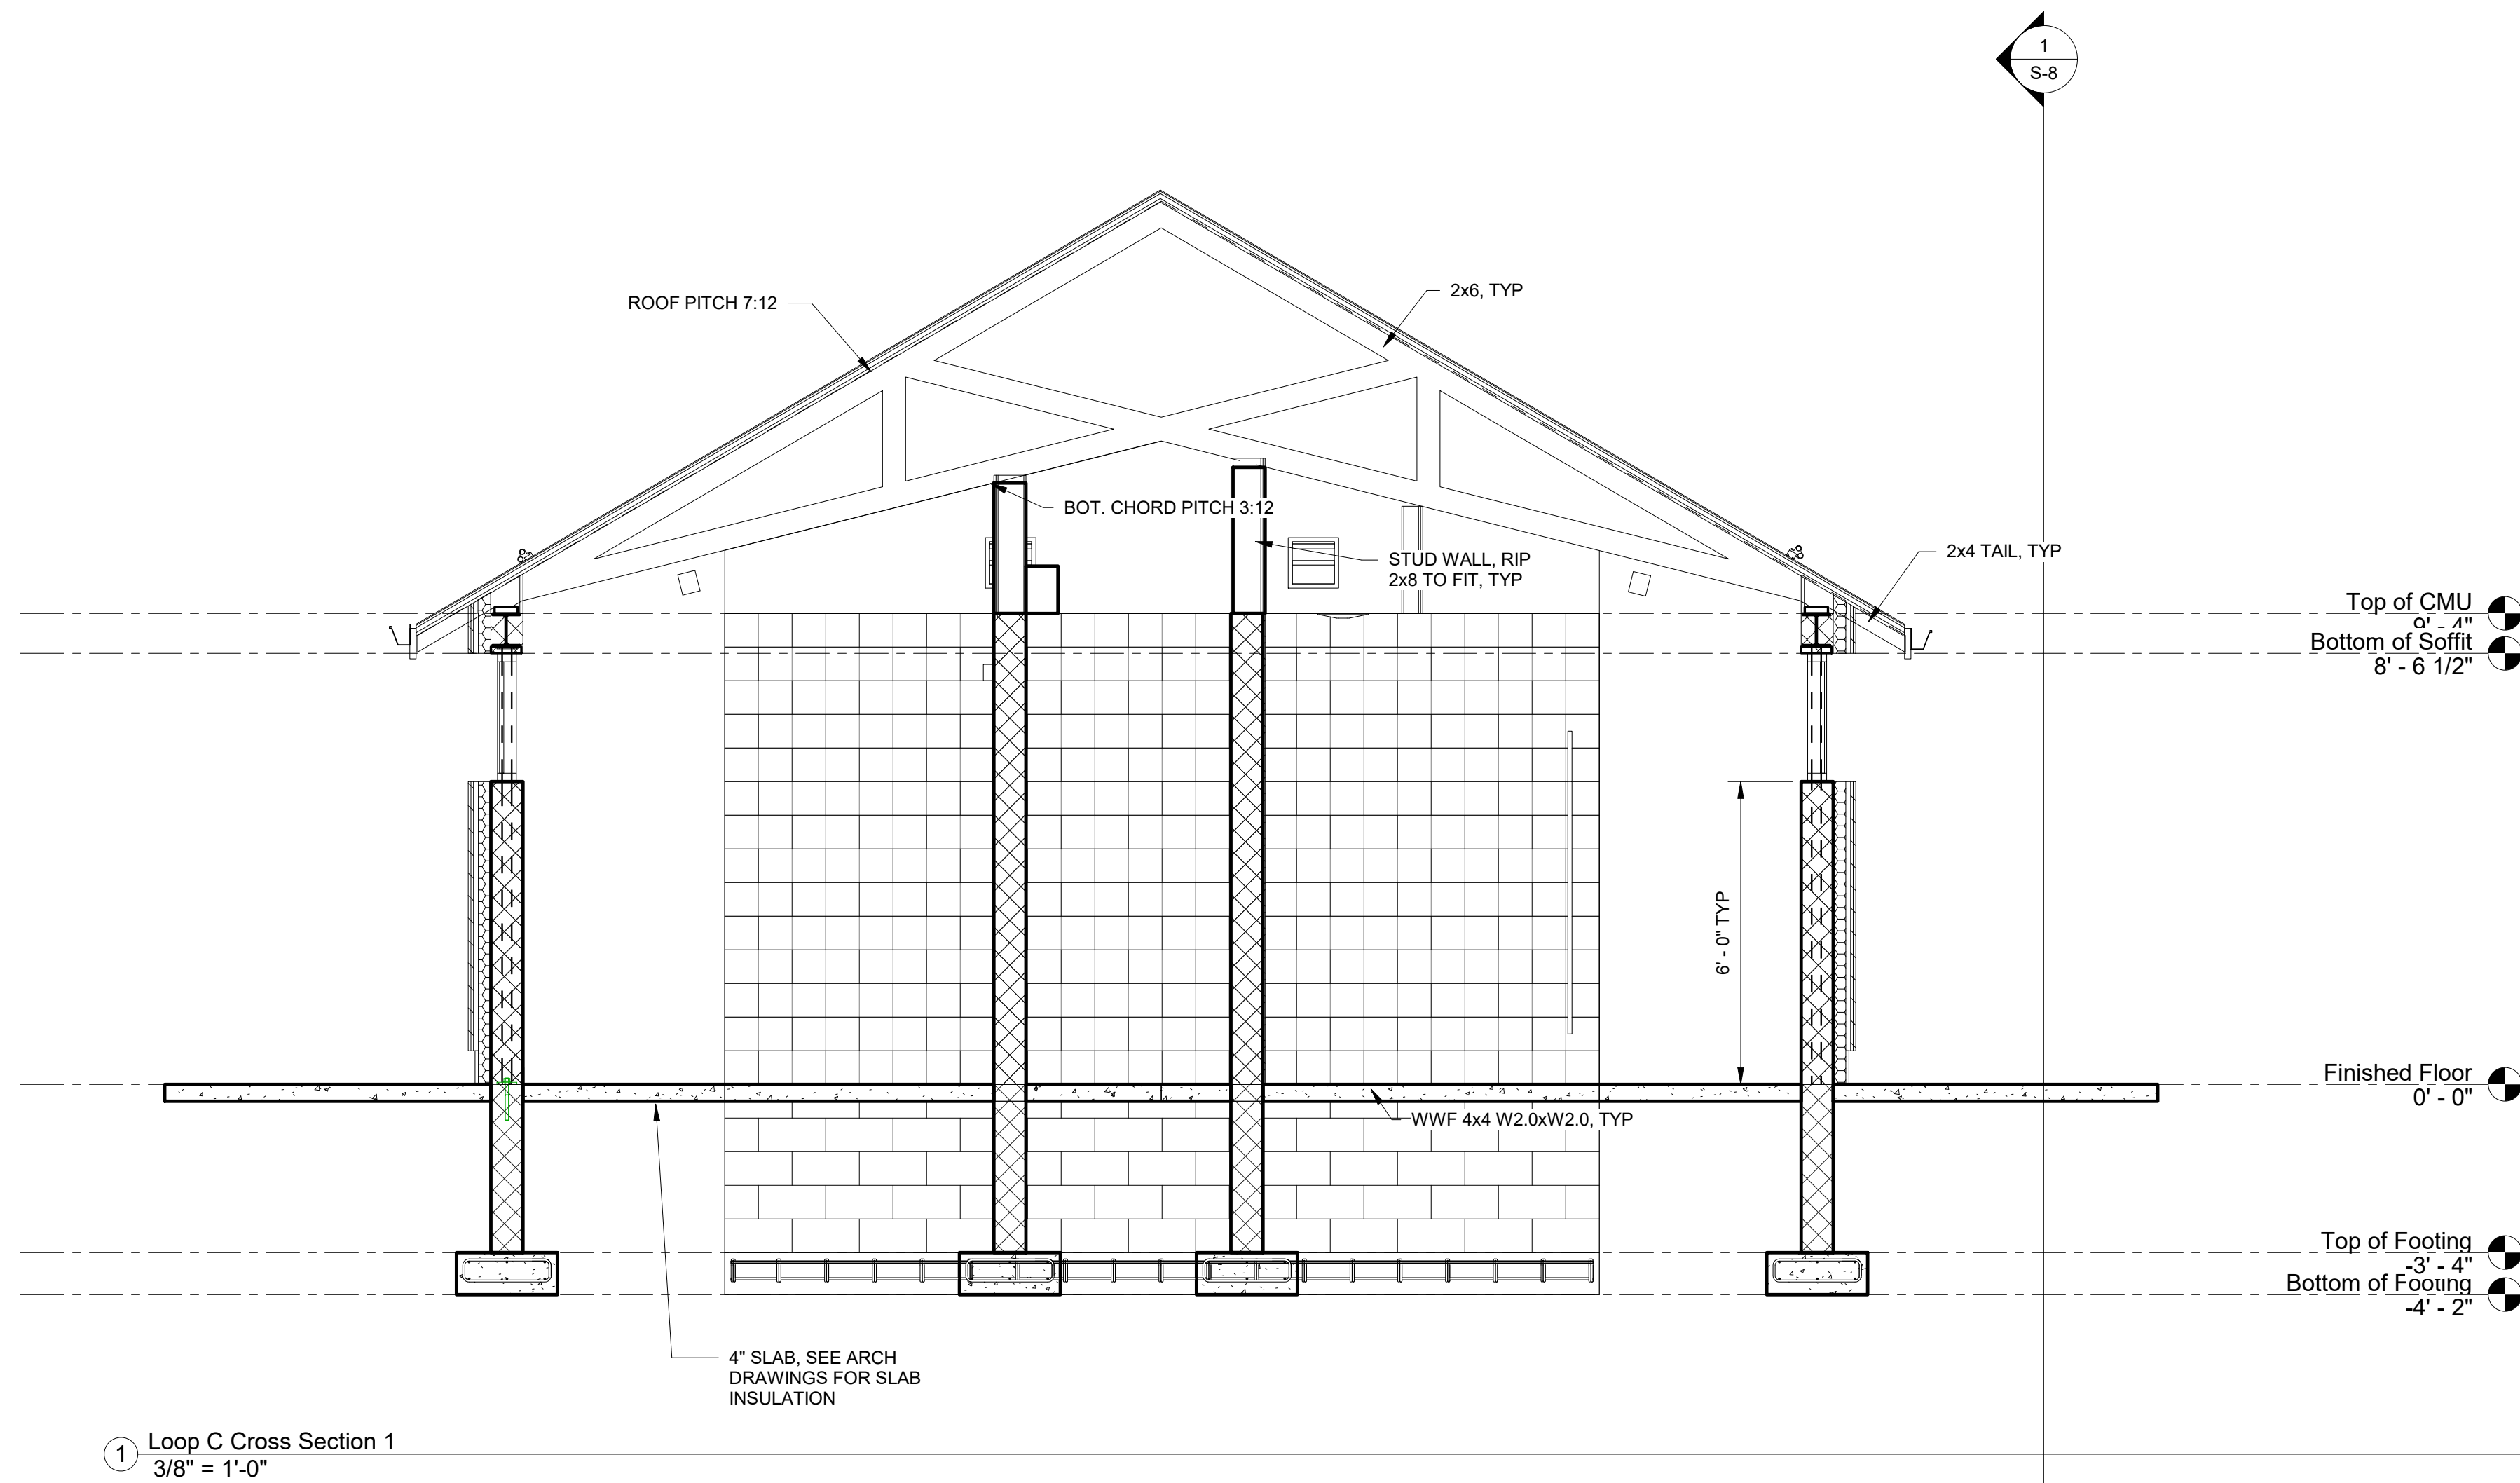

① Loop C Cross Section 1
3/8" = 1'-0"

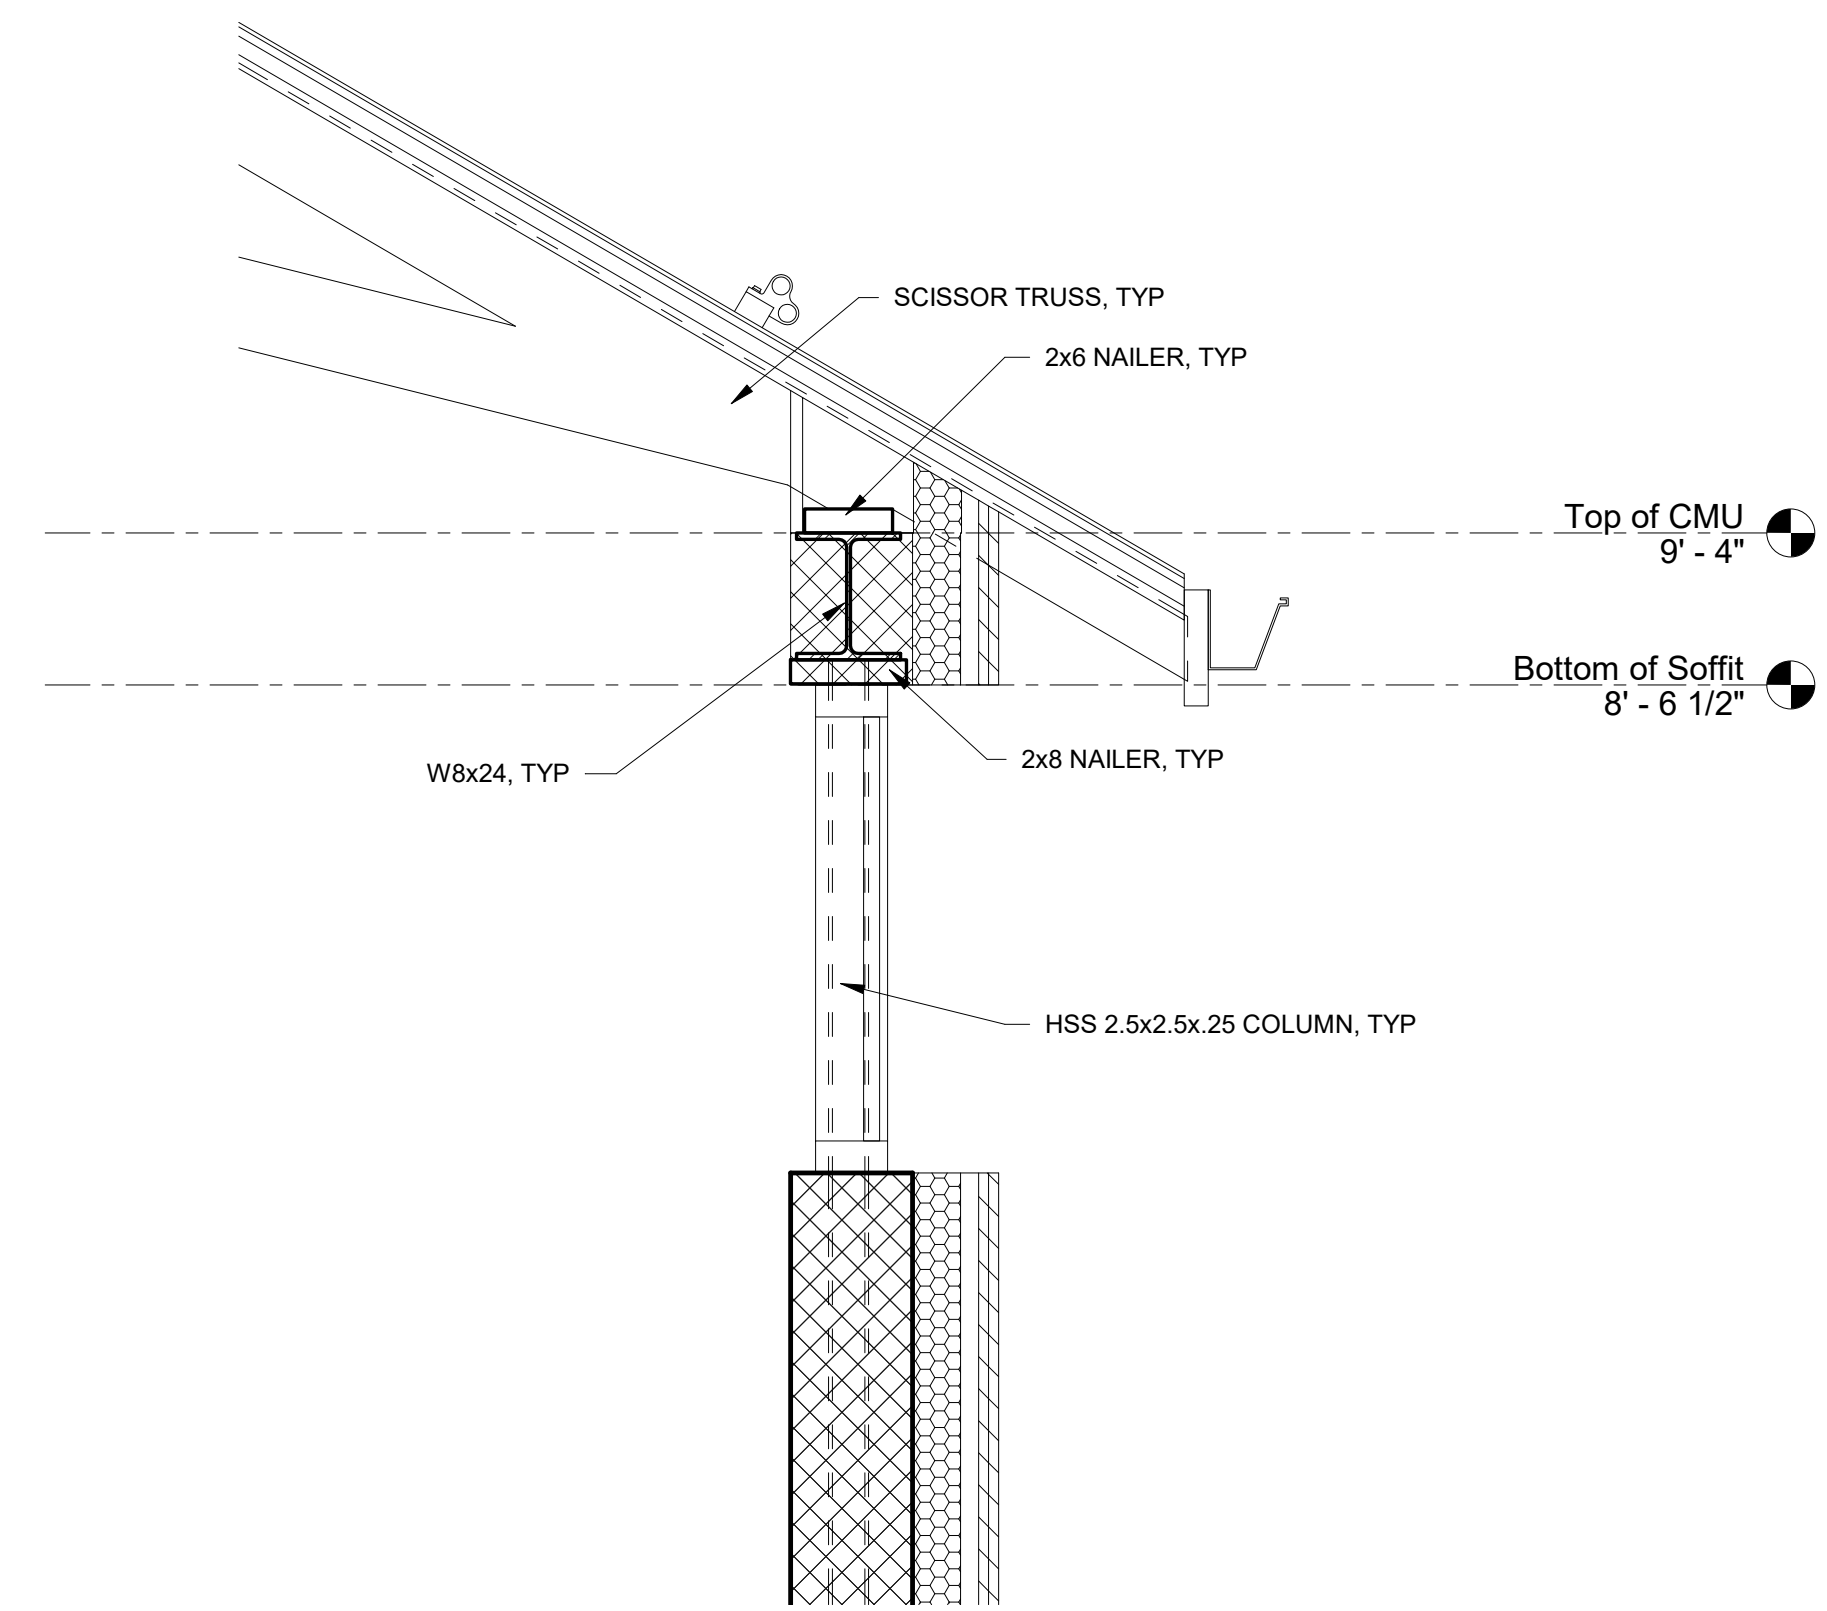

② Steel Column and Beam
1" = 1'-0"

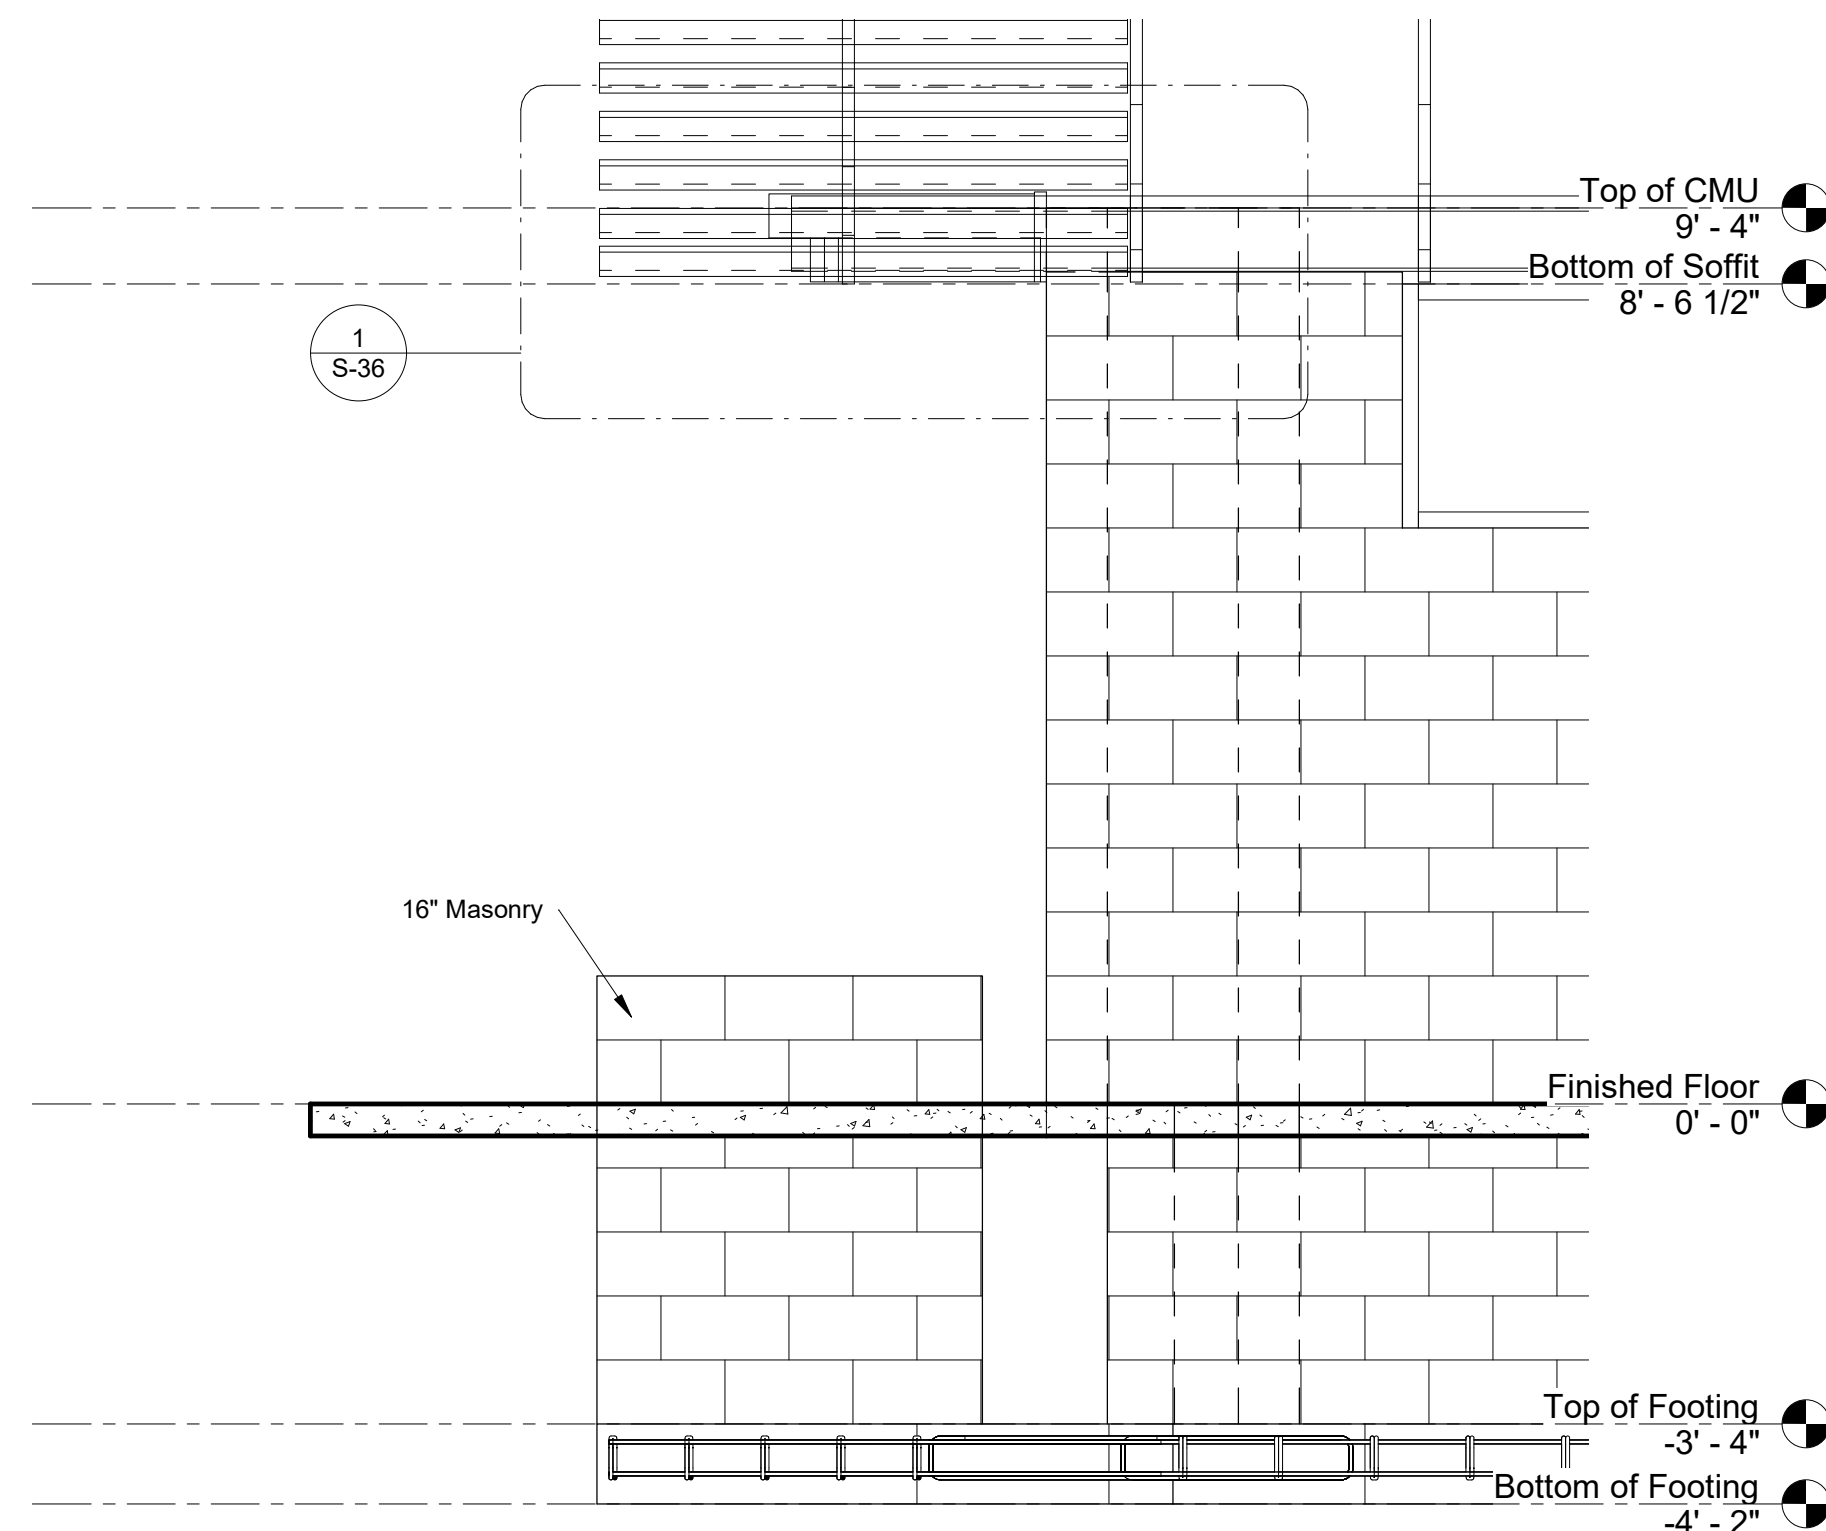

③ Loop C Lookout Detail
1/2" = 1'-0"

NOTES:
1. FOR GENERAL NOTES SEE SHEET S-2
2. FOR SYMBOLS AND ABBREVIATIONS SEE SHEET S-1

CONSTRUCTION DOCUMENTS



NO.	REVISION

REGISTERED PROFESSIONAL ENGINEER

 James W. Adams
 SIGNATURE DATE 11/19/2021

SMP ARCHITECTS
 1600 WALNUT STREET, SECOND FLOOR
 PHILADELPHIA, PENNSYLVANIA

COMMONWEALTH OF PENNSYLVANIA
 DEPARTMENT OF GENERAL SERVICES
 HARRISBURG, PENNSYLVANIA


D.G.S. PROJECT No.
 C-114-0006 PHASE 1

HICKORY RUN STATE PARK
 LATRINE IMPROVEMENTS
 DEPT of CONSERVATION AND NATURAL RESOURCES
 WHITE HAVEN, CARBON COUNTY, PA


LOOP C SECTIONS, SHEET 1

VERIFY SCALE	
BAR IS ONE (1) INCH LONG	ON ORIGINAL DRAWING: 1
IF BAR IS NOT ONE (1) INCH LONG, ADJUST SCALE ACCORDINGLY	0
CONTRACTOR SHALL FIELD VERIFY ALL DIMENSIONS. VARIANCE FROM CONTRACT DOCUMENTS NOT PERMITTED WITHOUT PROFESSIONAL & BUREAU OF CONSTRUCTION APPROVAL.	

DRAWN BY J ADAMS	DATE 06/17/2022	DRAWING No. S-7
CHECKED BY J ADAMS	SCALE AS NOTED	88 OF 144

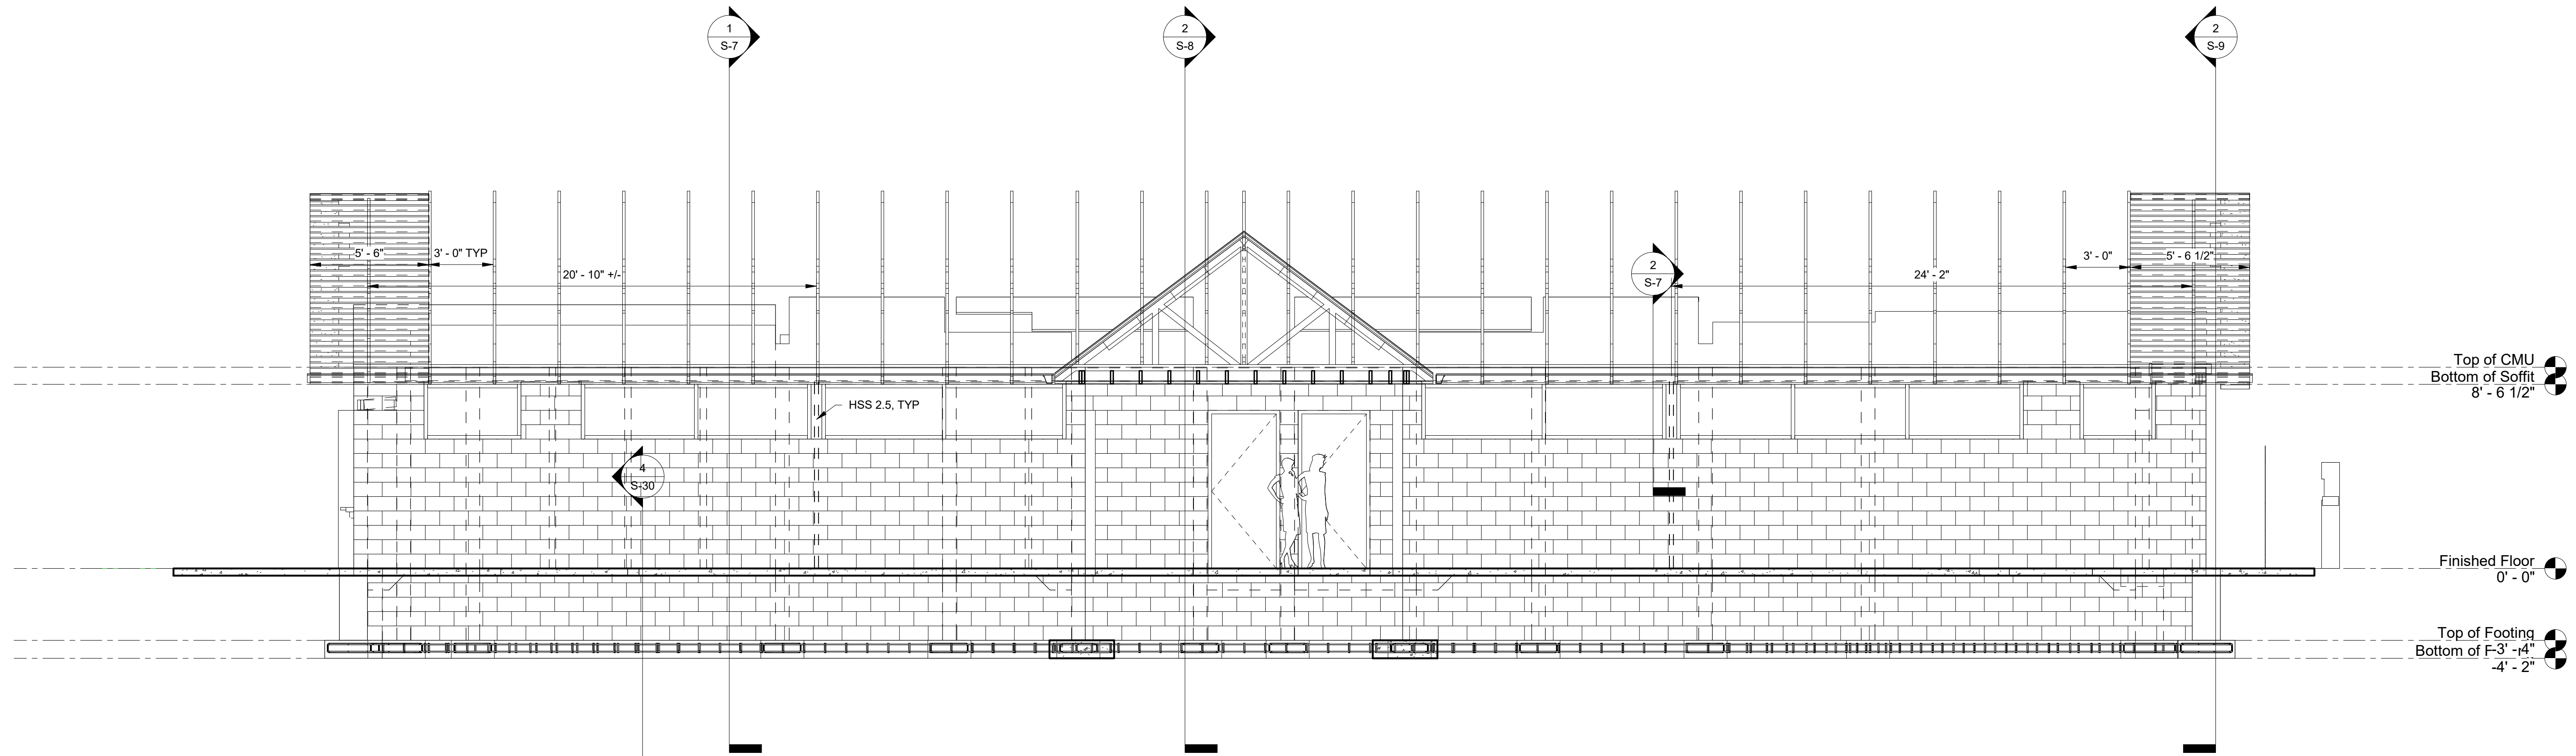

1 Loop C Cross Section 2
1/4" = 1'-0"

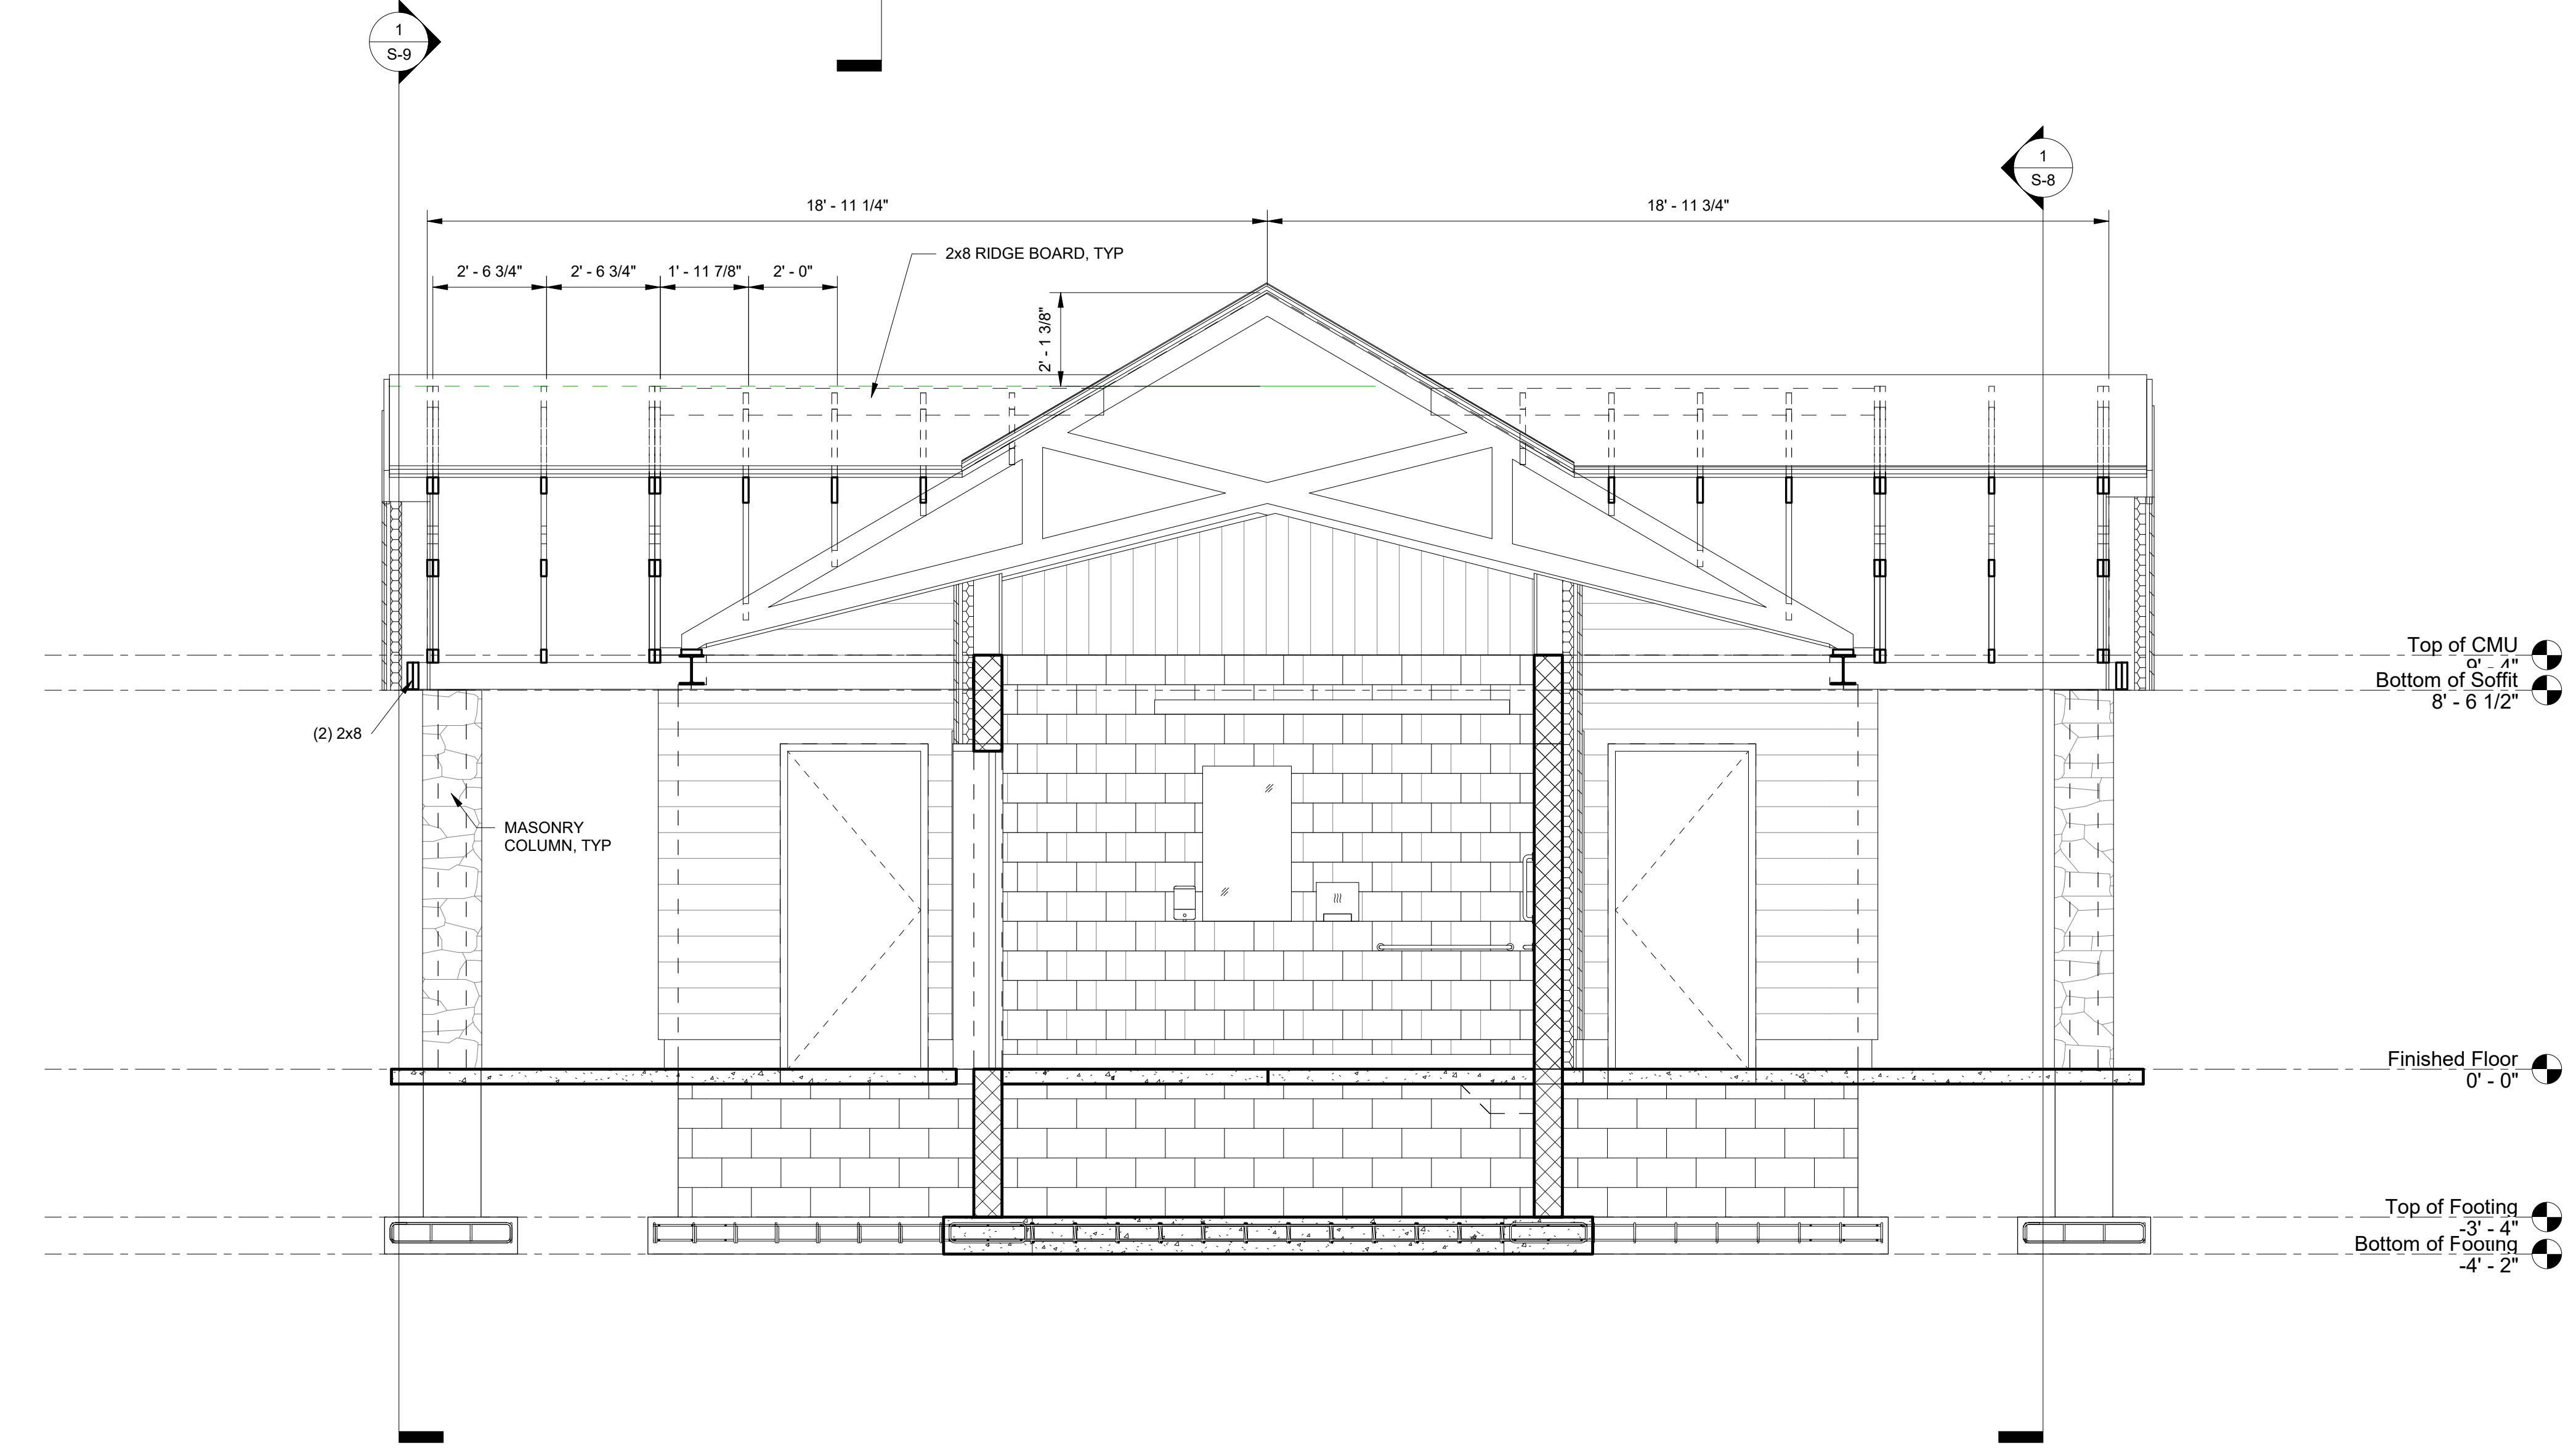


2 Loop C Cross Section Through Entrance
3/8" = 1'-0"

NOTES:
1. FOR GENERAL NOTES SEE SHEET S-2
2. FOR SYMBOLS AND ABBREVIATIONS SEE SHEET S-1

CONSTRUCTION DOCUMENTS



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DEPARTMENT OF GENERAL SERVICES
HARRISBURG, PENNSYLVANIA

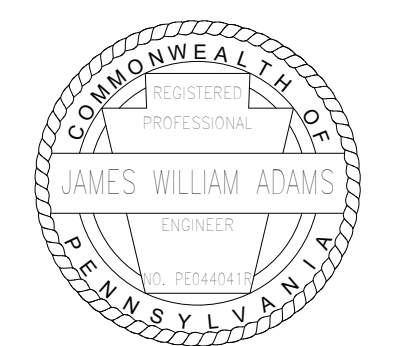D.G.S. PROJECT No. C-114-0006 PHASE 1


HICKORY RUN STATE PARK
LATRINE IMPROVEMENTS
DEPT of CONSERVATION AND NATURAL RESOURCES
WHITE HAVEN, CARBON COUNTY, PA

LOOP C SECTIONS, SHEET 2


VERIFY SCALE
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ON ORIGINAL DRAWING: 0 1
IF BAR IS NOT ONE (1) INCH LONG, ADJUST SCALE ACCORDINGLY
CONTRACTOR SHALL FIELD VERIFY ALL DIMENSIONS
VARIANCE FROM CONTRACT DOCUMENTS NOT PERMITTED WITHOUT PROFESSIONAL & BUREAU OF CONSTRUCTION APPROVAL.

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CHECKED BY J ADAMS	SCALE AS NOTED

DRAWING No. S-8

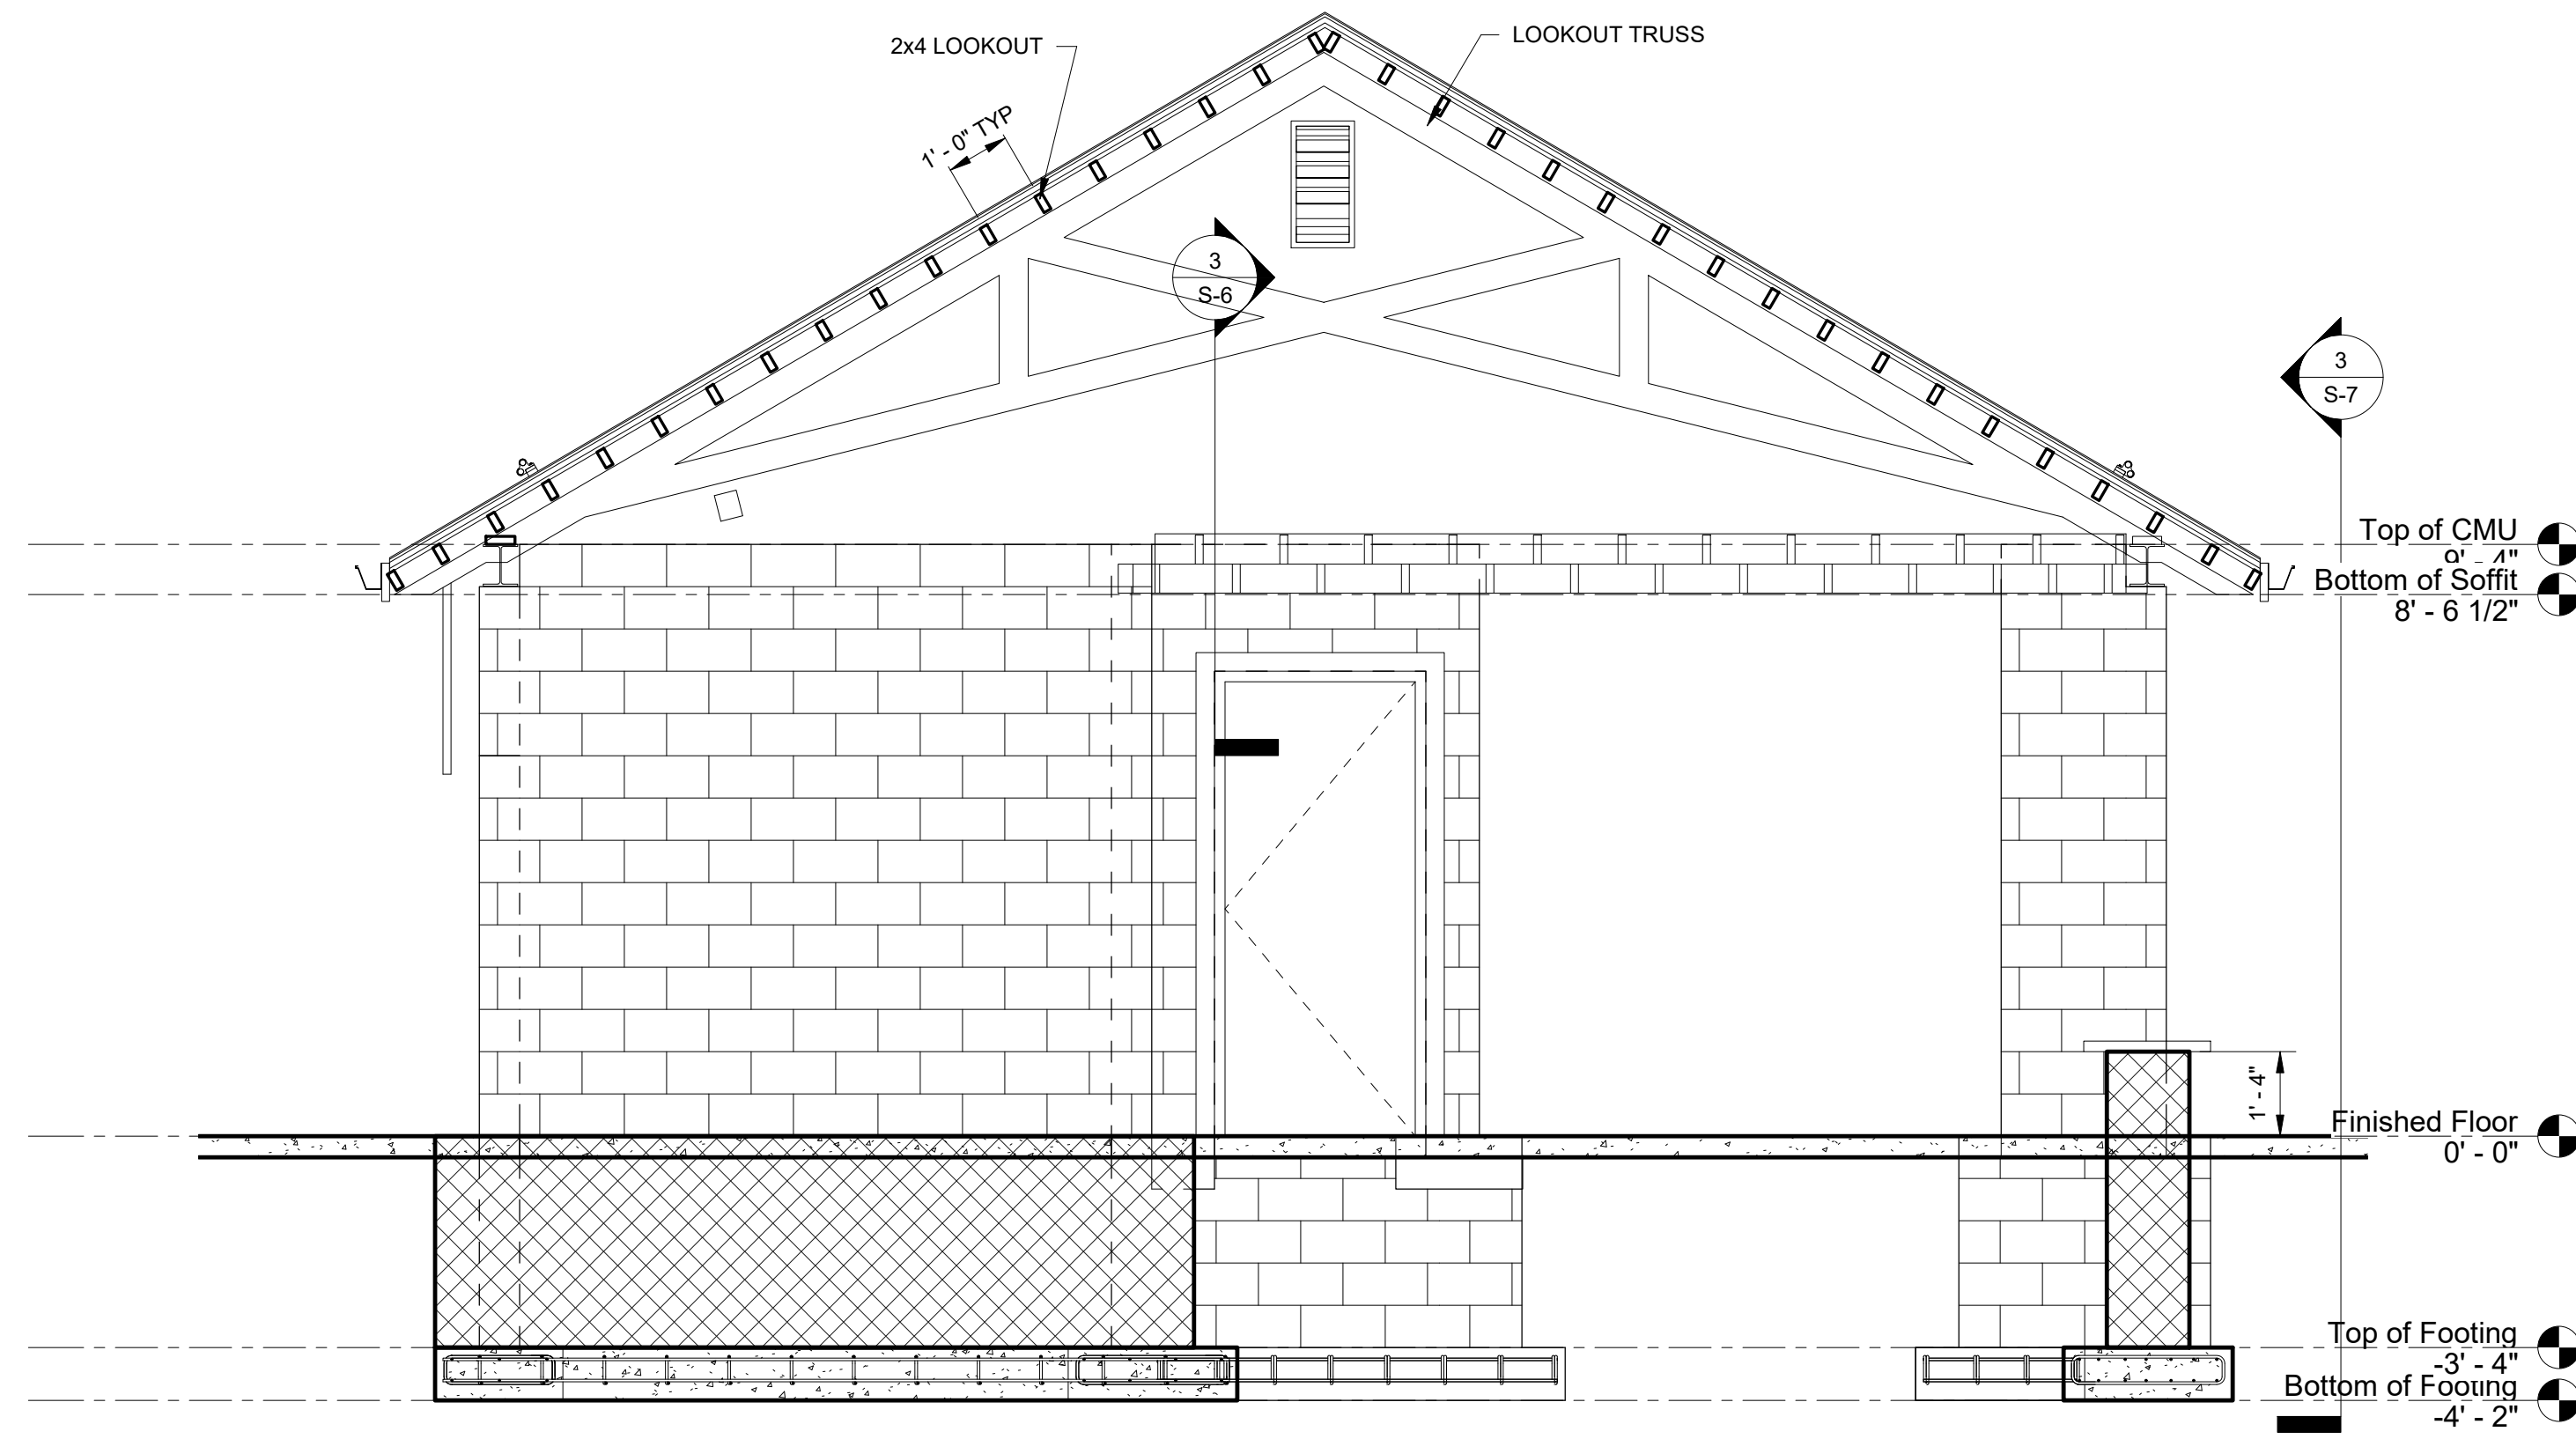

② Loop C Lookouts
3/8" = 1'-0"

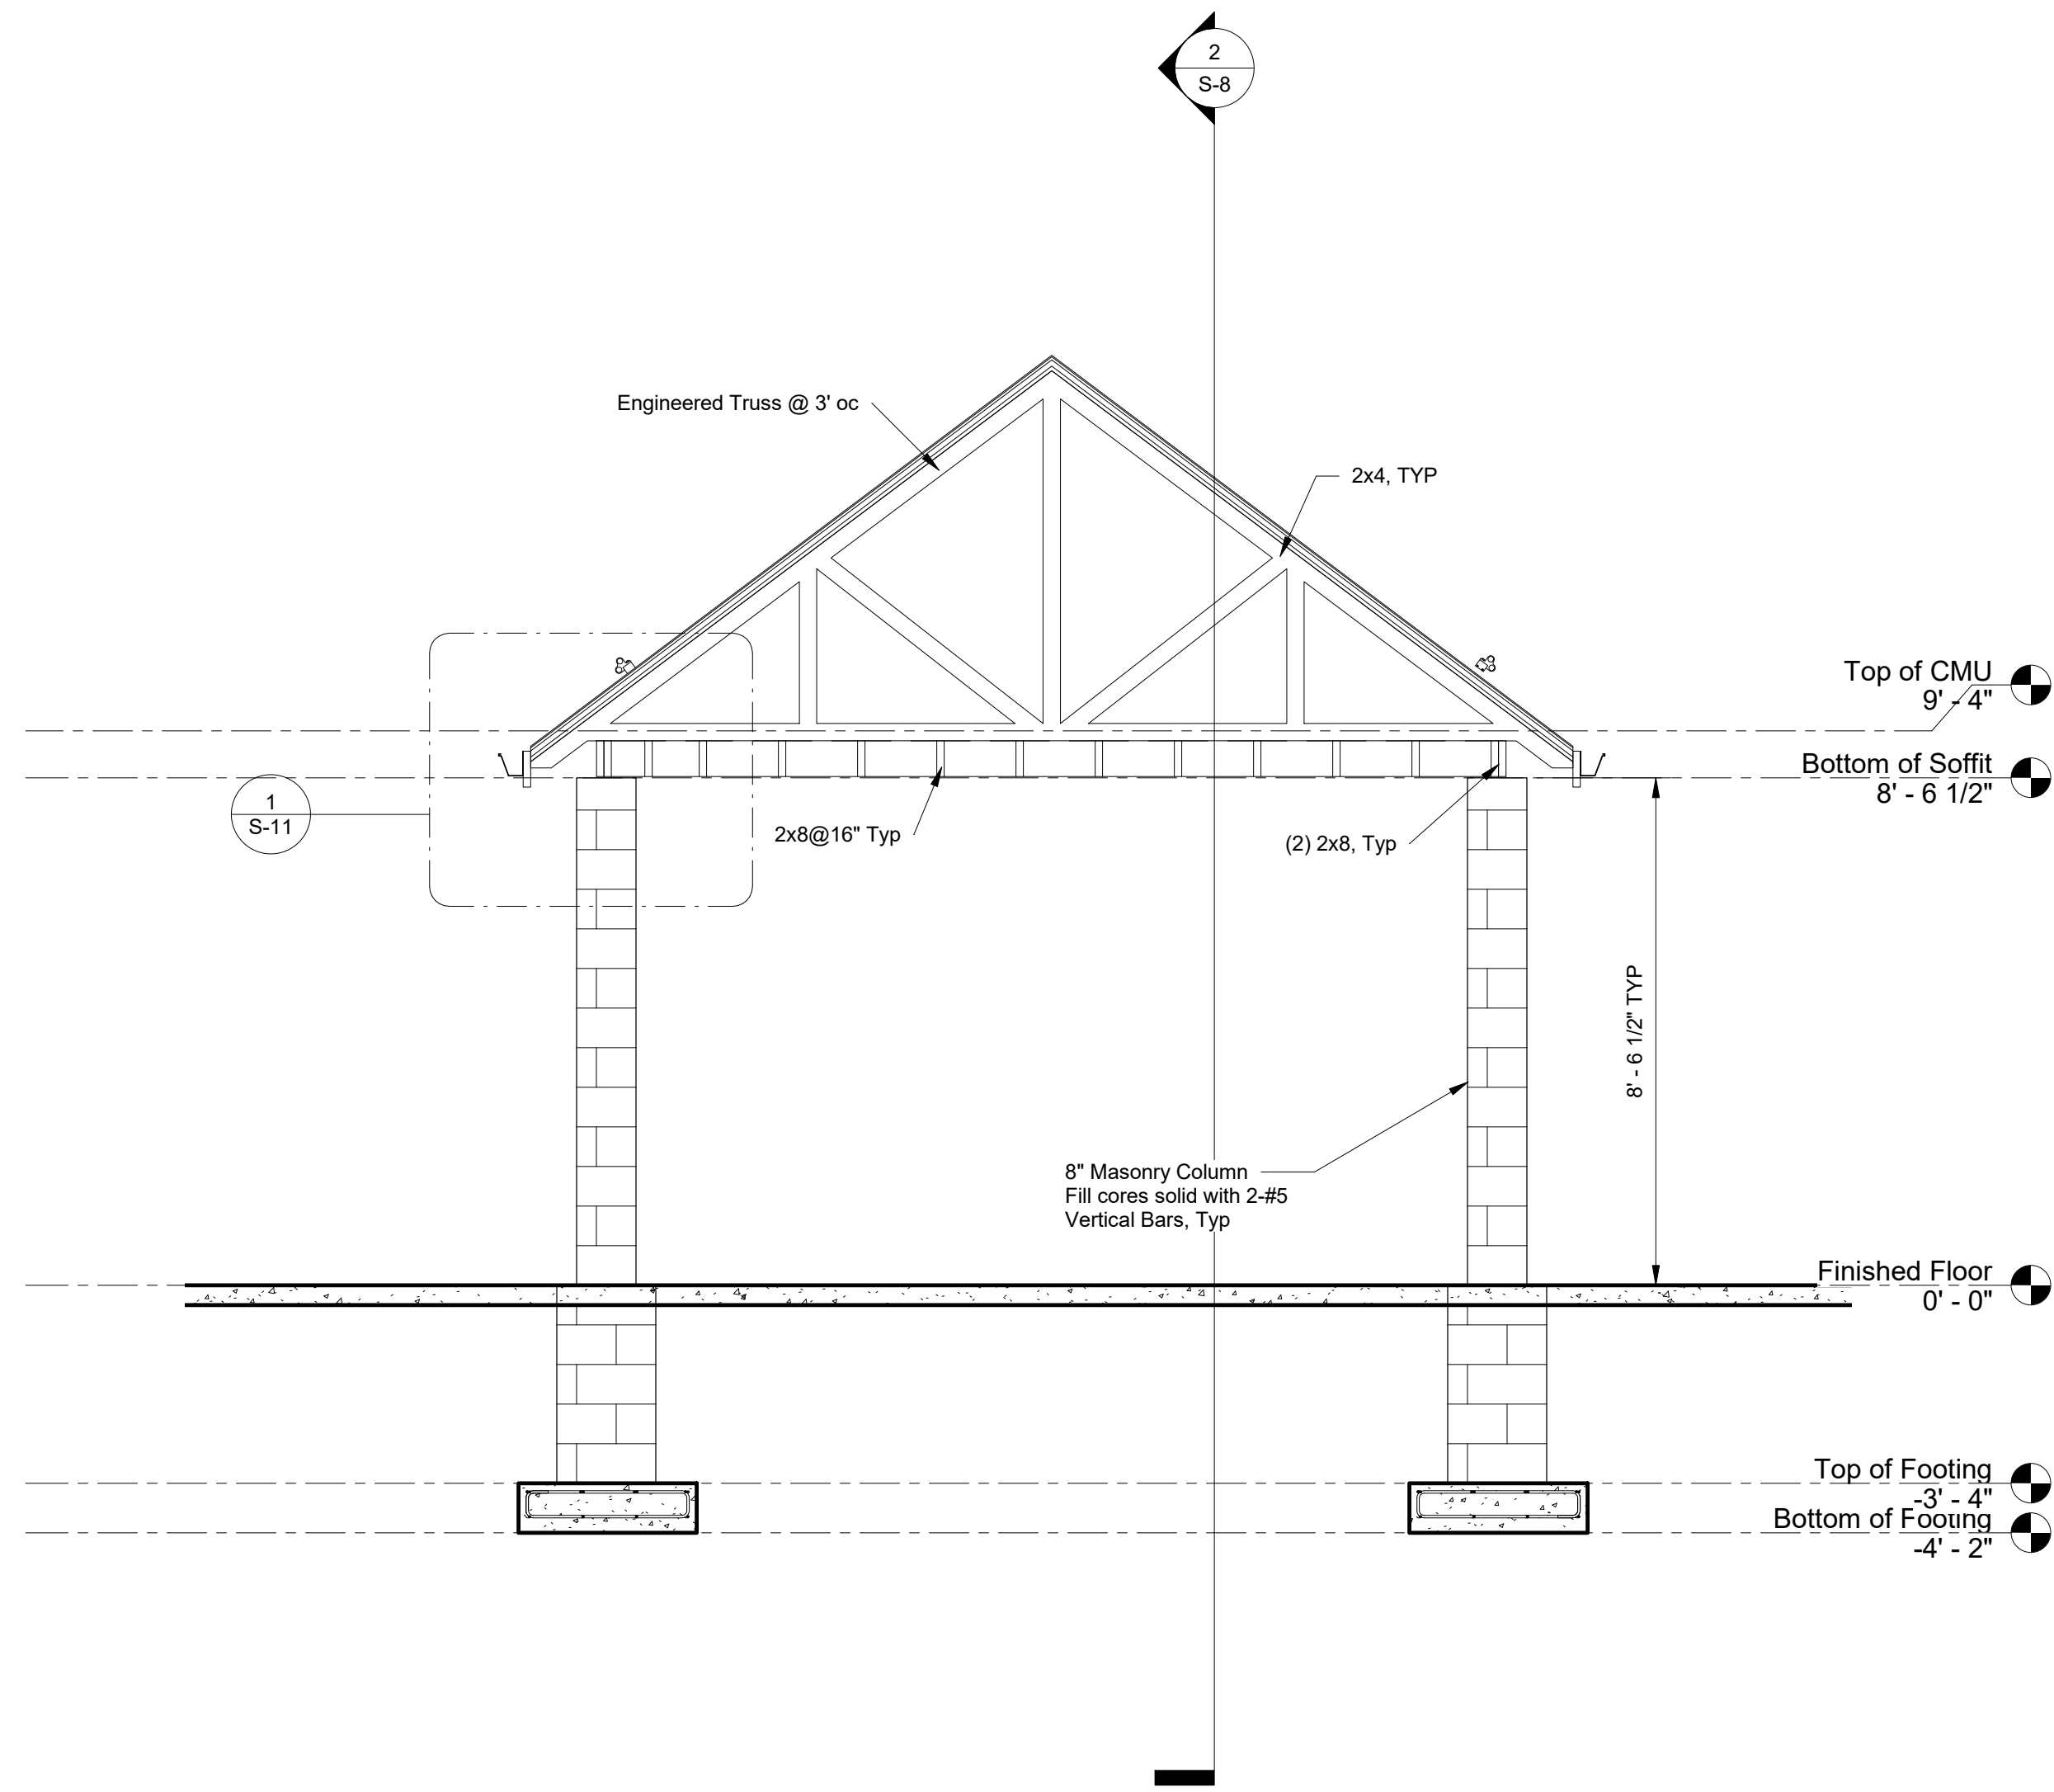


① Loop C Entrance Section
3/8" = 1'-0"

CONSTRUCTION DOCUMENTS



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SMP ARCHITECTS
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HICKORY RUN STATE PARK
LATRINE IMPROVEMENTS
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LOOP C SECTIONS, SHEET 3

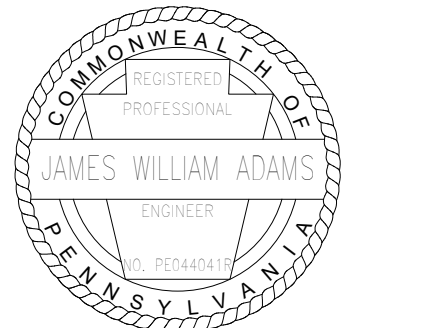VERIFY SCALE


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ON ORIGINAL DRAWING: 0 1
IF BAR IS NOT ONE (1) INCH LONG, ADJUST SCALE ACCORDINGLY

CONTRACTOR SHALL FIELD VERIFY ALL DIMENSIONS
VARIANCE FROM CONTRACT DOCUMENTS NOT PERMITTED WITHOUT PROFESSIONAL & BUREAU OF CONSTRUCTION APPROVAL.


DRAWN BY J ADAMS	DATE 06/17/2022
CHECKED BY J ADAMS	SCALE AS NOTED

DRAWING No.
S-9
90 OF 144

NOTES:
1. FOR GENERAL NOTES SEE SHEET S-2
2. FOR SYMBOLS AND ABBREVIATIONS SEE SHEET S-1

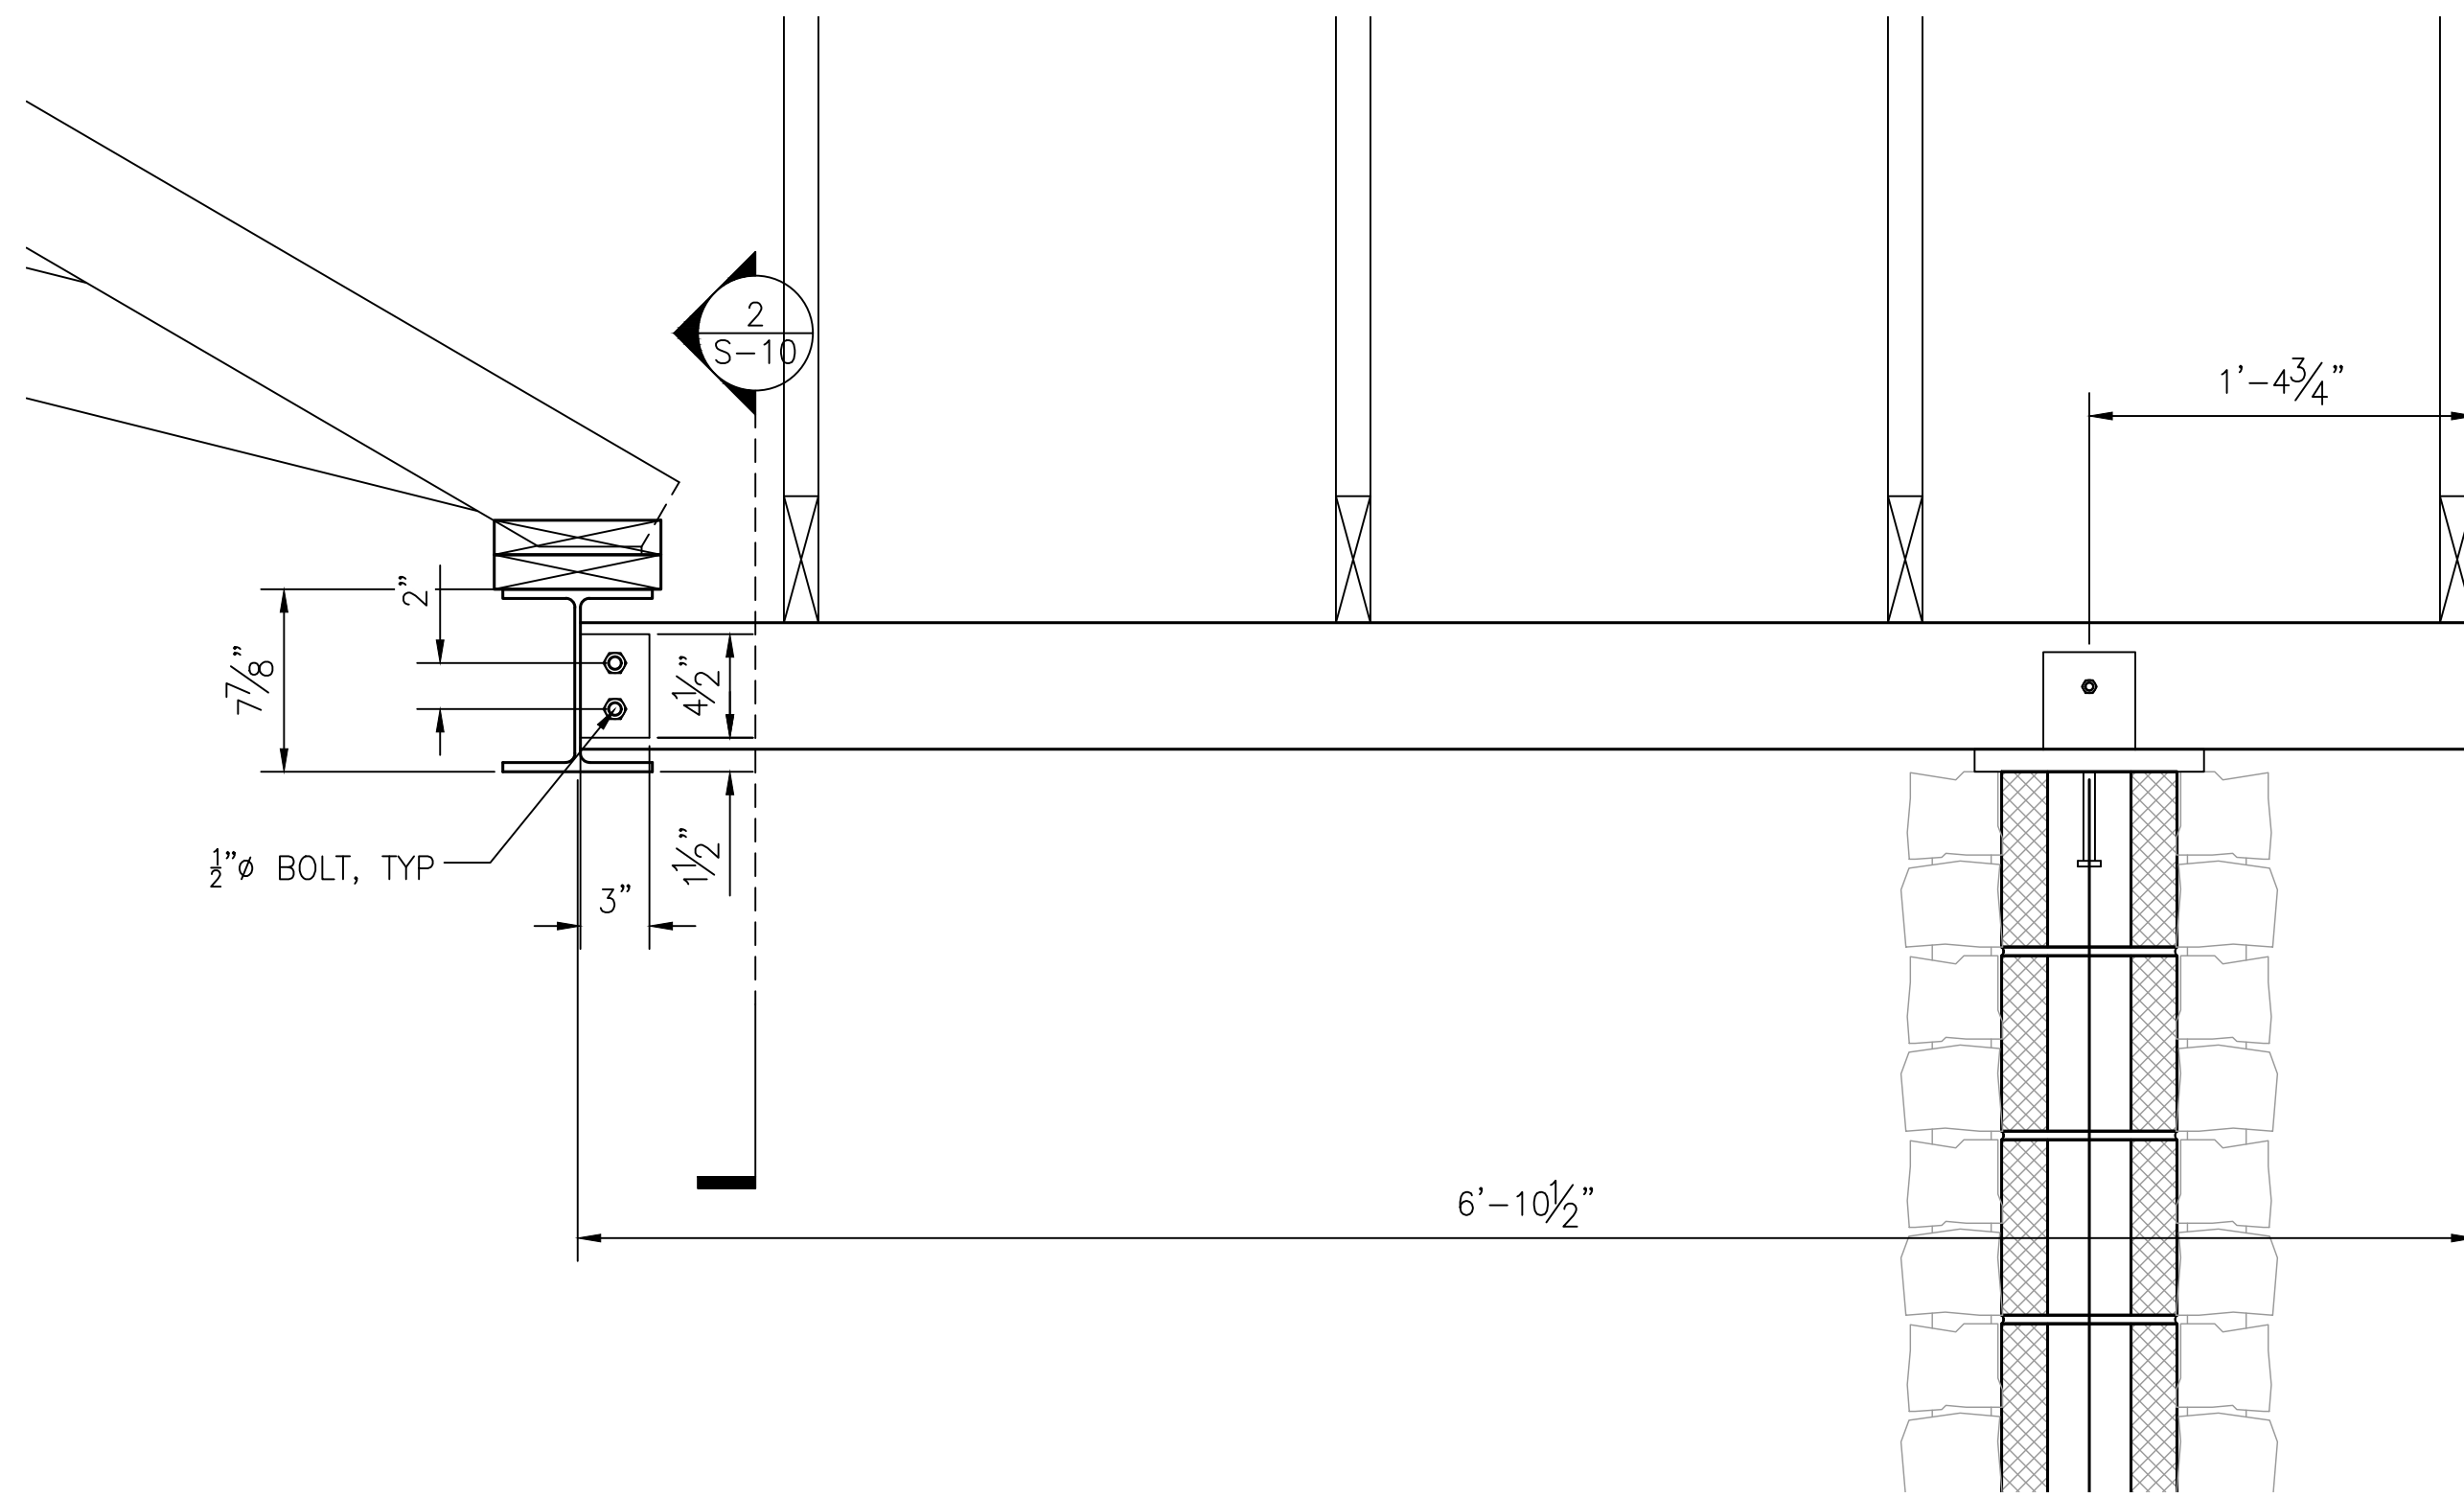

1 SECTION
S-10 TIMBER BEAM 1 1/2"=1'-0"

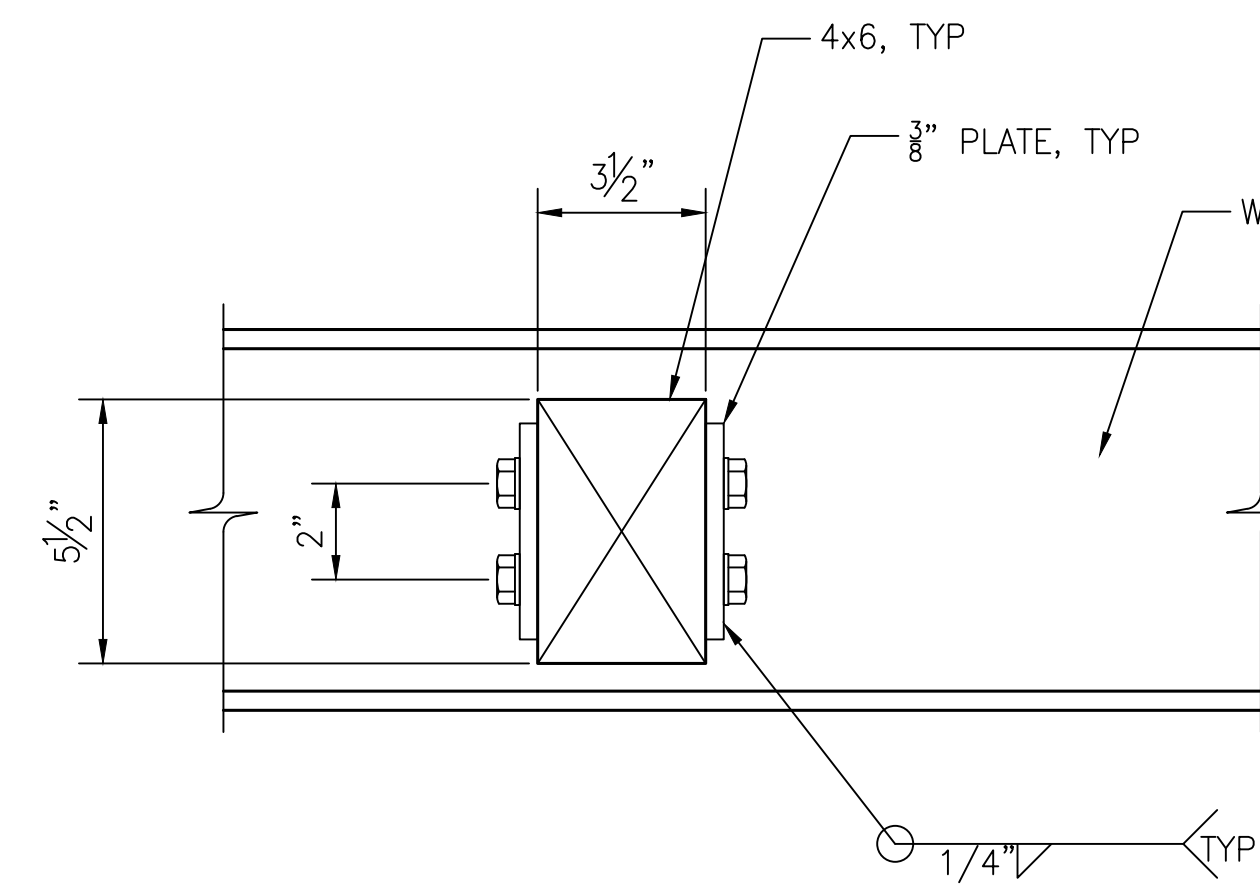


2 SECTION
S-10 TIMBER/STEEL CONNECTION 1 1/2"=1'-0"

NOTES:
1. FOR GENERAL NOTES SEE SHEET S-2
2. FOR SYMBOLS AND ABBREVIATIONS SEE SHEET S-1

CONSTRUCTION DOCUMENTS



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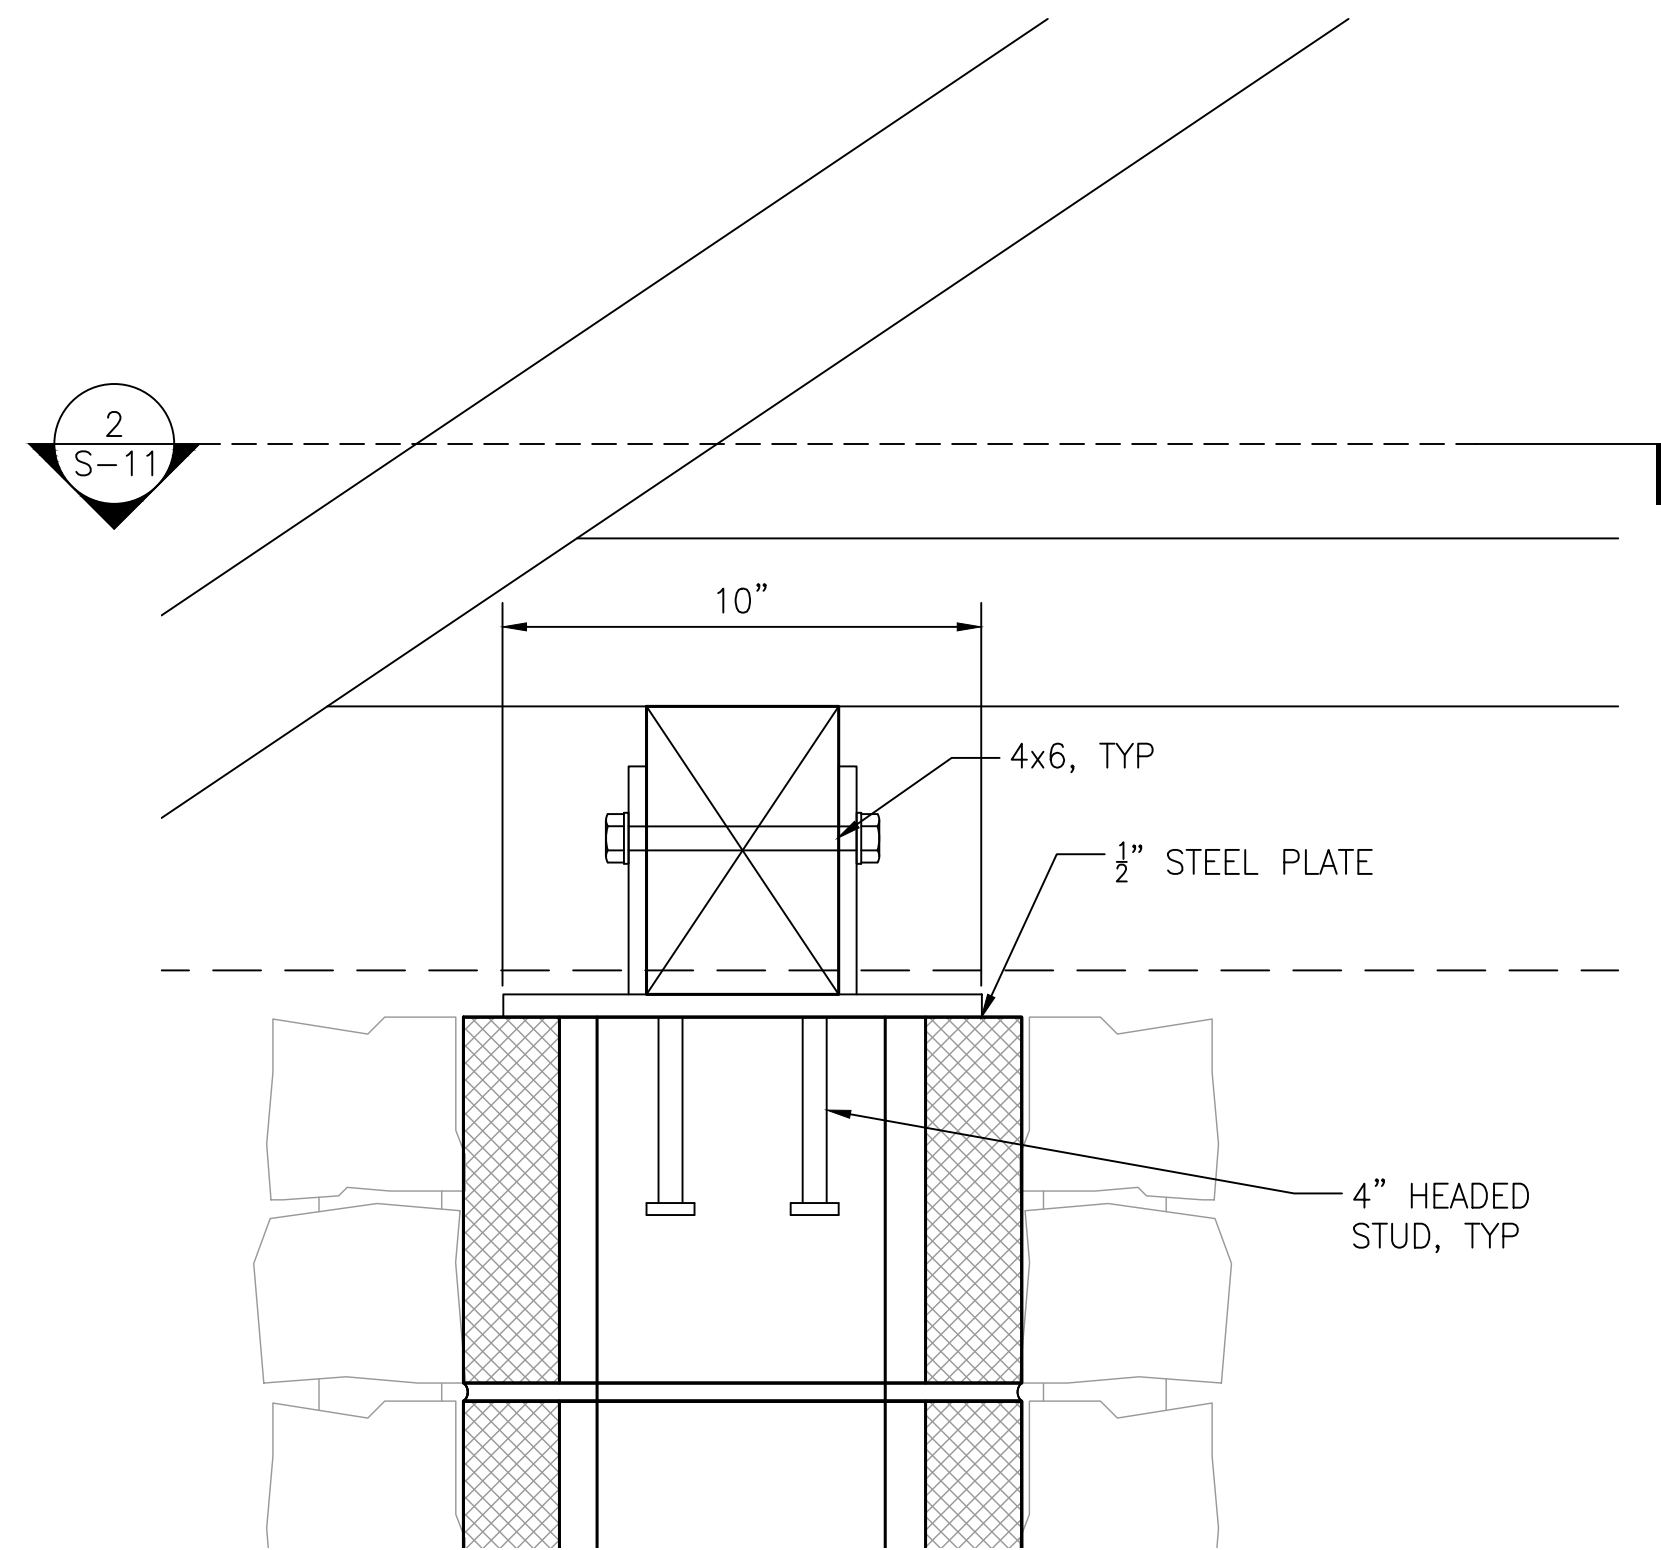
HICKORY RUN STATE PARK
LATRINE IMPROVEMENTS
DEPT of CONSERVATION AND NATURAL RESOURCES
WHITE HAVEN, CARBON COUNTY, PA

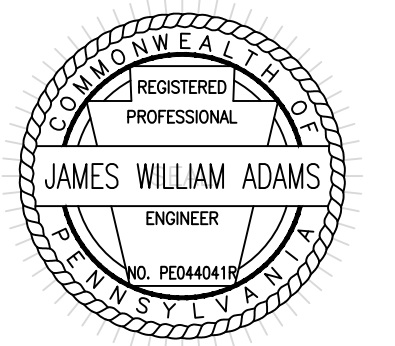LOOP C DETAILS - SHEET 1


VERIFY SCALE
BAR IS ONE (1) INCH LONG
ON ORIGINAL DRAWING:
0 1
IF BAR IS NOT ONE (1) INCH LONG,
ADJUST SCALE ACCORDINGLY

CONTRACTOR SHALL FIELD VERIFY ALL DIMENSIONS. VARIANCE FROM CONTRACT DOCUMENTS NOT PERMITTED WITHOUT PROFESSIONAL & BUREAU OF CONSTRUCTION APPROVAL.	DRAWN BY M DIMONTE	DATE 06/17/2022	DRAWING No. S-10
	CHECKED BY J ADAMS	SCALE AS NOTED	91 OF 144

FILE PATH: I:\2020\20027 - Hickory Run State Park\CD\sheet files\20027 - STRUCTURAL.dwg
LAYOUT TAB: S-10 LOOP C DETAILS - SHEET 1
PLOTTED BY: James Adams
PLOTTED: 2022.06.17 09:08 AM



1 DETAIL
S-11 BEAM/COLUMN CONNECTION 3"=1'-0"

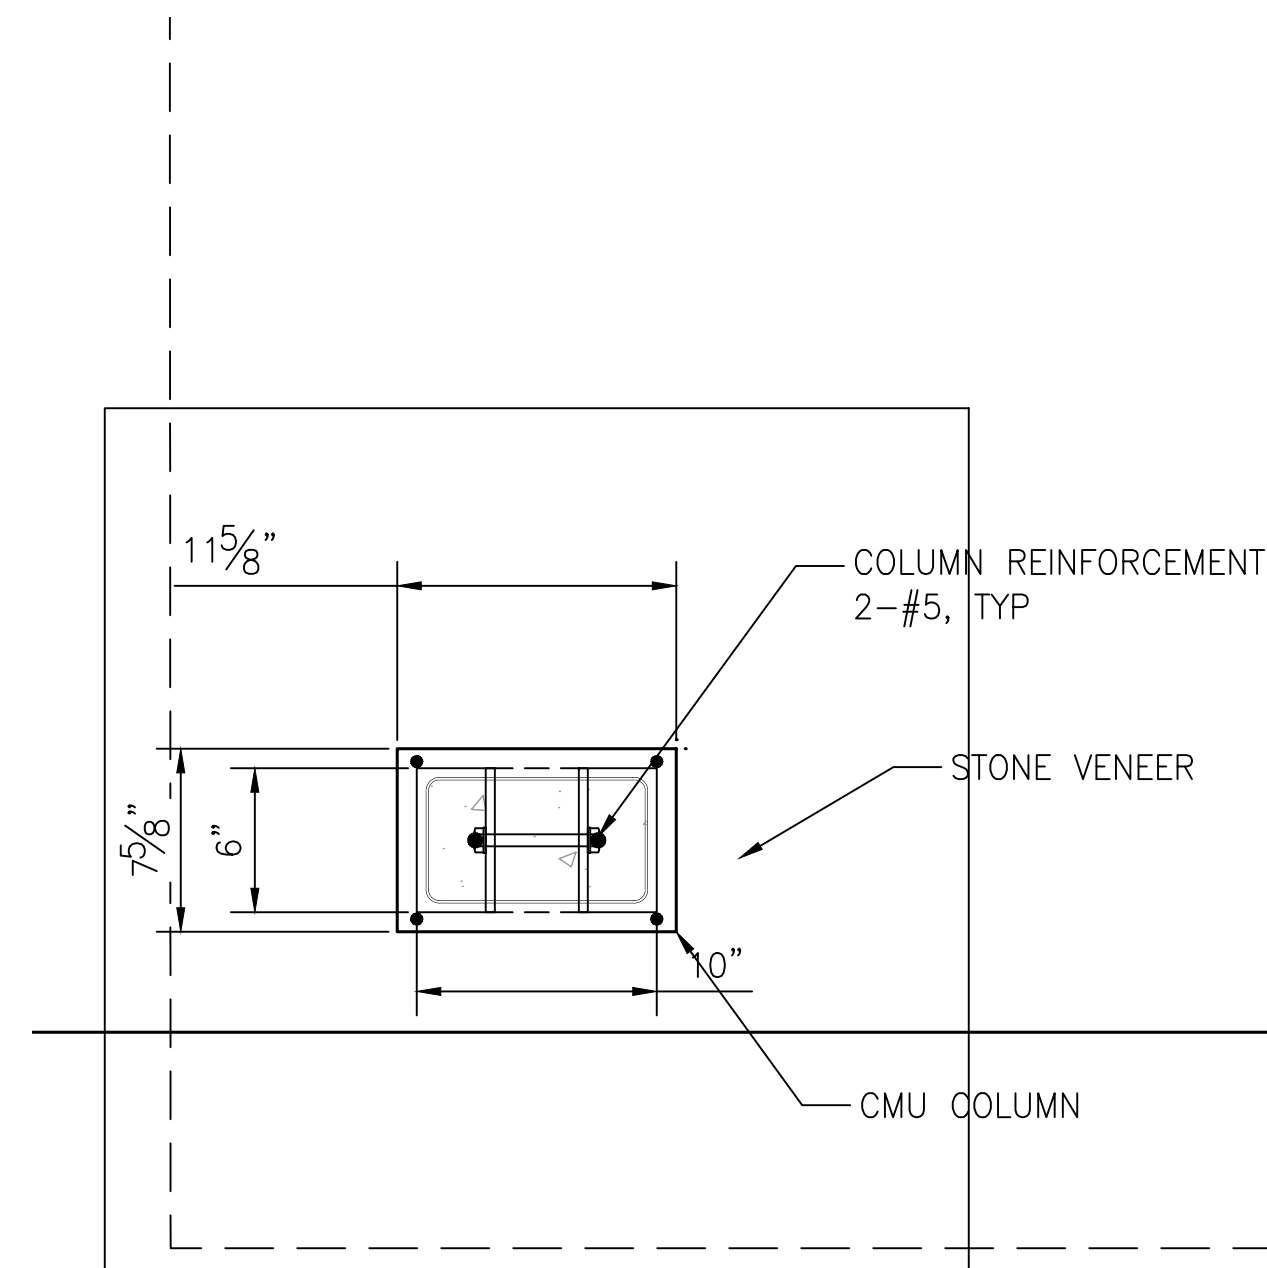

2 SECTION
S-11 1 1/2"=1'-0"

NOTES:
1. FOR GENERAL NOTES SEE SHEET S-2
2. FOR SYMBOLS AND ABBREVIATIONS SEE SHEET S-1

VERIFY SCALE
BAR IS ONE (1) INCH LONG ON ORIGINAL DRAWING:
0 1
IF BAR IS NOT ONE (1) INCH LONG, ADJUST SCALE ACCORDINGLY

CONTRACTOR SHALL FIELD VERIFY ALL DIMENSIONS. VARIANCE FROM CONTRACT DOCUMENTS NOT PERMITTED WITHOUT PROFESSIONAL & BUREAU OF CONSTRUCTION APPROVAL.

DRAWN BY: **M DIMONTE**
CHECKED BY: **J ADAMS**

DATE: 06/17/2022
SCALE: AS NOTED

DRAWING No. **S-11**

92 OF 144

CONSTRUCTION DOCUMENTS

meliora

259 MORGAN STREET, PHOENIXVILLE, PA 19460
(610) 933-0123 melioradesign.com

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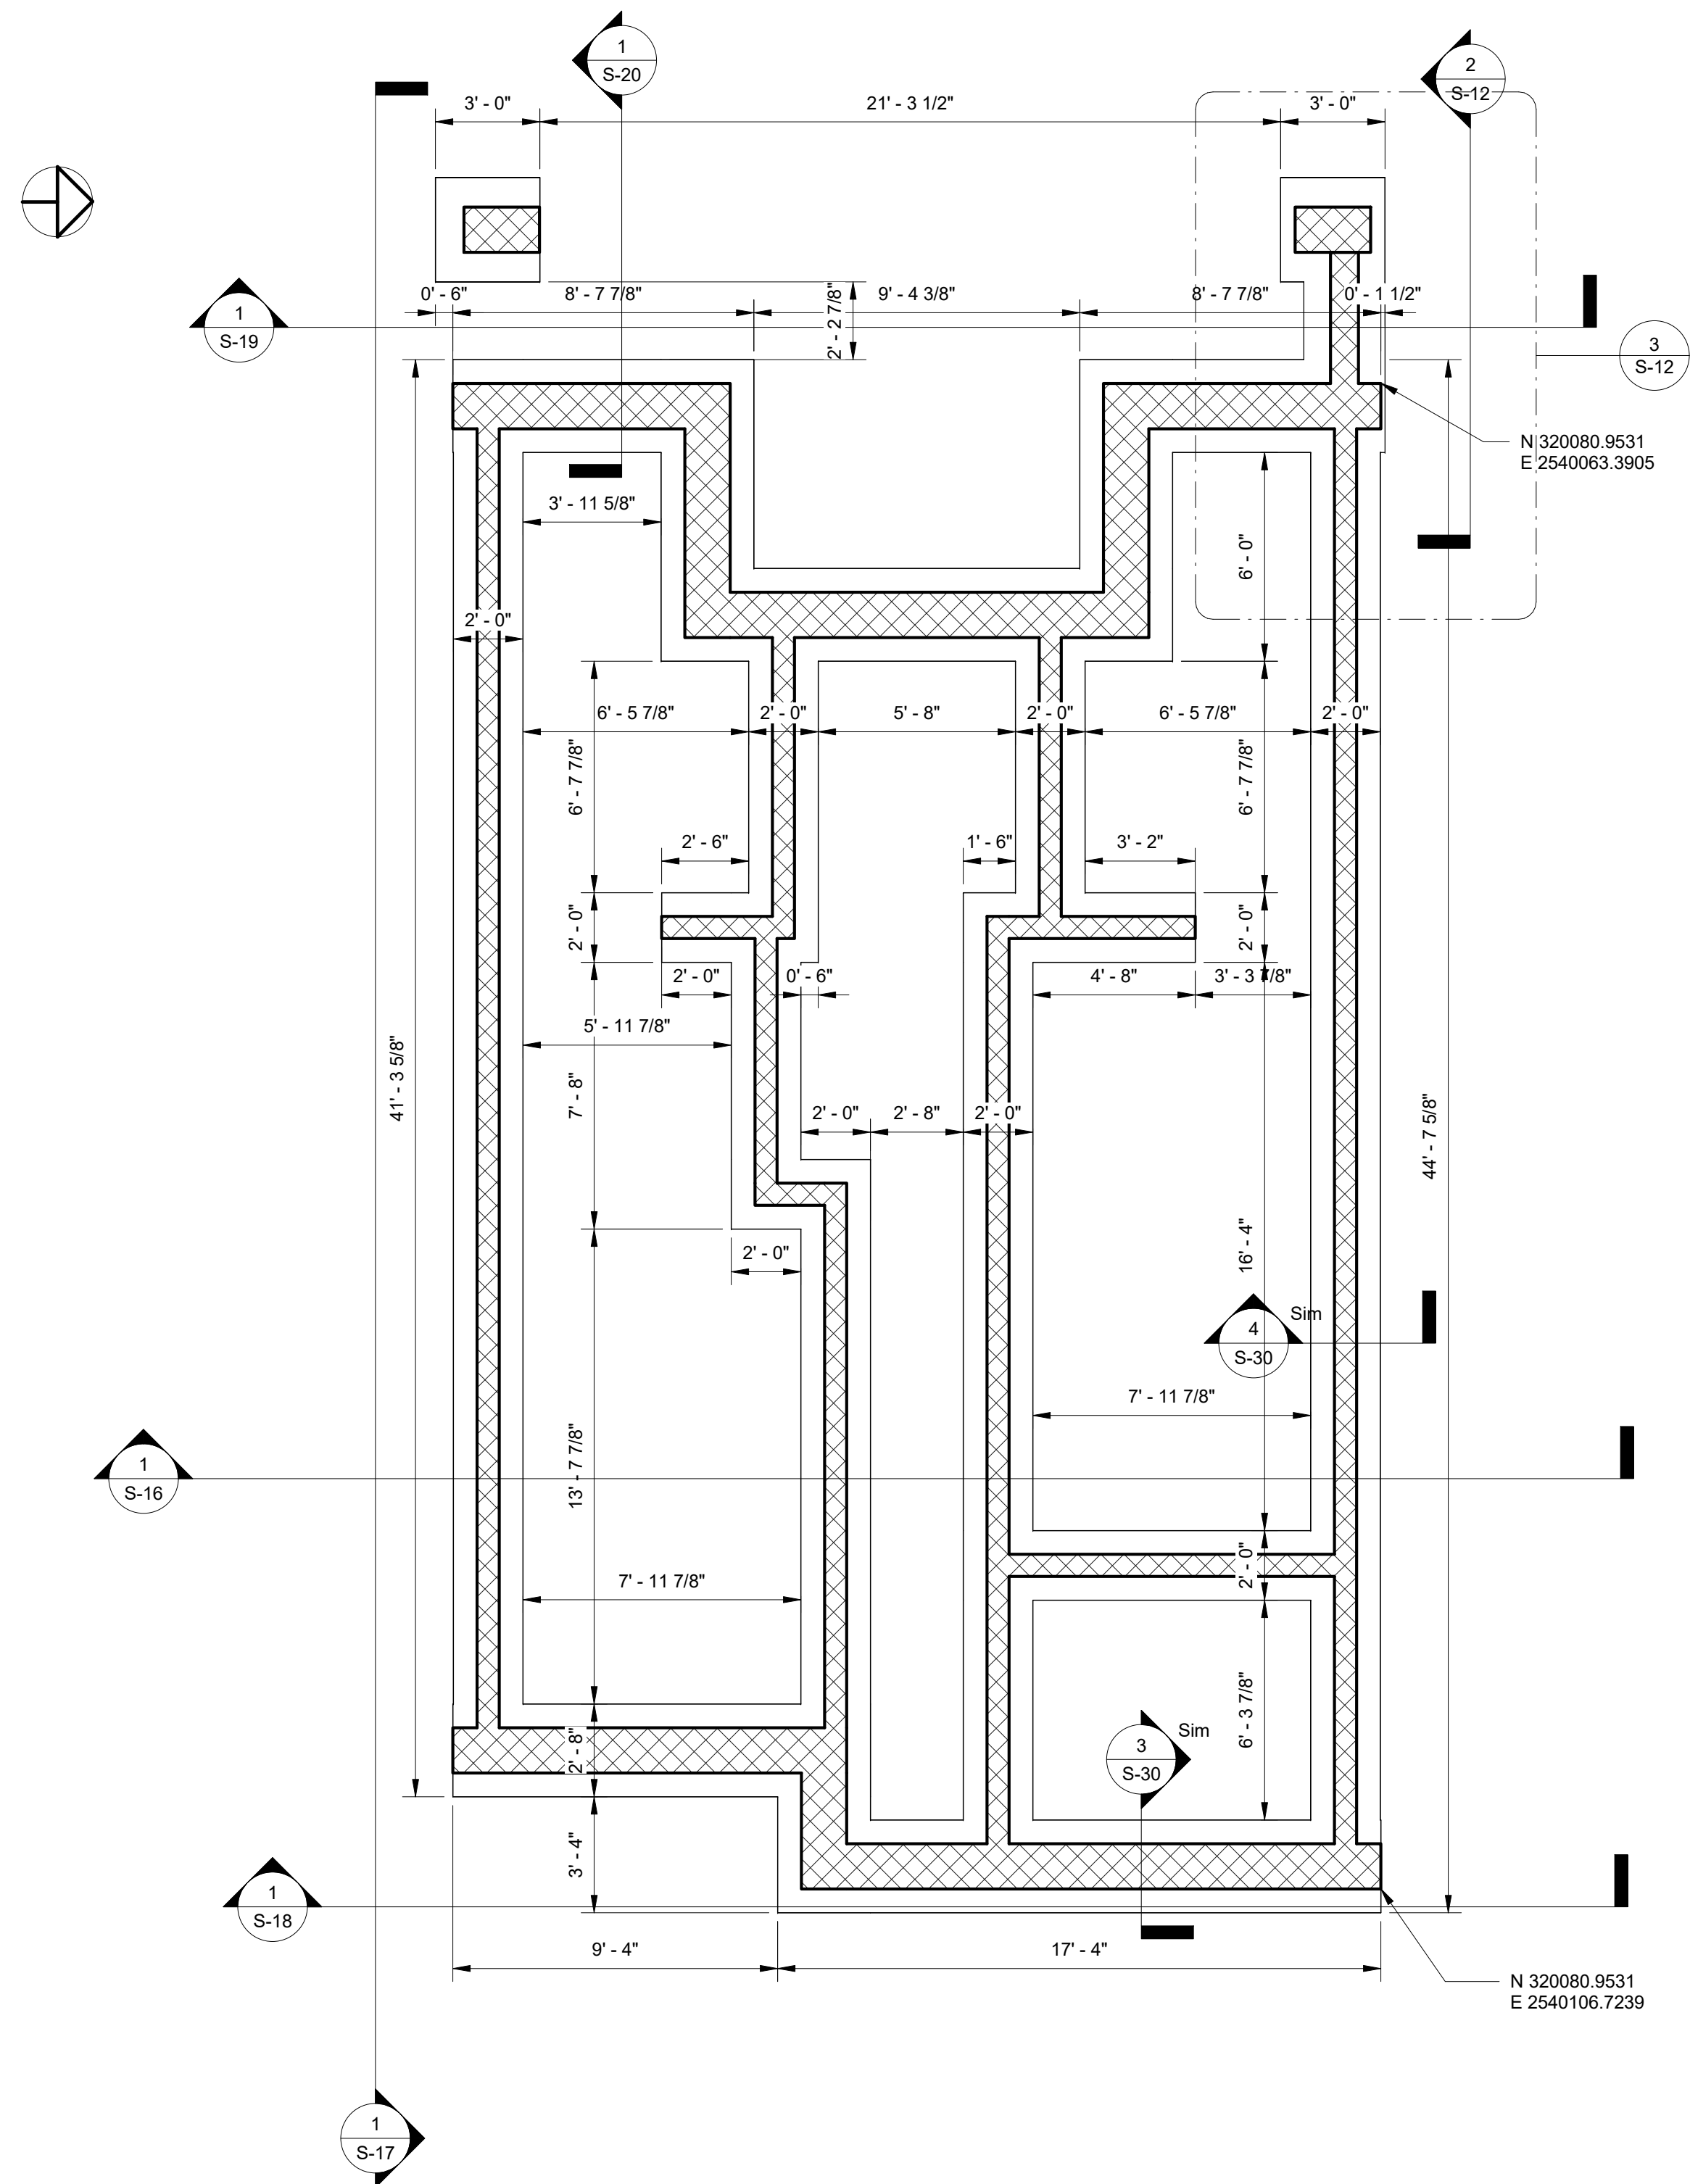
COMMONWEALTH OF PENNSYLVANIA
DEPARTMENT OF GENERAL SERVICES
HARRISBURG, PENNSYLVANIA

D.G.S. PROJECT No. **C-114-0006 PHASE 1**


HICKORY RUN STATE PARK
LATRINE IMPROVEMENTS
DEPT of CONSERVATION AND NATURAL RESOURCES
WHITE HAVEN, CARBON COUNTY, PA

LOOP C DETAILS - SHEET 2


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LAYOUT TAB: S-11 LOOP C DETAILS - SHEET 2
PLOTTED BY: James Adams
PLOTTED: 2022.06.17 09:08 AM
LAST SAVED: 2022.06.10 01:08 PM



① Footing - Tent Camp
1/4" = 1'-0"

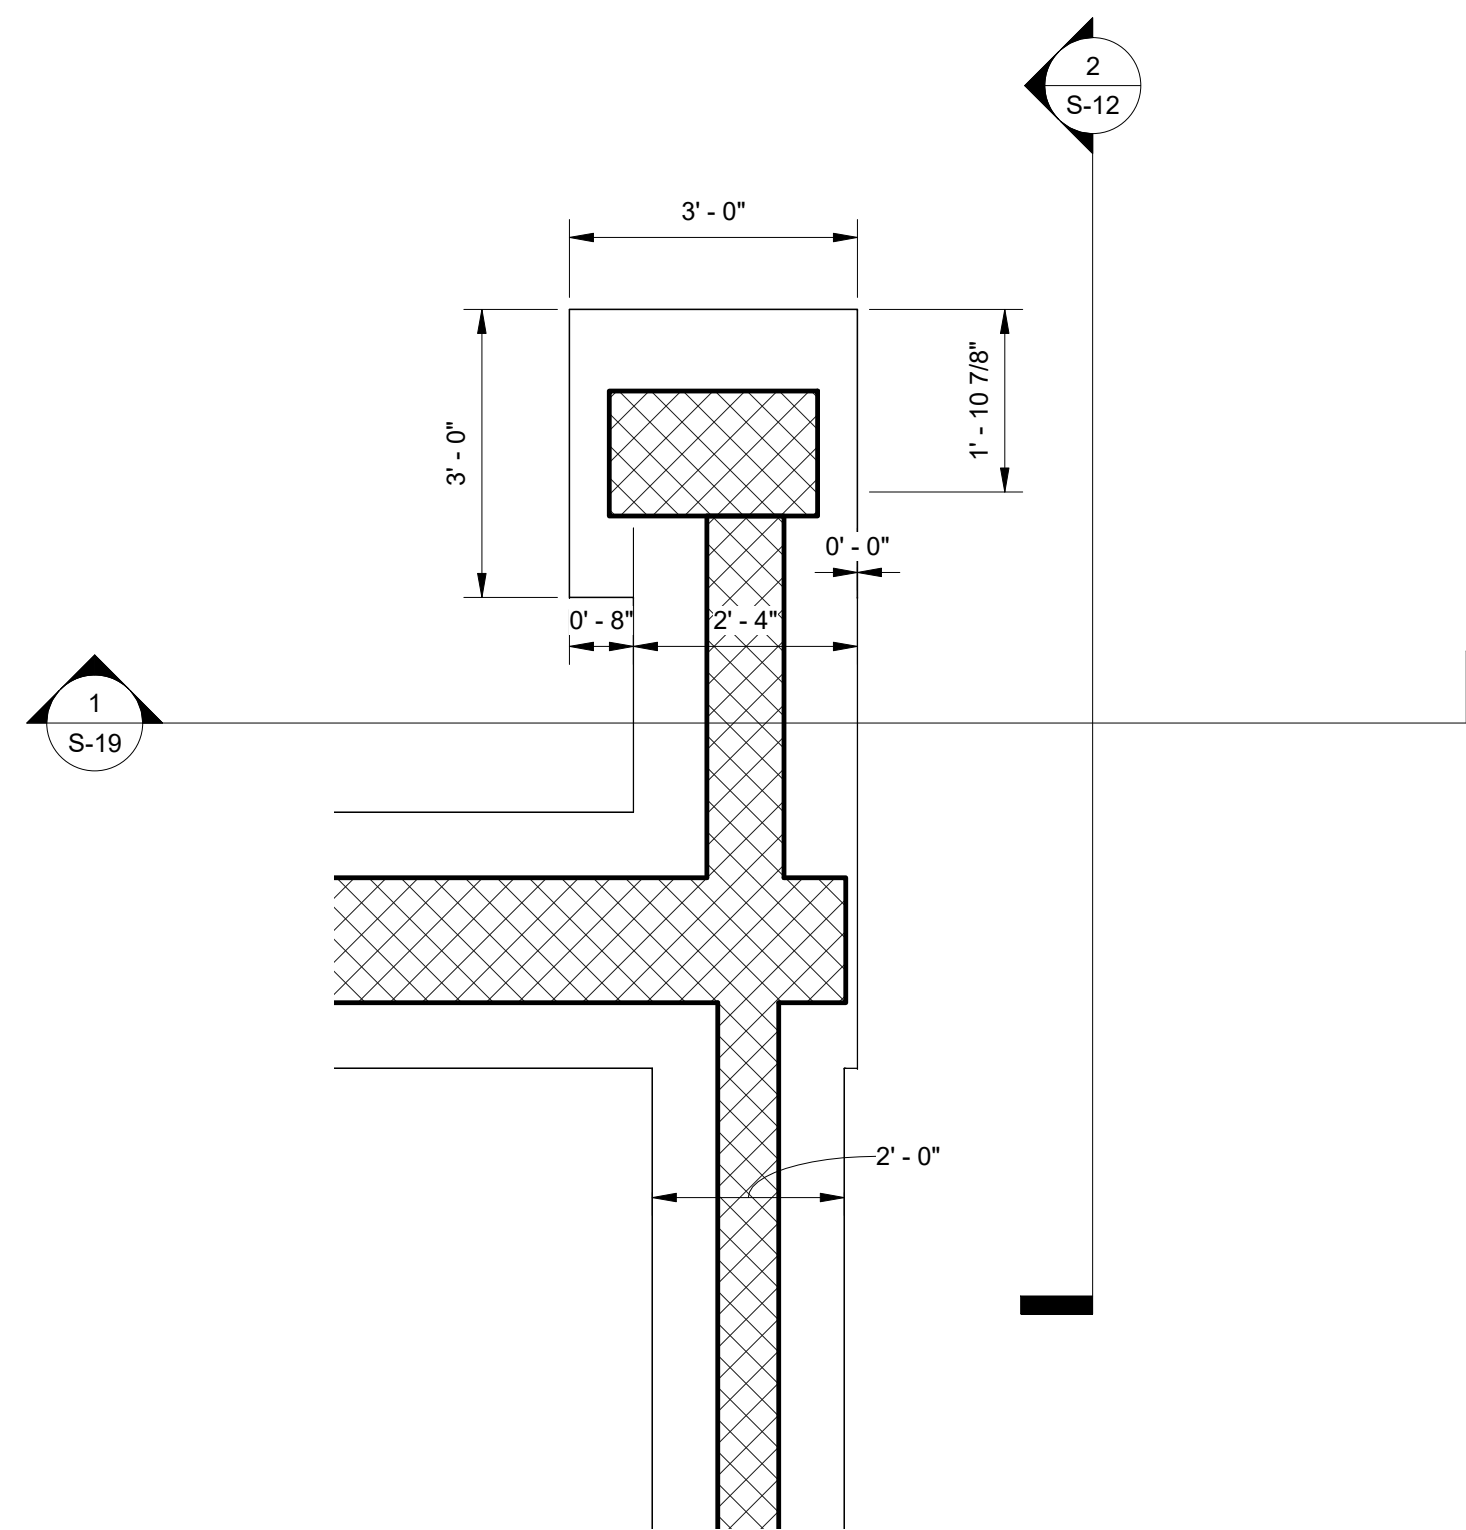

③ Footing - Tent Camp - Callout 1
1/2" = 1'-0"

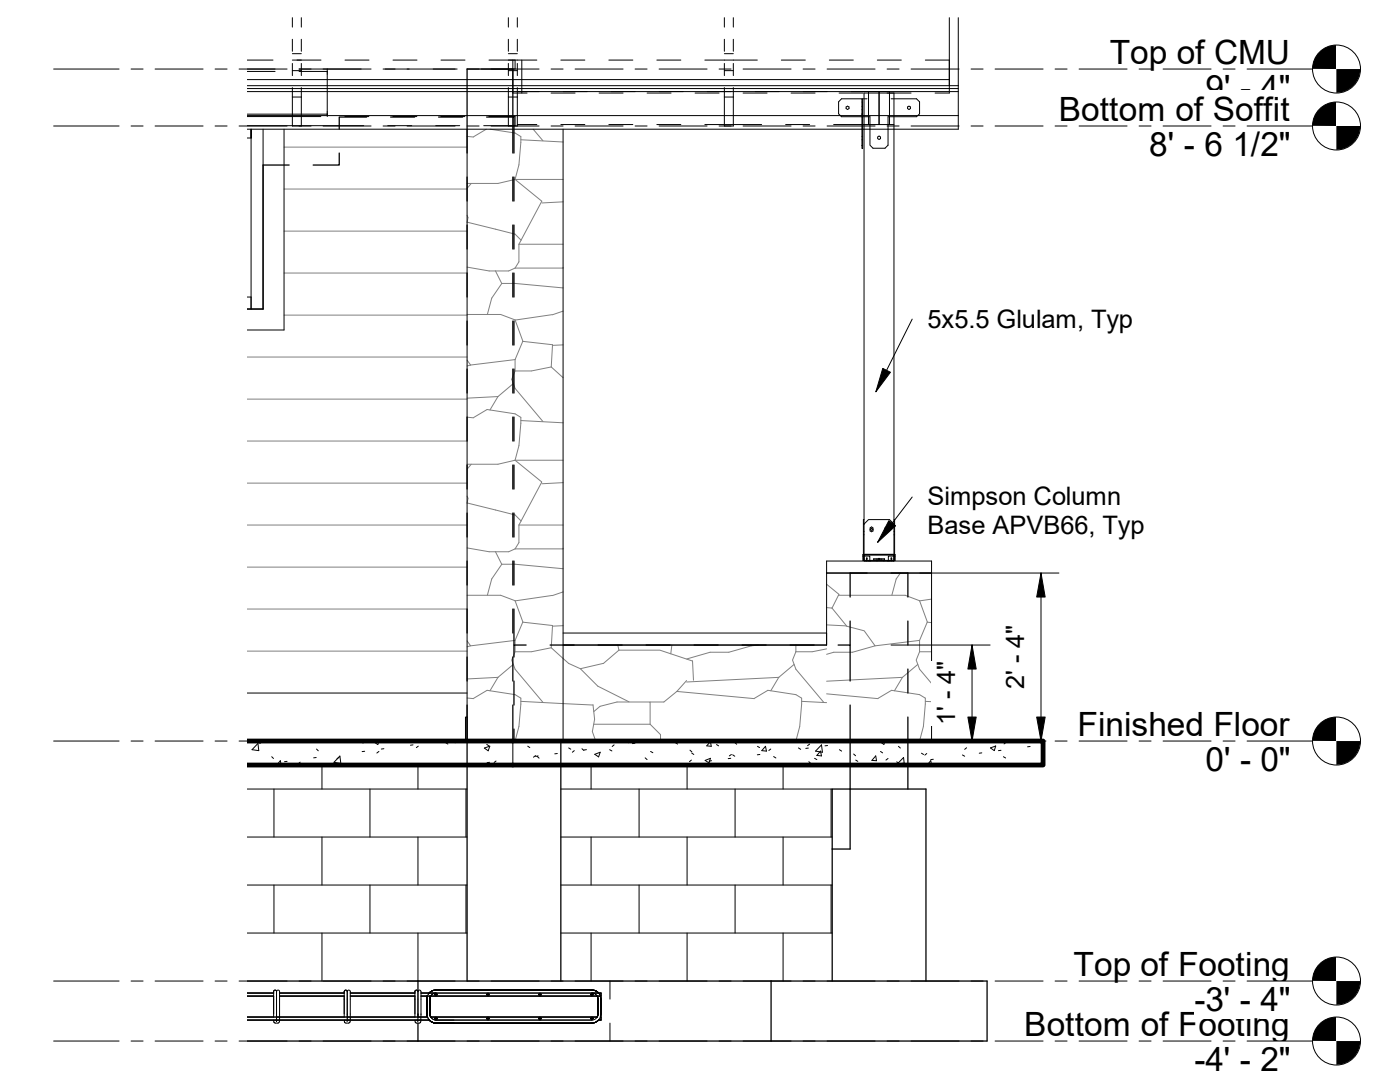


② Bench Wall
3/8" = 1'-0"

CONSTRUCTION DOCUMENTS



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DEPARTMENT OF GENERAL SERVICES
HARRISBURG, PENNSYLVANIA
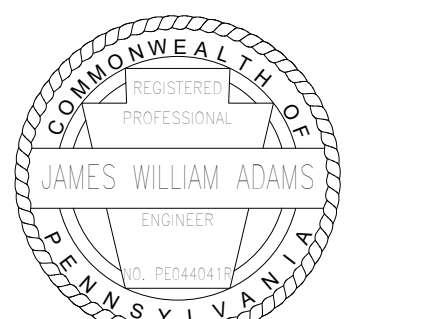
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C-114-0006 PHASE 1


HICKORY RUN STATE PARK
LATRINE IMPROVEMENTS
DEPT of CONSERVATION AND NATURAL RESOURCES
WHITE HAVEN, CARBON COUNTY, PA

TENT CAMP FOOTING PLAN


VERIFY SCALE	
BAR IS ONE (1) INCH LONG	ON ORIGINAL DRAWING: 0 1
IF BAR IS NOT ONE (1) INCH LONG, ADJUST SCALE ACCORDINGLY	
CONTRACTOR SHALL FIELD VERIFY ALL DIMENSIONS. VARIANCE FROM CONTRACT DOCUMENTS NOT PERMITTED WITHOUT PROFESSIONAL & BUREAU OF CONSTRUCTION APPROVAL.	

DRAWN BY J ADAMS	DATE 06/17/2022	DRAWING No. S-12
CHECKED BY J ADAMS	SCALE AS NOTED	93 OF 144

NOTES:
1. FOR GENERAL NOTES SEE SHEET S-2
2. FOR SYMBOLS AND ABBREVIATIONS SEE SHEET S-1

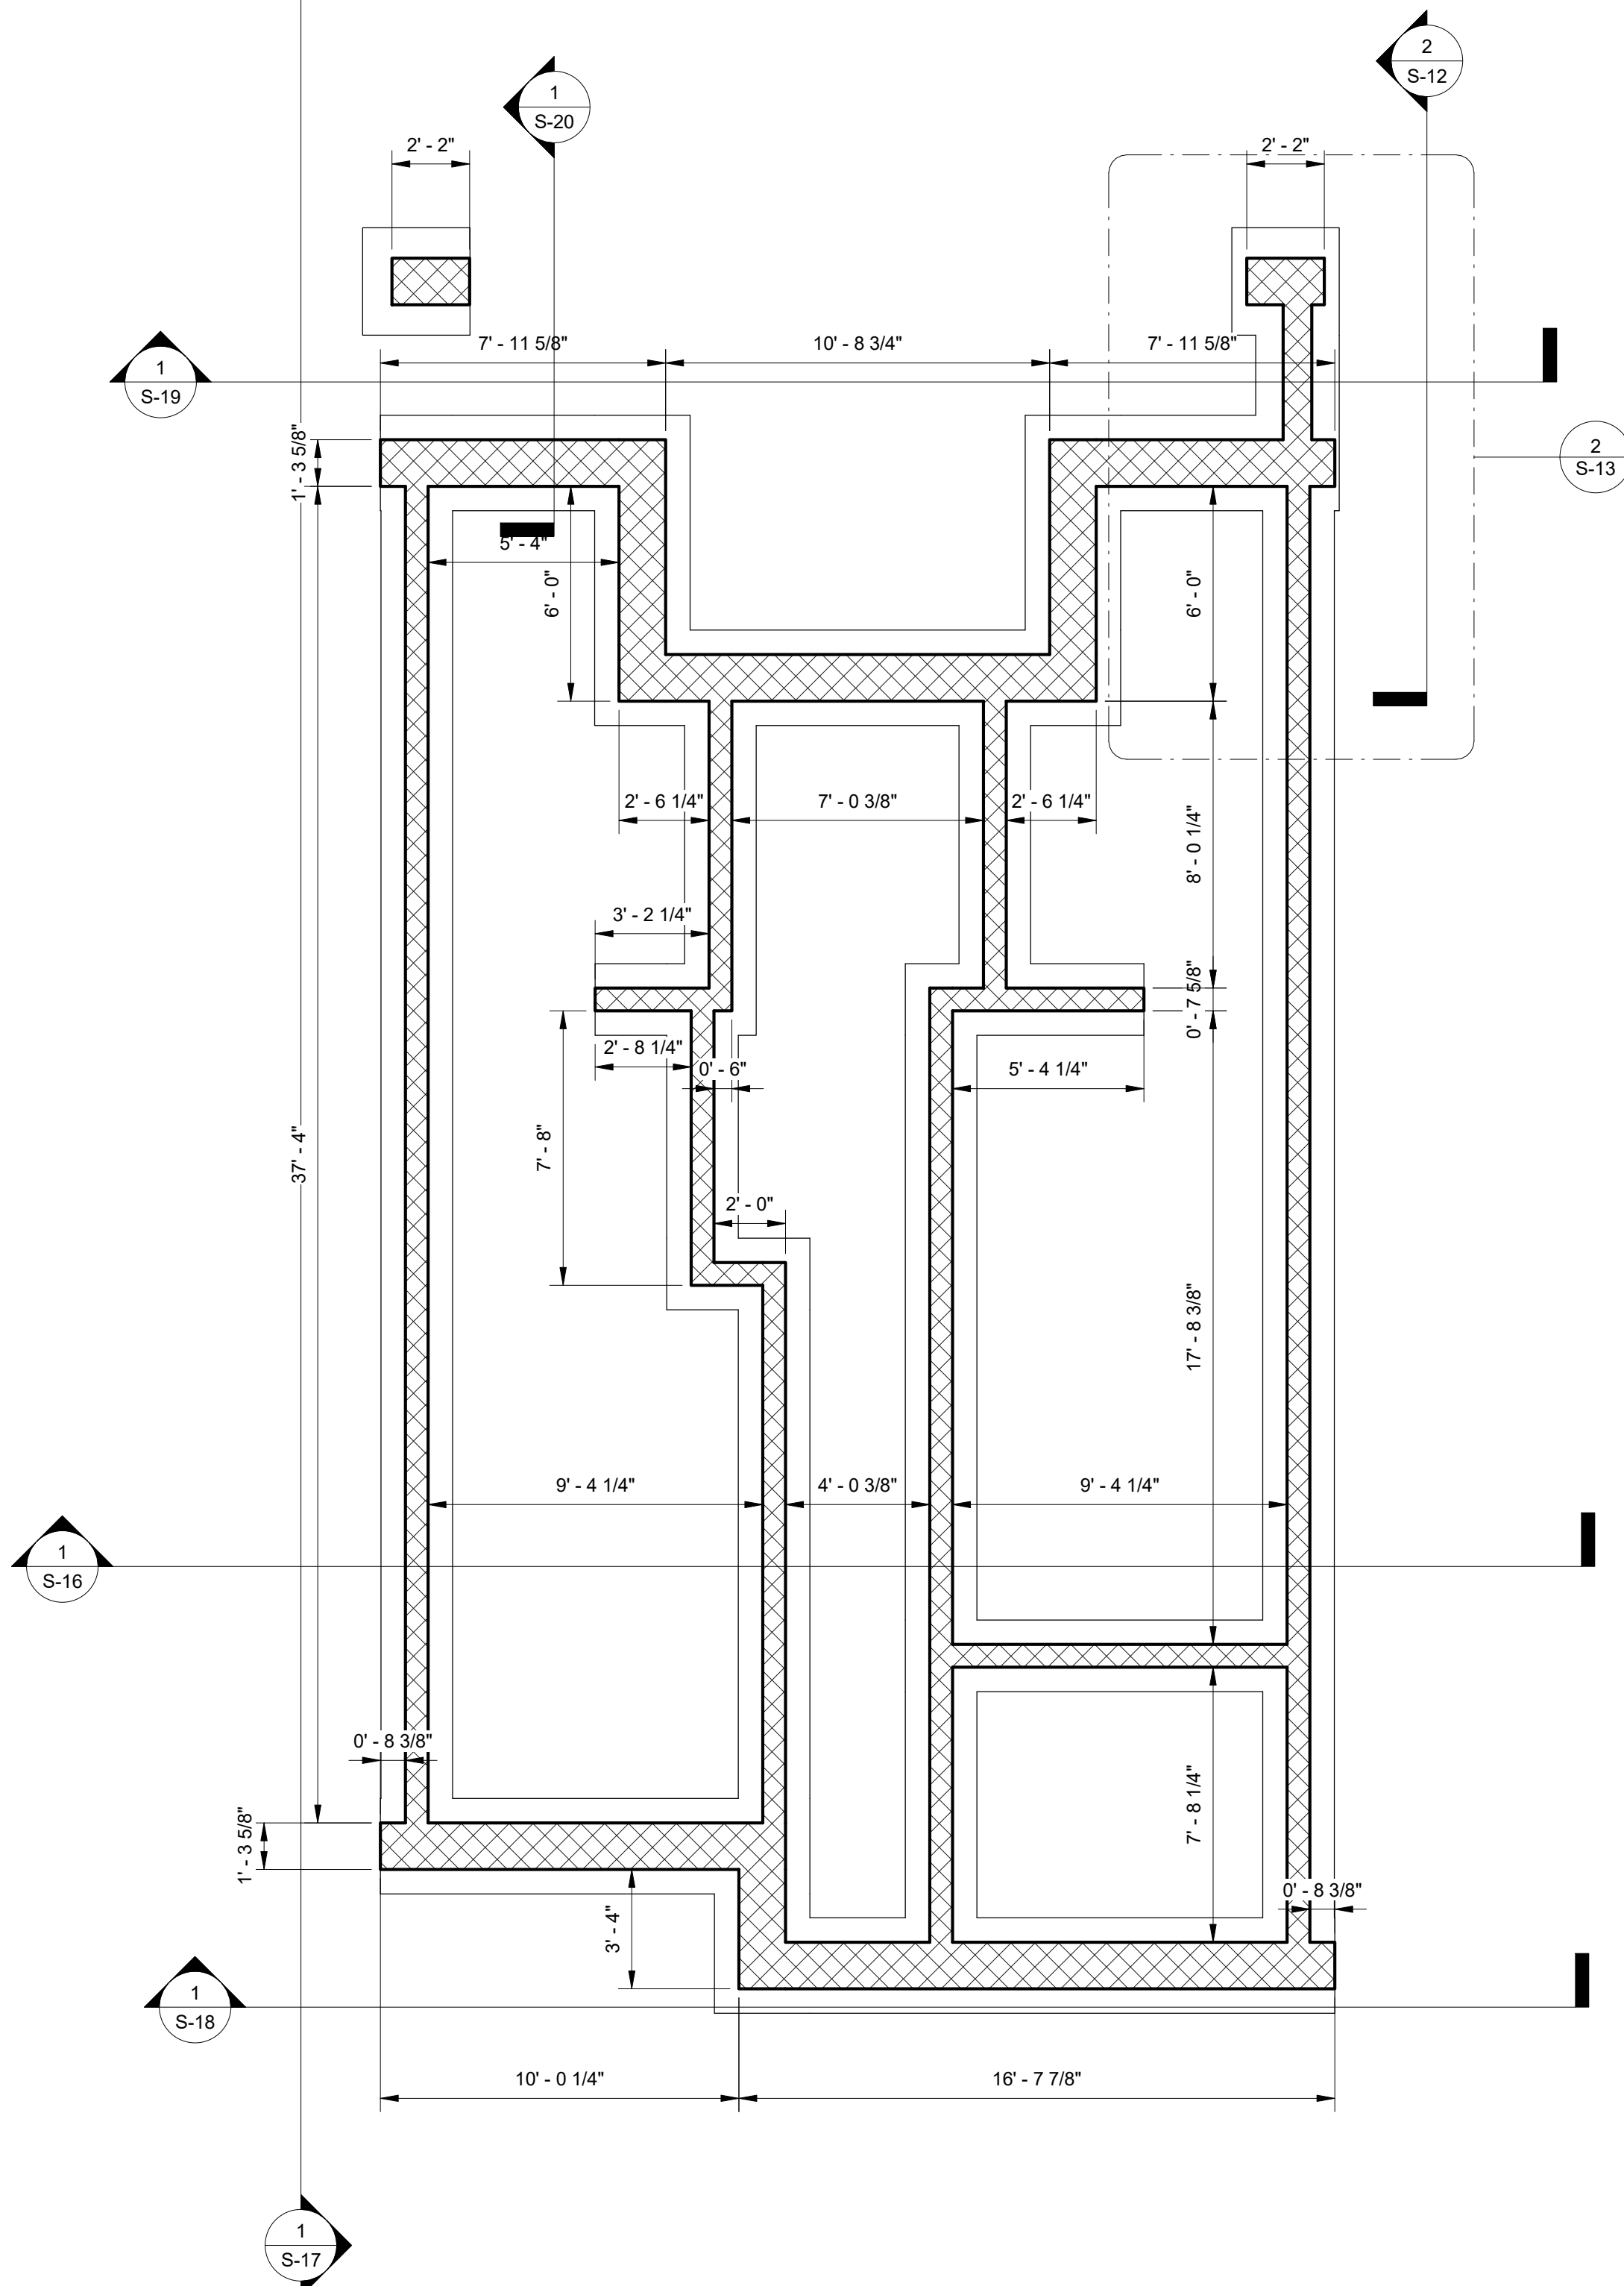

① Foundation Wall - Tent Camp
1/4" = 1'-0"

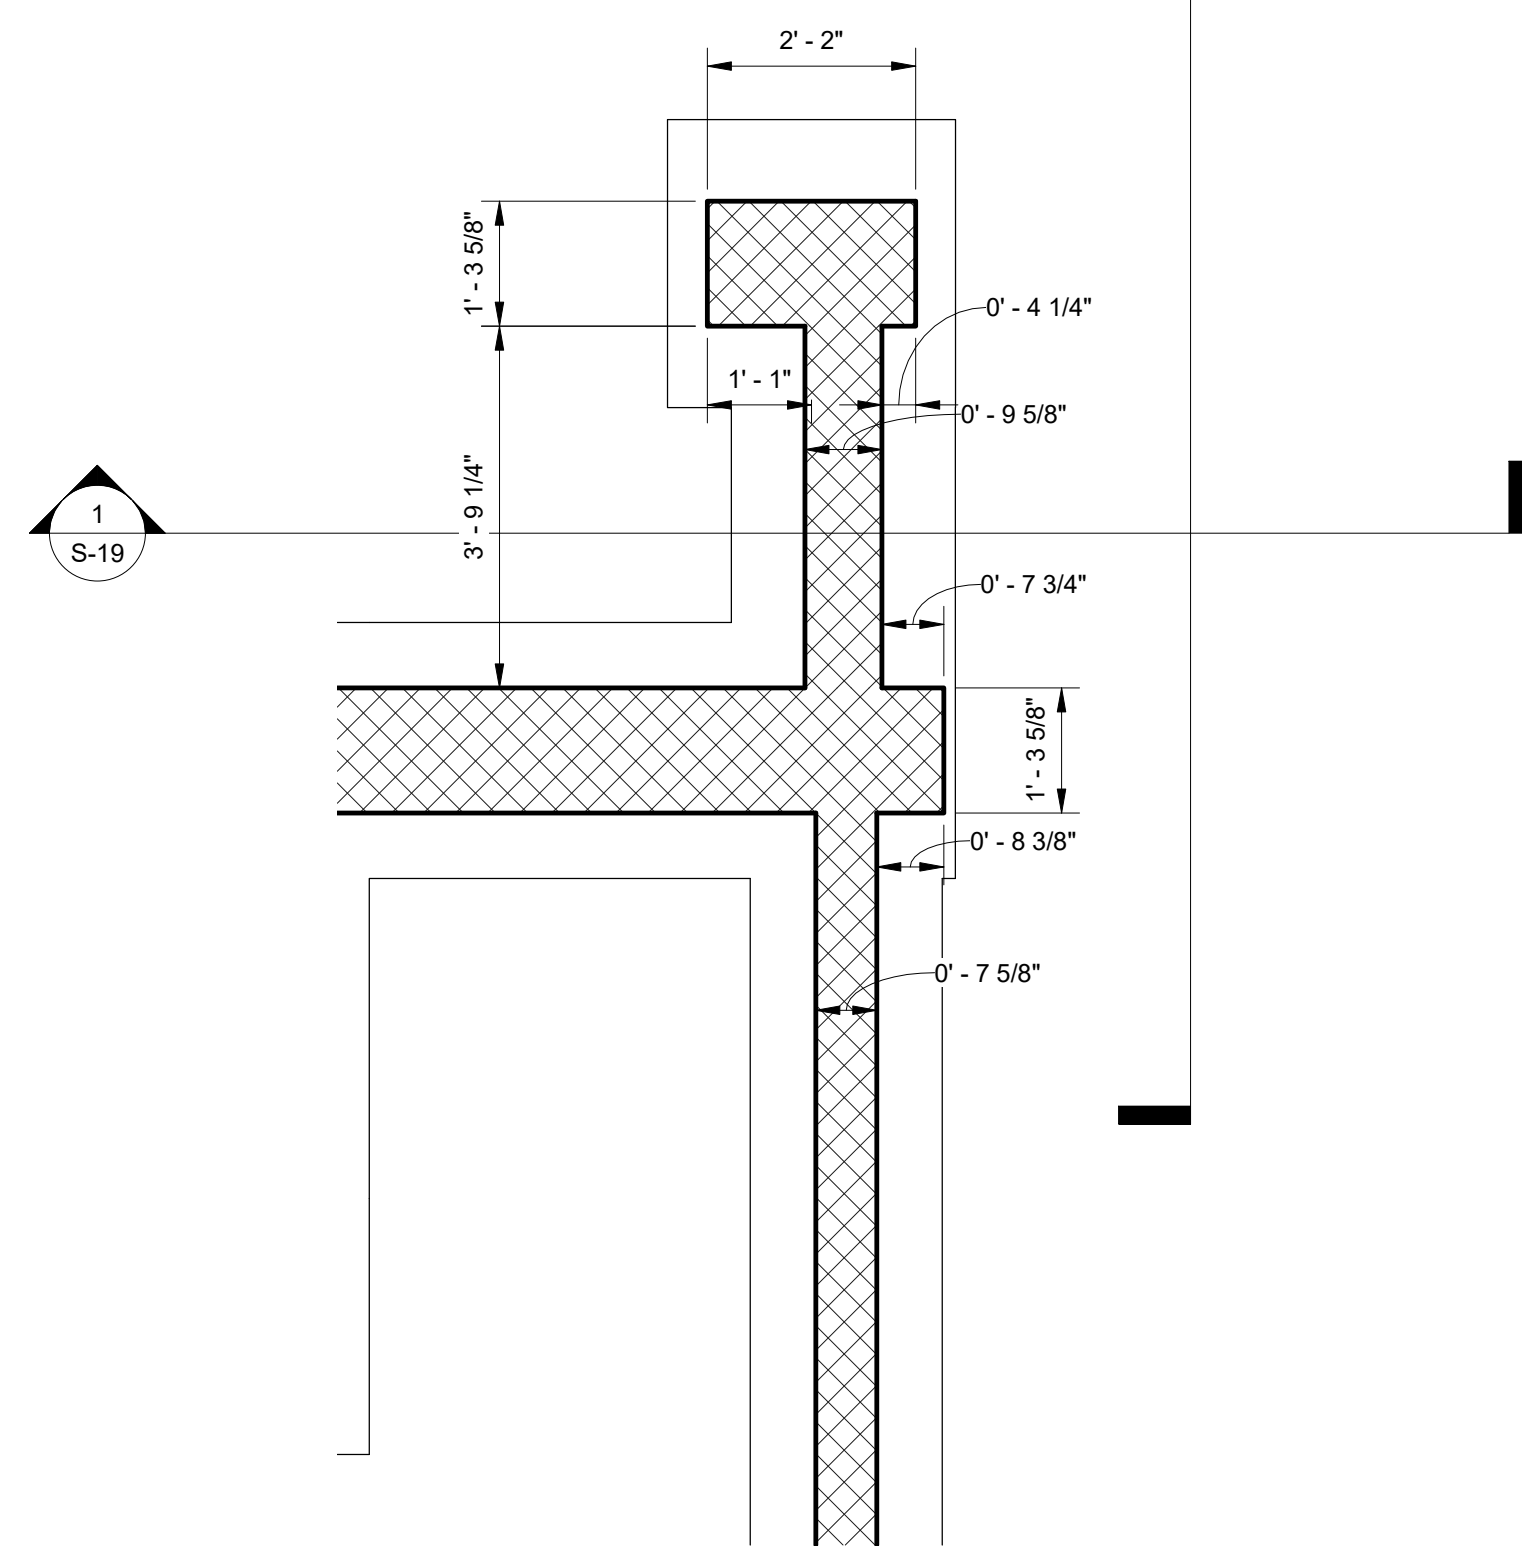


② Foundation Wall - Tent Camp - Callout 1
1/2" = 1'-0"

CONSTRUCTION DOCUMENTS



NO.	REVISION	DATE

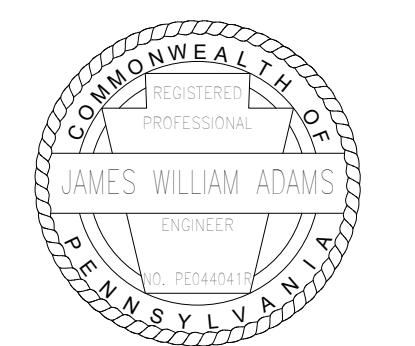

James W. Adams
SIGNATURE DATE 11/19/2021

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1600 WALNUT STREET, SECOND FLOOR
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DEPARTMENT OF GENERAL SERVICES
HARRISBURG, PENNSYLVANIA

D.G.S. PROJECT No.
C-114-0006 PHASE 1


HICKORY RUN STATE PARK
LATRINE IMPROVEMENTS
DEPT of CONSERVATION AND NATURAL RESOURCES
WHITE HAVEN, CARBON COUNTY, PA

TENT CAMP FOUNDATION WALL PLAN

VERIFY SCALE	
BAR IS ONE (1) INCH LONG	ON ORIGINAL DRAWING: 0 1
IF BAR IS NOT ONE (1) INCH LONG, ADJUST SCALE ACCORDINGLY	
CONTRACTOR SHALL FIELD VERIFY ALL DIMENSIONS. VARIANCE FROM CONTRACT DOCUMENTS NOT PERMITTED WITHOUT PROFESSIONAL & BUREAU OF CONSTRUCTION APPROVAL.	

DRAWN BY J ADAMS	DATE 06/17/2022	DRAWING No. S-13
CHECKED BY J ADAMS	SCALE AS NOTED	94 OF 144

NOTES:
1. FOR GENERAL NOTES SEE SHEET S-2
2. FOR SYMBOLS AND ABBREVIATIONS SEE SHEET S-1

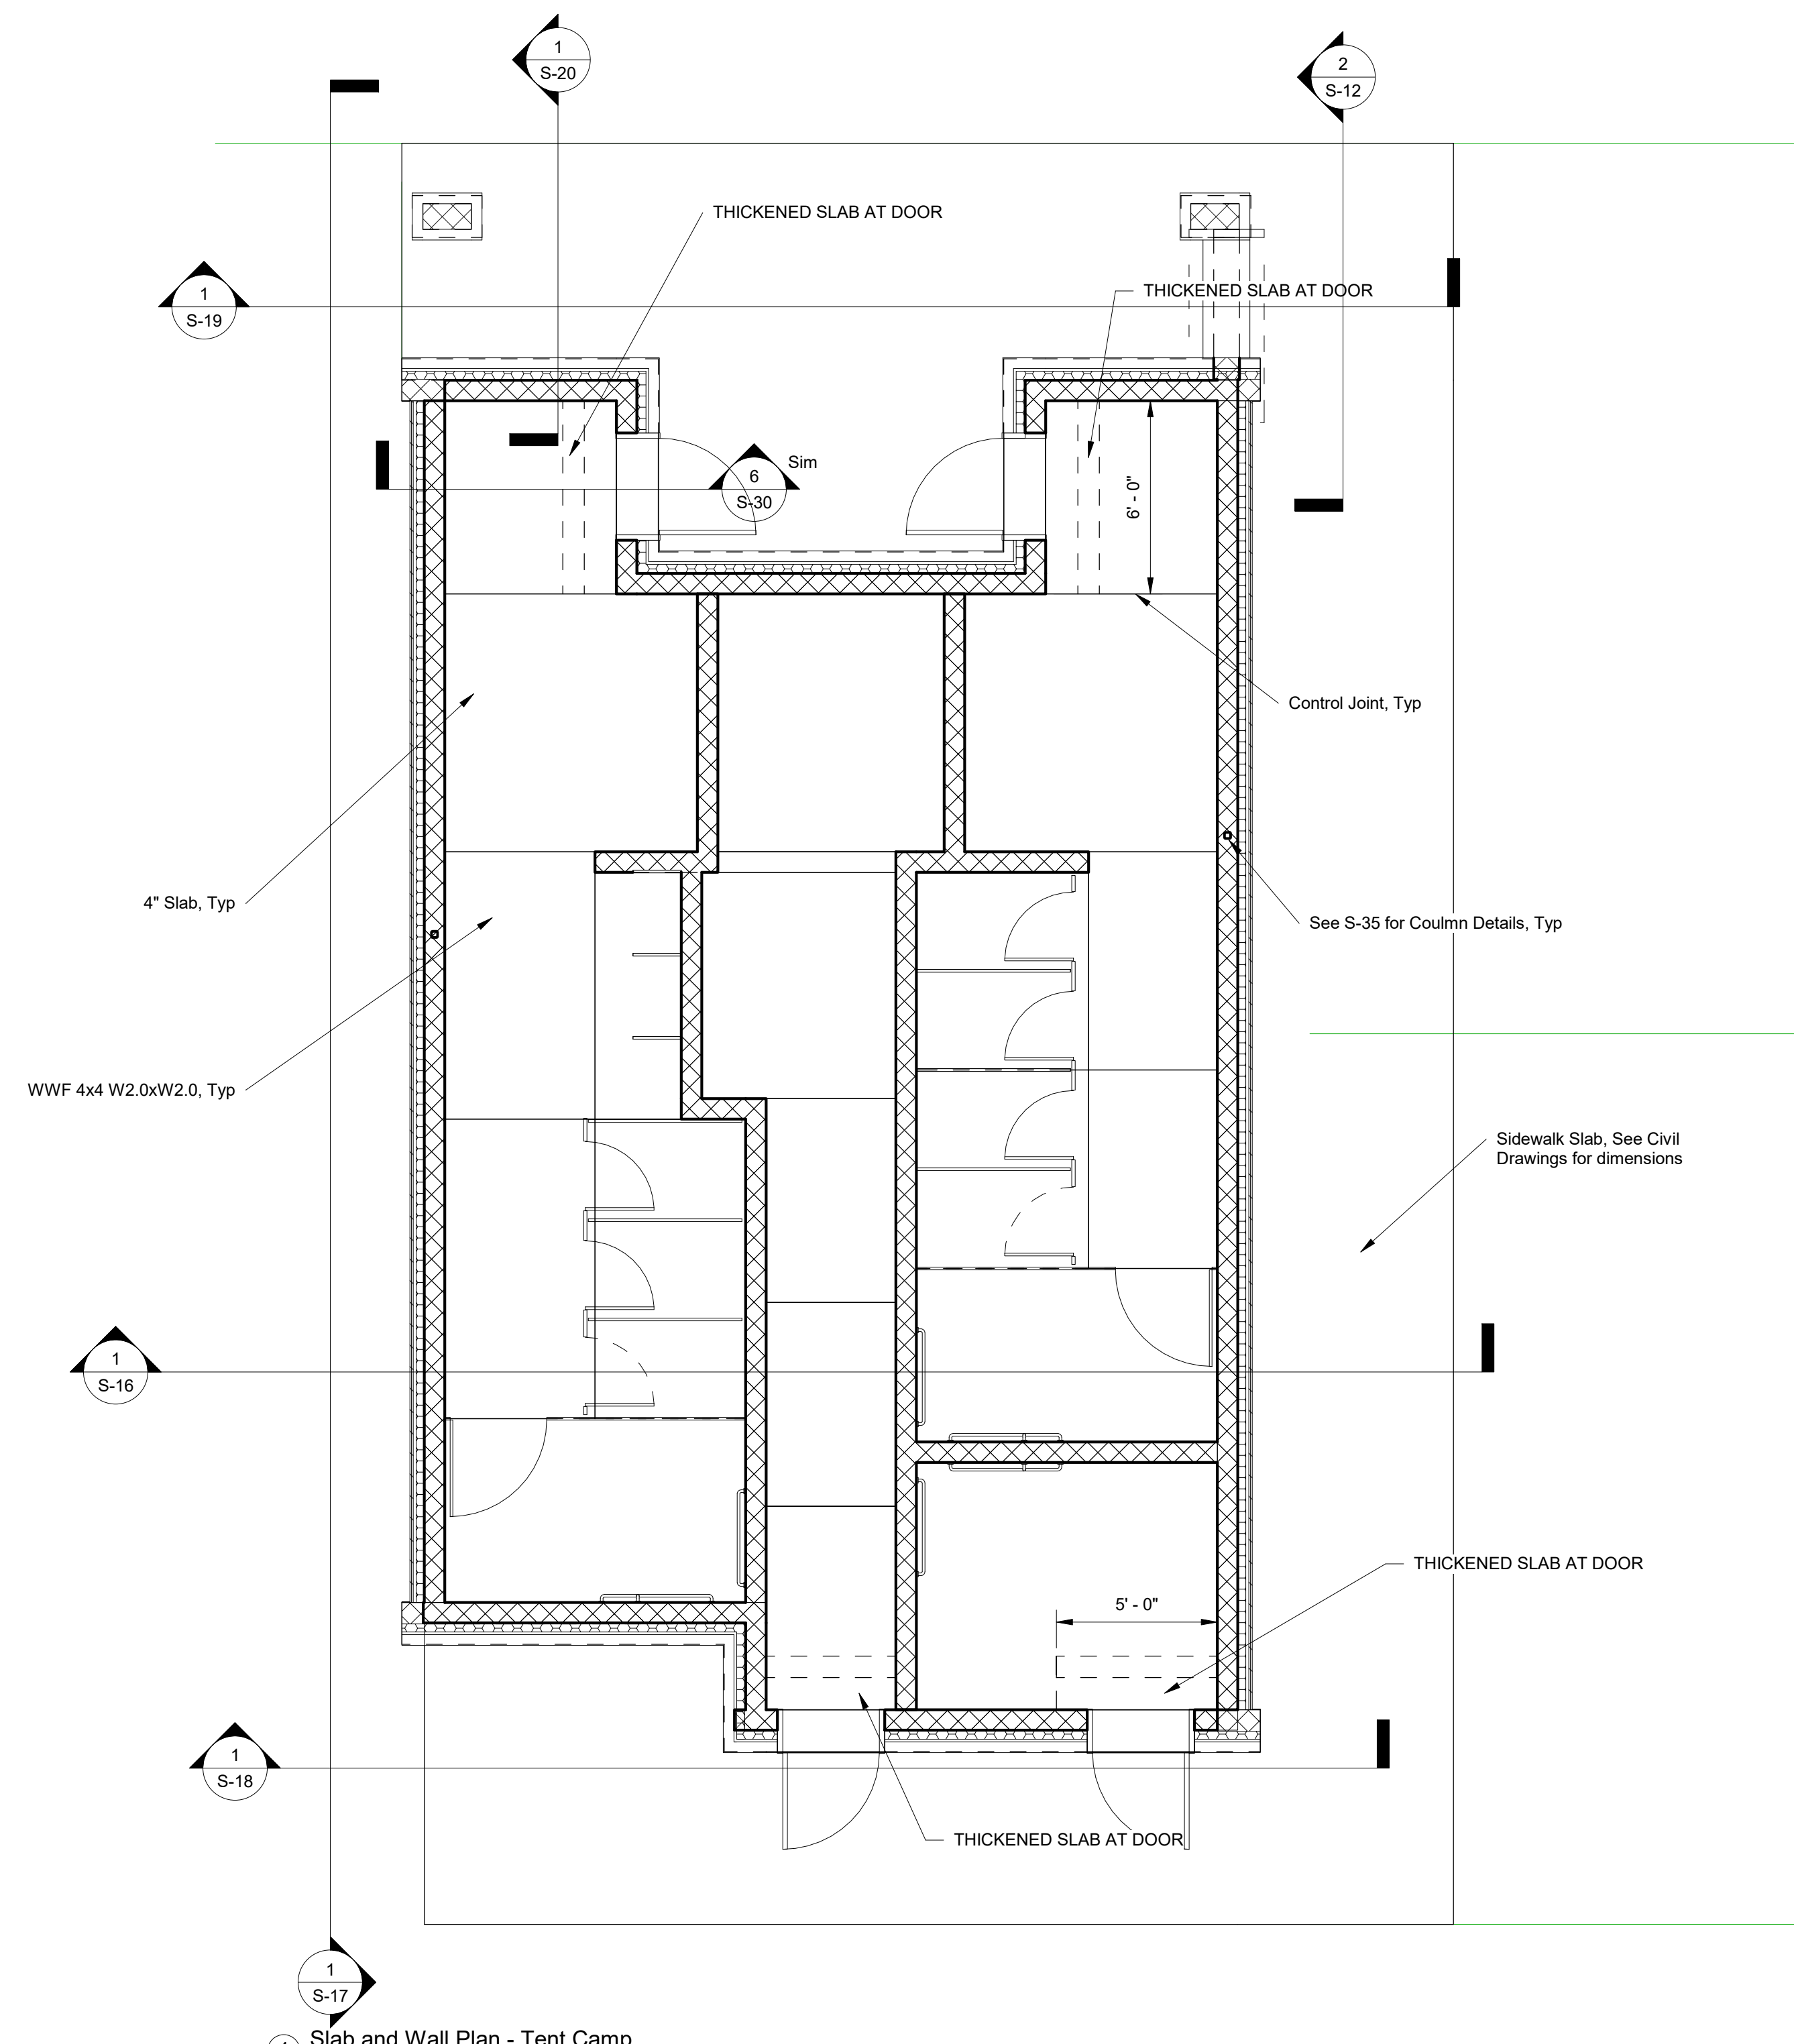


1 Slab and Wall Plan - Tent Camp
1/4" = 1'-0"

- NOTES:
 1. FOR GENERAL NOTES SEE SHEET S-2
 2. FOR SYMBOLS AND ABBREVIATIONS SEE SHEET S-1

CONSTRUCTION DOCUMENTS



NO.	REVISION	DATE

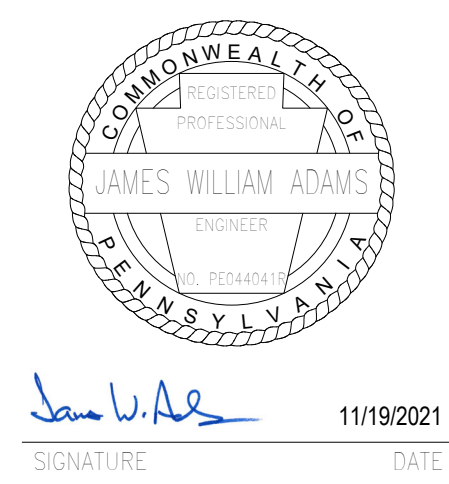


SMP ARCHITECTS
 1600 WALNUT STREET, SECOND FLOOR
 PHILADELPHIA, PENNSYLVANIA

COMMONWEALTH OF PENNSYLVANIA
 DEPARTMENT OF GENERAL SERVICES
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D.G.S. PROJECT No.
C-114-0006 PHASE 1
HICKORY RUN STATE PARK
LATRINE IMPROVEMENTS
 DEPT of CONSERVATION AND NATURAL RESOURCES
 WHITE HAVEN, CARBON COUNTY, PA

VERIFY SCALE
 BAR IS ONE (1) INCH LONG
 ON ORIGINAL DRAWING: 0 1
 IF BAR IS NOT ONE (1) INCH LONG, ADJUST SCALE ACCORDINGLY

CONTRACTOR SHALL FIELD VERIFY ALL DIMENSIONS. VARIANCE FROM CONTRACT DOCUMENTS NOT PERMITTED WITHOUT PROFESSIONAL & BUREAU OF CONSTRUCTION APPROVAL.	DRAWN BY J ADAMS	DATE 06/17/2022	DRAWING No. S-14
	CHECKED BY J ADAMS	SCALE AS NOTED	95 OF 144

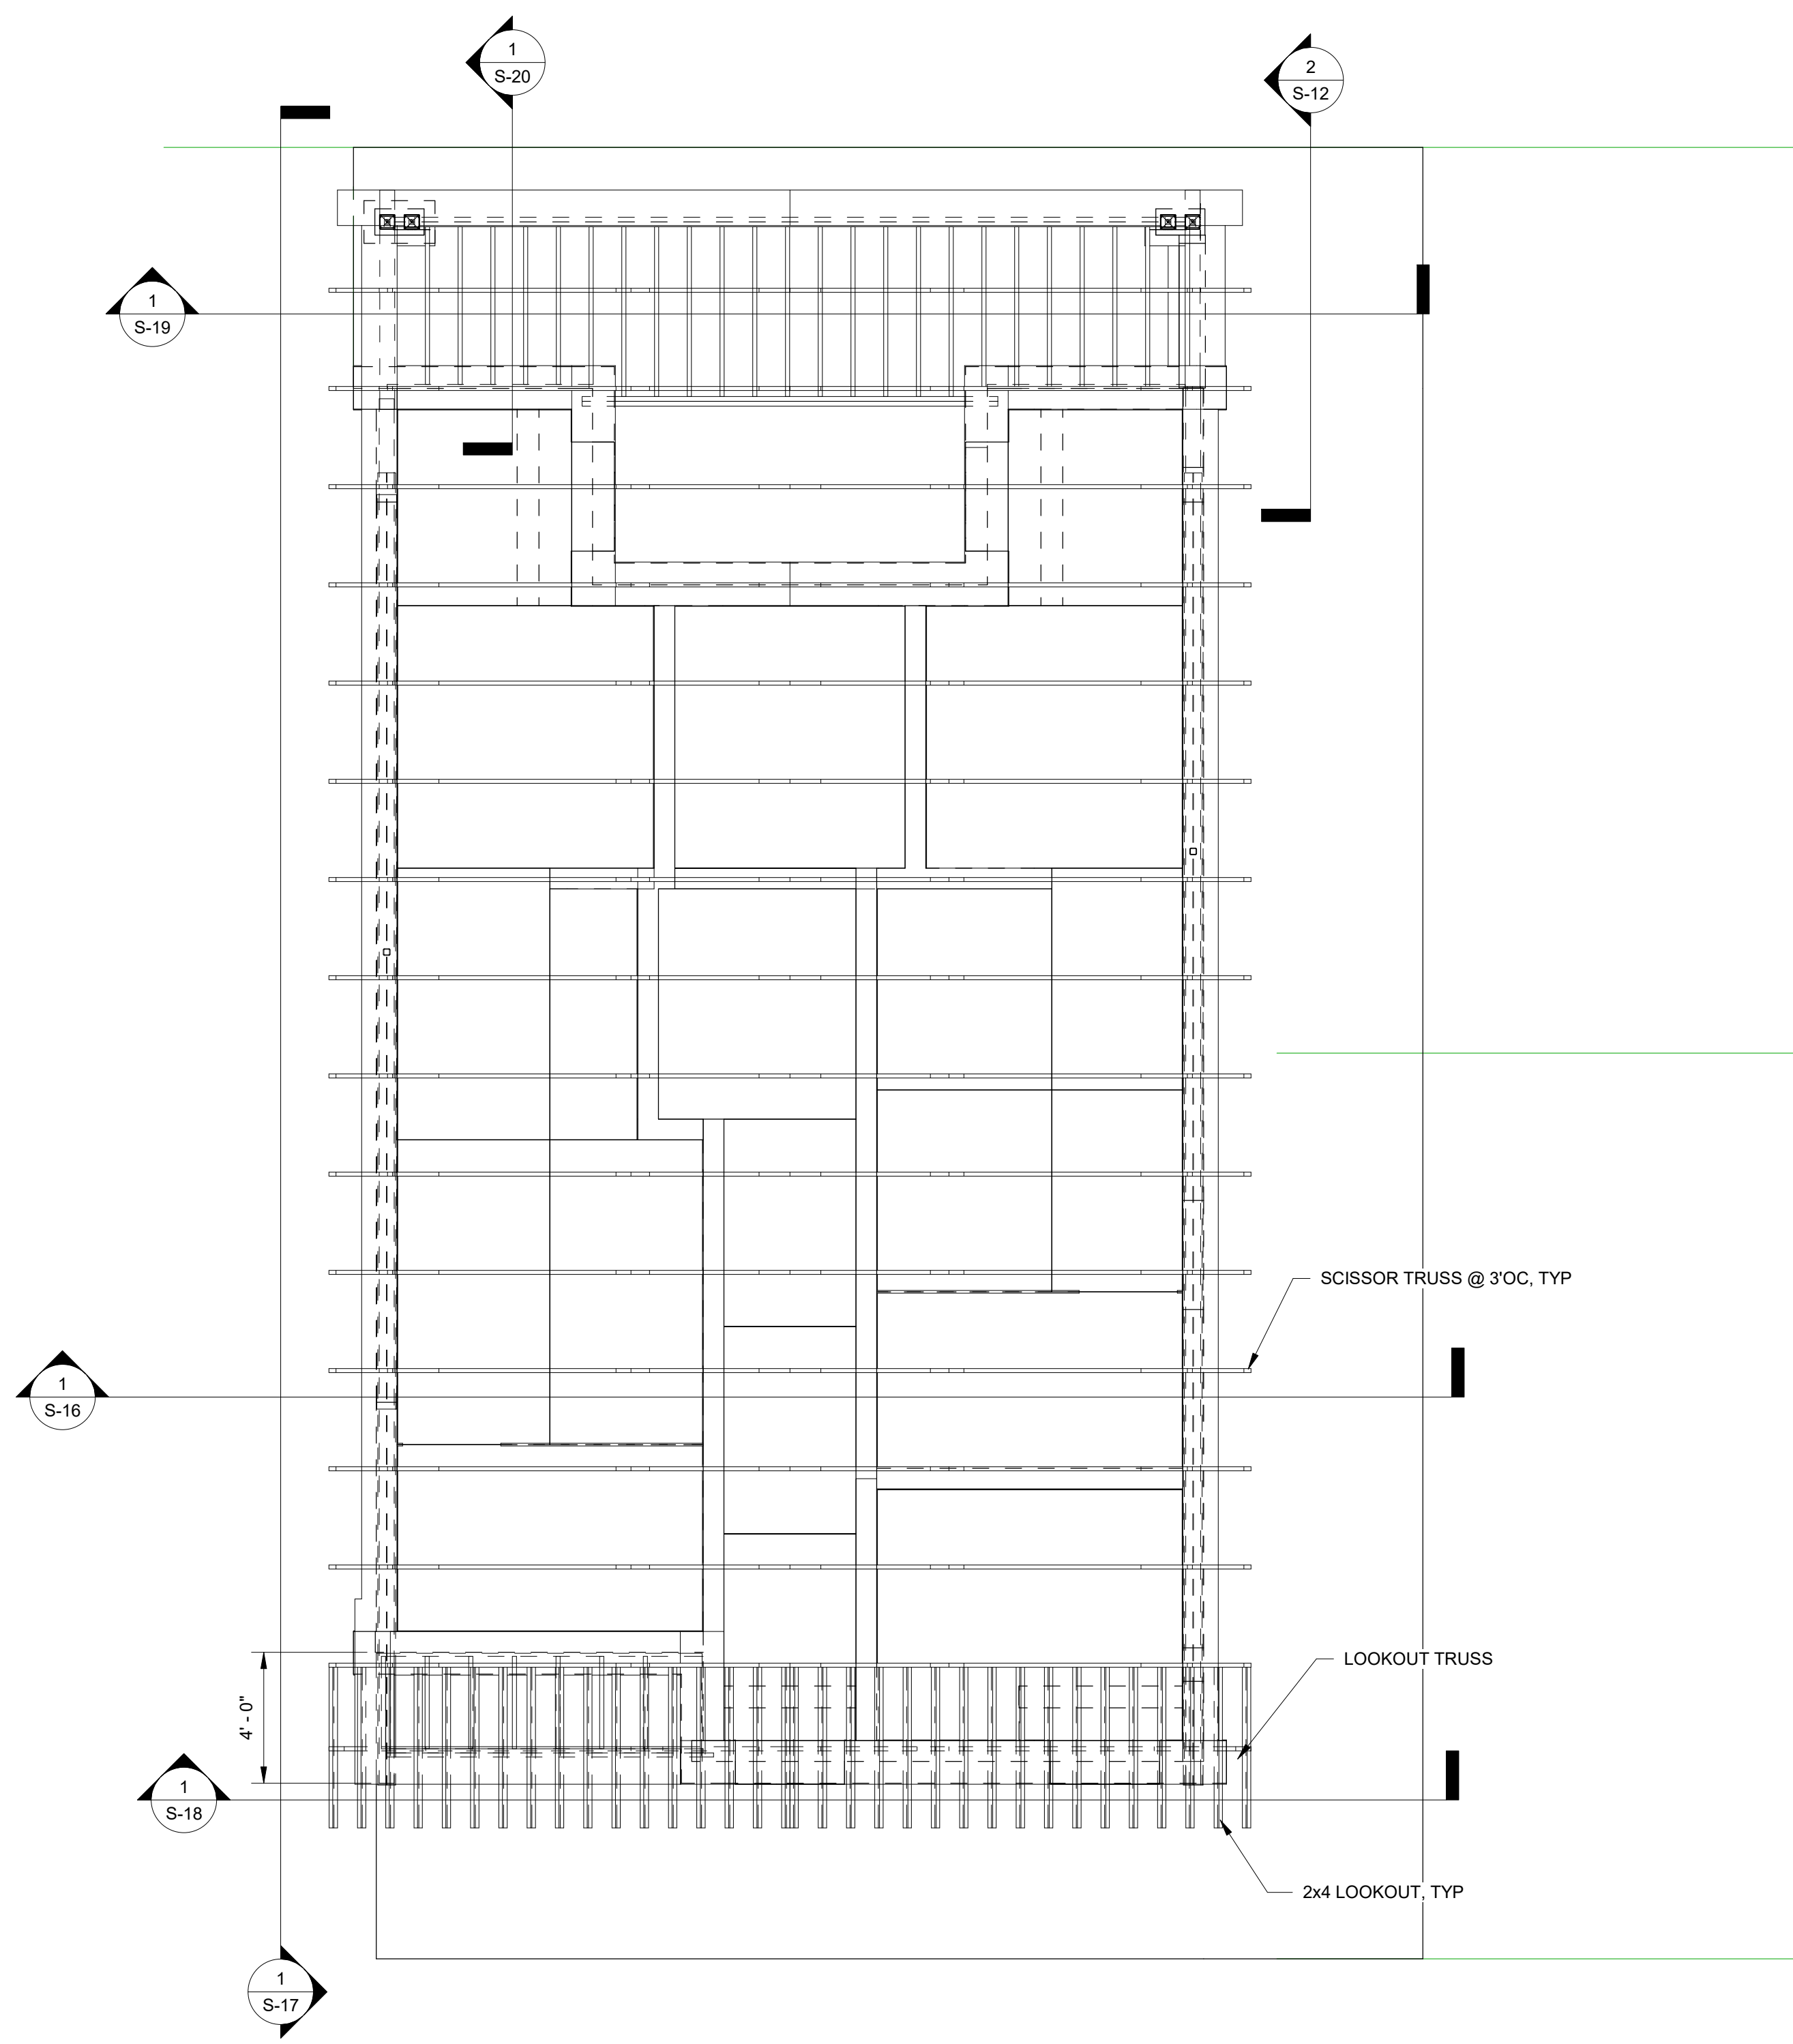

1 Roof - Tent Camp
1/4" = 1'-0"


NOTES:
1. FOR GENERAL NOTES SEE SHEET S-2
2. FOR SYMBOLS AND ABBREVIATIONS SEE SHEET S-1

CONSTRUCTION DOCUMENTS



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D.G.S. PROJECT No.
C-114-0006 PHASE 1


HICKORY RUN STATE PARK
LATRINE IMPROVEMENTS
DEPT of CONSERVATION AND NATURAL RESOURCES
WHITE HAVEN, CARBON COUNTY, PA

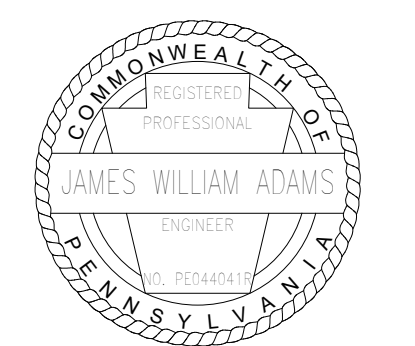TENT CAMP ROOF PLAN

VERIFY SCALE	
BAR IS ONE (1) INCH LONG	ON ORIGINAL DRAWING: 0 1
IF BAR IS NOT ONE (1) INCH LONG, ADJUST SCALE ACCORDINGLY	
CONTRACTOR SHALL FIELD VERIFY ALL DIMENSIONS. VARIANCE FROM CONTRACT DOCUMENTS NOT PERMITTED WITHOUT PROFESSIONAL & BUREAU OF CONSTRUCTION APPROVAL.	

DRAWN BY J ADAMS	DATE 06/17/2022
CHECKED BY J ADAMS	SCALE AS NOTED

DRAWING No.
S-15
96 OF 144

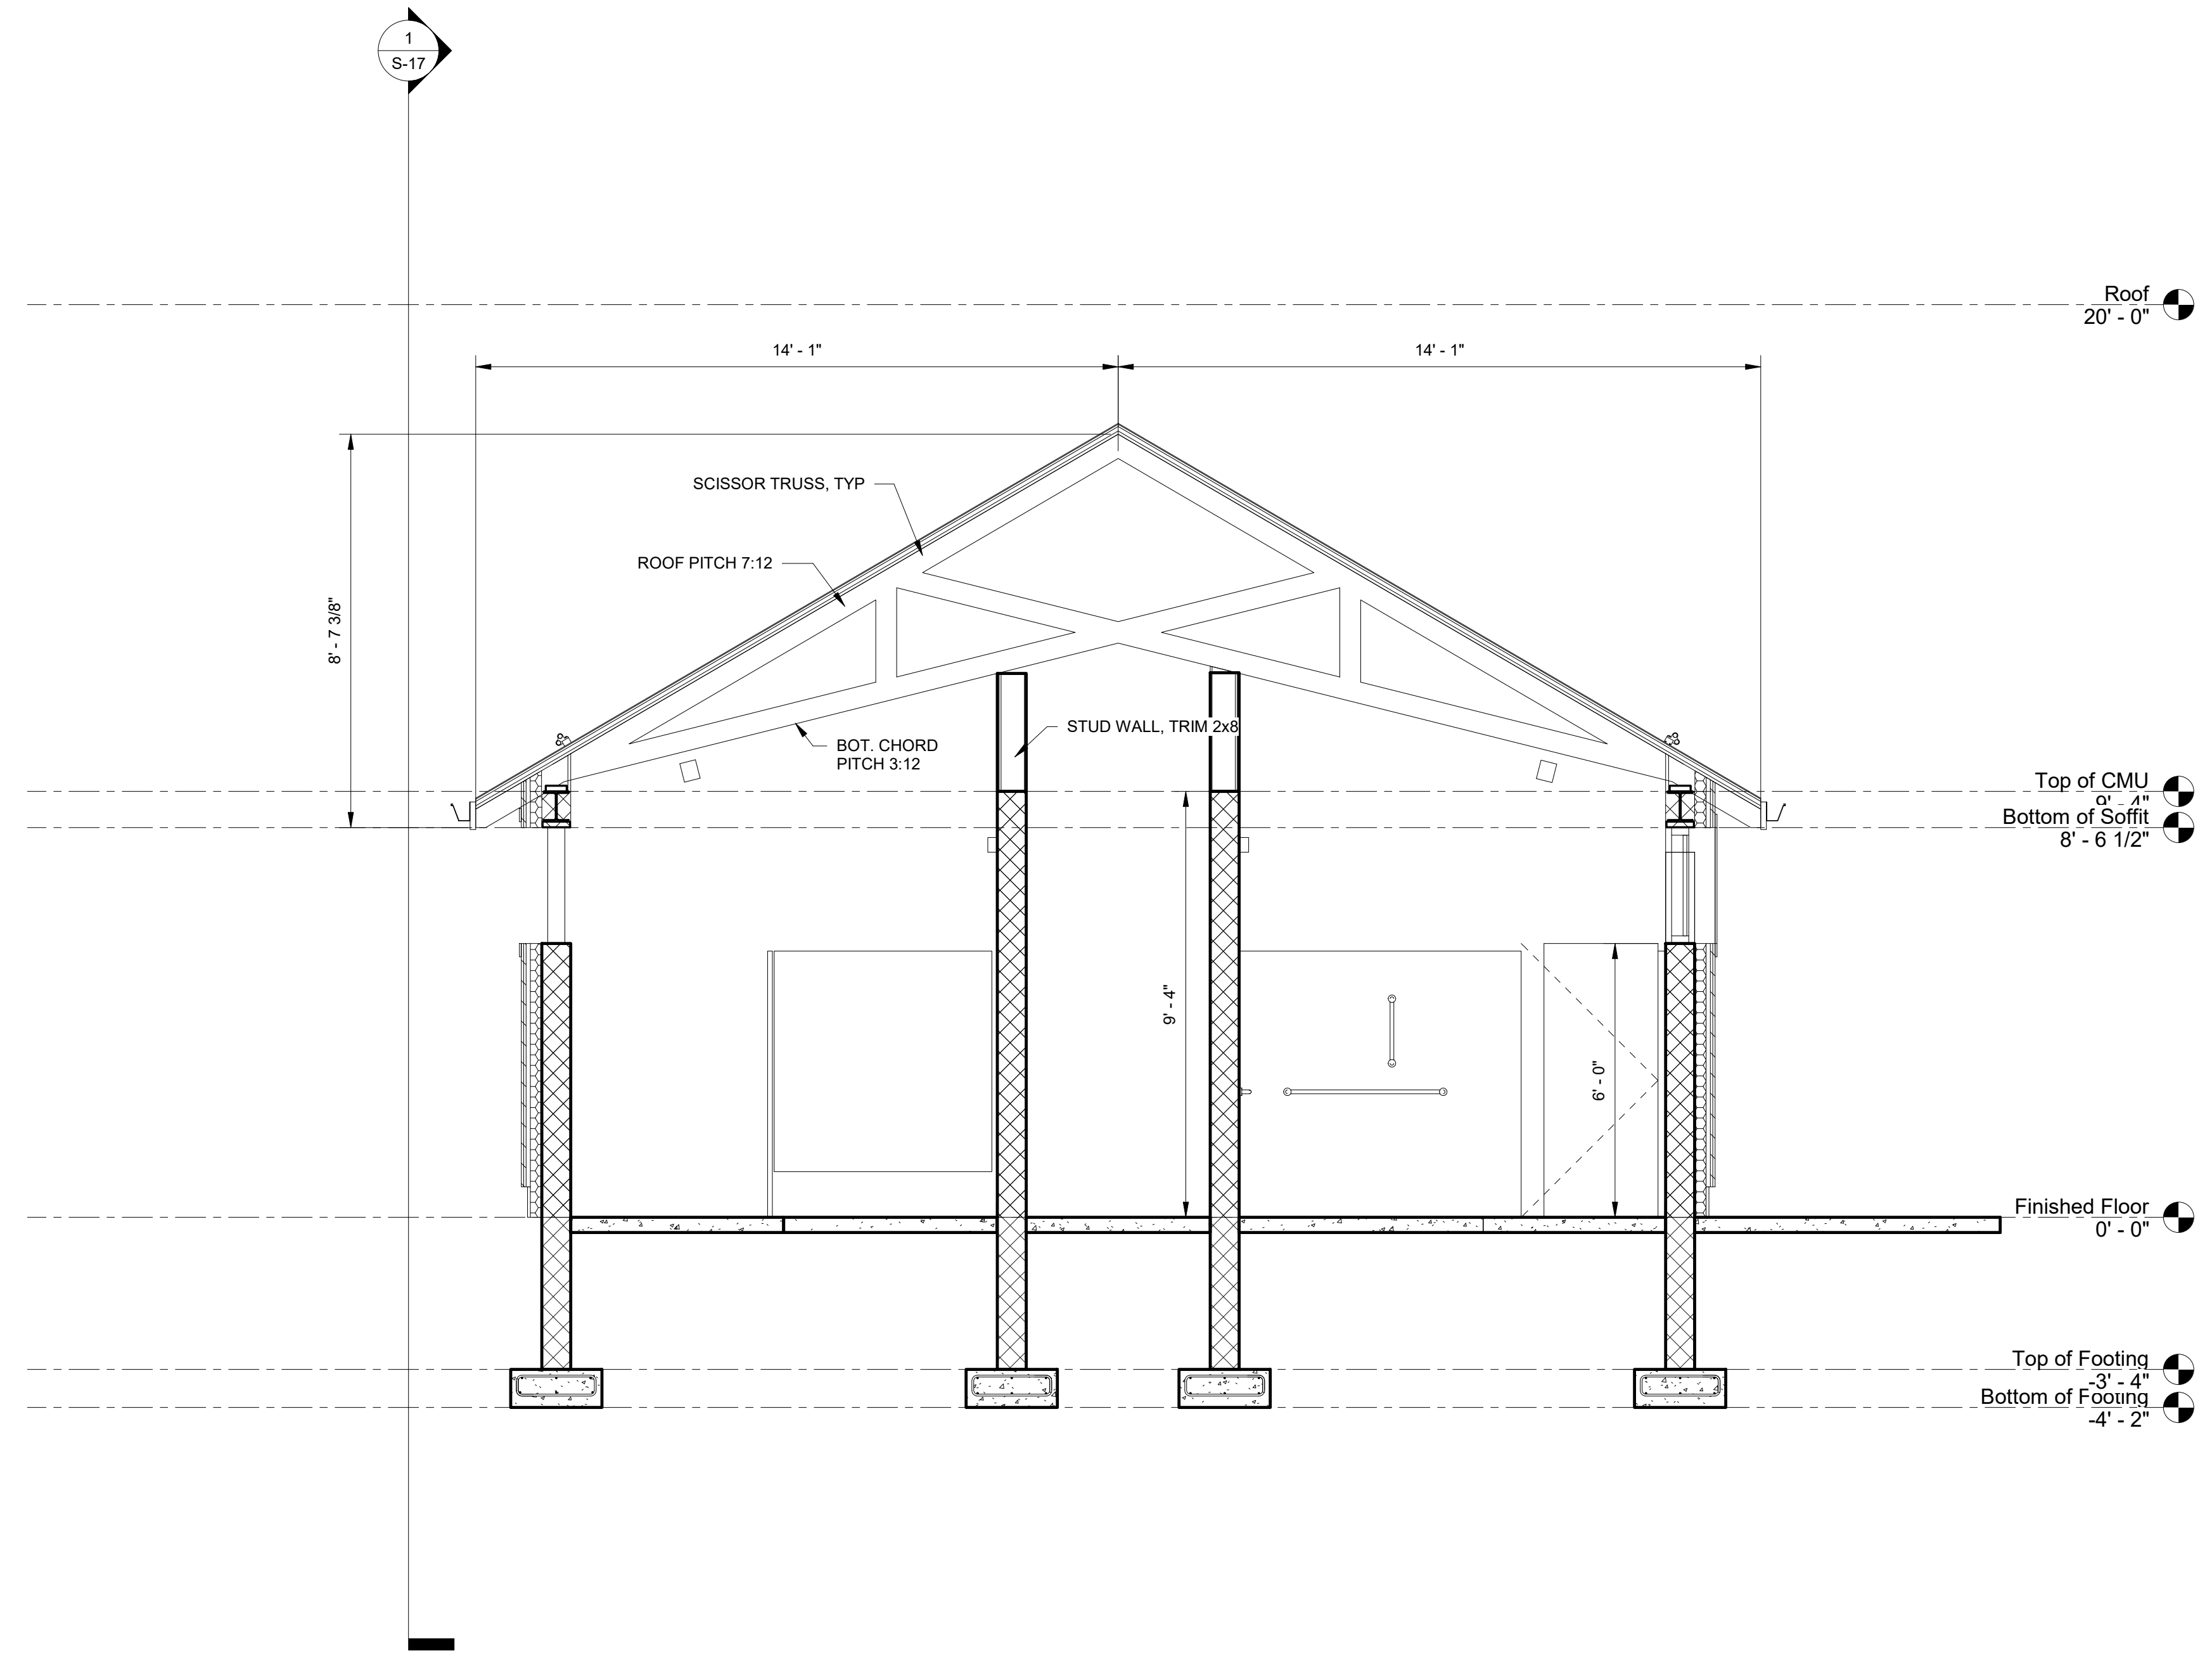

1 Tent Camp Cross Section 1
3/8" = 1'-0"

- NOTES:
1. FOR GENERAL NOTES SEE SHEET S-2
2. FOR SYMBOLS AND ABBREVIATIONS SEE SHEET S-1

VERIFY SCALE

BAR IS ONE (1) INCH LONG
ON ORIGINAL DRAWING: 0 1

IF BAR IS NOT ONE (1) INCH LONG, ADJUST SCALE ACCORDINGLY

CONTRACTOR SHALL FIELD VERIFY ALL DIMENSIONS
VARIANCE FROM CONTRACT DOCUMENTS NOT PERMITTED WITHOUT PROFESSIONAL & BUREAU OF CONSTRUCTION APPROVAL.

DRAWN BY: J ADAMS
CHECKED BY: J ADAMS

DATE: 06/17/2022
SCALE: AS NOTED

DRAWING No. S-16
97 OF 144

CONSTRUCTION DOCUMENTS

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James W. Adams 11/19/2021
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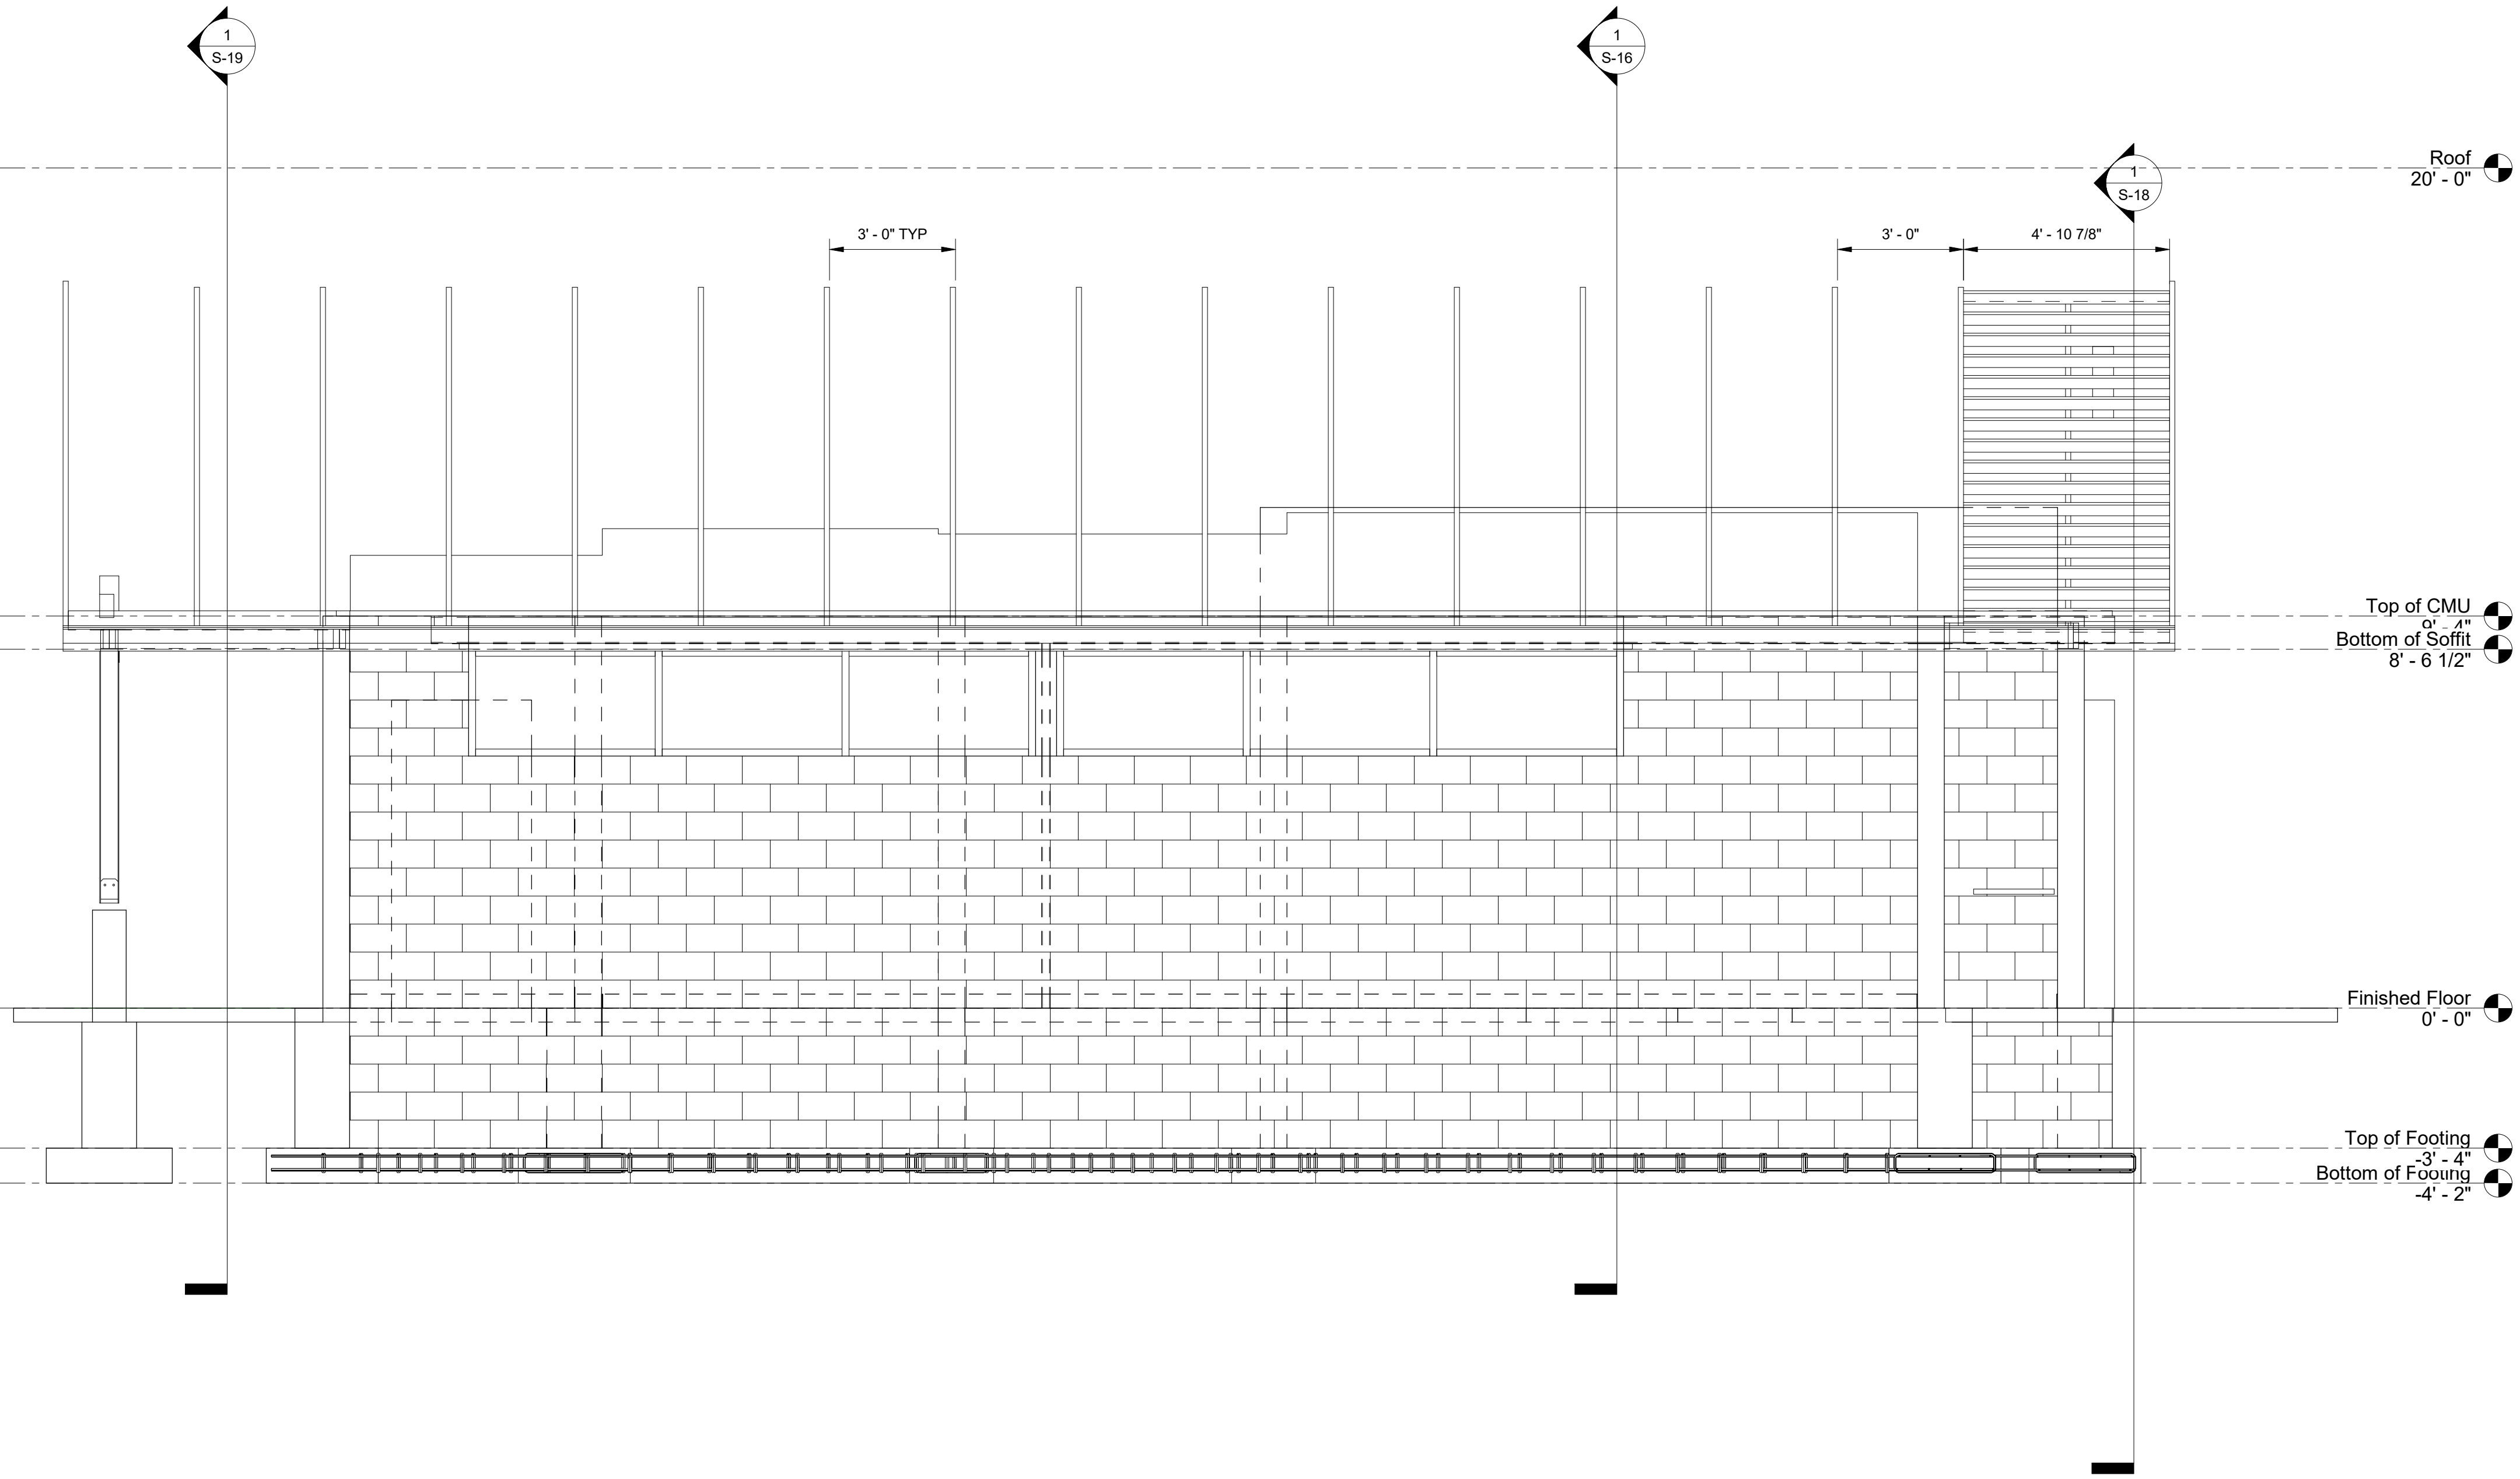
SMP ARCHITECTS
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COMMONWEALTH OF PENNSYLVANIA
DEPARTMENT OF GENERAL SERVICES
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D.G.S. PROJECT No.
C-114-0006 PHASE 1

HICKORY RUN STATE PARK
LATRINE IMPROVEMENTS
DEPT of CONSERVATION AND NATURAL RESOURCES
WHITE HAVEN, CARBON COUNTY, PA

TENT CAMP SECTIONS, SHEET 1




1 Tent Camp Cross Section 2
3/8" = 1'-0"

CONSTRUCTION DOCUMENTS



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SIGNATURE DATE 11/19/2021
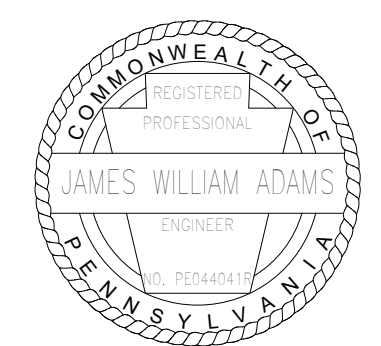
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C-114-0006 PHASE 1

HICKORY RUN STATE PARK
LATRINE IMPROVEMENTS
DEPT of CONSERVATION AND NATURAL RESOURCES
WHITE HAVEN, CARBON COUNTY, PA

TENT CAMP SECTIONS, SHEET 2

VERIFY SCALE
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ON ORIGINAL DRAWING: 0 1
IF BAR IS NOT ONE (1) INCH LONG, ADJUST SCALE ACCORDINGLY


CONTRACTOR SHALL FIELD VERIFY ALL DIMENSIONS
VARIANCE FROM CONTRACT DOCUMENTS NOT PERMITTED WITHOUT PROFESSIONAL & BUREAU OF CONSTRUCTION APPROVAL.

DRAWN BY J ADAMS	DATE 06/17/2022
CHECKED BY J ADAMS	SCALE AS NOTED

DRAWING No.
S-17
98 OF 144

NOTES:
1. FOR GENERAL NOTES SEE SHEET S-2
2. FOR SYMBOLS AND ABBREVIATIONS SEE SHEET S-1

1
S-17

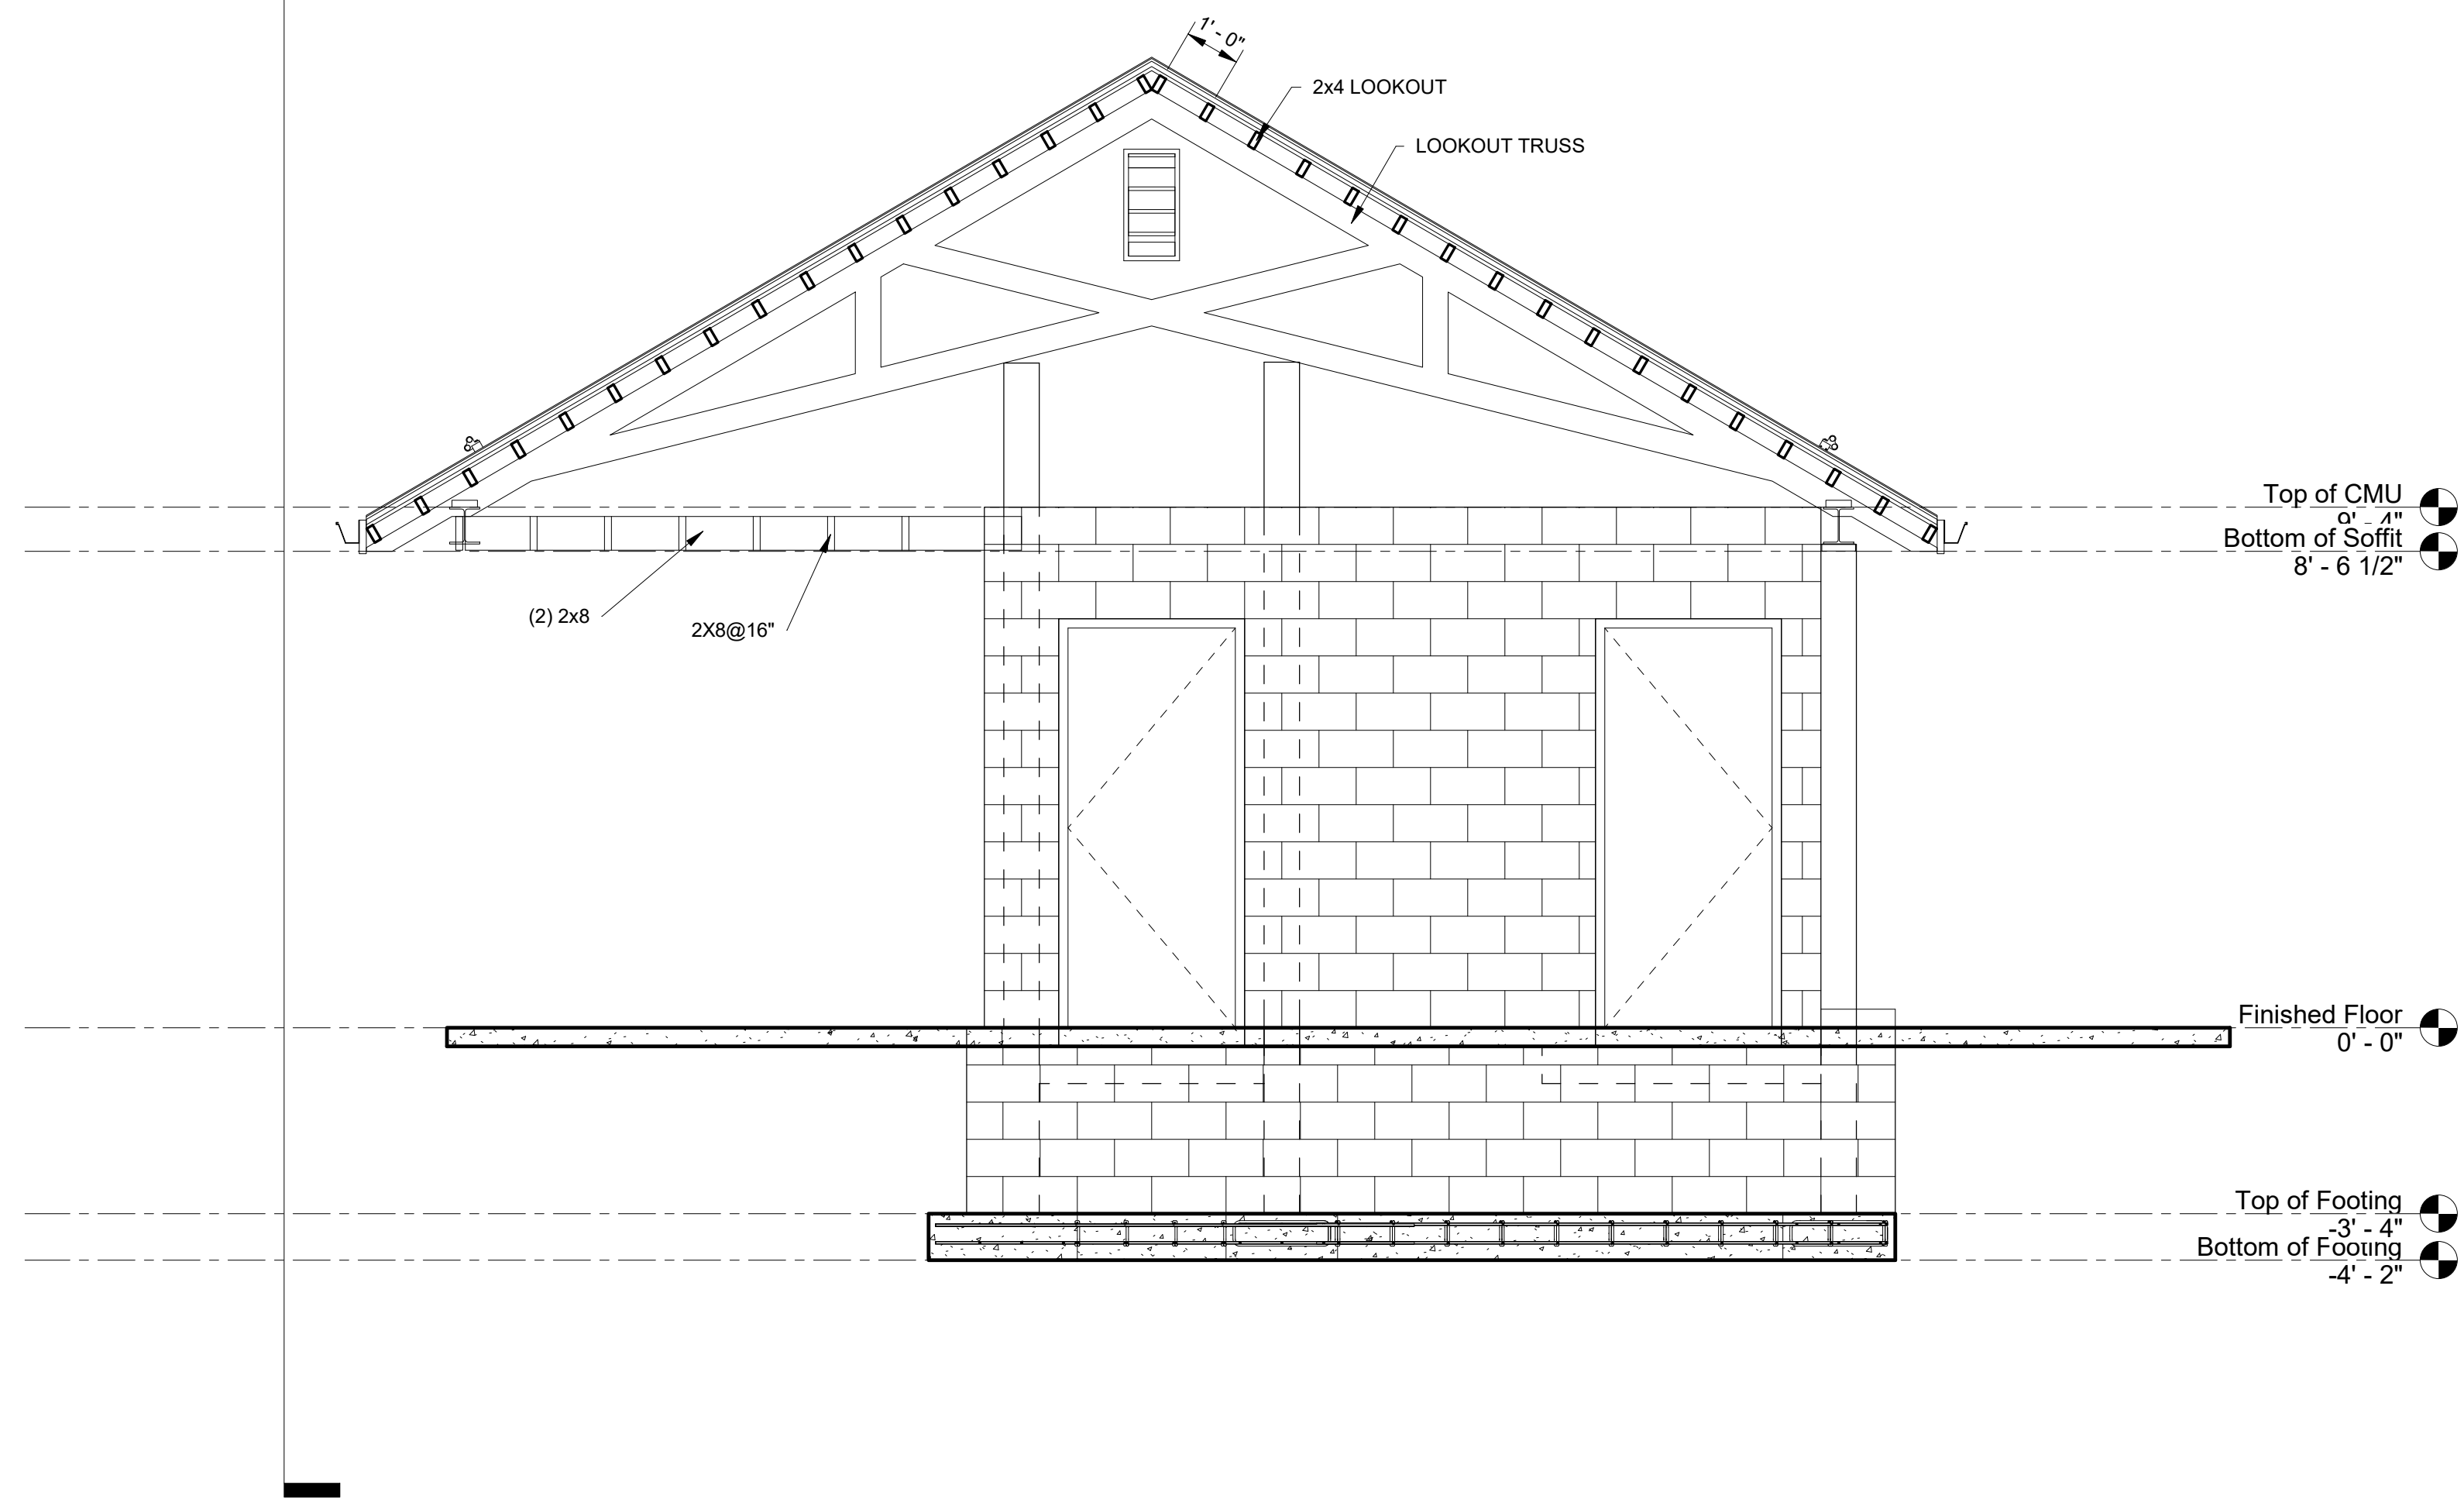


1 Tent Camp Lookouts
3/8" = 1'-0"

CONSTRUCTION DOCUMENTS



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James W. Adams
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D.G.S. PROJECT No.
C-114-0006 PHASE 1

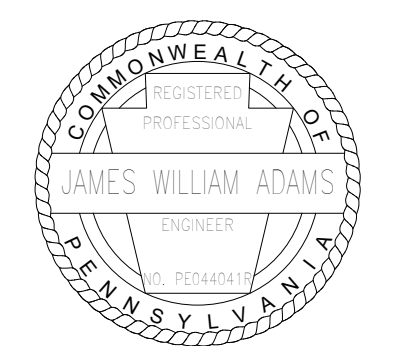HICKORY RUN STATE PARK
LATRINE IMPROVEMENTS
DEPT of CONSERVATION AND NATURAL RESOURCES
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TENT CAMP SECTIONS, SHEET 3


VERIFY SCALE
BAR IS ONE (1) INCH LONG
ON ORIGINAL DRAWING: 0 1
IF BAR IS NOT ONE (1) INCH LONG, ADJUST SCALE ACCORDINGLY

CONTRACTOR SHALL FIELD VERIFY ALL DIMENSIONS. VARIANCE FROM CONTRACT DOCUMENTS NOT PERMITTED WITHOUT PROFESSIONAL & BUREAU OF CONSTRUCTION APPROVAL.


DRAWN BY J ADAMS	DATE 06/17/2022
CHECKED BY J ADAMS	SCALE AS NOTED

DRAWING No.
S-18
99 OF 144

NOTES:
1. FOR GENERAL NOTES SEE SHEET S-2
2. FOR SYMBOLS AND ABBREVIATIONS SEE SHEET S-1

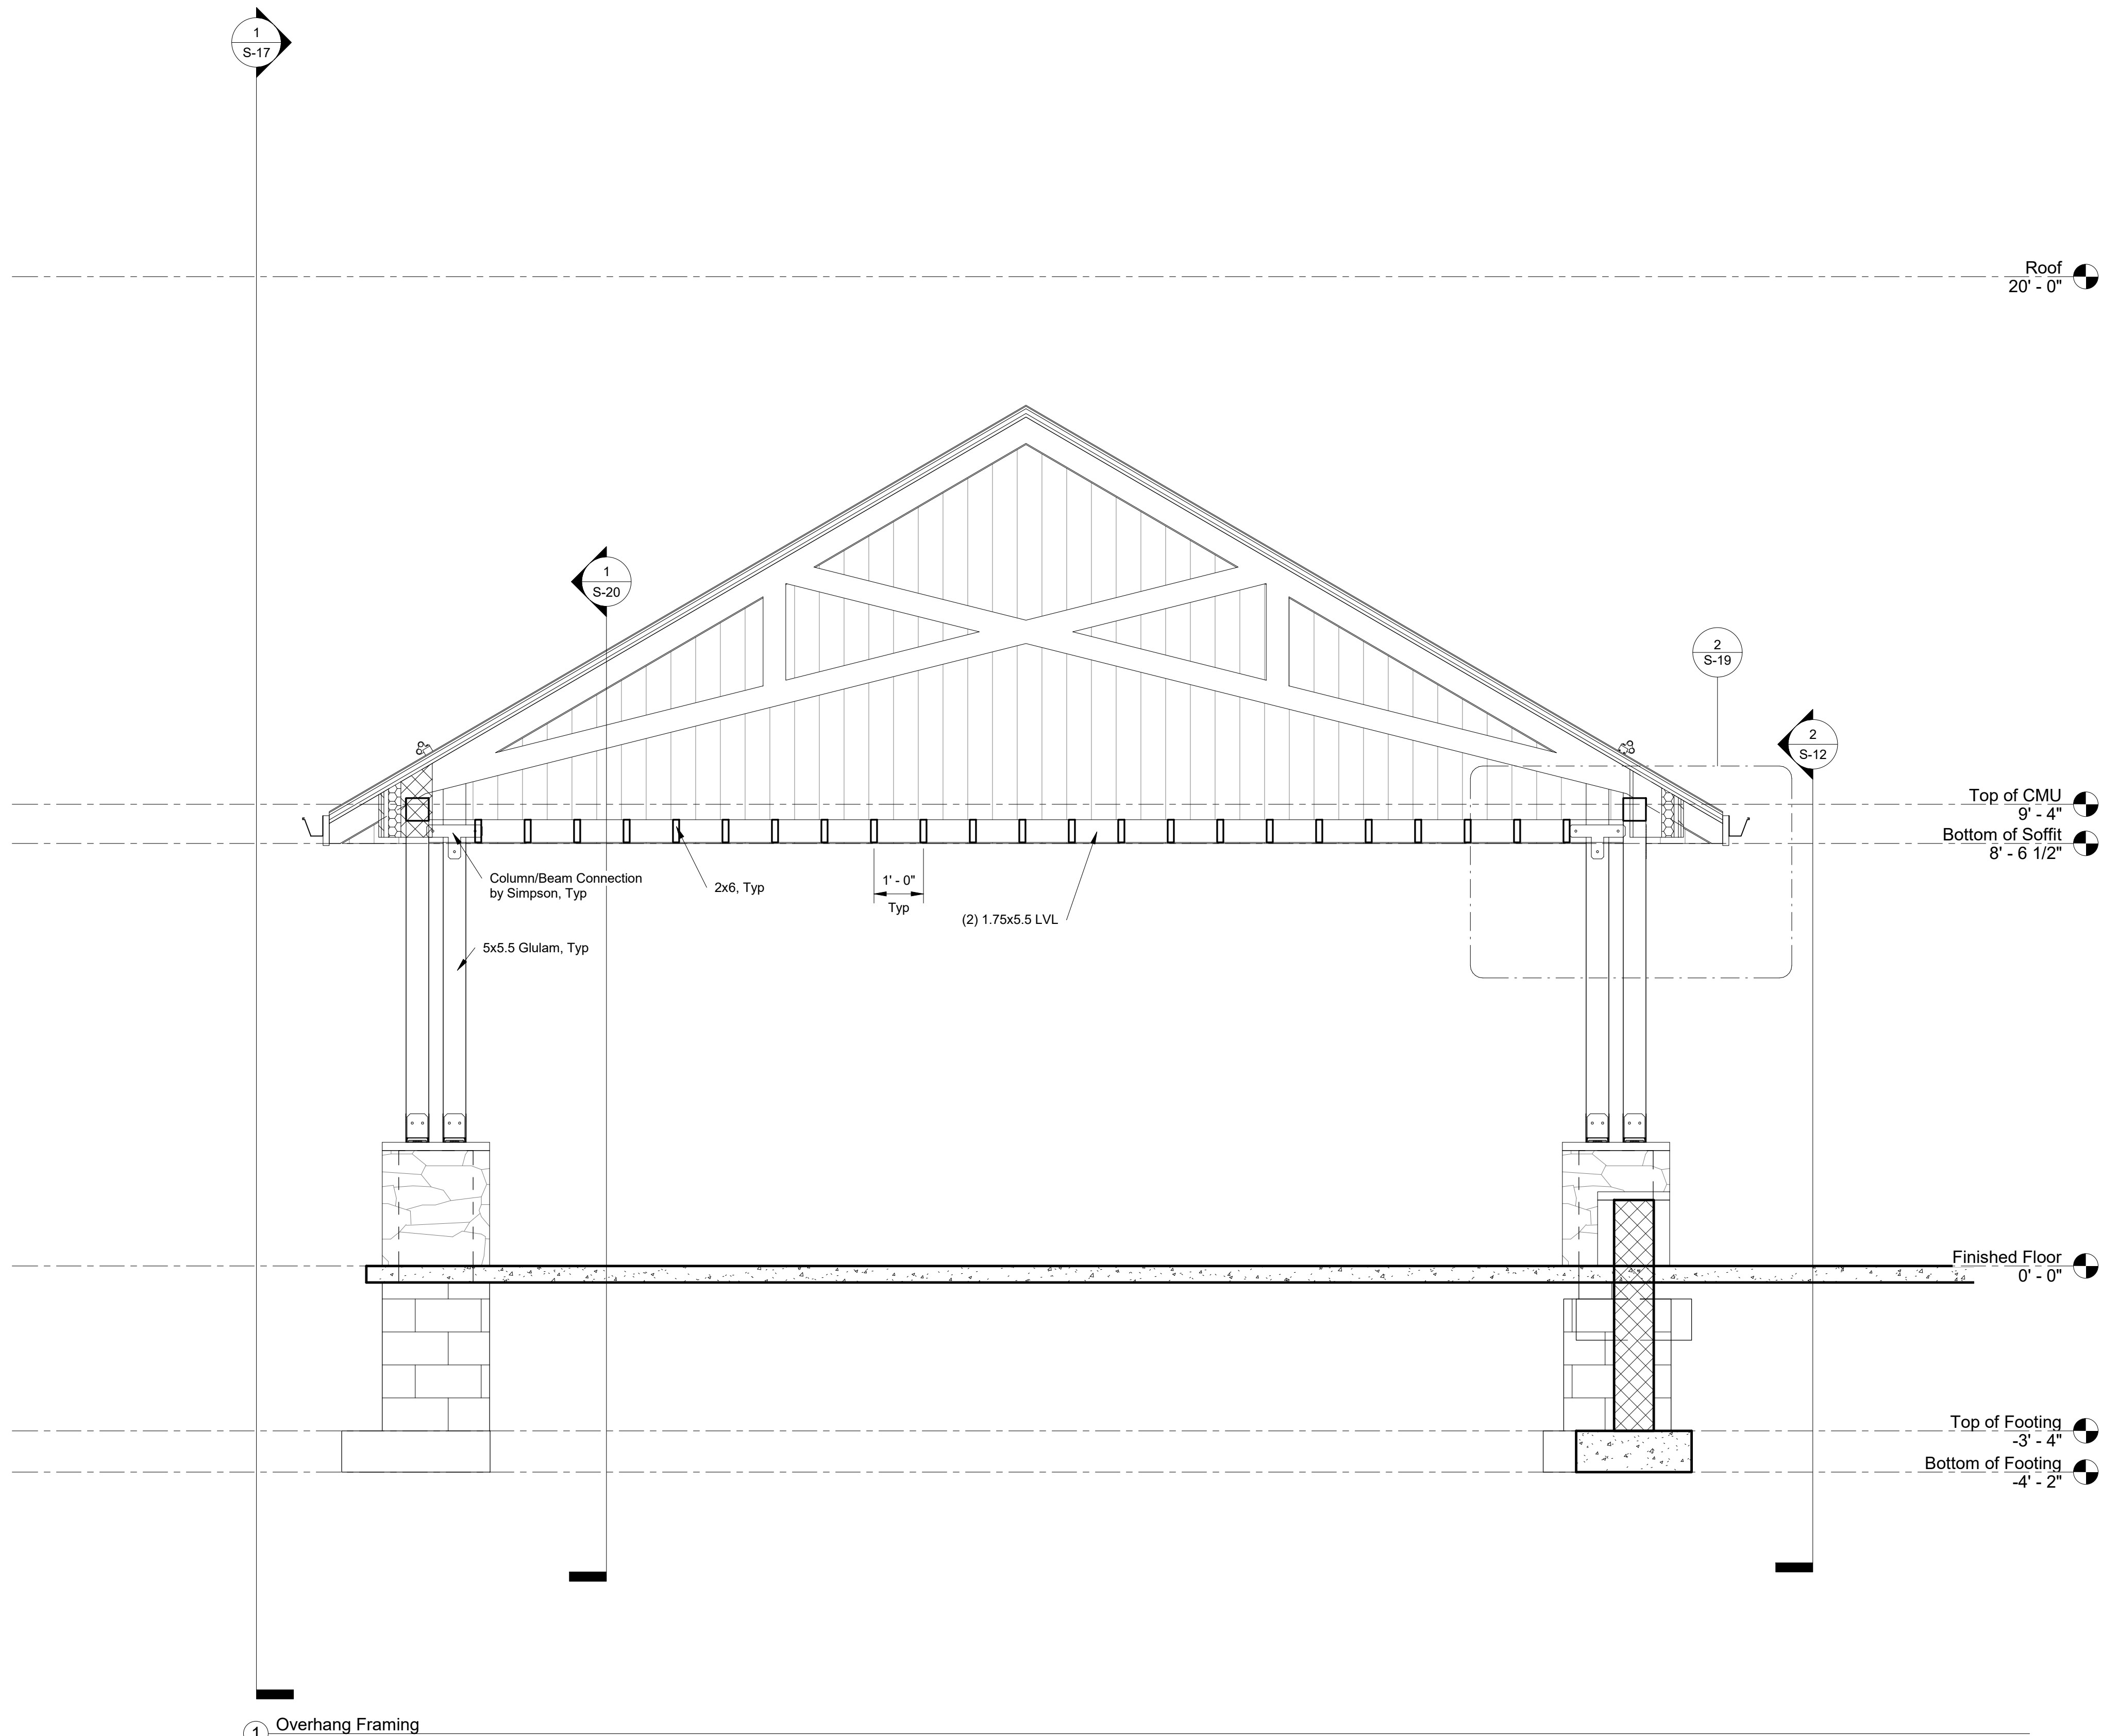

1 Overhang Framing
1/2" = 1'-0"

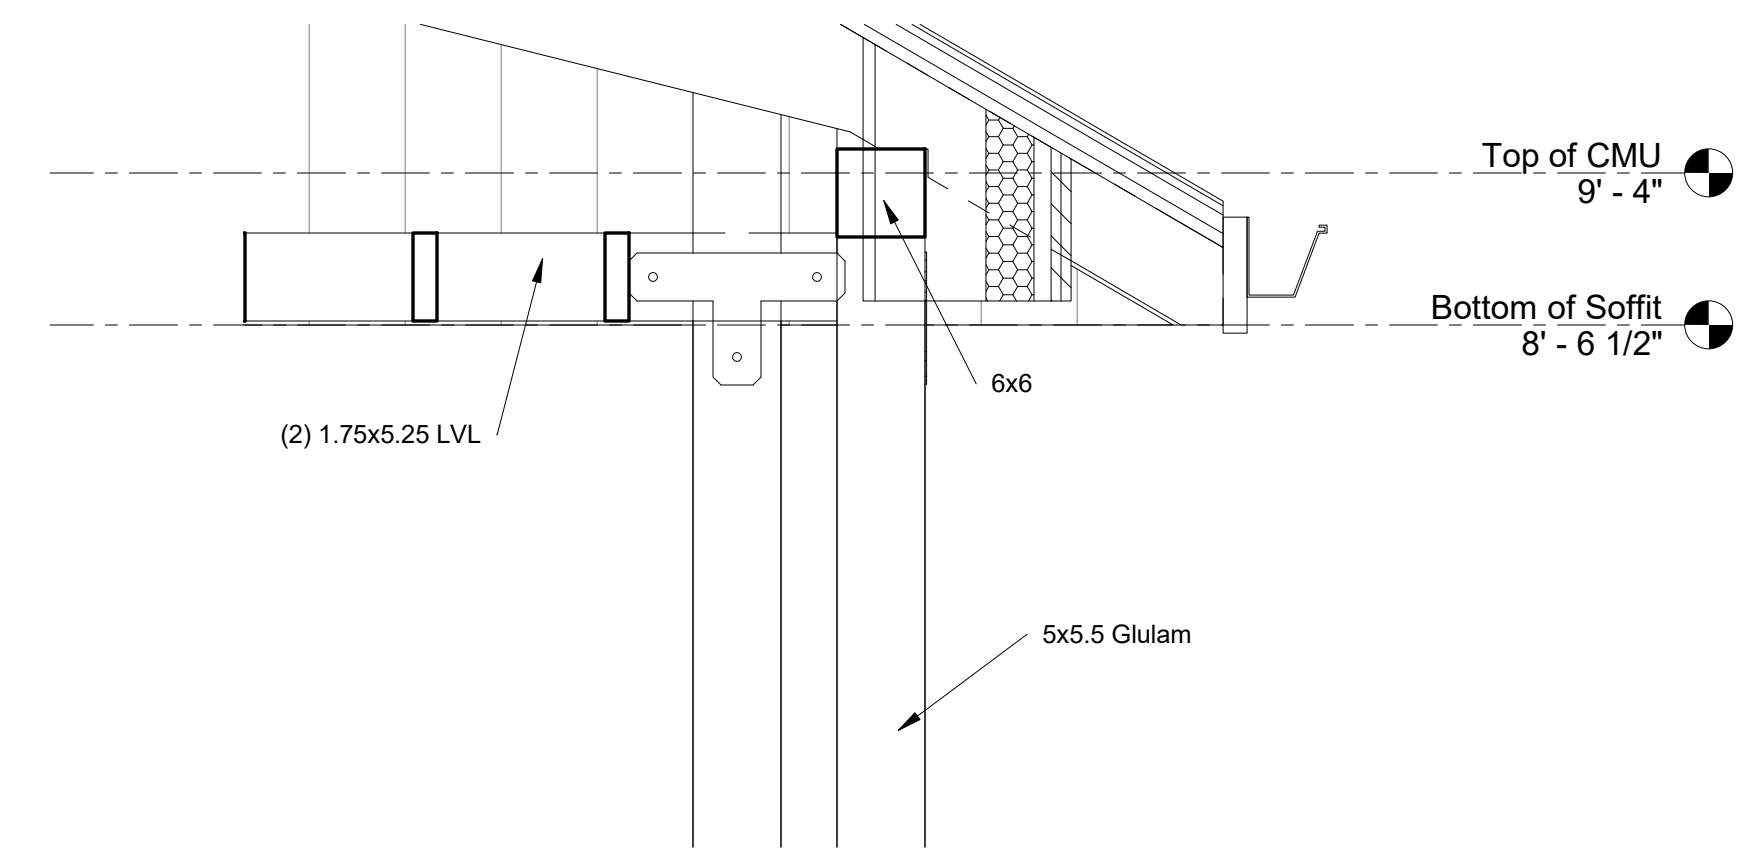

2 Section 29 - Callout 1
1" = 1'-0"

CONSTRUCTION DOCUMENTS



NO.	REVISION	DATE

2 S-12

James W. Adams
SIGNATURE

11/19/2021
DATE

SMP ARCHITECTS
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PHILADELPHIA, PENNSYLVANIA

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DEPARTMENT OF GENERAL SERVICES
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C-114-0006 PHASE 1

HICKORY RUN STATE PARK
LATRINE IMPROVEMENTS

DEPT of CONSERVATION AND NATURAL RESOURCES
WHITE HAVEN, CARBON COUNTY, PA

TENT CAMP DETAILS, SHEET 1

VERIFY SCALE


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ON ORIGINAL DRAWING: 0 1

IF BAR IS NOT ONE (1) INCH LONG, ADJUST SCALE ACCORDINGLY


CONTRACTOR SHALL FIELD VERIFY ALL DIMENSIONS. VARIANCE FROM CONTRACT DOCUMENTS NOT PERMITTED WITHOUT PROFESSIONAL & BUREAU OF CONSTRUCTION APPROVAL.

DRAWN BY J ADAMS	DATE 06/17/2022	DRAWING No. S-19
CHECKED BY J ADAMS	SCALE AS NOTED	100 OF 144

NOTES:
1. FOR GENERAL NOTES SEE SHEET S-2
2. FOR SYMBOLS AND ABBREVIATIONS SEE SHEET S-1

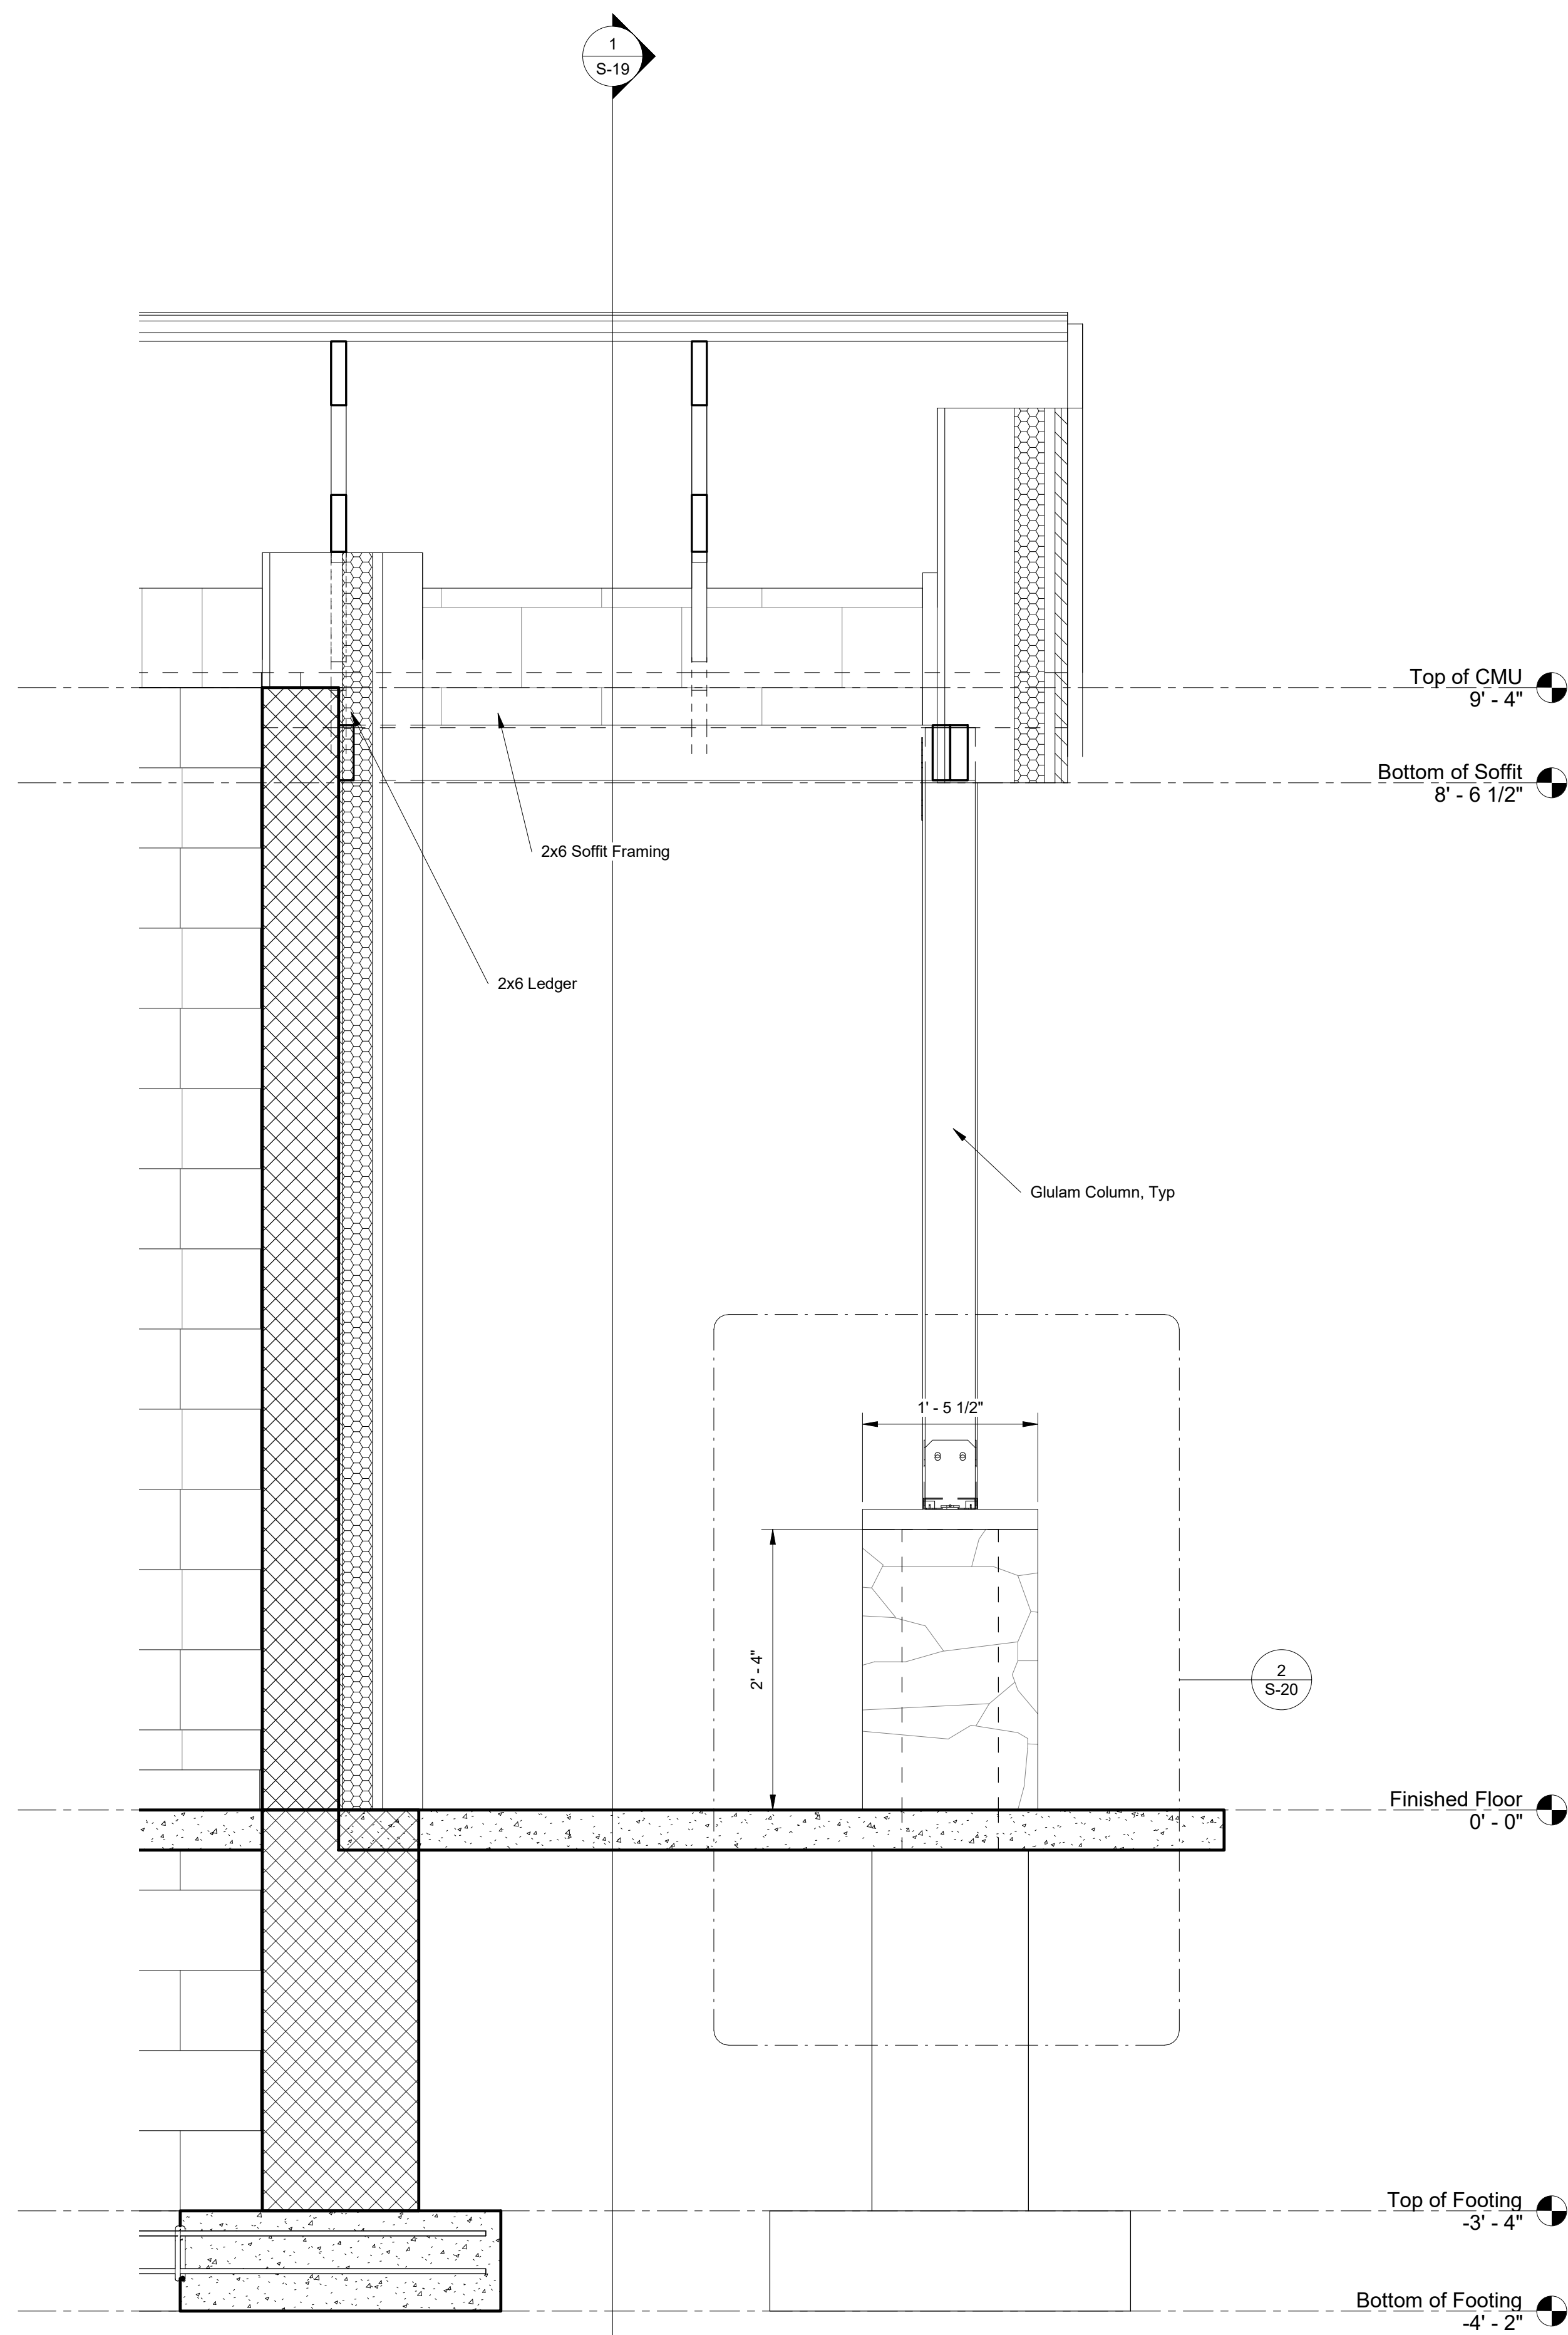

1 Overhang Section
1" = 1'-0"

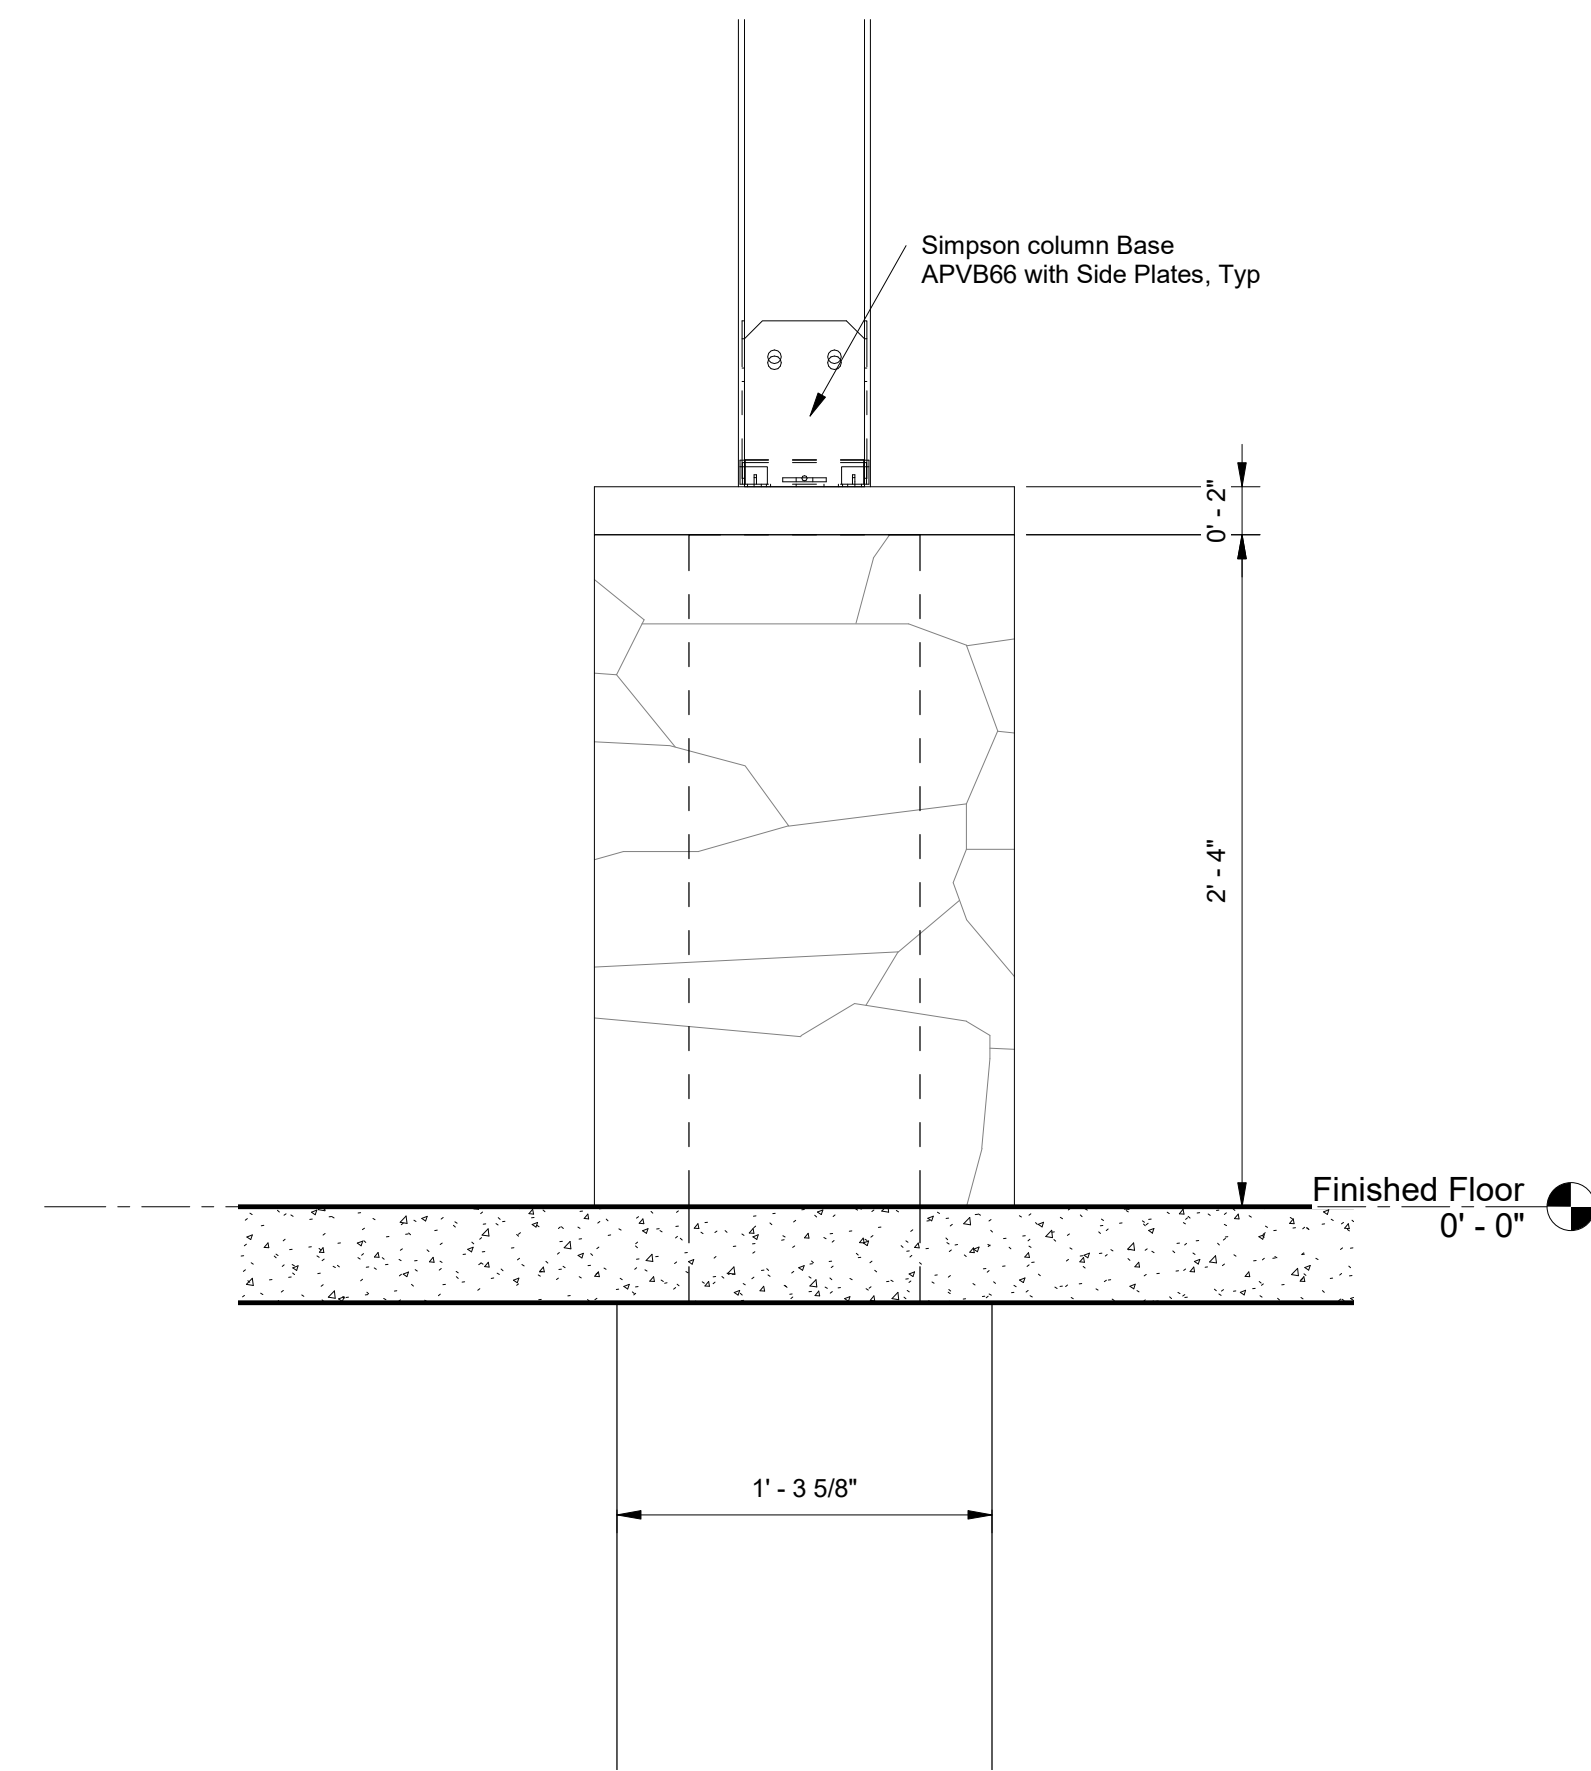


2 Section 28 - Callout 1
1 1/2" = 1'-0"

- NOTES:
 1. FOR GENERAL NOTES SEE SHEET S-2
 2. FOR SYMBOLS AND ABBREVIATIONS SEE SHEET S-1

CONSTRUCTION DOCUMENTS



RECORD REVISIONS

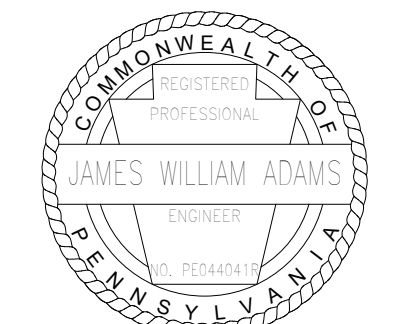

James W. Adams
 SIGNATURE DATE 11/19/2021

SMP ARCHITECTS
 1600 WALNUT STREET, SECOND FLOOR
 PHILADELPHIA, PENNSYLVANIA

COMMONWEALTH OF PENNSYLVANIA
 DEPARTMENT OF GENERAL SERVICES
 HARRISBURG, PENNSYLVANIA

D.G.S. PROJECT No.
 C-114-0006 PHASE 1

HICKORY RUN STATE PARK
LATRINE IMPROVEMENTS
 DEPT of CONSERVATION AND NATURAL RESOURCES
 WHITE HAVEN, CARBON COUNTY, PA


TENT CAMP DETAILS, SHEET 2

VERIFY SCALE	
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IF BAR IS NOT ONE (1) INCH LONG, ADJUST SCALE ACCORDINGLY	
CONTRACTOR SHALL FIELD VERIFY ALL DIMENSIONS. VARIANCE FROM CONTRACT DOCUMENTS NOT PERMITTED WITHOUT PROFESSIONAL & BUREAU OF CONSTRUCTION APPROVAL.	


DRAWN BY J ADAMS	DATE 06/17/2022
CHECKED BY J ADAMS	SCALE AS NOTED

DRAWING No. S-20

DADDY ALLEN-Bid 3
SHEHAQUA-Bid 2

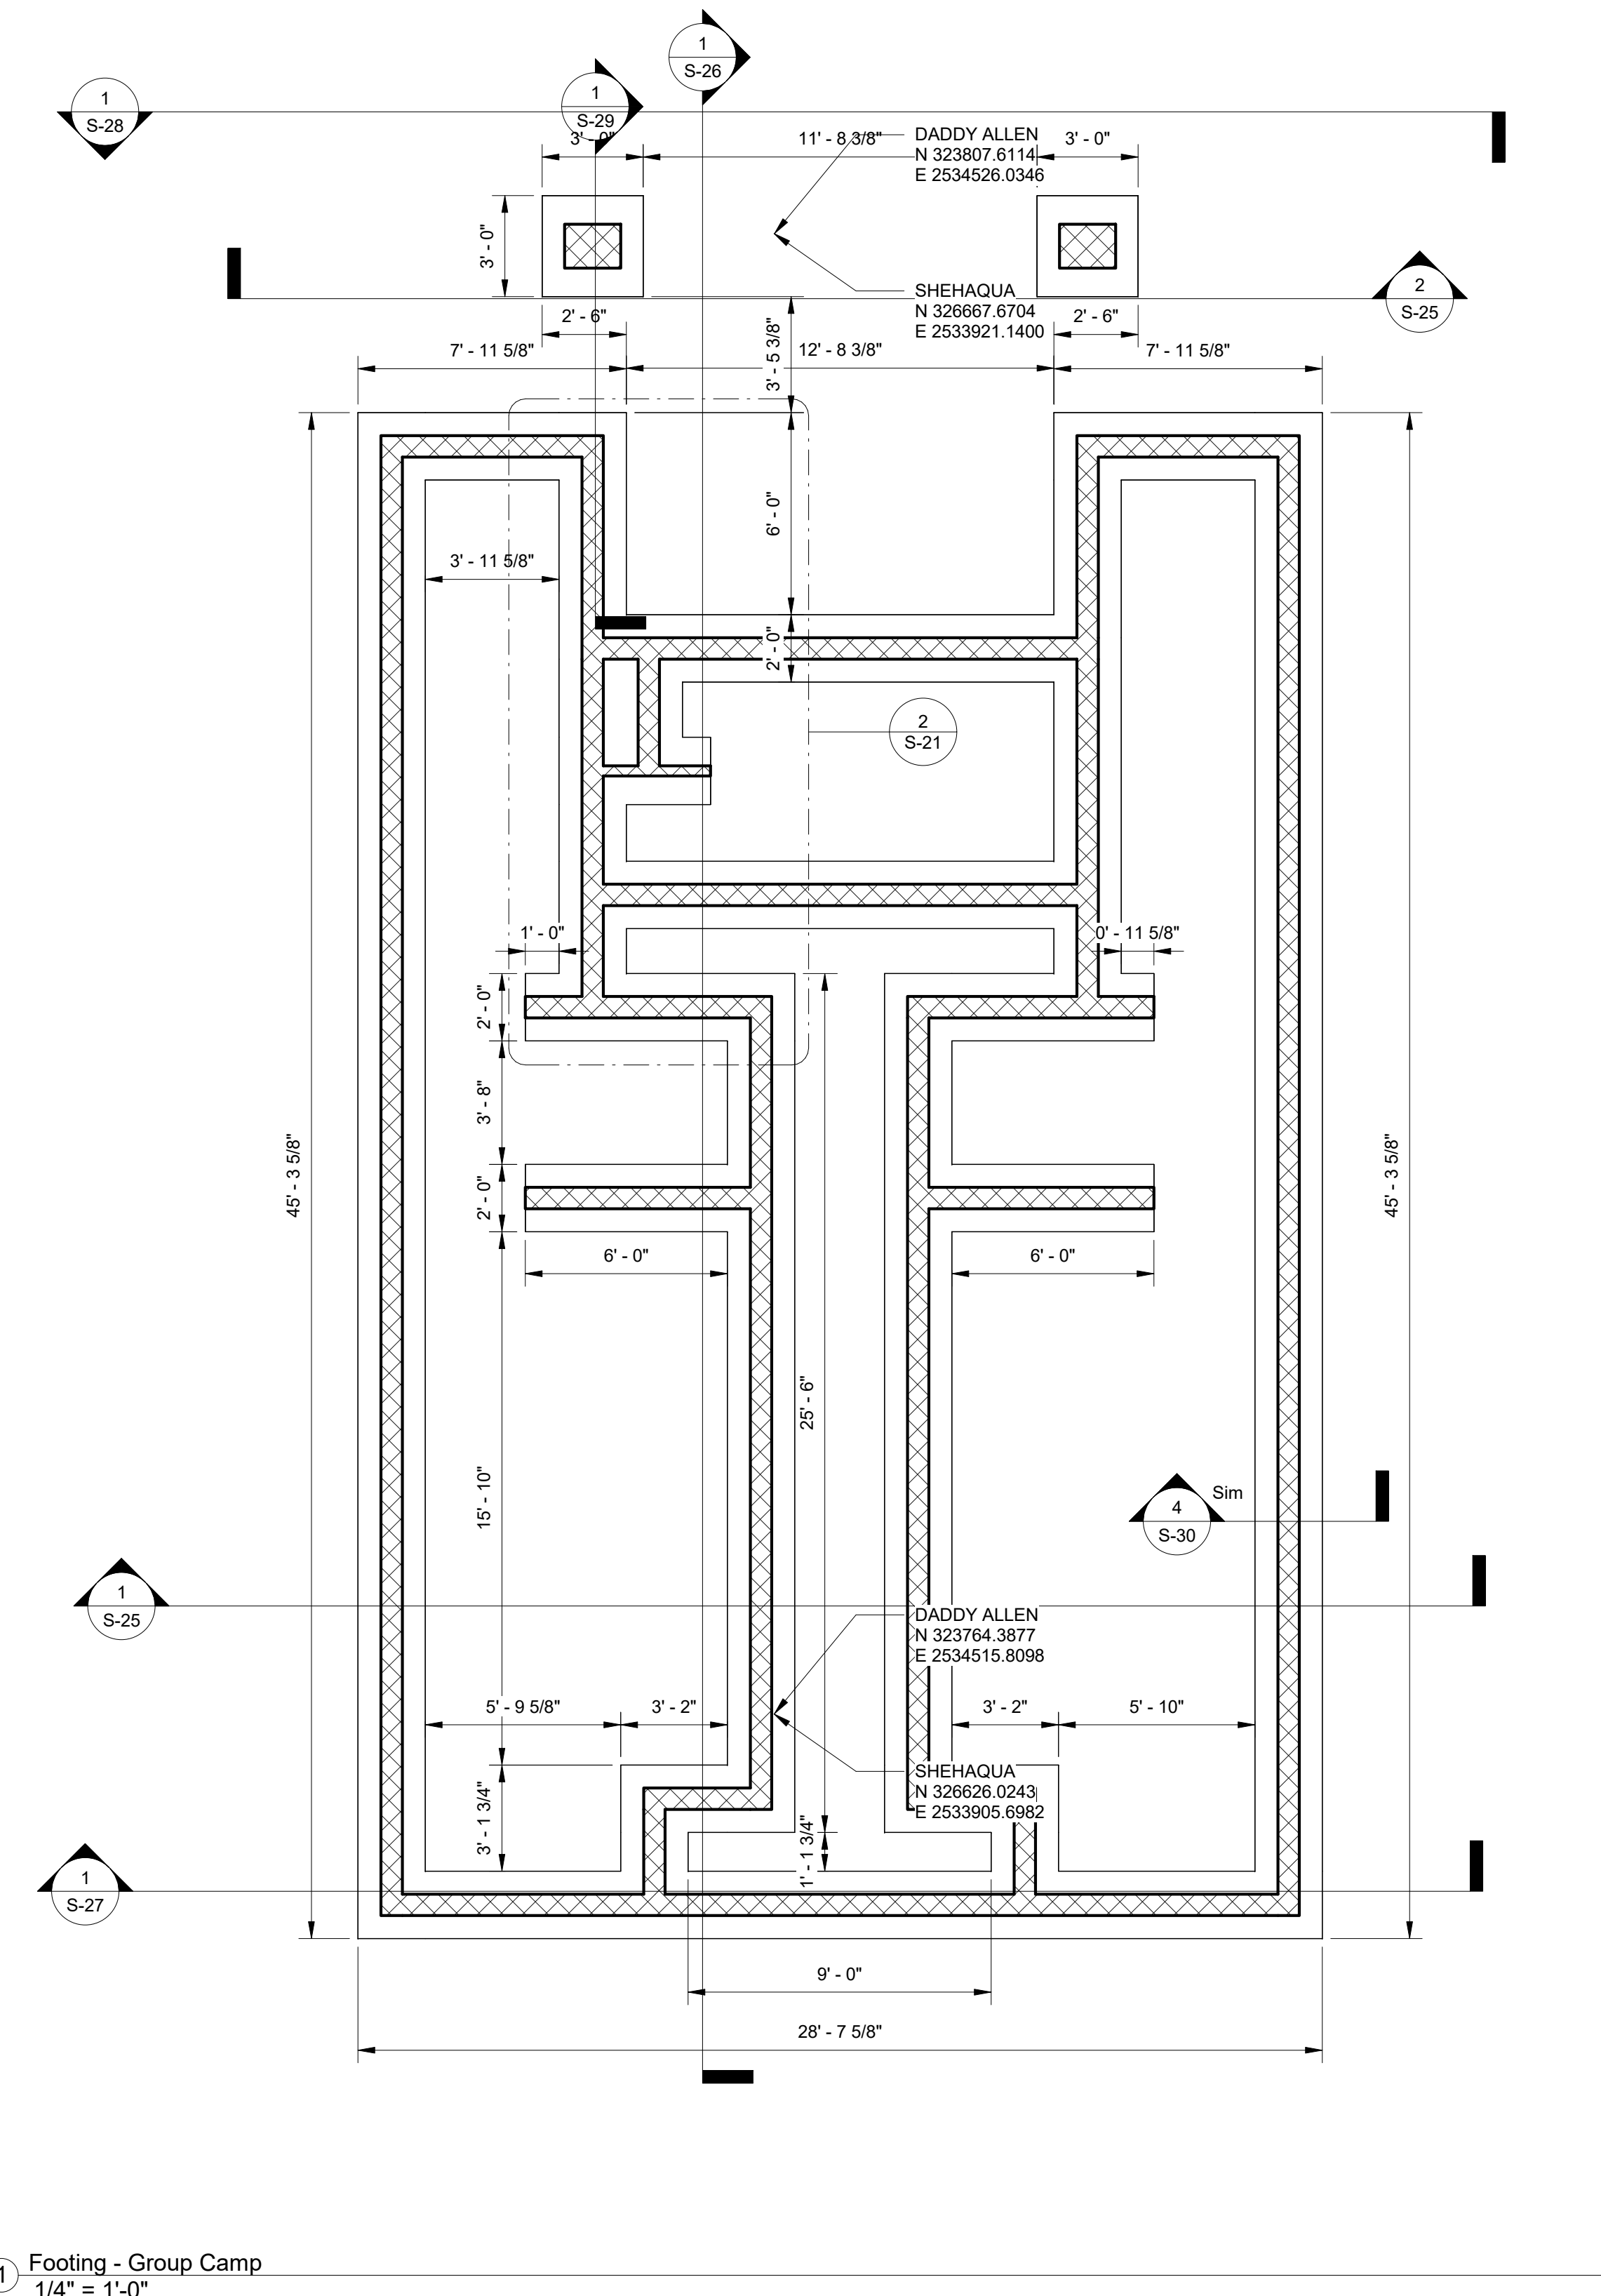

1 Footing - Group Camp
1/4" = 1'-0"

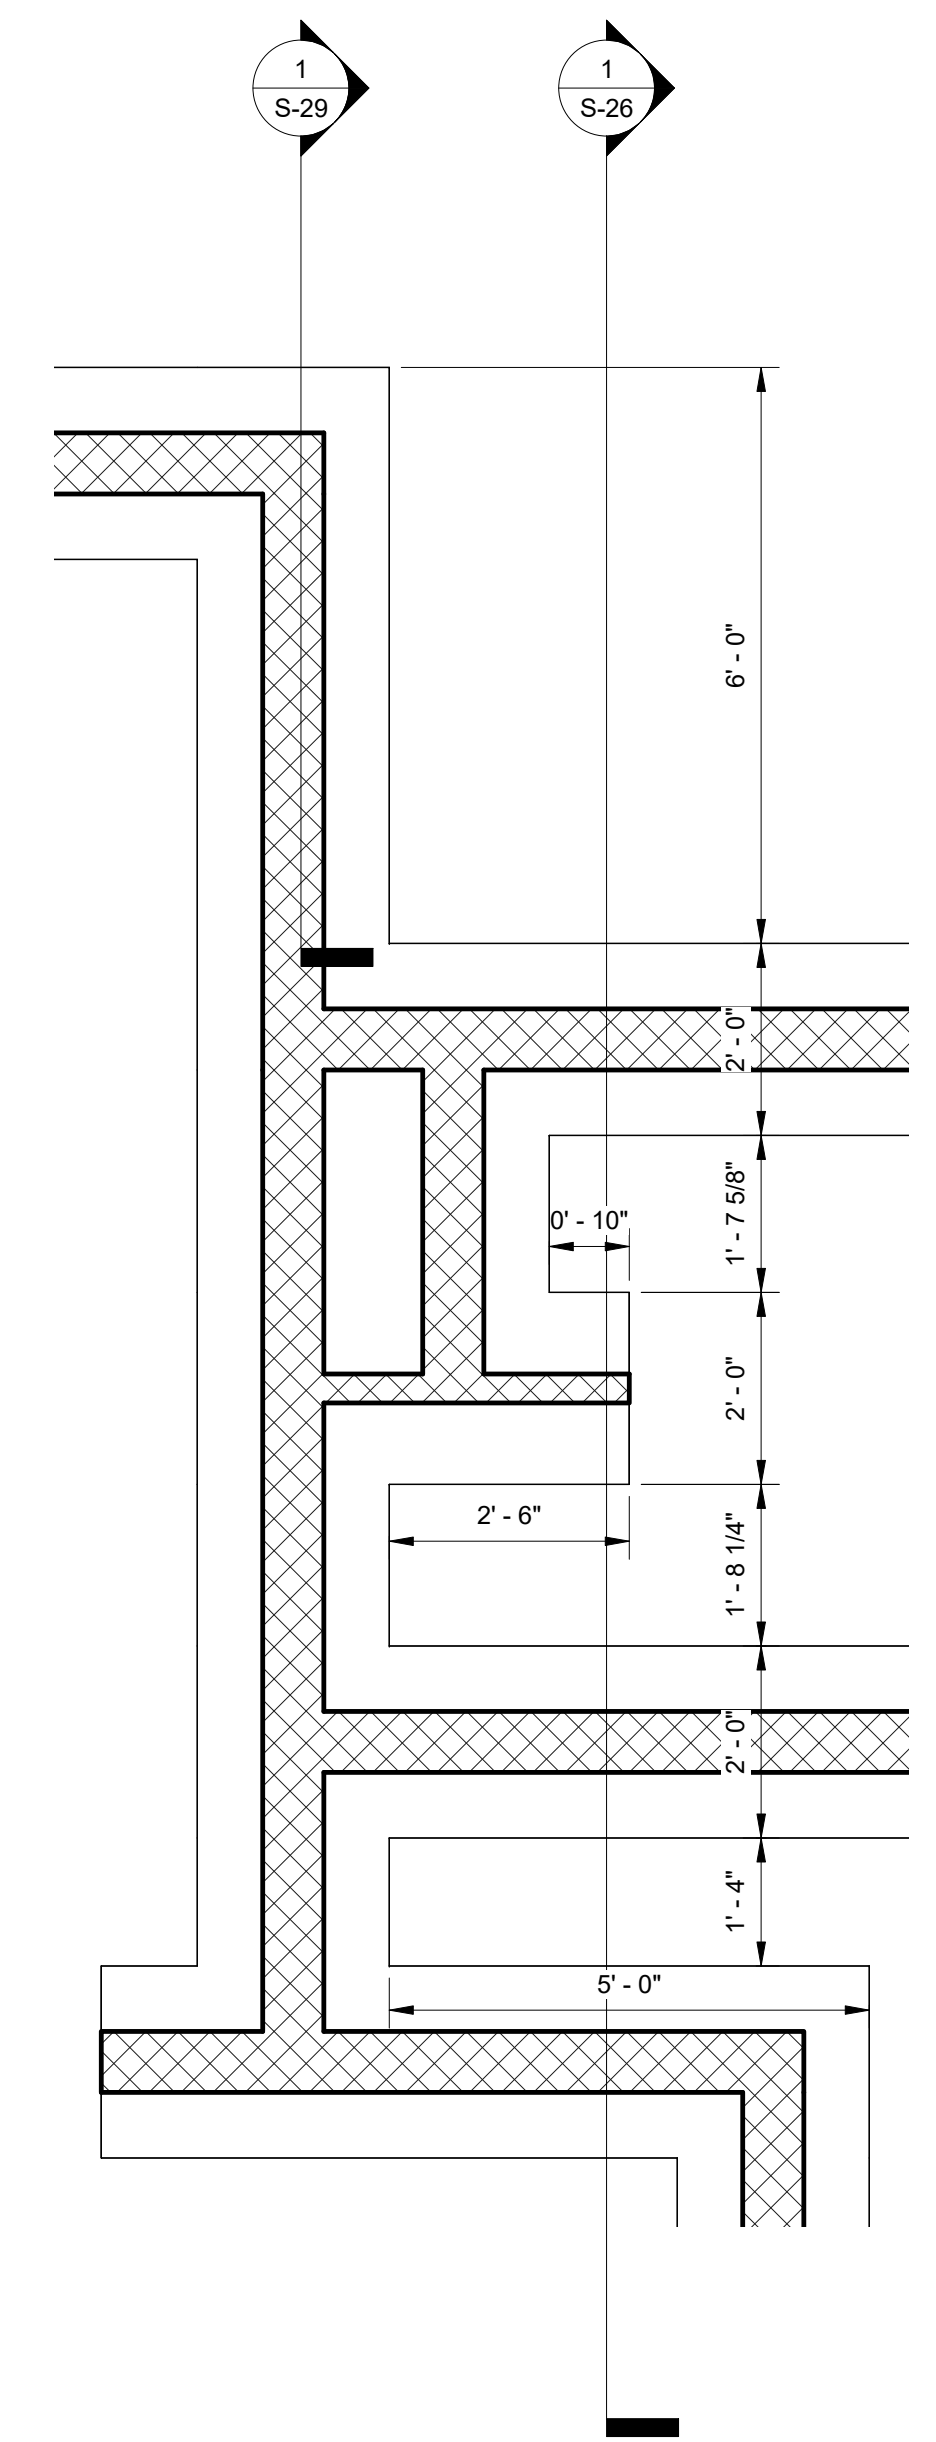

2 Footing - Group Camp - Callout 1
1/2" = 1'-0"

NOTE - THIS SHEET SHOWS PLANS AND DETAILS FOR BOTH DADDY ALLEN AND FOR SHEHAQUA. DADDY ALLEN IS BID 3. SHEHAQUA IS BID 2


NOTES:
1. FOR GENERAL NOTES SEE SHEET S-2
2. FOR SYMBOLS AND ABBREVIATIONS SEE SHEET S-1

VERIFY SCALE	
BAR IS ONE (1) INCH LONG	ON ORIGINAL DRAWING: 1
IF BAR IS NOT ONE (1) INCH LONG, ADJUST SCALE ACCORDINGLY	
CONTRACTOR SHALL FIELD VERIFY ALL DIMENSIONS. VARIANCE FROM CONTRACT DOCUMENTS NOT PERMITTED WITHOUT PROFESSIONAL & BUREAU OF CONSTRUCTION APPROVAL.	
CHECKED BY J ADAMS	SCALE AS NOTED

CONSTRUCTION DOCUMENTS



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James W. Adams
SIGNATURE DATE 11/19/2021
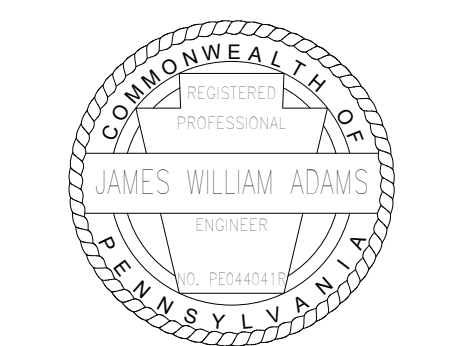
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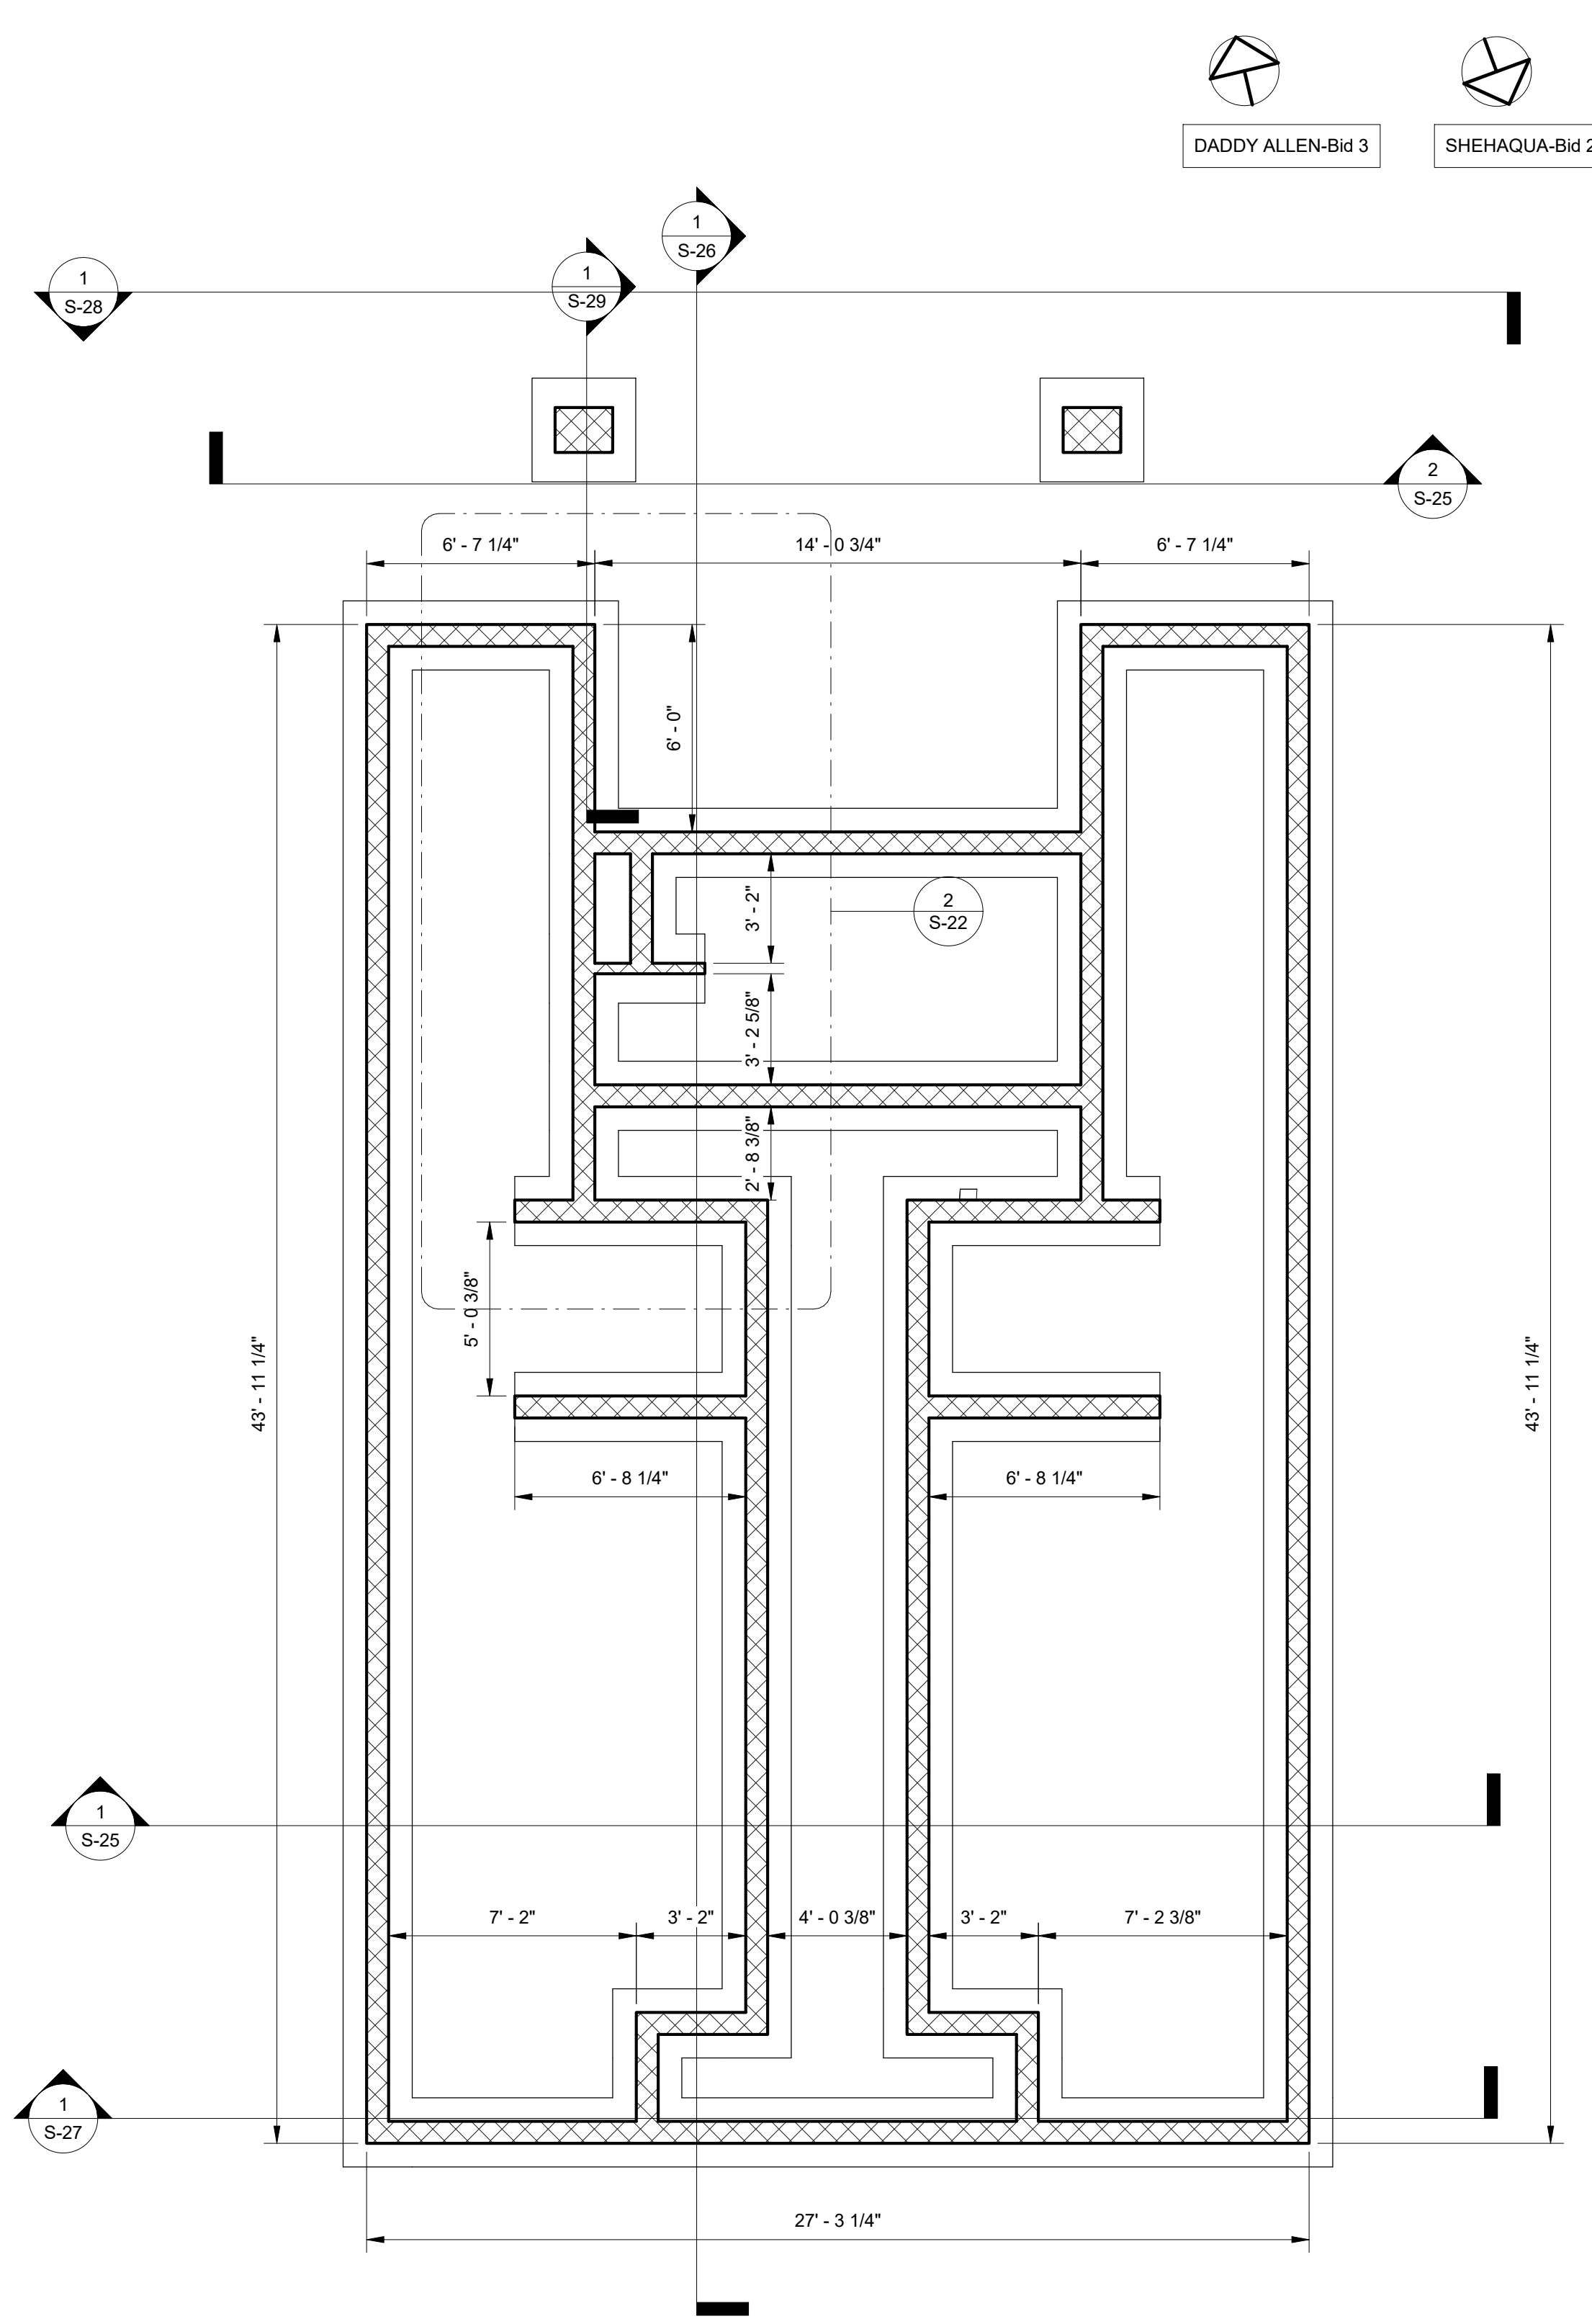
COMMONWEALTH OF PENNSYLVANIA
DEPARTMENT OF GENERAL SERVICES
HARRISBURG, PENNSYLVANIA

D.G.S. PROJECT No.
C-114-0006 PHASE 1

HICKORY RUN STATE PARK
LATRINE IMPROVEMENTS
DEPT of CONSERVATION AND NATURAL RESOURCES
WHITE HAVEN, CARBON COUNTY, PA


GROUP CAMP FOOTING PLAN

DATE 06/17/2022	DRAWING No. S-21
CHECKED BY J ADAMS	SCALE AS NOTED
DRAWN BY J ADAMS	DATE 06/17/2022



1 Foundation Wall - Group Camp
1/4" = 1'-0"

DADDY ALLEN-Bid 3
SHEHAQUA-Bid 2

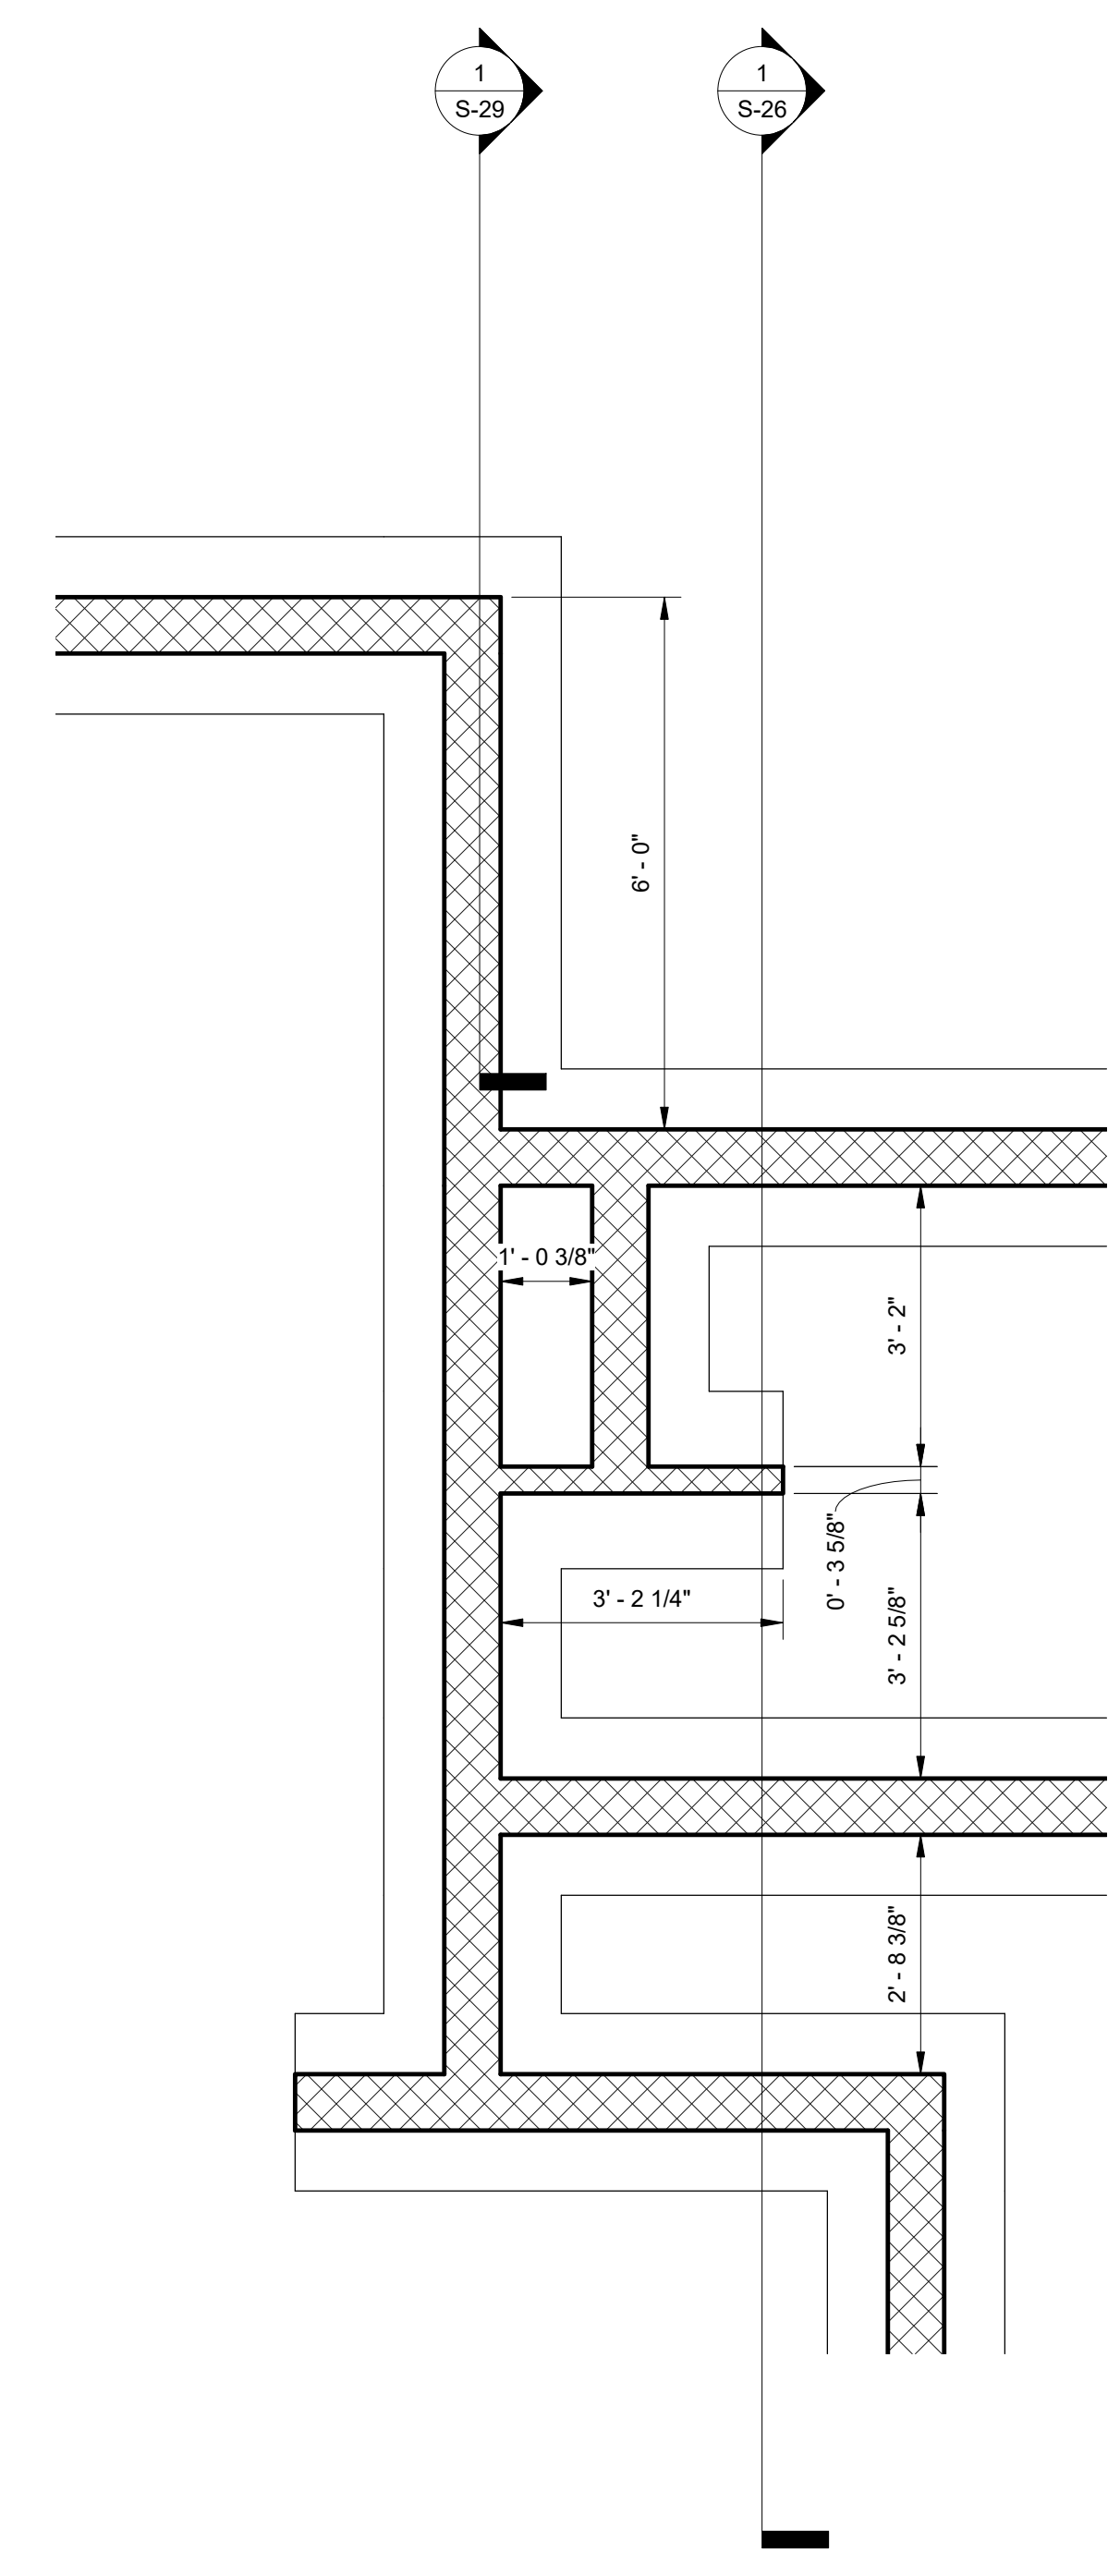

2 Foundation Wall - Group Camp - Callout 1
1/2" = 1'-0"

NOTE - THIS SHEET SHOWS PLANS AND DETAILS FOR BOTH DADDY ALLEN AND FOR SHEHAQUA. DADDY ALLEN IS BID 3. SHEHAQUA IS BID 2


- NOTES:
1. FOR GENERAL NOTES SEE SHEET S-2
2. FOR SYMBOLS AND ABBREVIATIONS SEE SHEET S-1

VERIFY SCALE
BAR IS ONE (1) INCH LONG
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CONSTRUCTION DOCUMENTS



NO.	REVISION	DATE

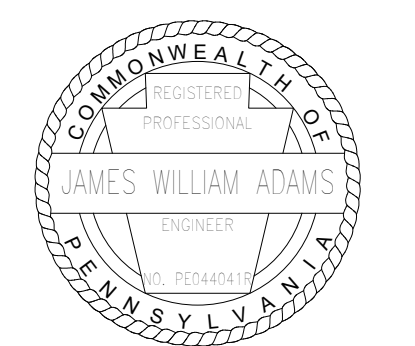

James W. Adams
SIGNATURE DATE 11/19/2021



SMP ARCHITECTS
1600 WALNUT STREET, SECOND FLOOR
PHILADELPHIA, PENNSYLVANIA

COMMONWEALTH OF PENNSYLVANIA
DEPARTMENT OF GENERAL SERVICES
HARRISBURG, PENNSYLVANIA

D.G.S. PROJECT No. C-114-0006 PHASE 1

HICKORY RUN STATE PARK
LATRINE IMPROVEMENTS
DEPT of CONSERVATION AND NATURAL RESOURCES
WHITE HAVEN, CARBON COUNTY, PA
GROUP CAMP FOUNDATION WALL PLAN

DRAWN BY J ADAMS	DATE 06/17/2022	DRAWING No. S-22
CHECKED BY J ADAMS	SCALE AS NOTED	103 OF 144

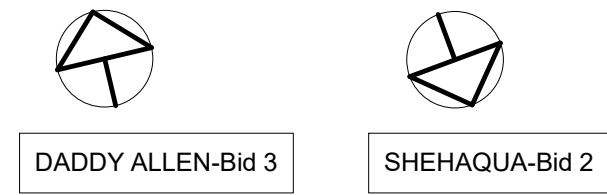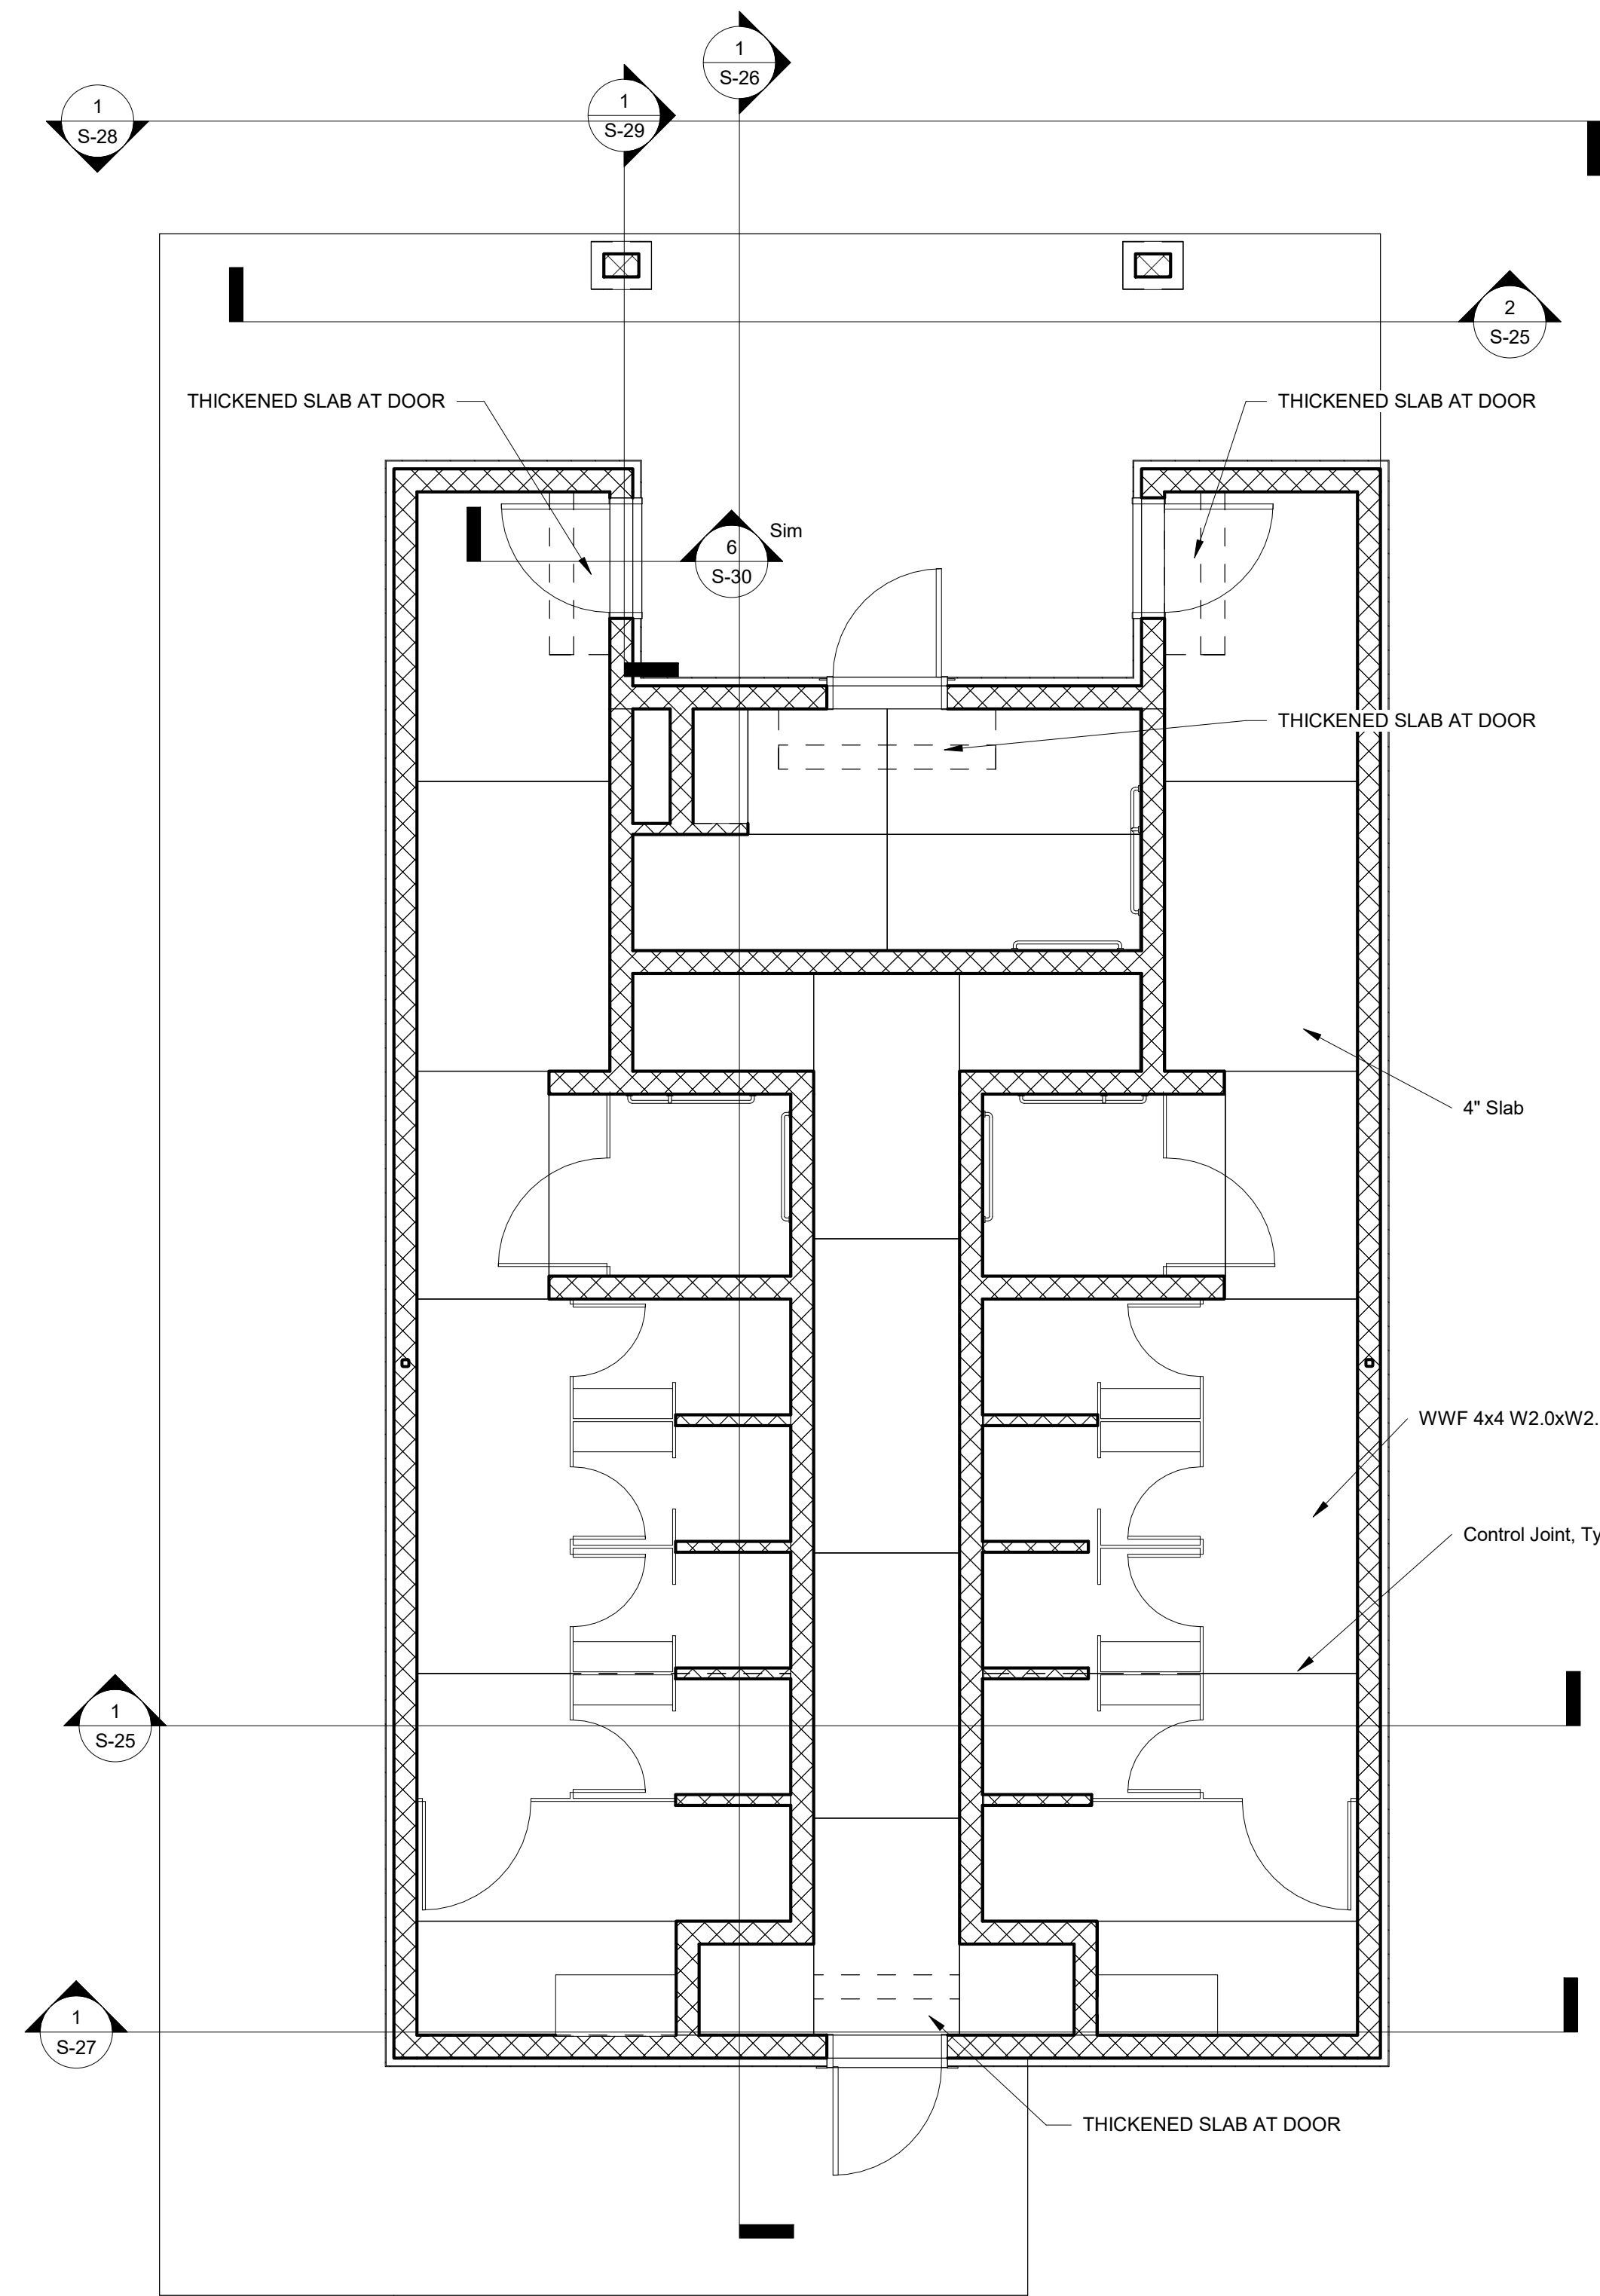

1 Slab and Wall Plan - Group Camp
1/4" = 1'-0"

NOTE - THIS SHEET SHOWS PLANS AND DETAILS FOR BOTH DADDY ALLEN AND FOR SHEHAQUA. DADDY ALLEN IS BID 3. SHEHAQUA IS BID 2


- NOTES:
 1. FOR GENERAL NOTES SEE SHEET S-2
 2. FOR SYMBOLS AND ABBREVIATIONS SEE SHEET S-1

VERIFY SCALE		
BAR IS ONE (1) INCH LONG		
ON ORIGINAL DRAWING: 0 1		
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CONTRACTOR SHALL FIELD VERIFY ALL DIMENSIONS. VARIANCE FROM CONTRACT DOCUMENTS NOT PERMITTED WITHOUT PROFESSIONAL & BUREAU OF CONSTRUCTION APPROVAL.	DRAWN BY J ADAMS	DATE 06/17/2022
CHECKED BY J ADAMS	SCALE AS NOTED	DRAWING No. S-23

CONSTRUCTION DOCUMENTS



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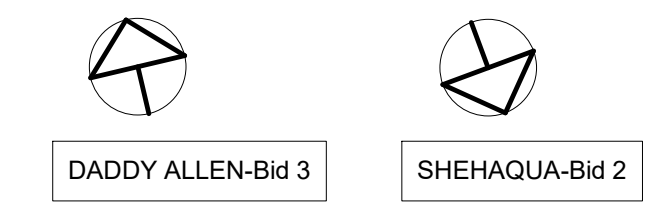
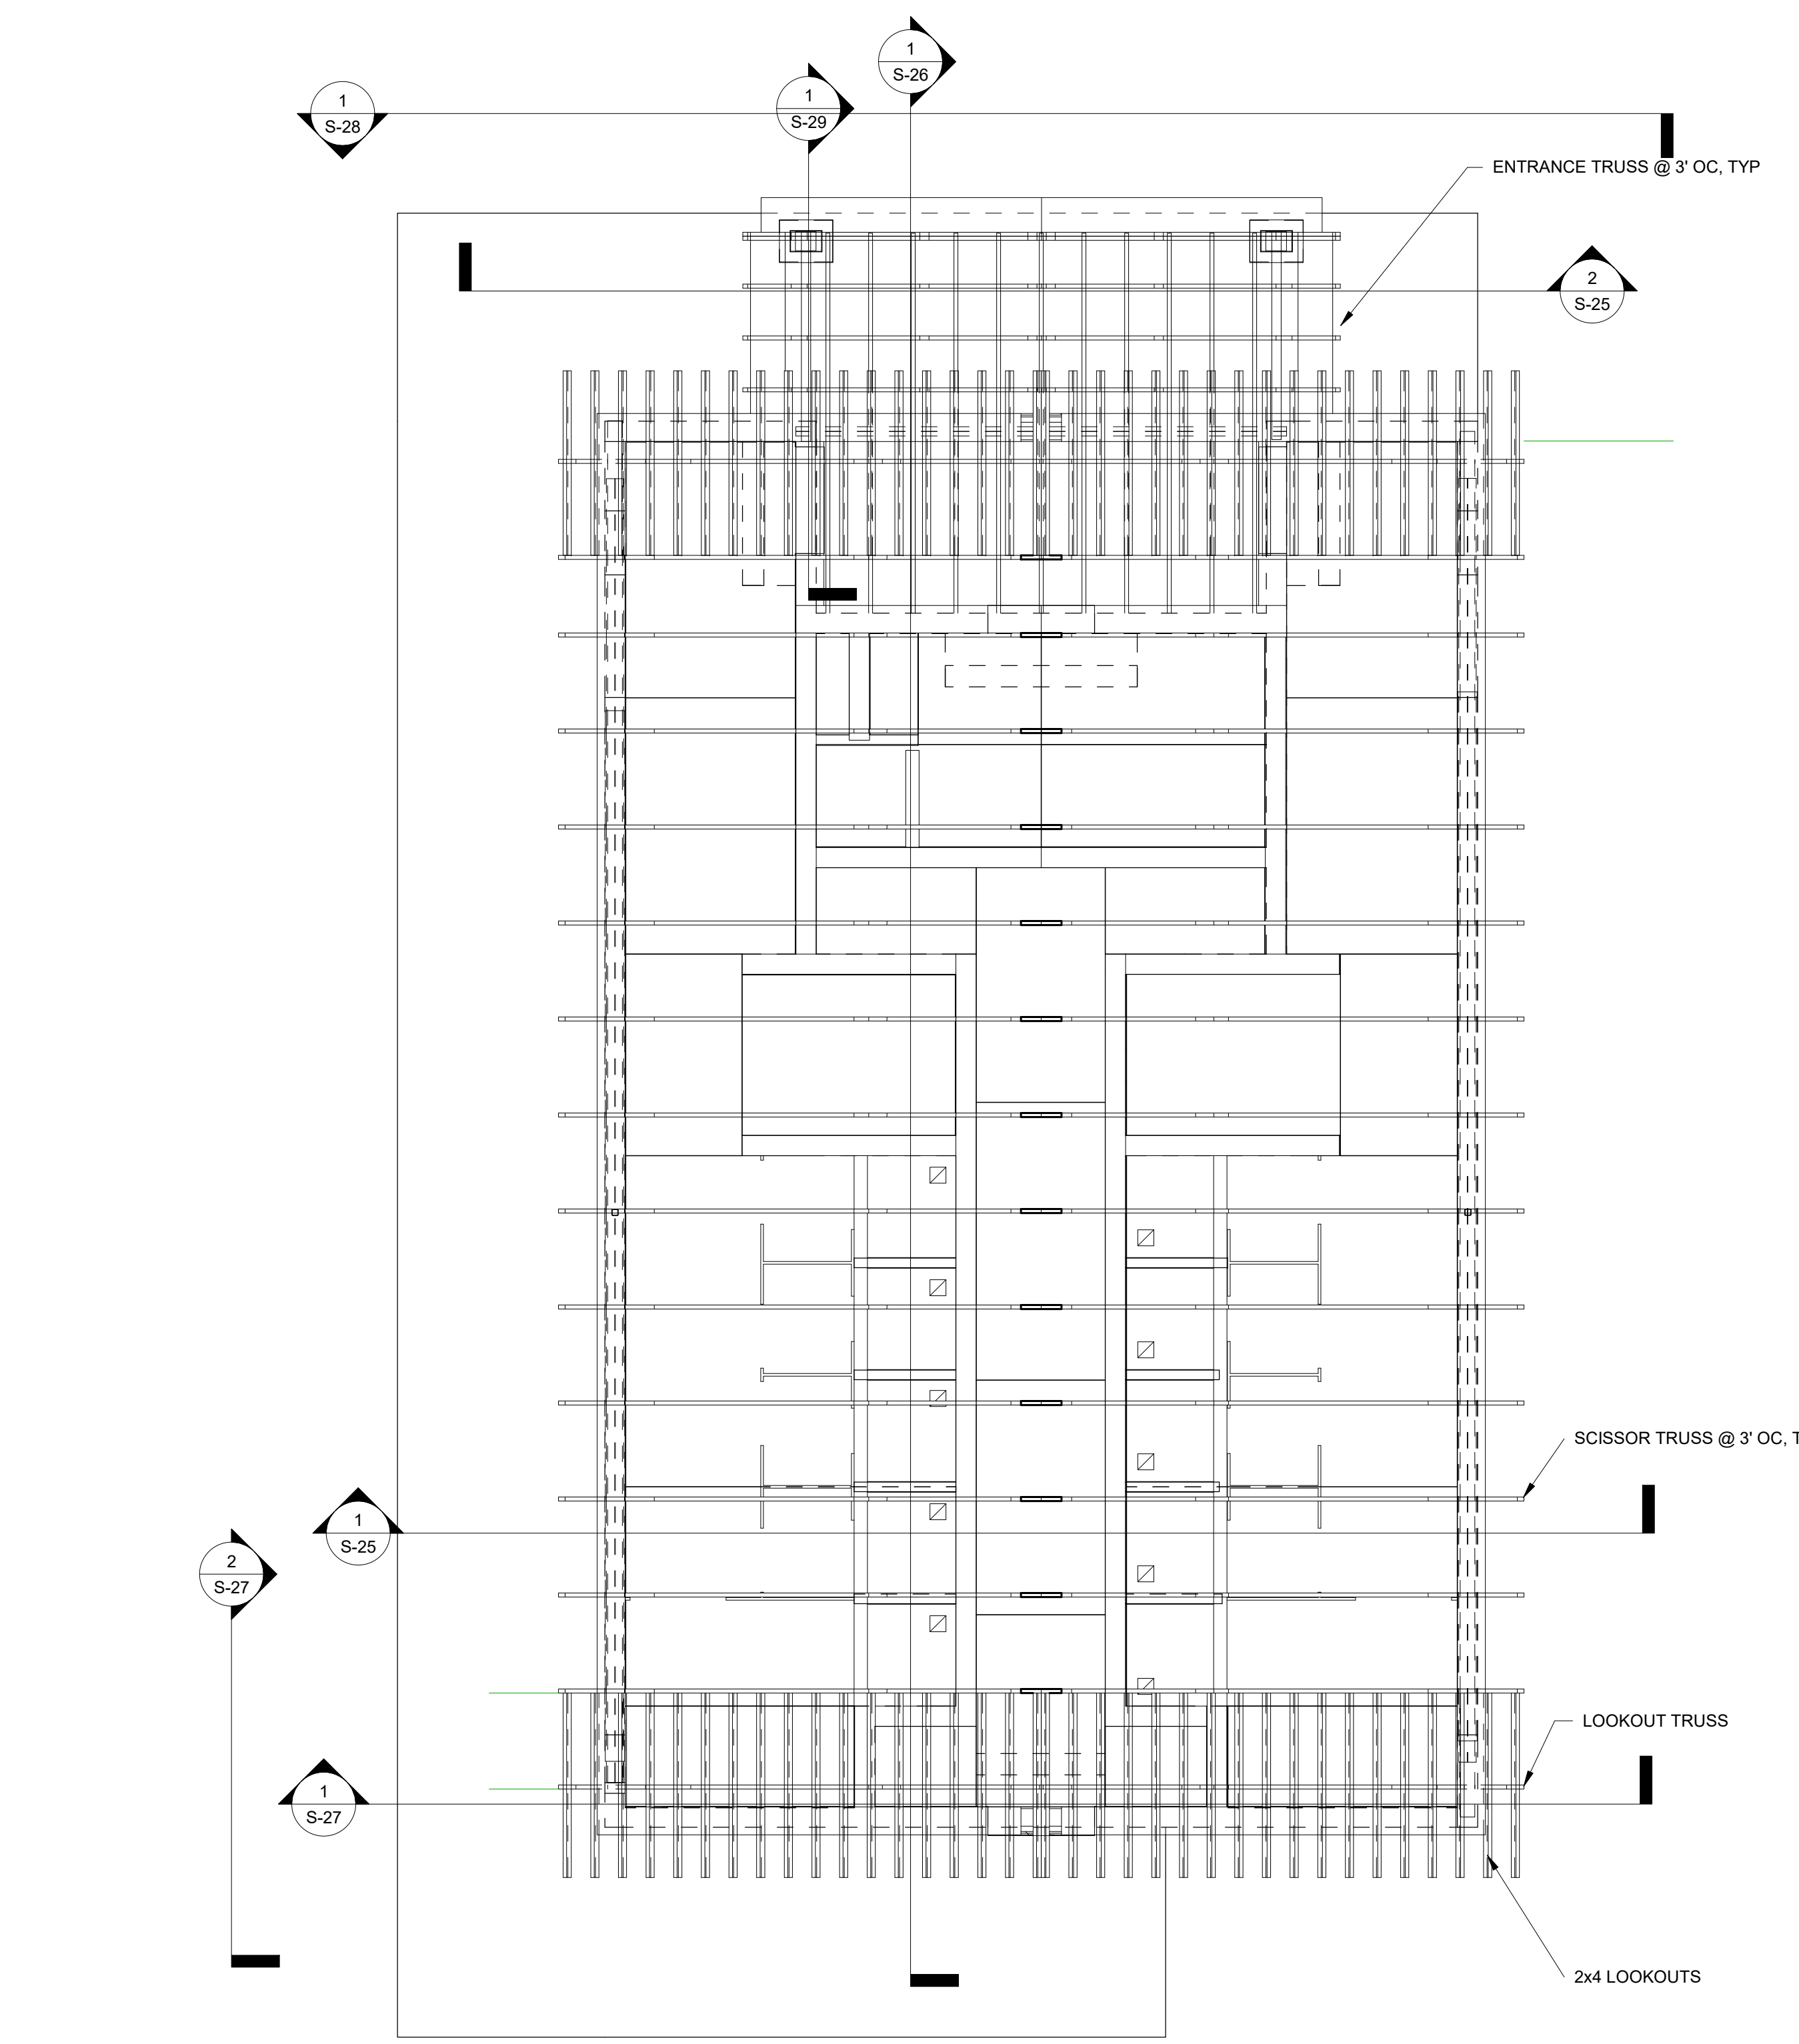


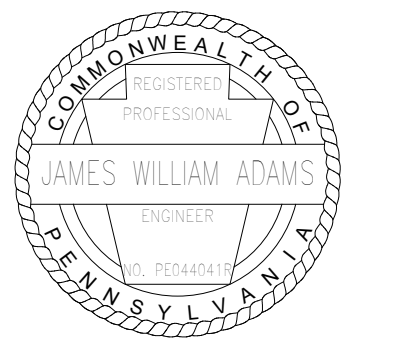Signature: *James W. Adams* DATE: 11/19/2021

SMP ARCHITECTS
 1600 WALNUT STREET, SECOND FLOOR
 PHILADELPHIA, PENNSYLVANIA

COMMONWEALTH OF PENNSYLVANIA
 DEPARTMENT OF GENERAL SERVICES
 HARRISBURG, PENNSYLVANIA

D.G.S. PROJECT No.
C-114-0006 PHASE 1
HICKORY RUN STATE PARK
LATRINE IMPROVEMENTS
 DEPT of CONSERVATION AND NATURAL RESOURCES
 WHITE HAVEN, CARBON COUNTY, PA
 GROUP CAMP SLAB AND WALL PLAN



1 Roof - Group Camp
1/4" = 1'-0"

NOTE - THIS SHEET SHOWS PLANS AND DETAILS FOR BOTH DADDY ALLEN AND FOR SHEHAQUA. DADDY ALLEN IS BID 3. SHEHAQUA IS BID 2


- NOTES:
- FOR GENERAL NOTES SEE SHEET S-2
 - FOR SYMBOLS AND ABBREVIATIONS SEE SHEET S-1

VERIFY SCALE		
BAR IS ONE (1) INCH LONG		
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DRAWN BY J ADAMS	DATE 06/17/2022	DRAWING No. S-24
CHECKED BY J ADAMS	SCALE AS NOTED	

CONSTRUCTION DOCUMENTS



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Signature: *James W. Adams*
DATE: 11/19/2021

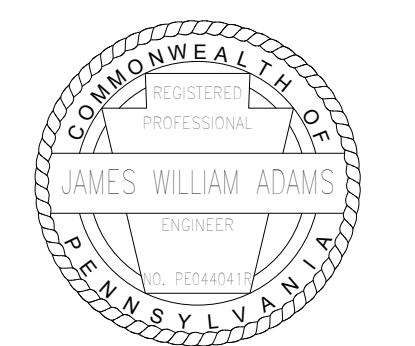
SMP ARCHITECTS
1600 WALNUT STREET, SECOND FLOOR
PHILADELPHIA, PENNSYLVANIA

COMMONWEALTH OF PENNSYLVANIA
DEPARTMENT OF GENERAL SERVICES
HARRISBURG, PENNSYLVANIA



D.G.S. PROJECT No. C-114-0006 PHASE 1

HICKORY RUN STATE PARK
LATRINE IMPROVEMENTS
DEPT of CONSERVATION AND NATURAL RESOURCES
WHITE HAVEN, CARBON COUNTY, PA

GROUP CAMP ROOF PLAN

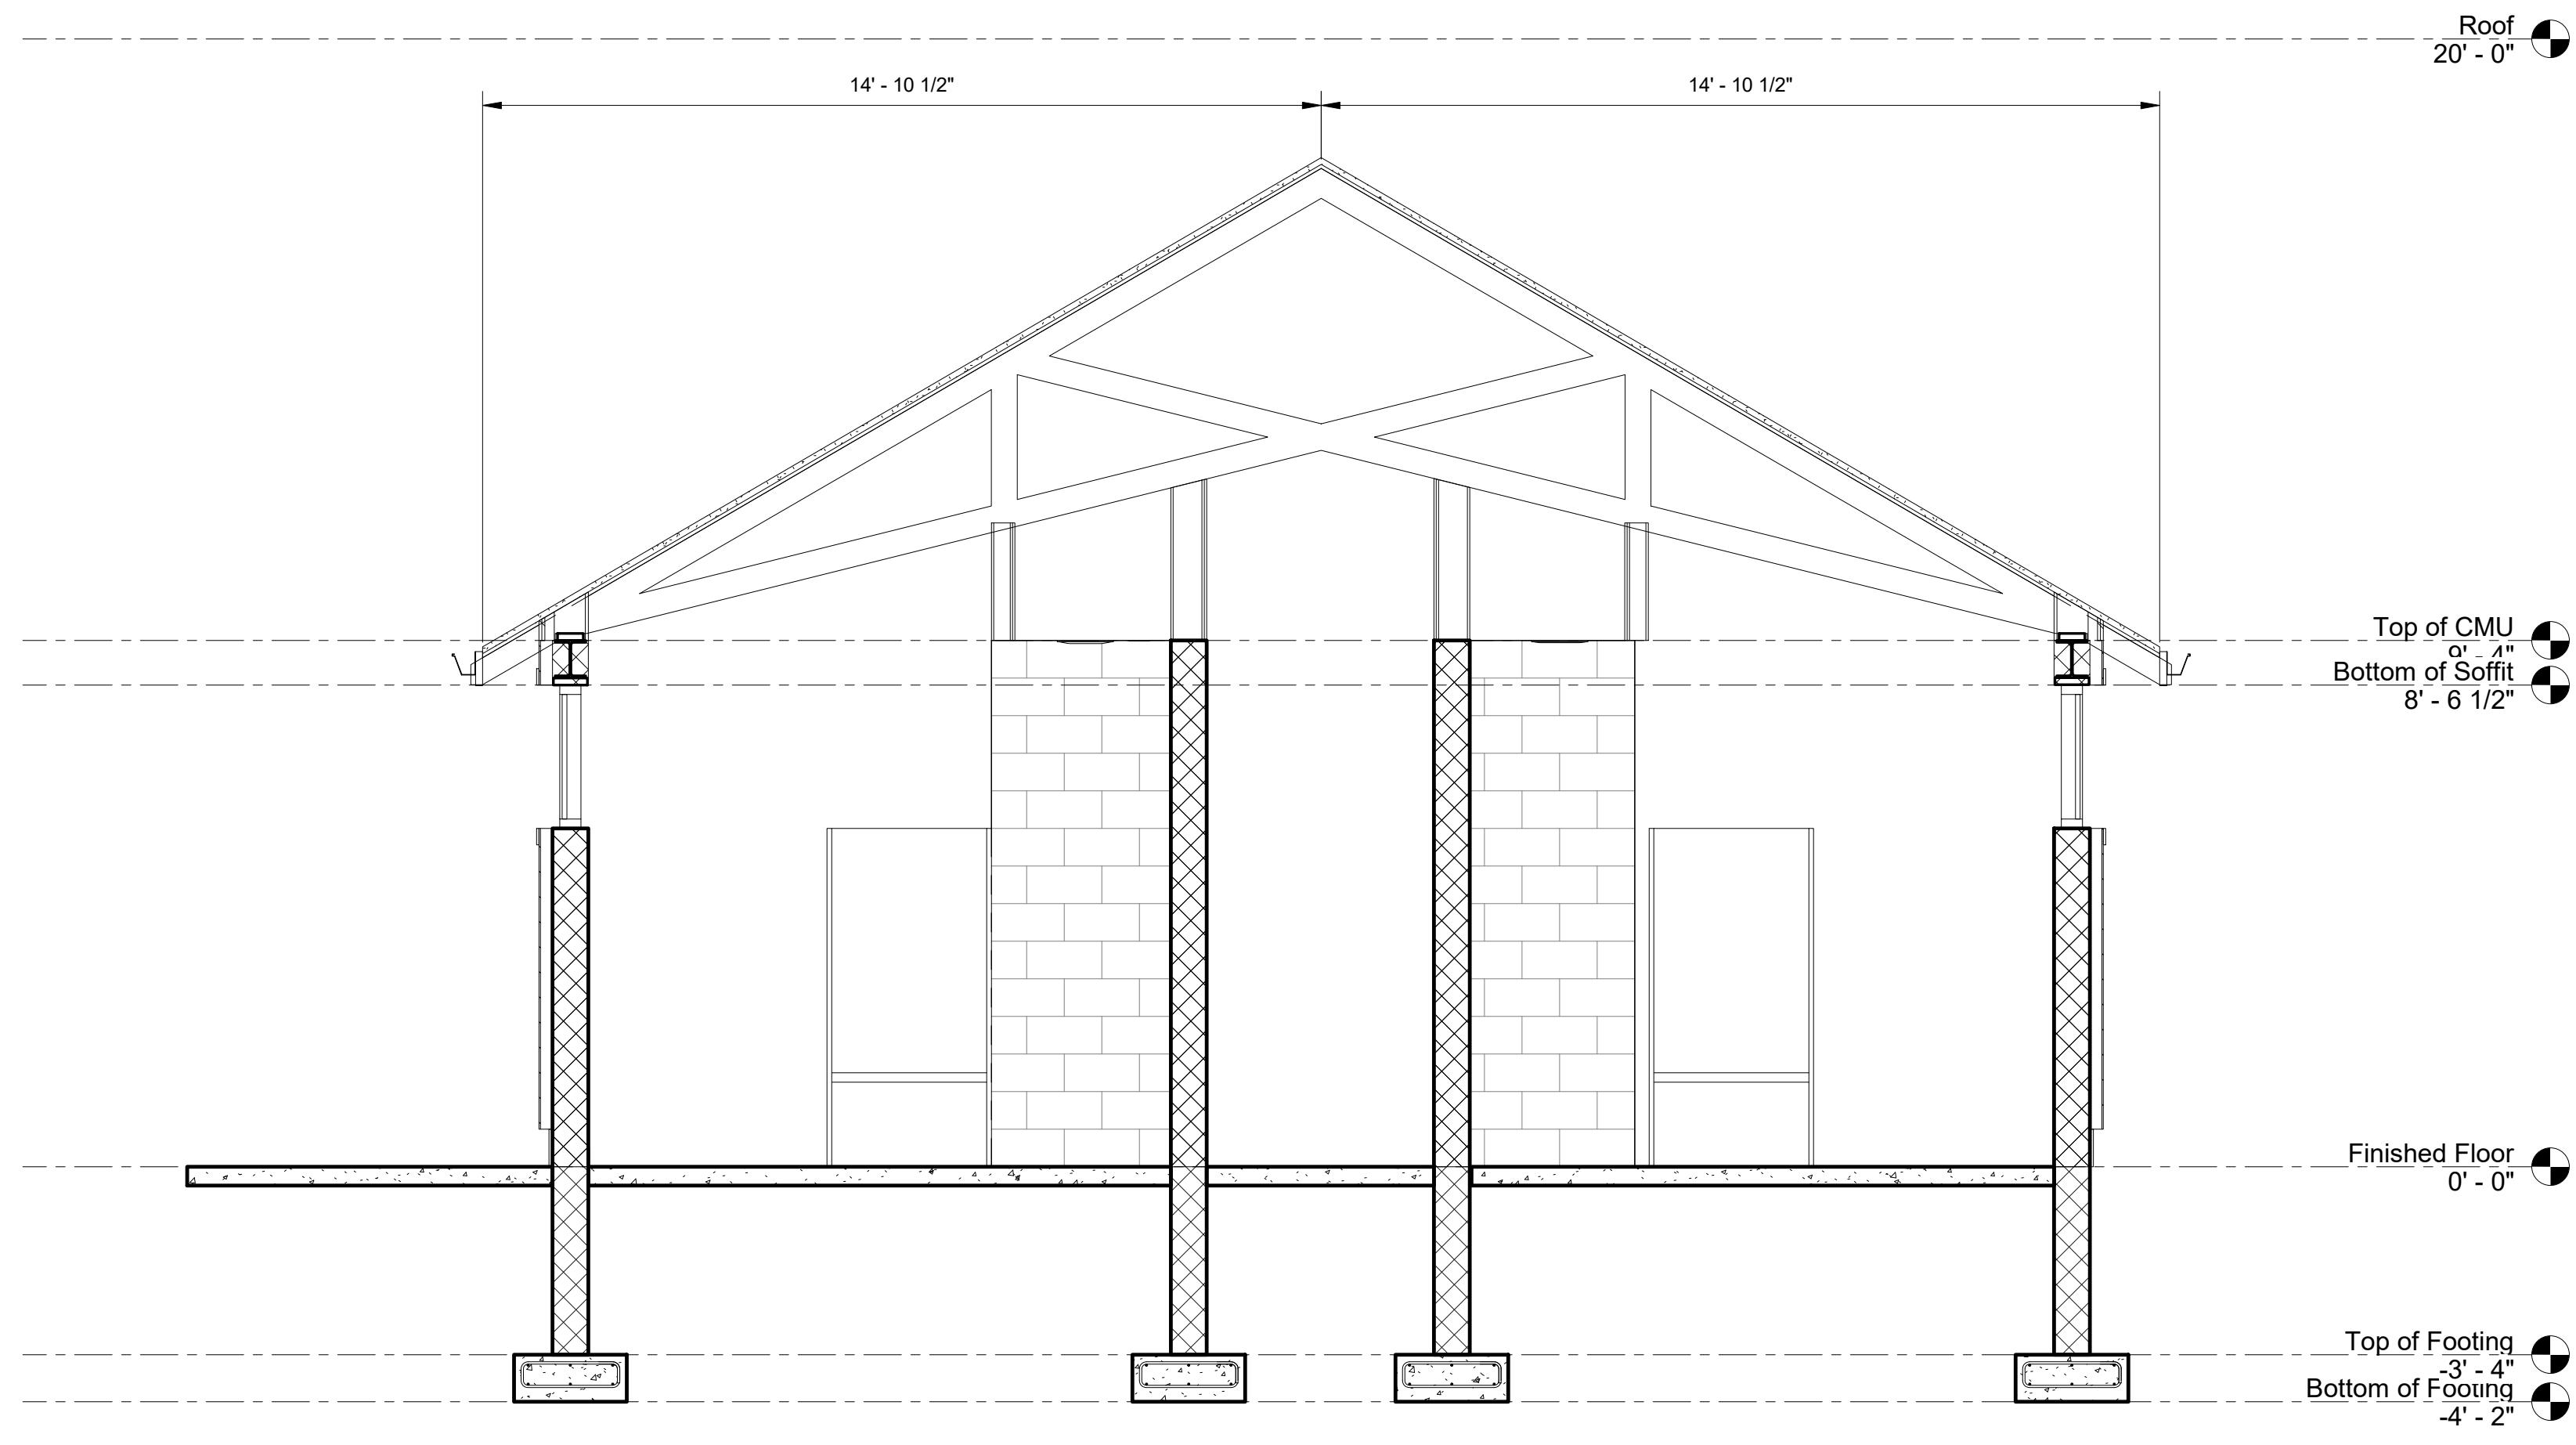

① Group Camp Cross Section
3/8" = 1'-0"

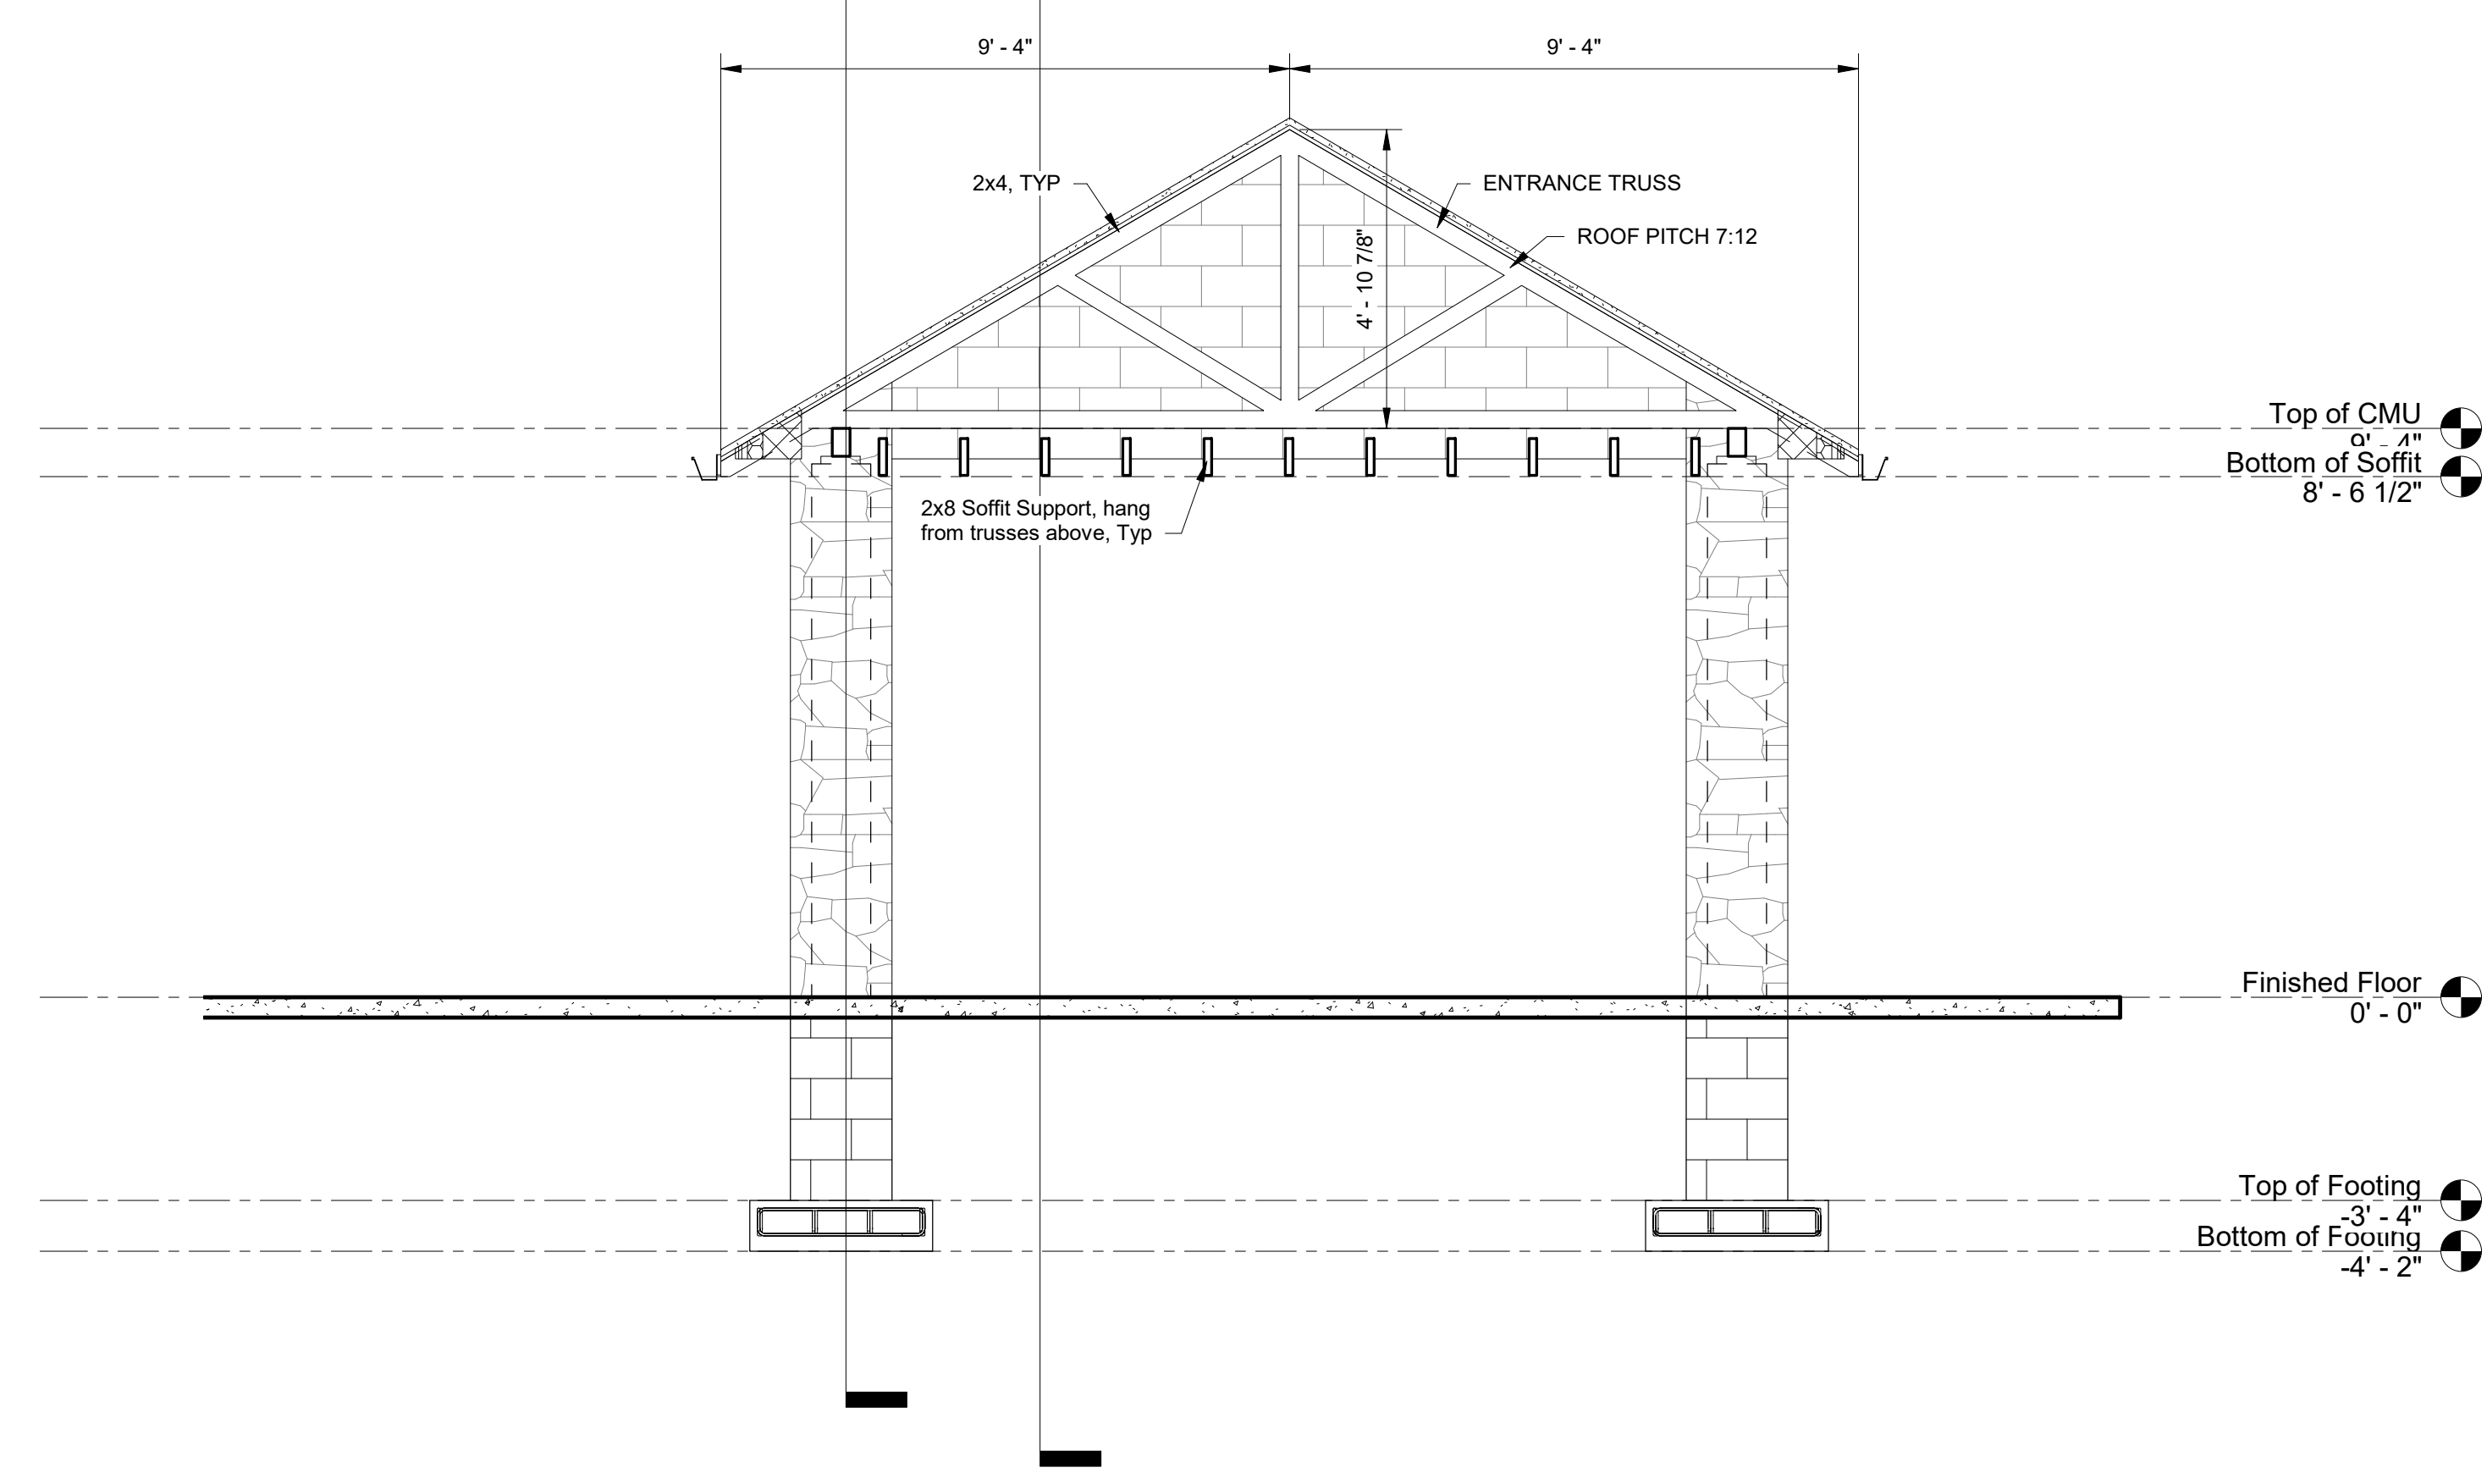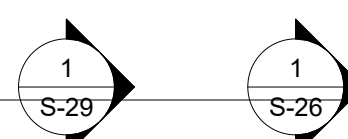

② Group Camp Entrance Section
3/8" = 1'-0"

NOTE - THIS SHEET SHOWS PLANS AND DETAILS FOR BOTH DADDY ALLEN AND FOR SHEHAQUA. DADDY ALLEN IS BID 3. SHEHAQUA IS BID 2

- NOTES:
 1. FOR GENERAL NOTES SEE SHEET S-2
 2. FOR SYMBOLS AND ABBREVIATIONS SEE SHEET S-1

VERIFY SCALE		
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ON ORIGINAL DRAWING: 0 1		
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DRAWN BY J ADAMS	DATE 06/17/2022	DRAWING No. S-25
CHECKED BY J ADAMS	SCALE AS NOTED	

CONSTRUCTION DOCUMENTS




NO.	REVISION

REGISTERED PROFESSIONAL ENGINEER
 COMMONWEALTH OF PENNSYLVANIA
 JAMES WILLIAM ADAMS
 ENGINEER
 P. 125440011
 PENNSYLVANIA
 Signature: *James W. Adams* DATE: 11/19/2021

SMP ARCHITECTS
 1600 WALNUT STREET, SECOND FLOOR
 PHILADELPHIA, PENNSYLVANIA

COMMONWEALTH OF PENNSYLVANIA
 DEPARTMENT OF GENERAL SERVICES
 HARRISBURG, PENNSYLVANIA

D.G.S. PROJECT No.
 C-114-0006 PHASE 1
HICKORY RUN STATE PARK
 LATRINE IMPROVEMENTS
 DEPT of CONSERVATION AND NATURAL RESOURCES
 WHITE HAVEN, CARBON COUNTY, PA
 GROUP CAMP SECTIONS, SHEET 1

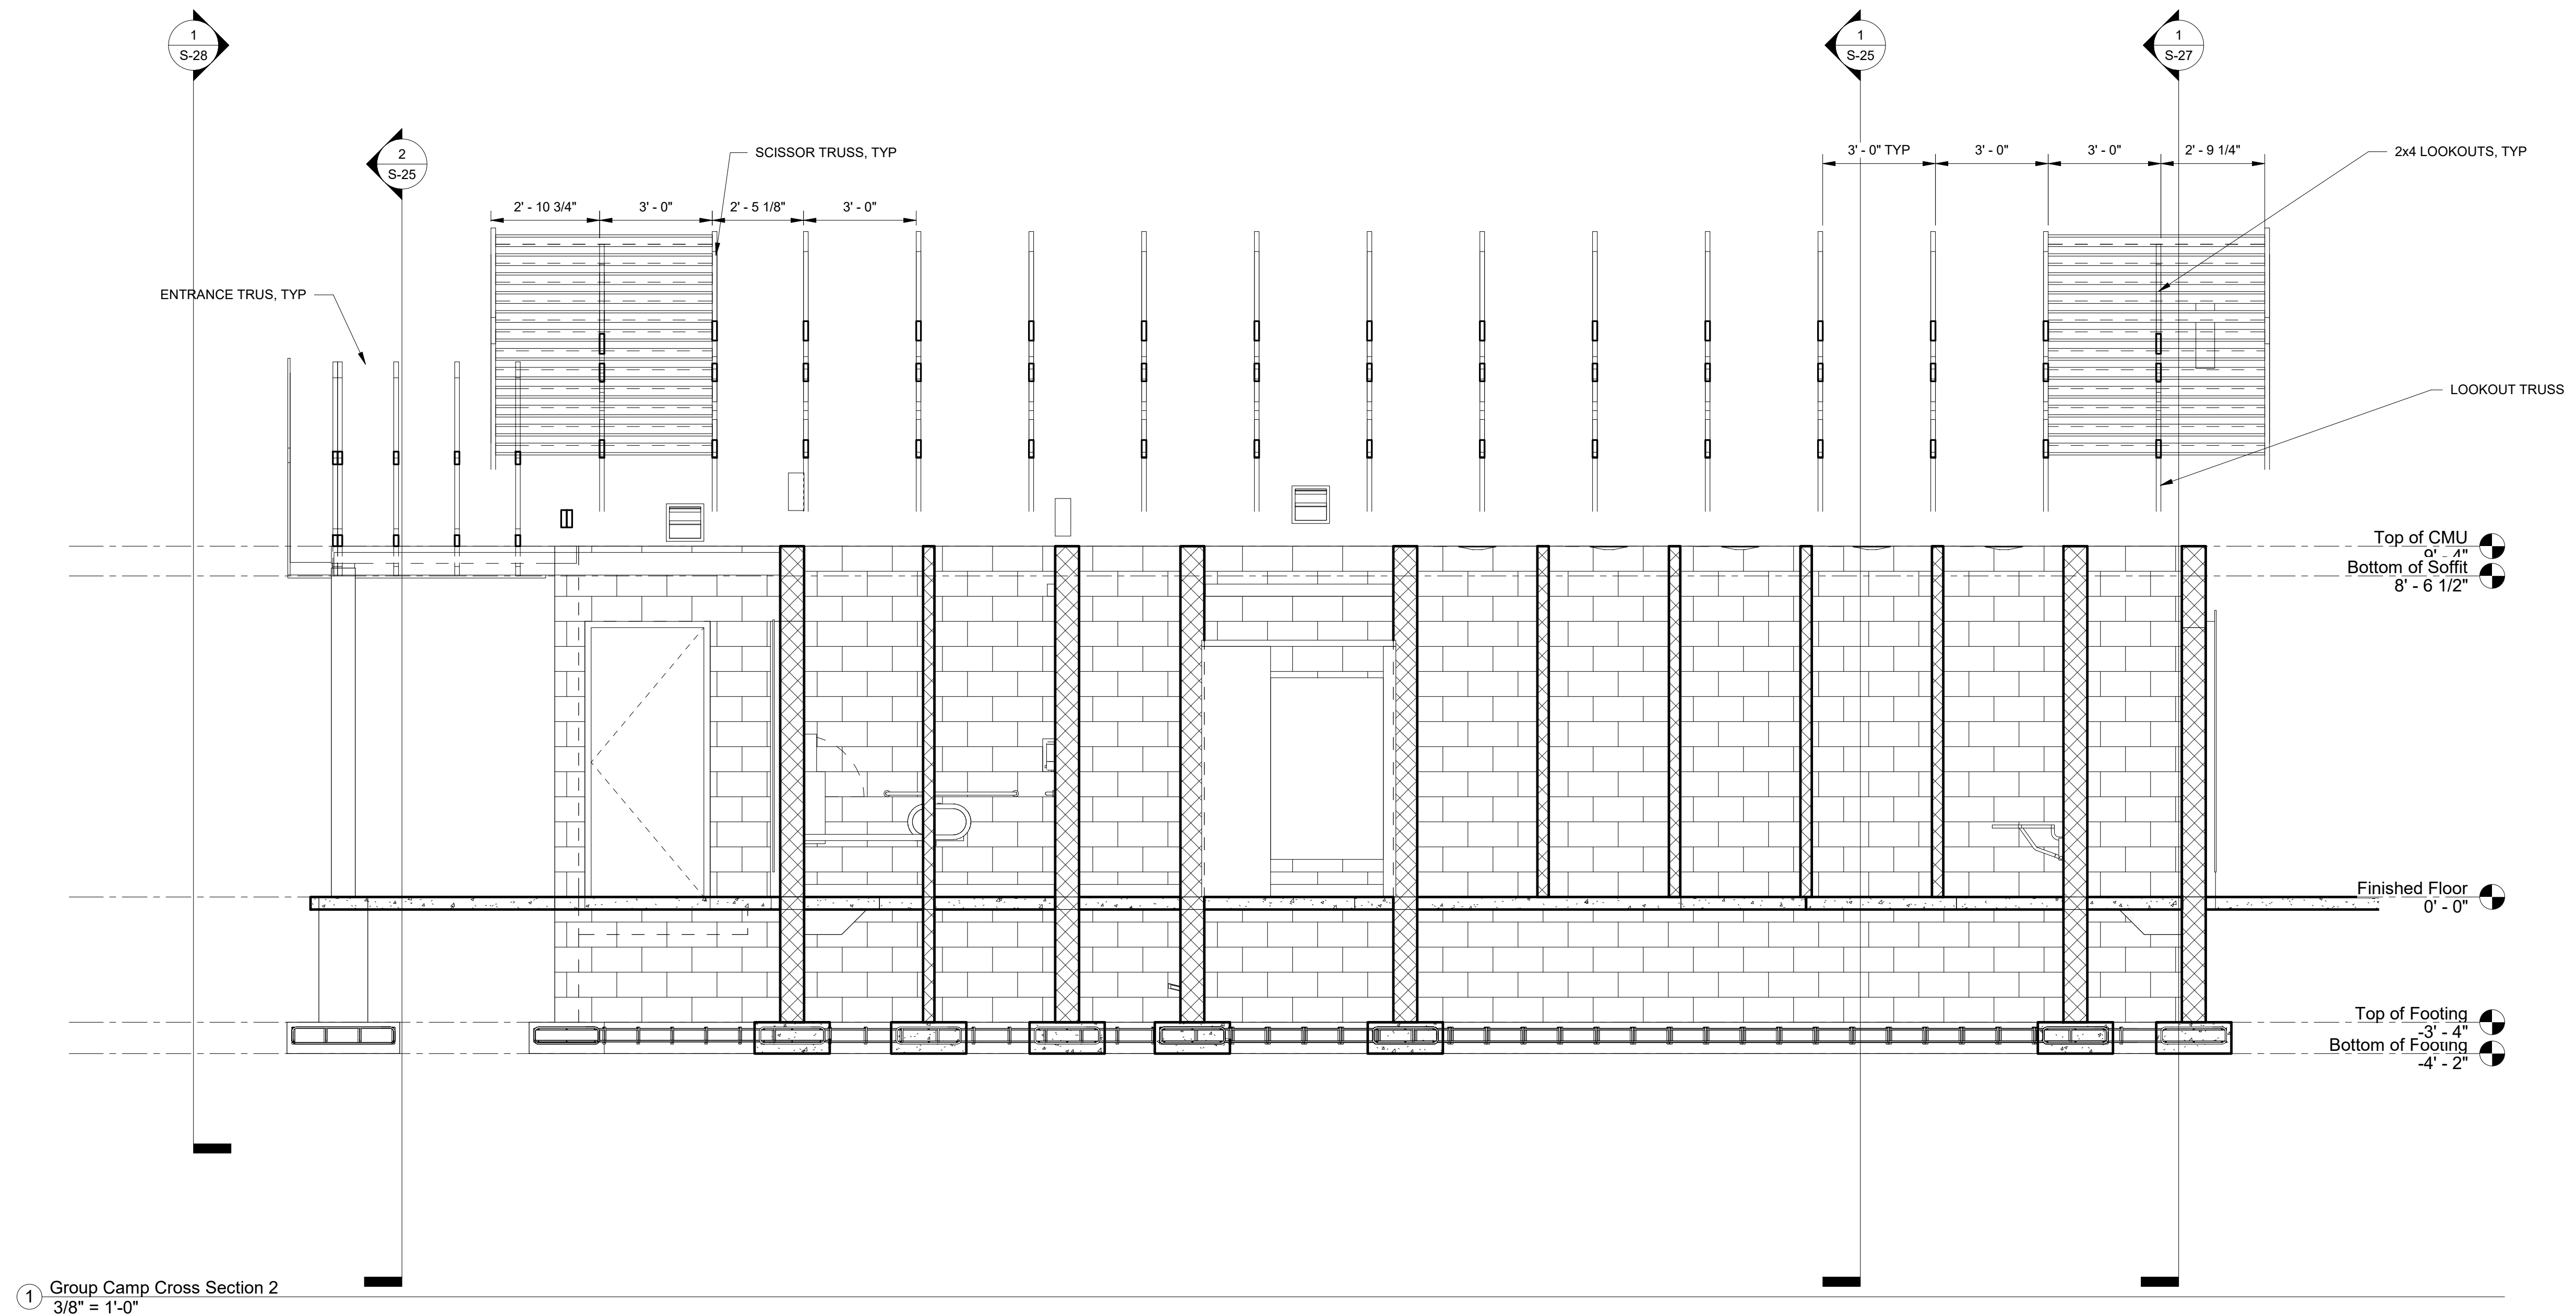

1 Group Camp Cross Section 2
3/8" = 1'-0"

NOTE - THIS SHEET SHOWS PLANS AND DETAILS FOR BOTH DADDY ALLEN AND FOR SHEHAQUA. DADDY ALLEN IS BID 3. SHEHAQUA IS BID 2

- NOTES:
 1. FOR GENERAL NOTES SEE SHEET S-2
 2. FOR SYMBOLS AND ABBREVIATIONS SEE SHEET S-1

VERIFY SCALE	
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CONSTRUCTION DOCUMENTS



NO.	DATE	REVISIONS

RECORD REVISIONS

James W. Adams
SIGNATURE 11/19/2021 DATE

SMP ARCHITECTS
 1600 WALNUT STREET, SECOND FLOOR
 PHILADELPHIA, PENNSYLVANIA


COMMONWEALTH OF PENNSYLVANIA
 DEPARTMENT OF GENERAL SERVICES
 HARRISBURG, PENNSYLVANIA

D.G.S. PROJECT No.
C-114-0006 PHASE 1


HICKORY RUN STATE PARK
LATRINE IMPROVEMENTS
 DEPT of CONSERVATION AND NATURAL RESOURCES
 WHITE HAVEN, CARBON COUNTY, PA

GROUP CAMP SECTIONS, SHEET 2

CONTRACTOR SHALL FIELD VERIFY ALL DIMENSIONS. VARIANCE FROM CONTRACT DOCUMENTS NOT PERMITTED WITHOUT PROFESSIONAL & BUREAU OF CONSTRUCTION APPROVAL.	DRAWN BY J ADAMS	DATE 06/17/2022	DRAWING No. S-26
	CHECKED BY J ADAMS	SCALE AS NOTED	107 OF 144

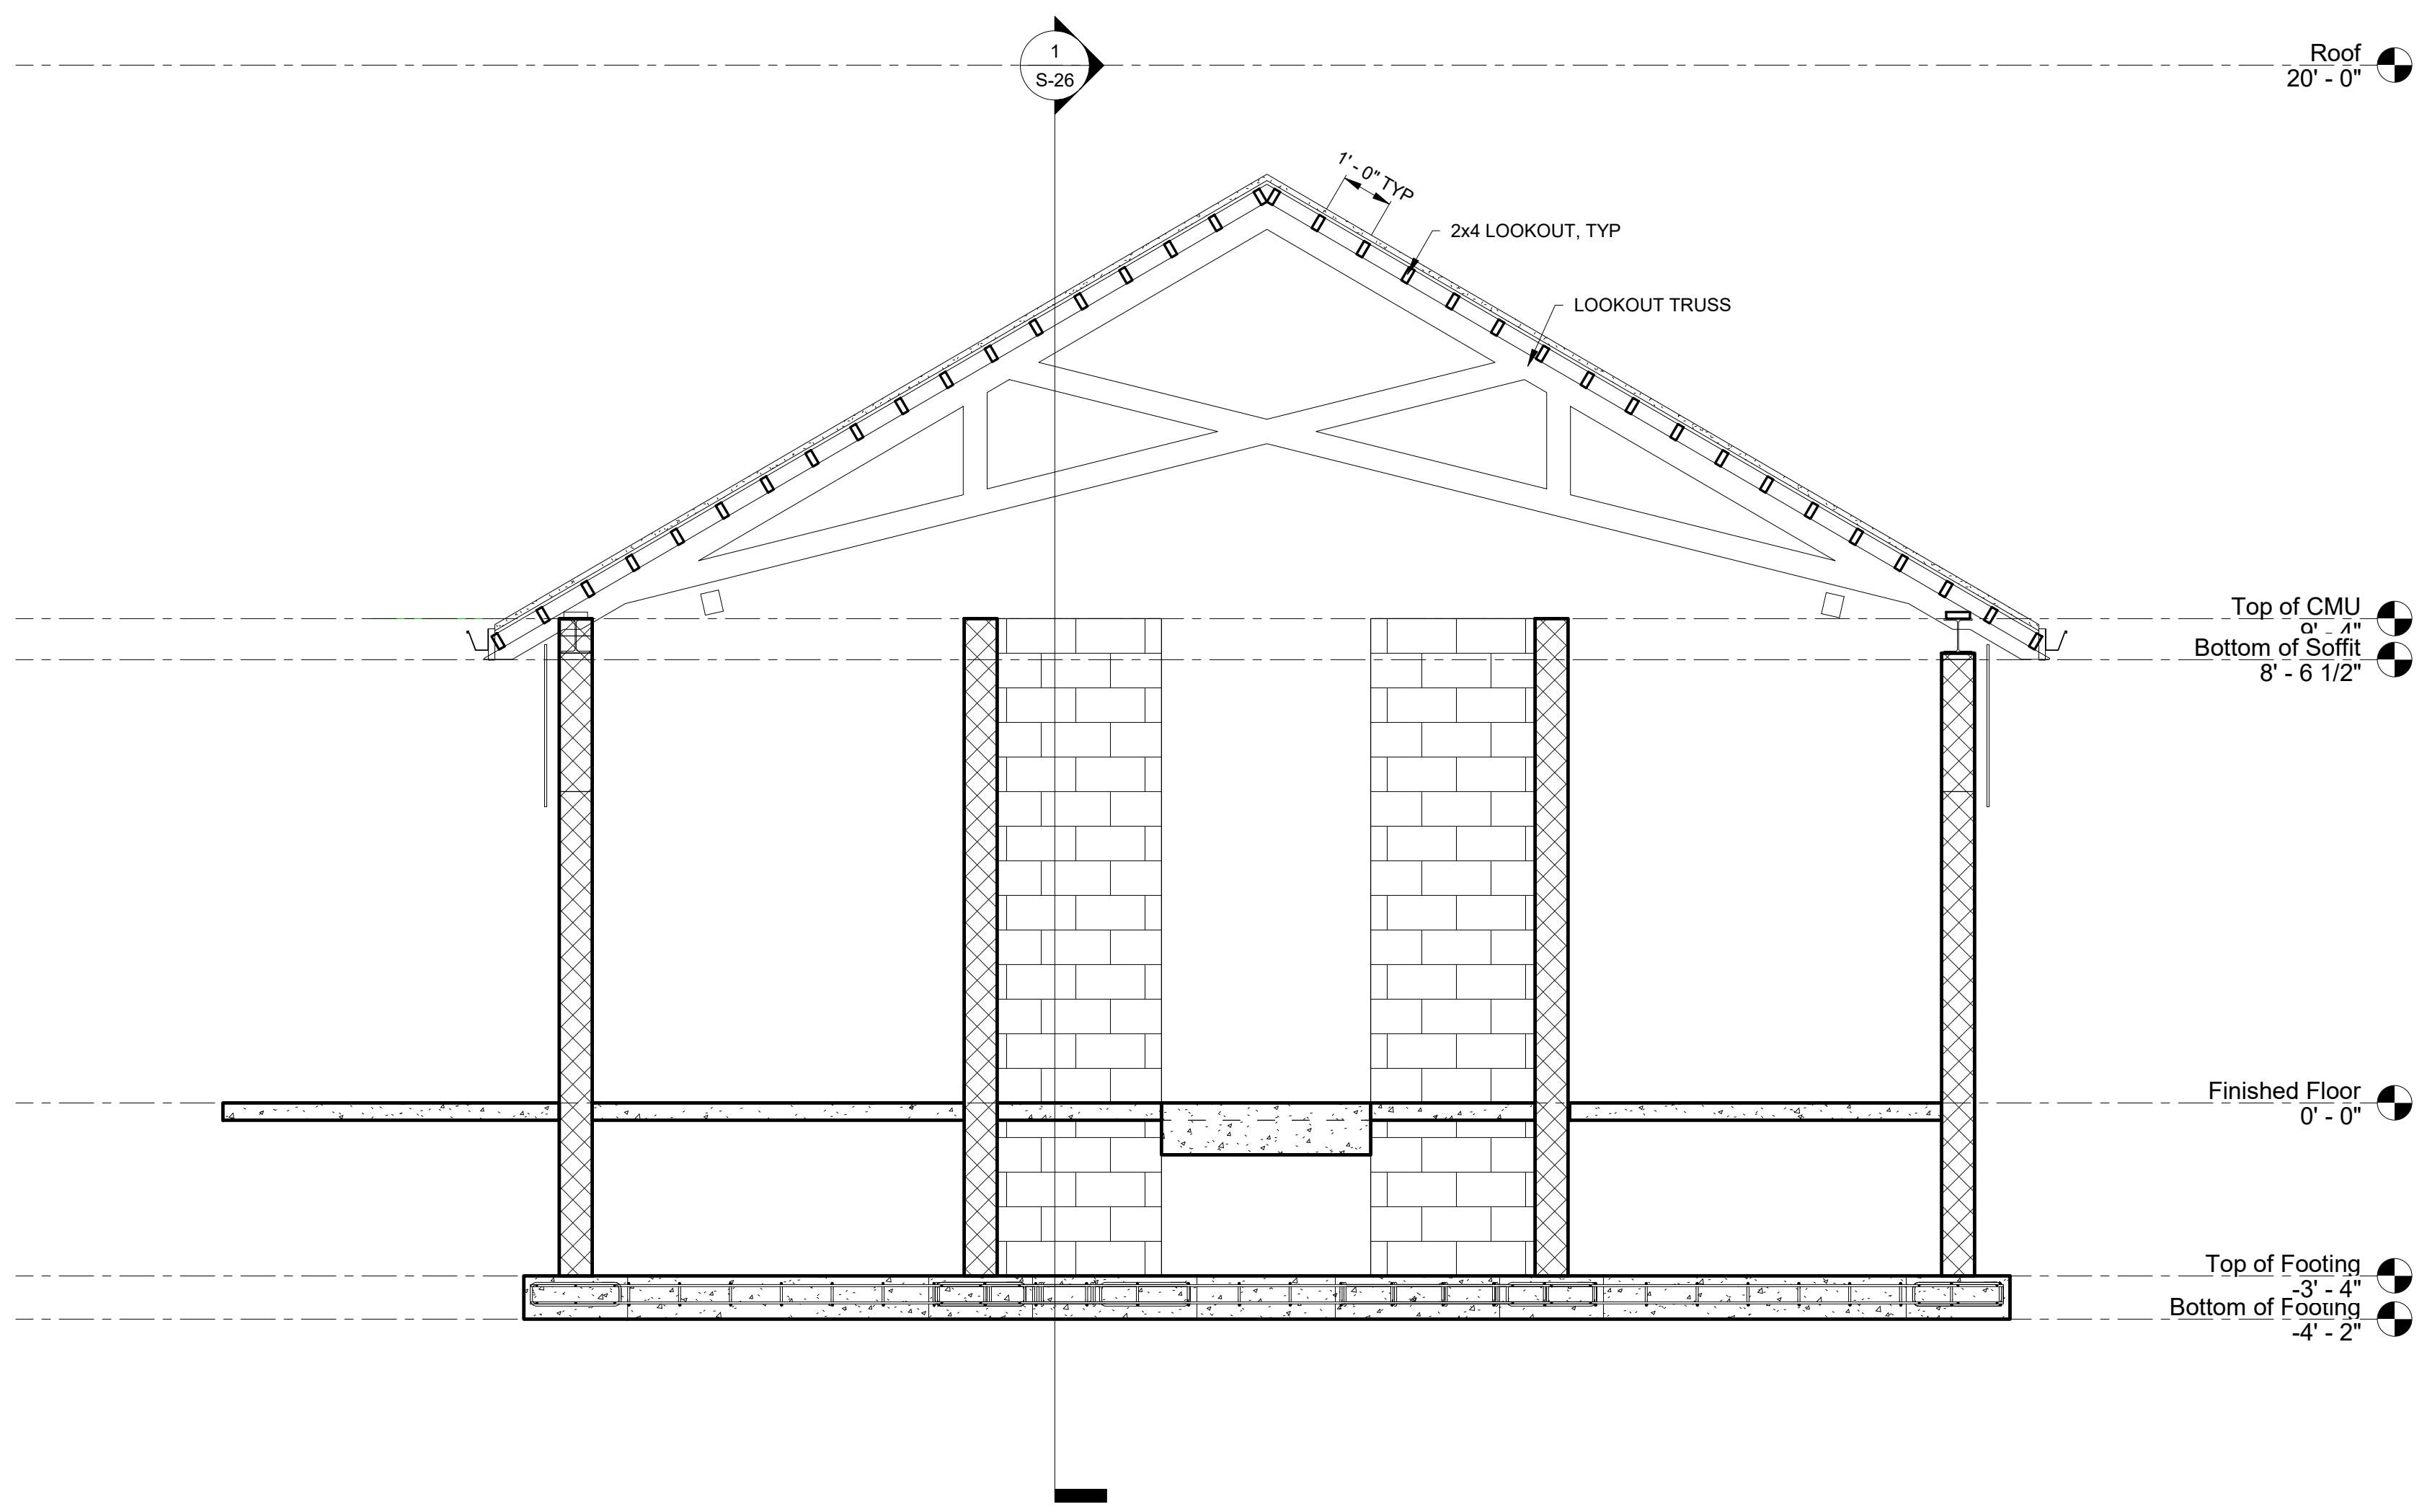

① Group Camp Lookouts
3/8" = 1'-0"

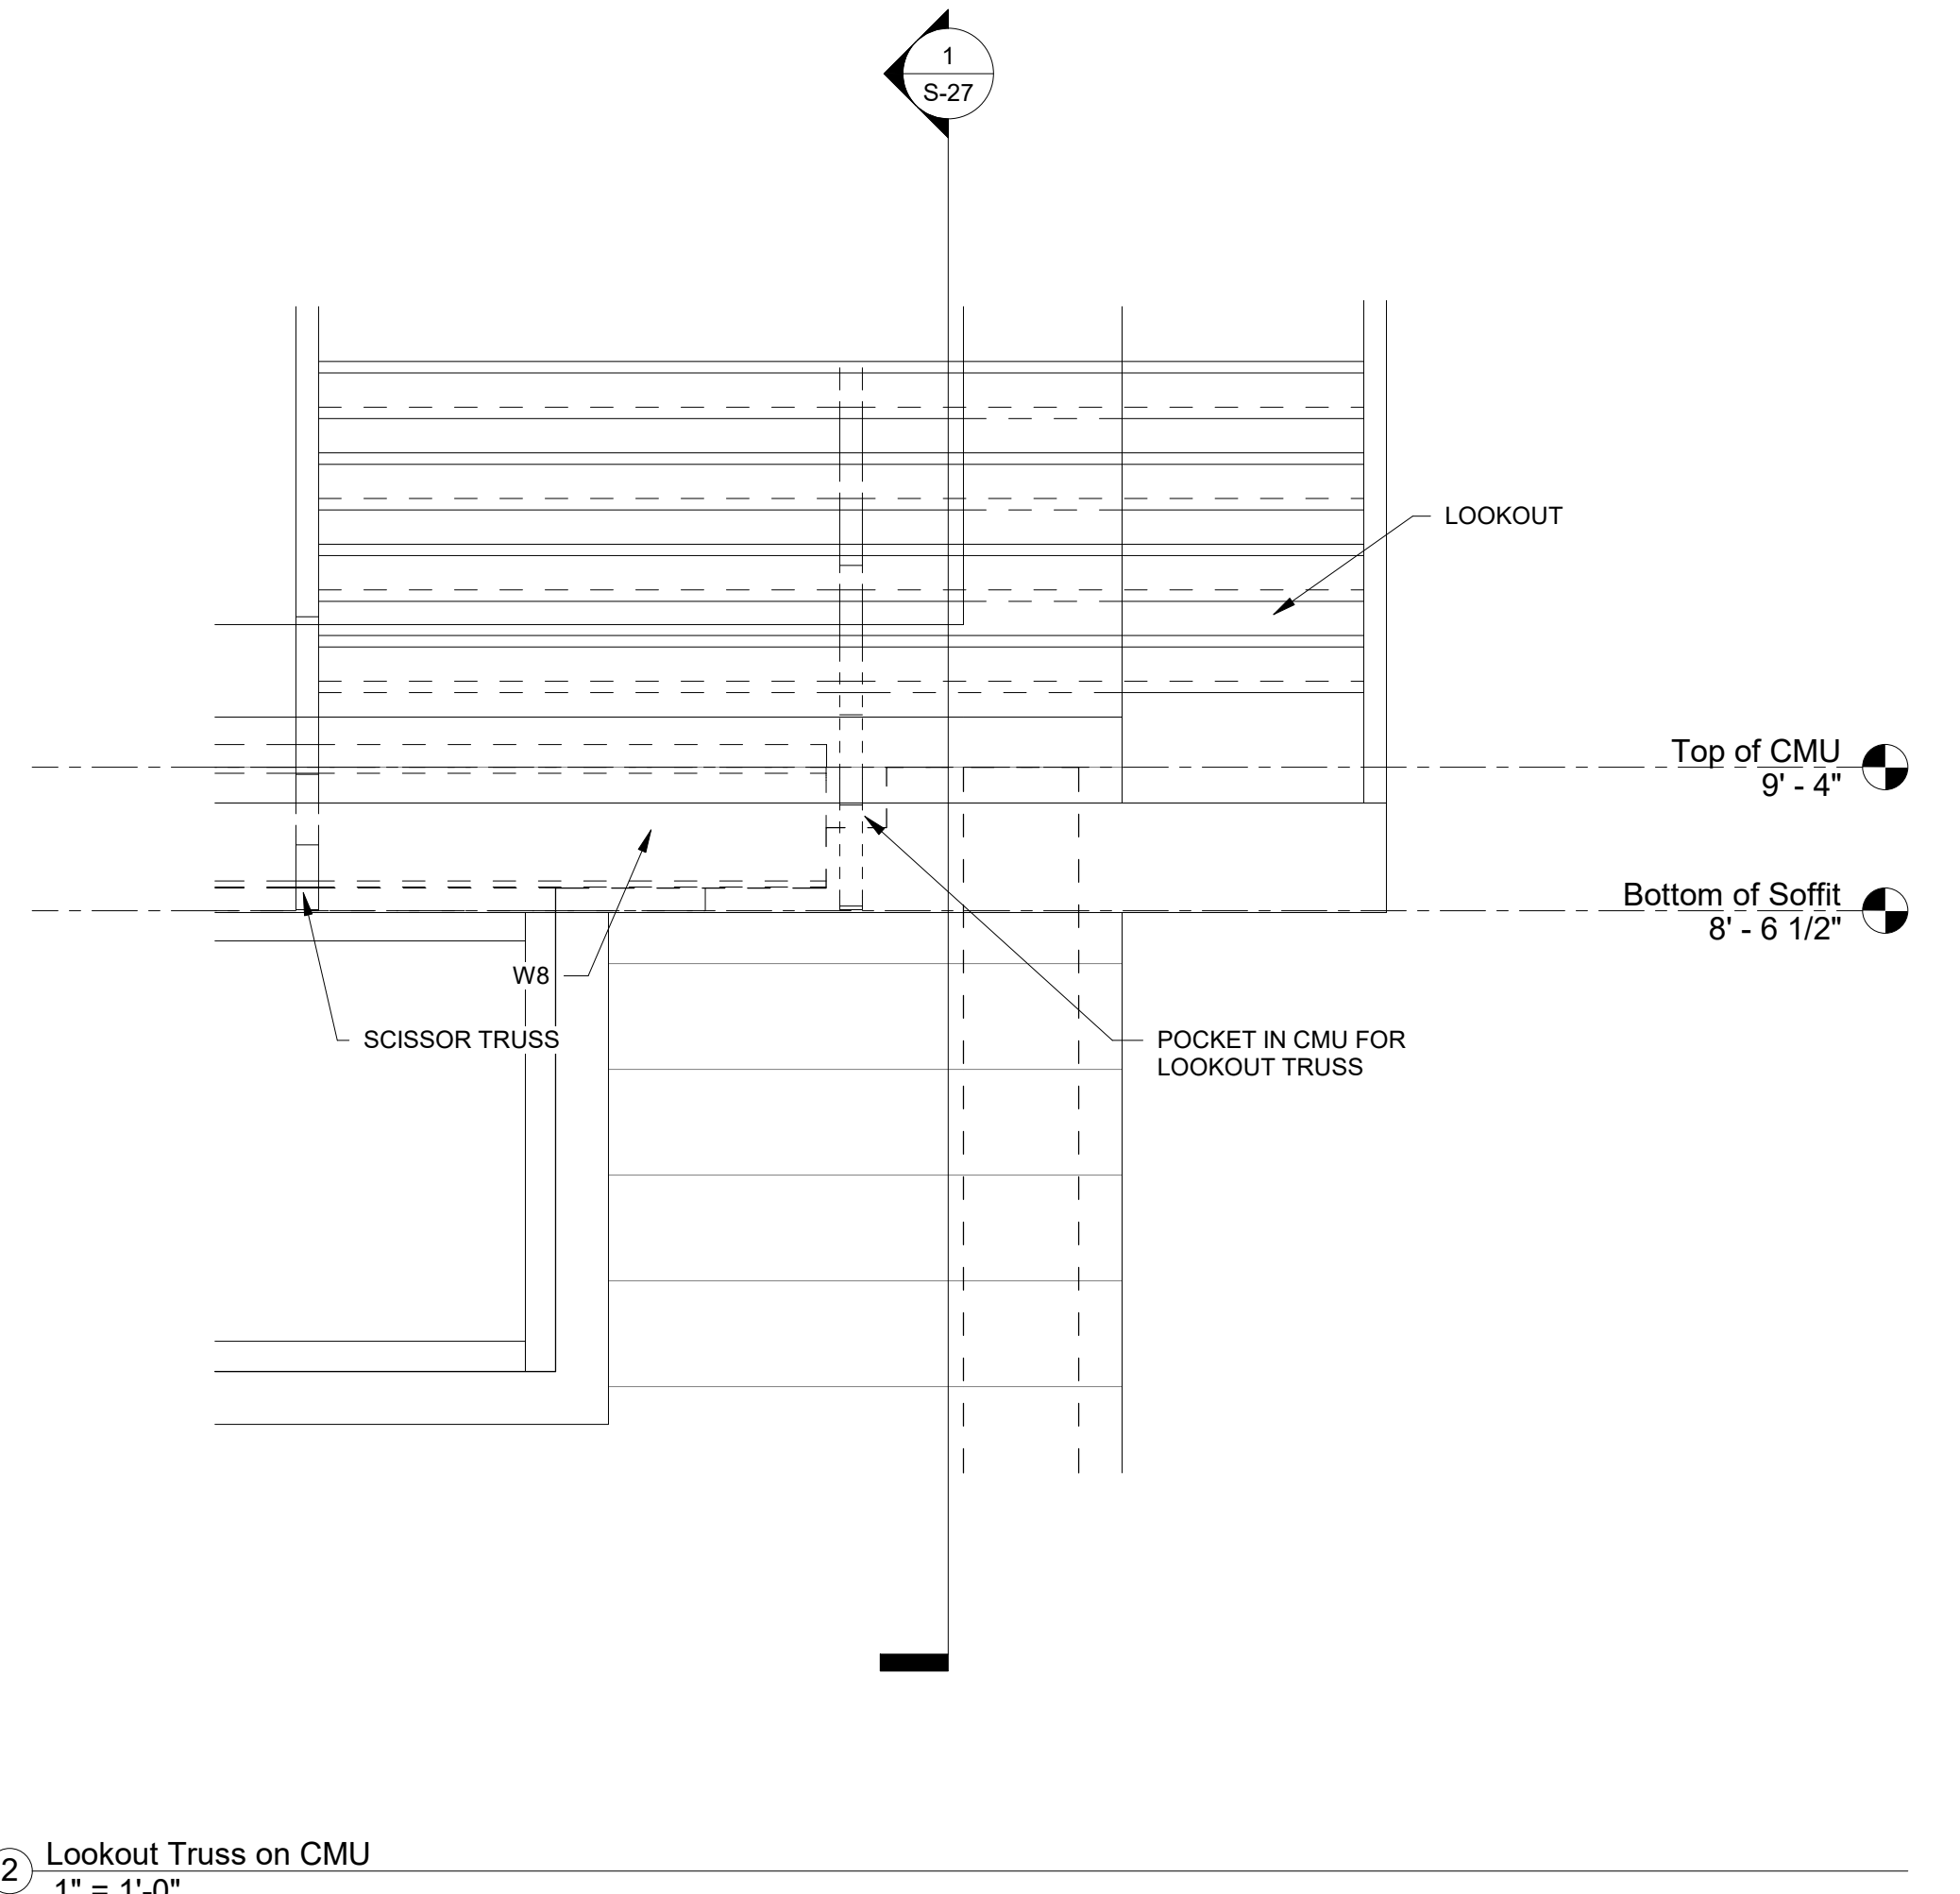

② Lookout Truss on CMU
1" = 1'-0"

NOTE - THIS SHEET SHOWS PLANS AND DETAILS FOR BOTH DADDY ALLEN AND FOR SHEHAQUA. DADDY ALLEN IS BID 3. SHEHAQUA IS BID 2

- NOTES:
1. FOR GENERAL NOTES SEE SHEET S-2
2. FOR SYMBOLS AND ABBREVIATIONS SEE SHEET S-1

VERIFY SCALE	
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DRAWN BY J ADAMS	DATE 06/17/2022	DRAWING No. S-27
CHECKED BY J ADAMS	SCALE AS NOTED	108 OF 144

CONSTRUCTION DOCUMENTS



NO.	REVISIONS


REGISTERED PROFESSIONAL ENGINEER
COMMONWEALTH OF PENNSYLVANIA
JAMES WILLIAM ADAMS
E. PESHAWER
11/19/2021
SIGNATURE DATE

SMP ARCHITECTS
1600 WALNUT STREET, SECOND FLOOR
PHILADELPHIA, PENNSYLVANIA

COMMONWEALTH OF PENNSYLVANIA
DEPARTMENT OF GENERAL SERVICES
HARRISBURG, PENNSYLVANIA

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C-114-0006 PHASE 1

HICKORY RUN STATE PARK
LATRINE IMPROVEMENTS
DEPT of CONSERVATION AND NATURAL RESOURCES
WHITE HAVEN, CARBON COUNTY, PA
GROUP CAMP SECTIONS, SHEET 3

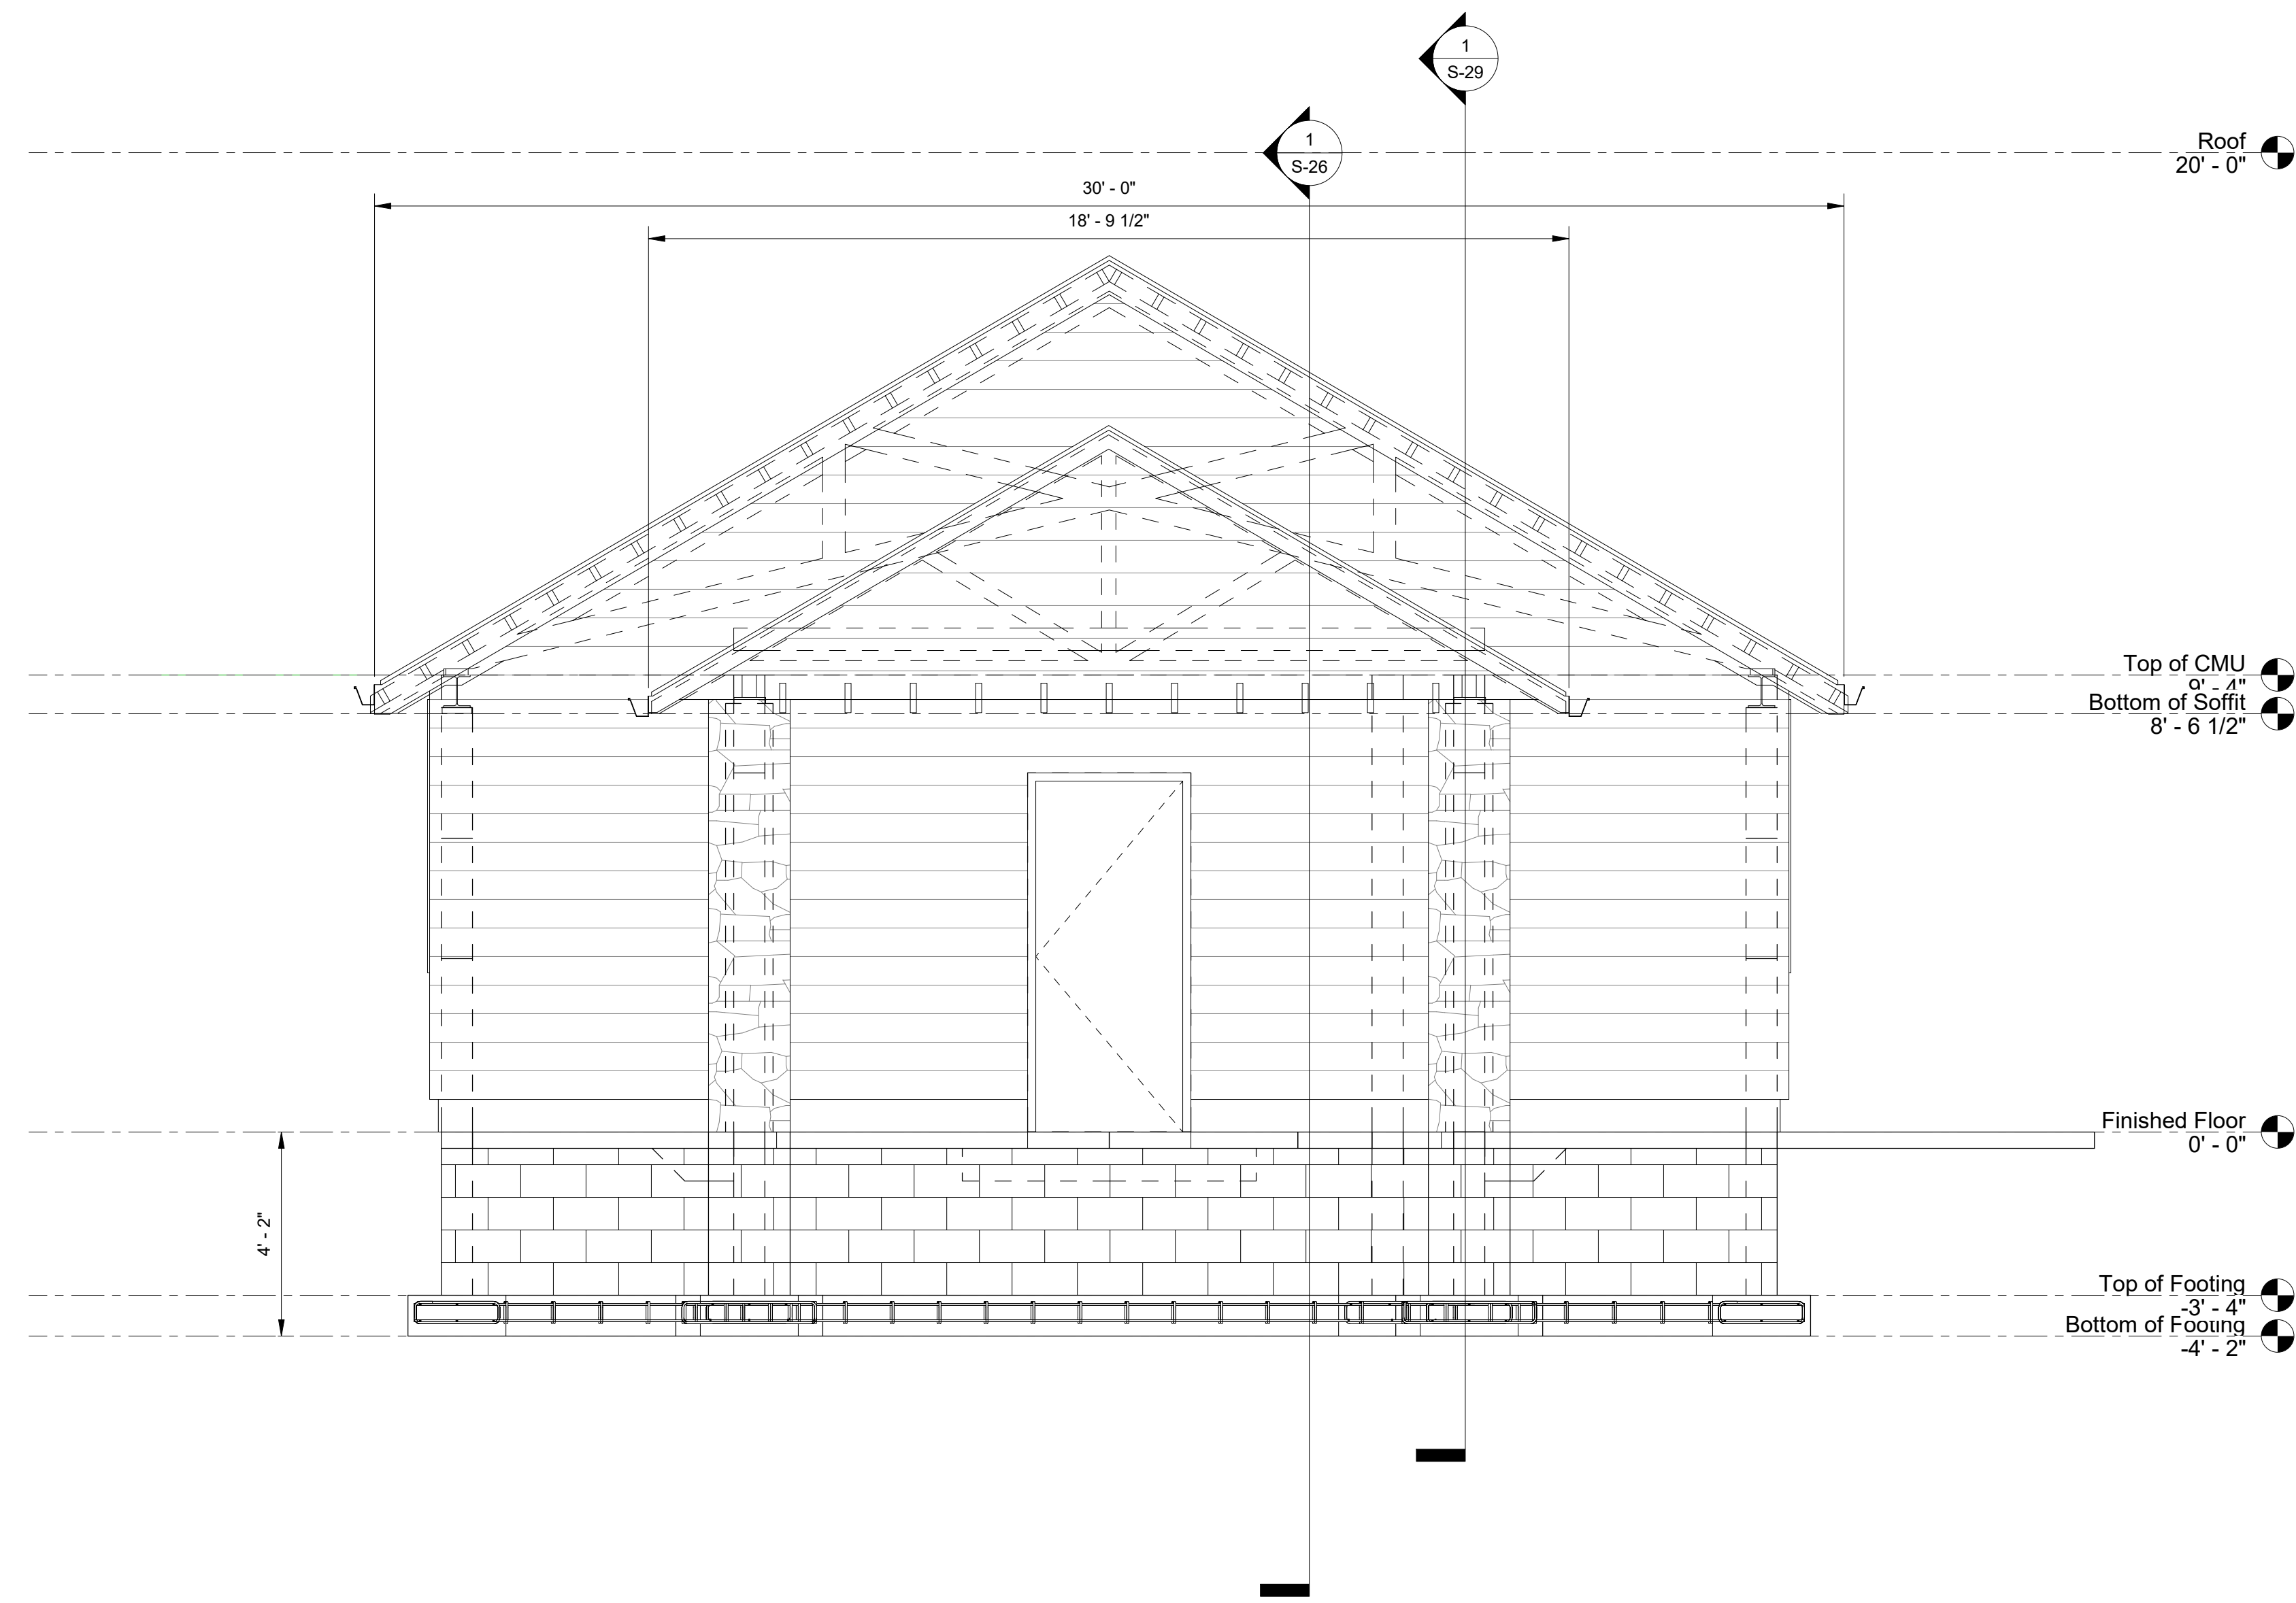

1 Section 58
3/8" = 1'-0"

NOTE - THIS SHEET SHOWS PLANS AND DETAILS FOR BOTH DADDY ALLEN AND FOR SHEHAQUA. DADDY ALLEN IS BID 3. SHEHAQUA IS BID 2

- NOTES:
 1. FOR GENERAL NOTES SEE SHEET S-2
 2. FOR SYMBOLS AND ABBREVIATIONS SEE SHEET S-1

VERIFY SCALE		
BAR IS ONE (1) INCH LONG		
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DRAWN BY J ADAMS	DATE 06/17/2022	DRAWING No. S-28
CHECKED BY J ADAMS	SCALE AS NOTED	

CONSTRUCTION DOCUMENTS



NO.	DATE	REVISIONS

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James W. Adams
SIGNATURE DATE 11/19/2021


SMP ARCHITECTS
 1600 WALNUT STREET, SECOND FLOOR
 PHILADELPHIA, PENNSYLVANIA

COMMONWEALTH OF PENNSYLVANIA
 DEPARTMENT OF GENERAL SERVICES
 HARRISBURG, PENNSYLVANIA

D.G.S. PROJECT No.
 C-114-0006 PHASE 1

HICKORY RUN STATE PARK
 LATRINE IMPROVEMENTS
 DEPT of CONSERVATION AND NATURAL RESOURCES
 WHITE HAVEN, CARBON COUNTY, PA

GROUP CAMP DETAILS, SHEET 1

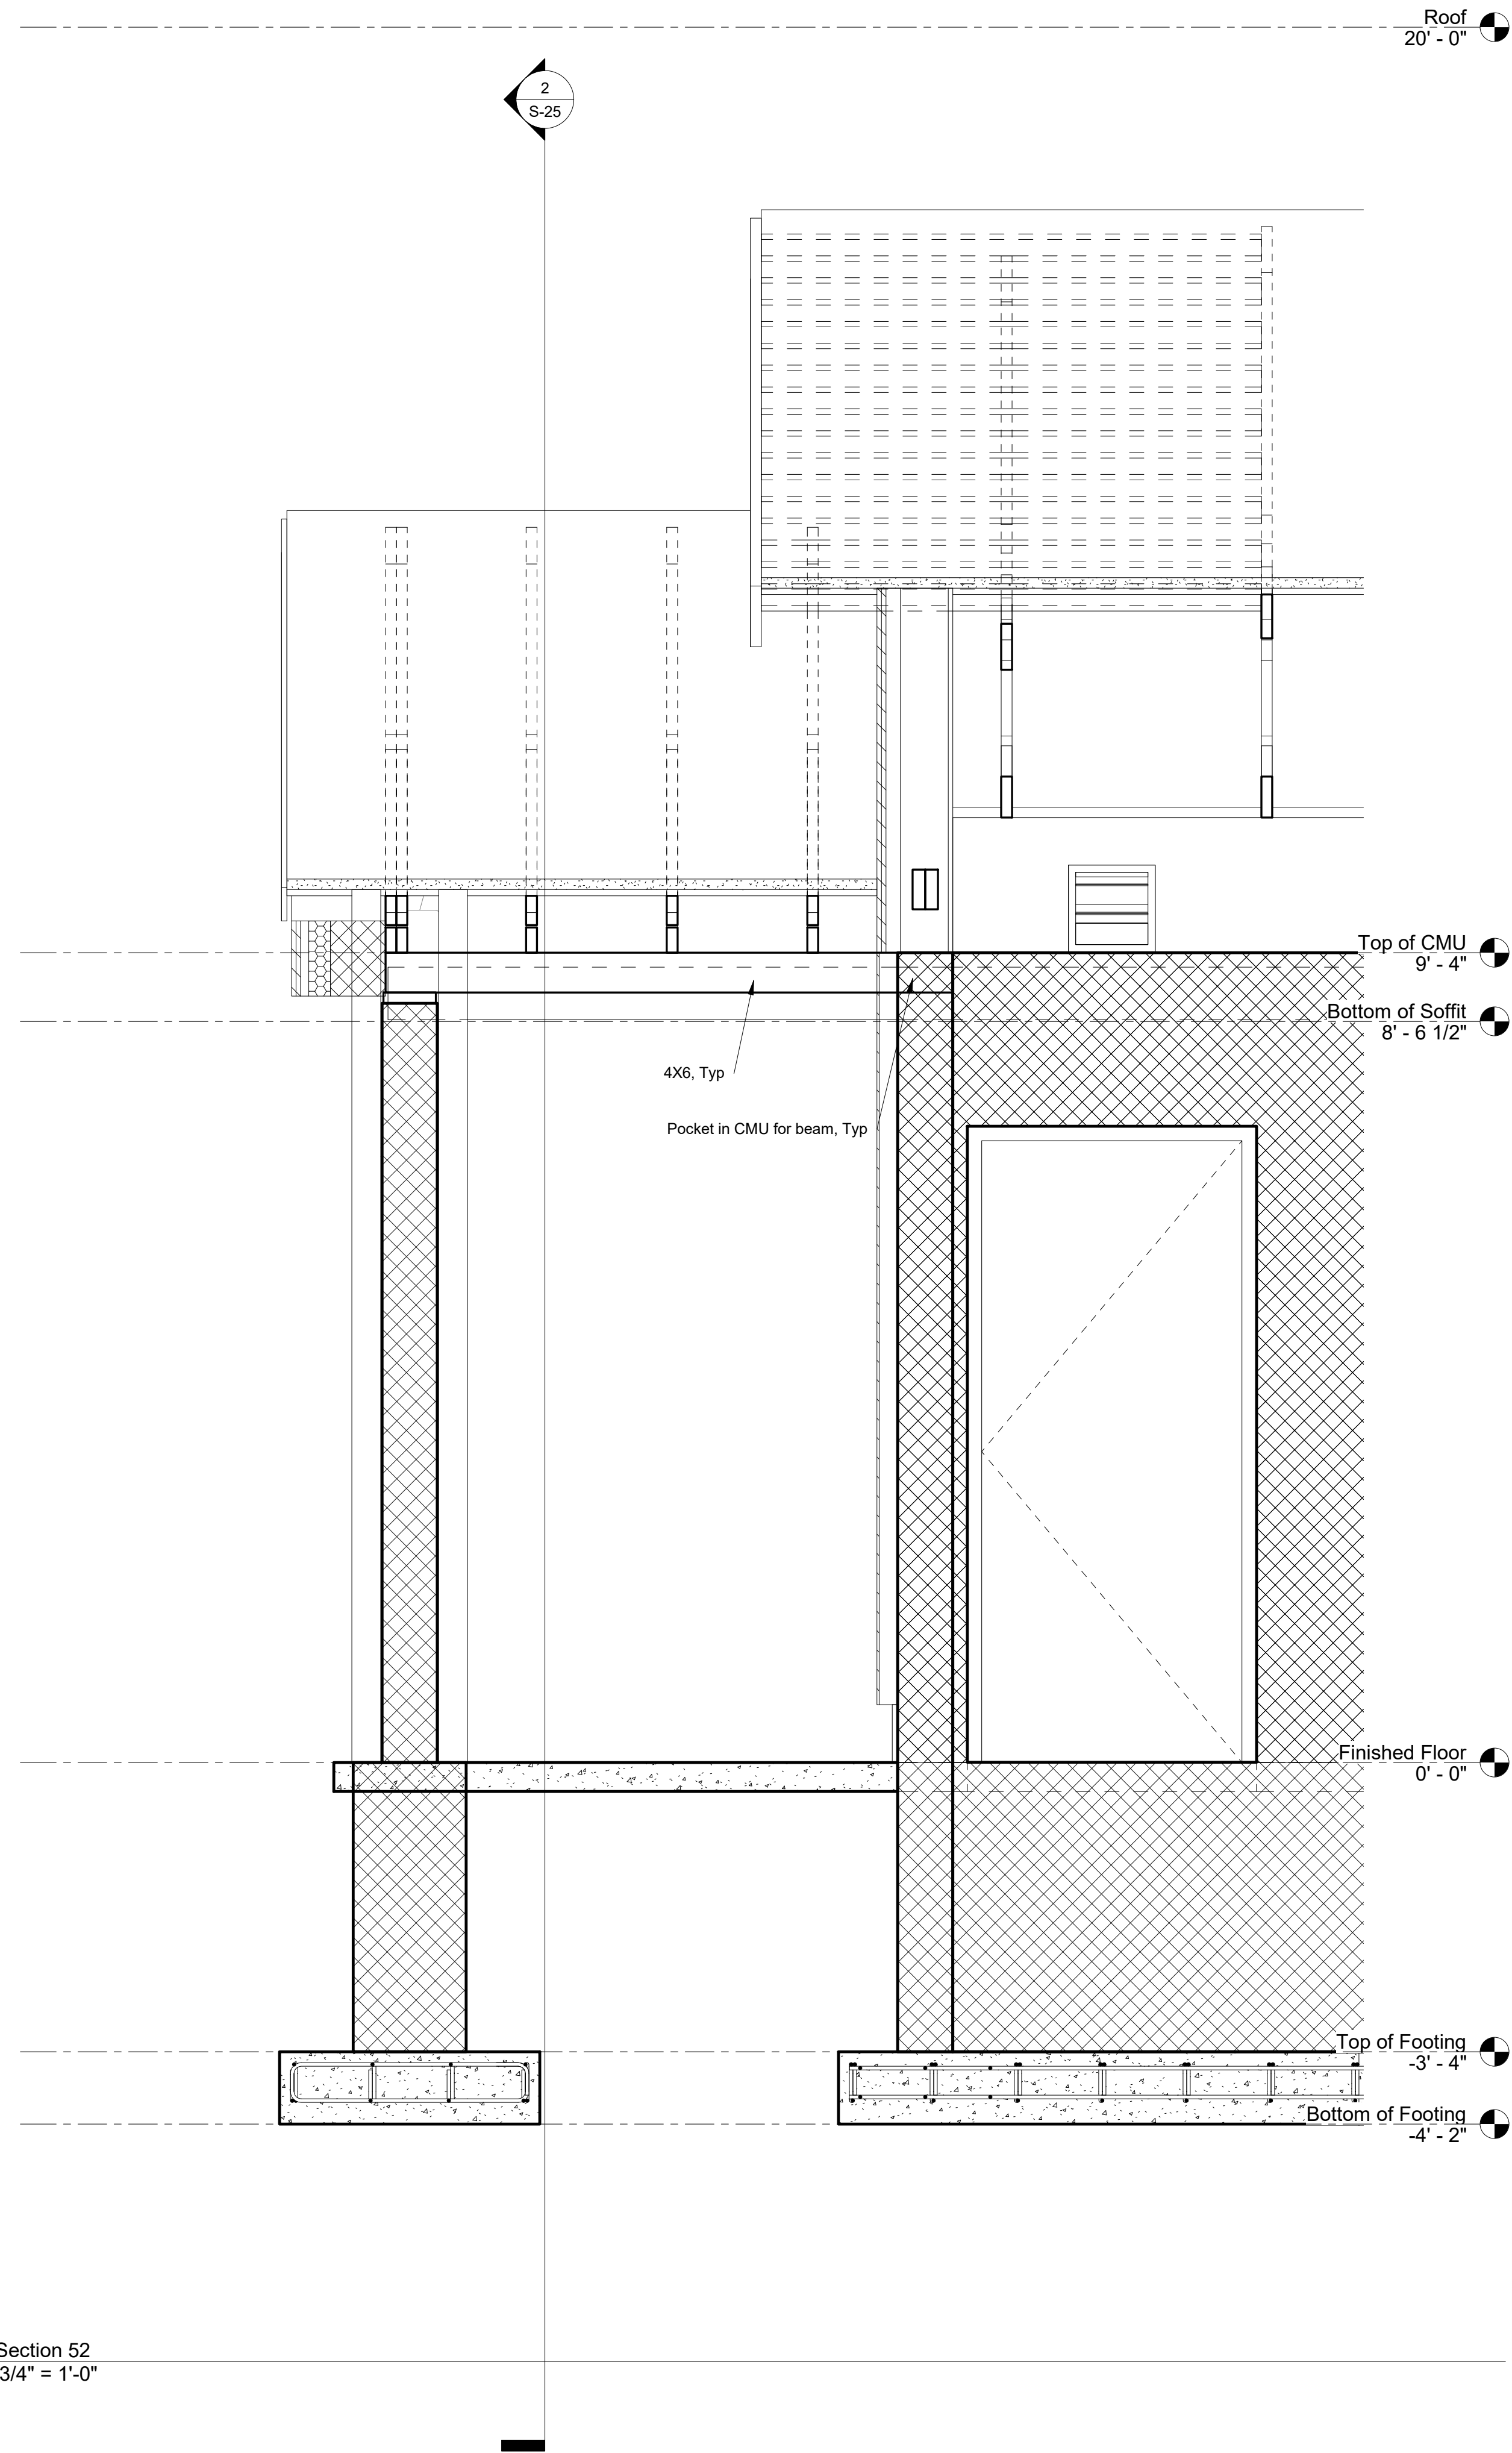

1 Section 52
3/4" = 1'-0"

NOTE - THIS SHEET SHOWS PLANS AND DETAILS FOR BOTH DADDY ALLEN AND FOR SHEHAQUA. DADDY ALLEN IS BID 3. SHEHAQUA IS BID 2

NOTES:
1. FOR GENERAL NOTES SEE SHEET S-2
2. FOR SYMBOLS AND ABBREVIATIONS SEE SHEET S-1

VERIFY SCALE

BAR IS ONE (1) INCH LONG
ON ORIGINAL DRAWING: 0 1

IF BAR IS NOT ONE (1) INCH LONG, ADJUST SCALE ACCORDINGLY

CONTRACTOR SHALL FIELD VERIFY ALL DIMENSIONS
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CONTRACTOR SHALL FIELD VERIFY ALL DIMENSIONS VARIANCE FROM CONTRACT DOCUMENTS NOT PERMITTED WITHOUT PROFESSIONAL & BUREAU OF CONSTRUCTION APPROVAL.	DRAWN BY J ADAMS	DATE 06/17/2022	DRAWING No. S-29
	CHECKED BY J ADAMS	SCALE AS NOTED	110 OF 144

CONSTRUCTION DOCUMENTS

meliora

259 MORGAN STREET, PHOENIXVILLE, PA 19460
(610) 933-0123 melioradesign.com

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James W. Adams 11/19/2021
SIGNATURE DATE

SMP ARCHITECTS
1600 WALNUT STREET, SECOND FLOOR
PHILADELPHIA, PENNSYLVANIA

COMMONWEALTH OF PENNSYLVANIA
DEPARTMENT OF GENERAL SERVICES
HARRISBURG, PENNSYLVANIA


D.G.S. PROJECT No.
C-114-0006 PHASE 1

HICKORY RUN STATE PARK
LATRINE IMPROVEMENTS


DEPT of CONSERVATION AND NATURAL RESOURCES
WHITE HAVEN, CARBON COUNTY, PA

GROUP CAMP DETAILS, SHEET 2


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3 16" Wall Foundation
3/4" = 1'-0"

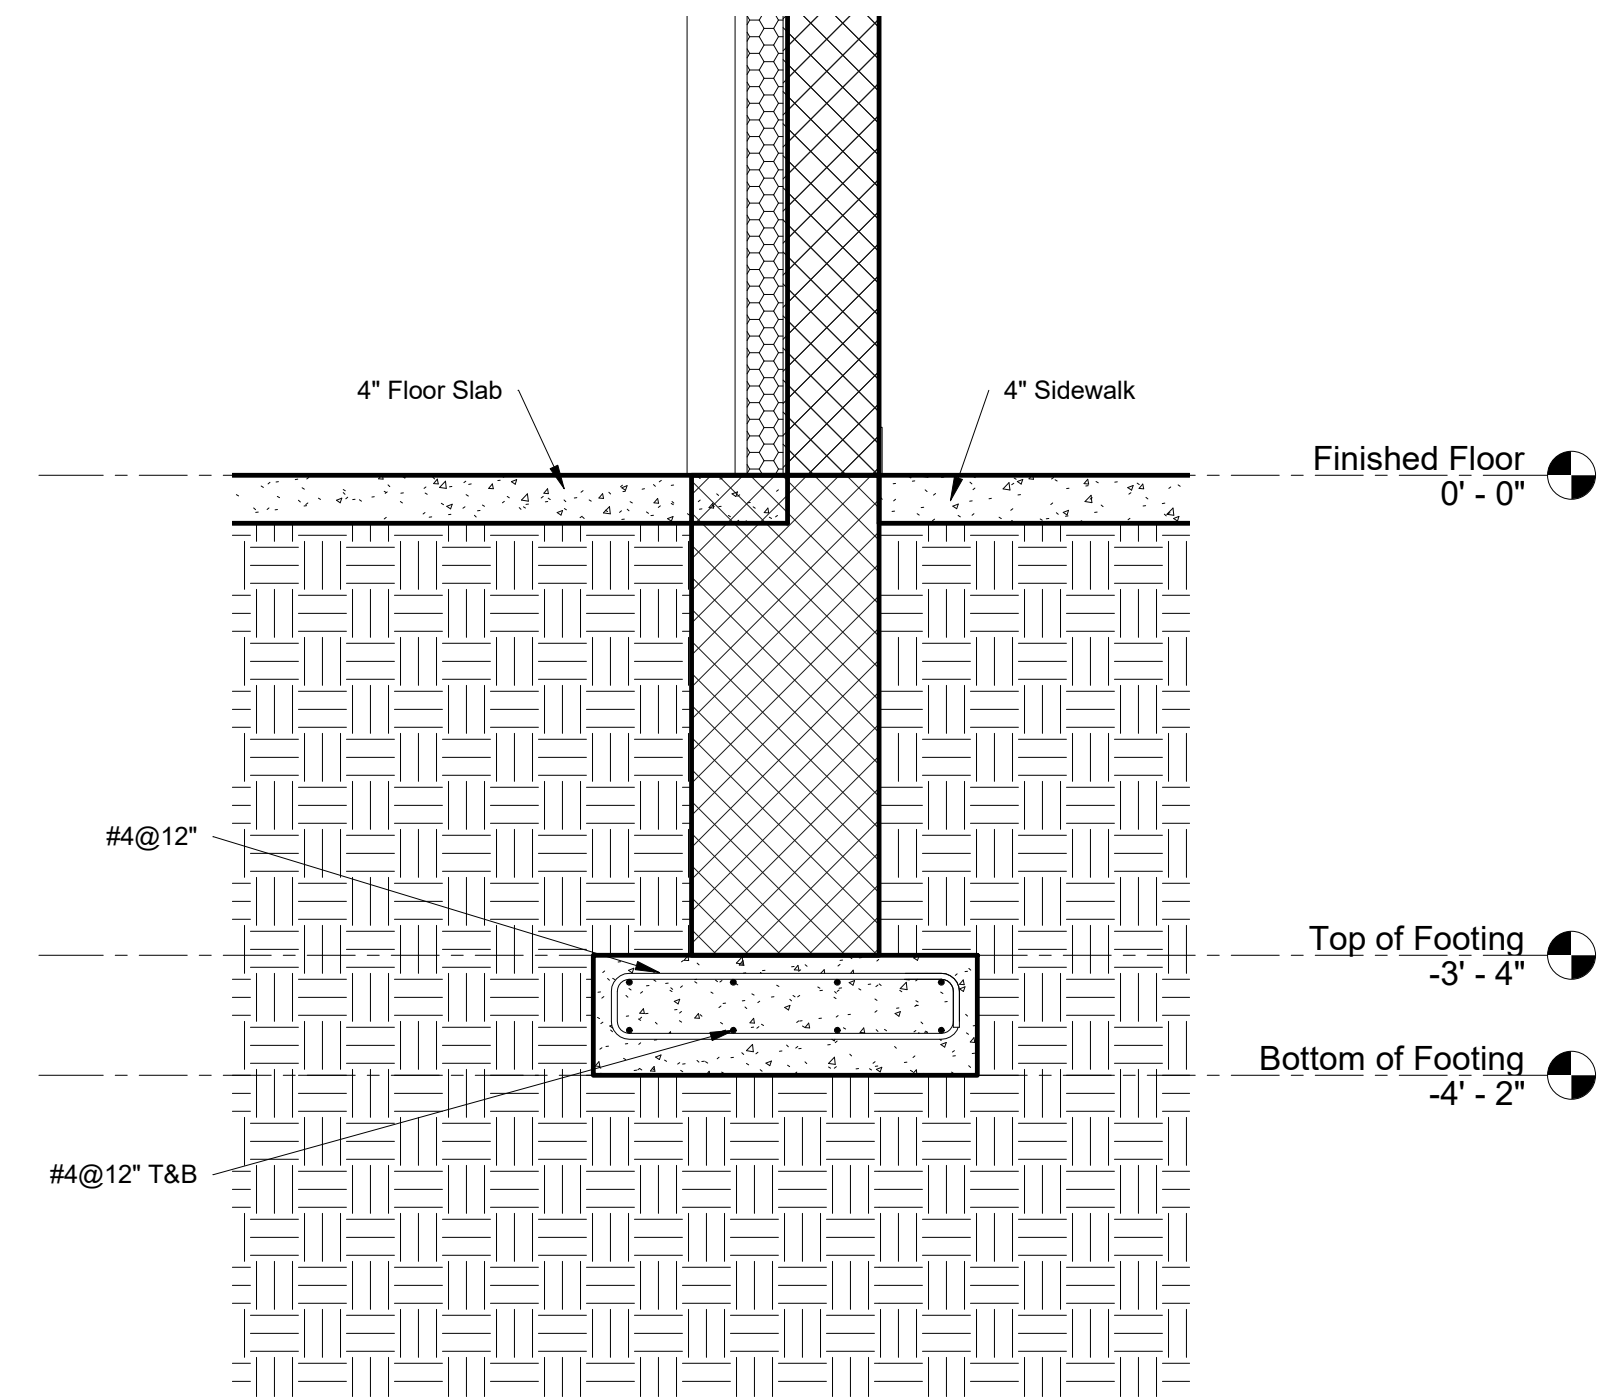


4 8" Wall Foundation
3/4" = 1'-0"

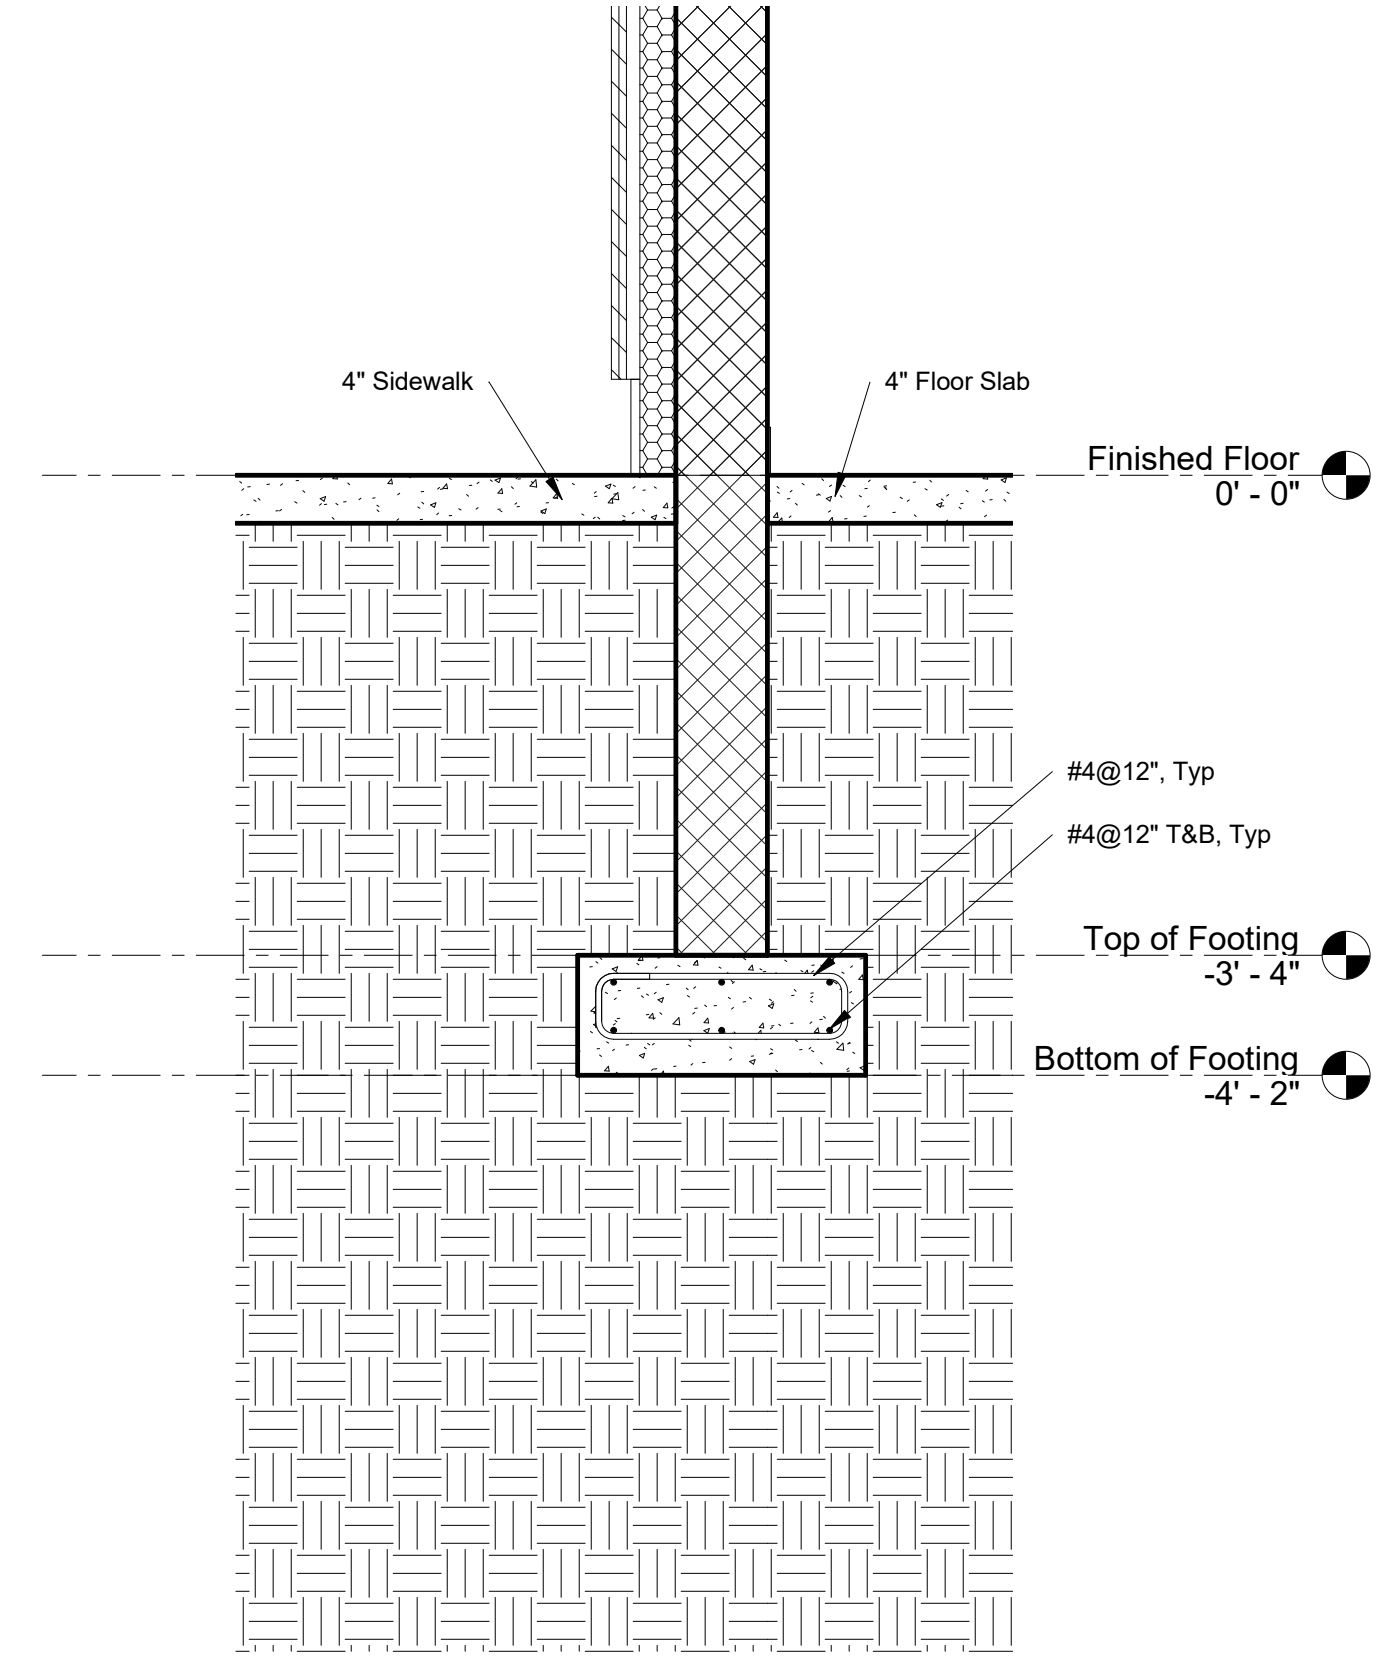


5 Interior Wall Foundation
3/4" = 1'-0"

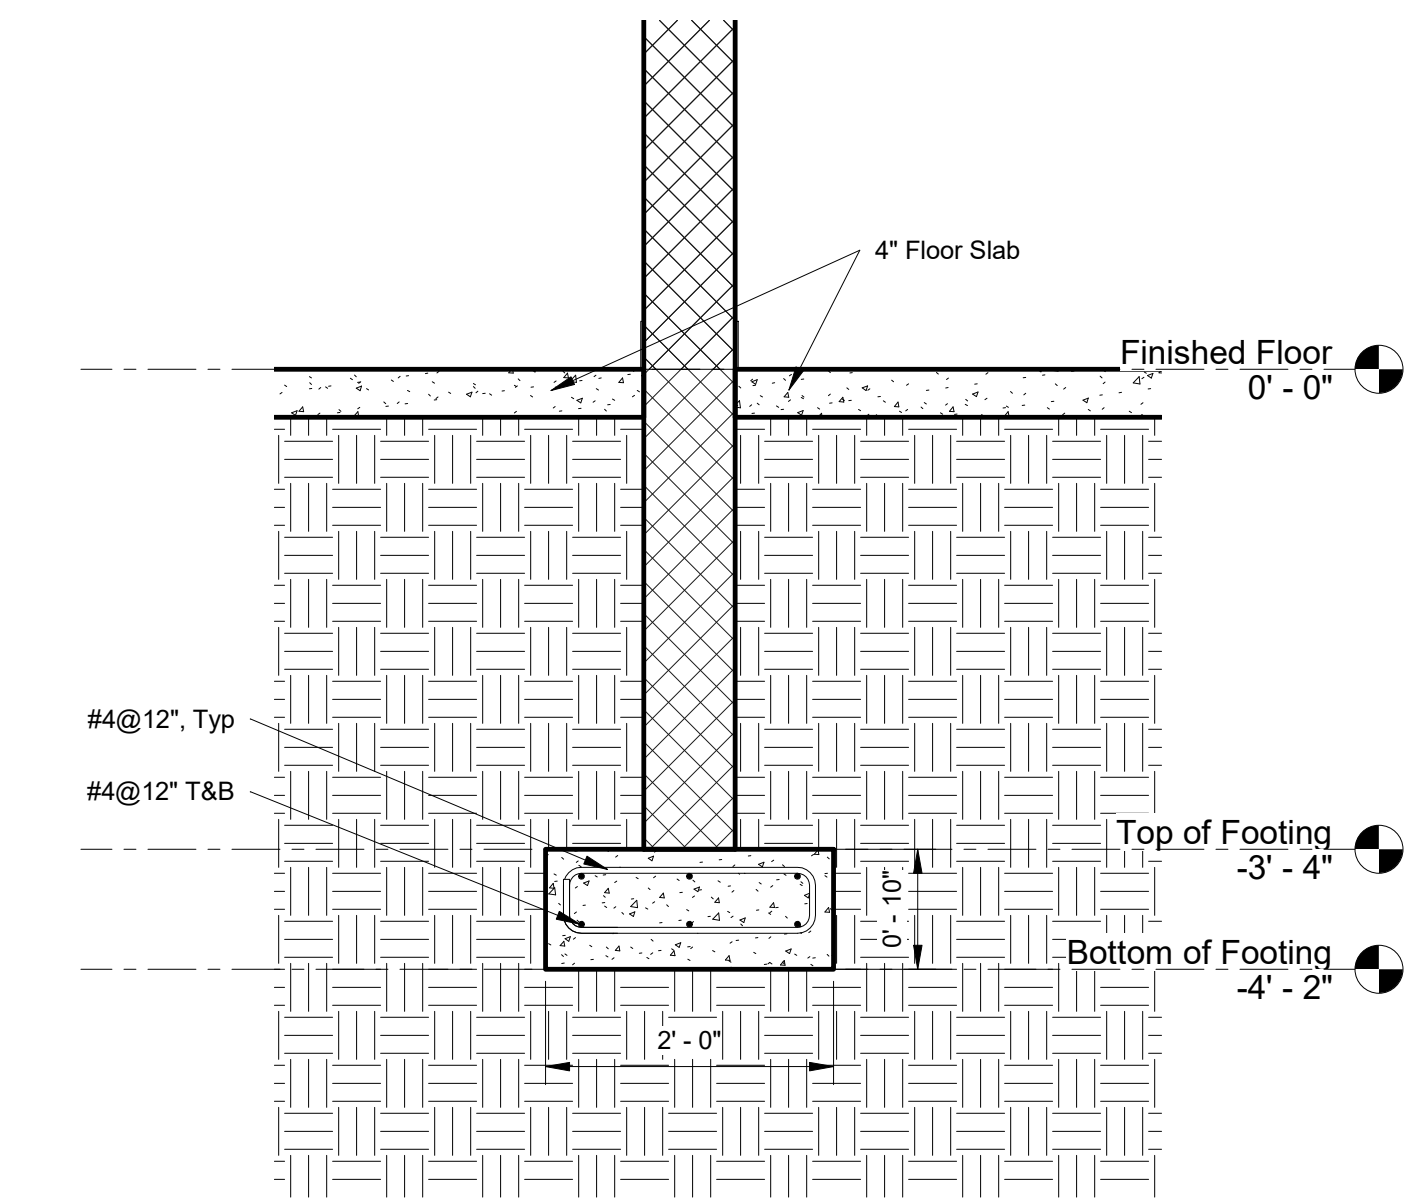
Note: All Foundations Walls shall be filled solid and have #4@16" vertical steel

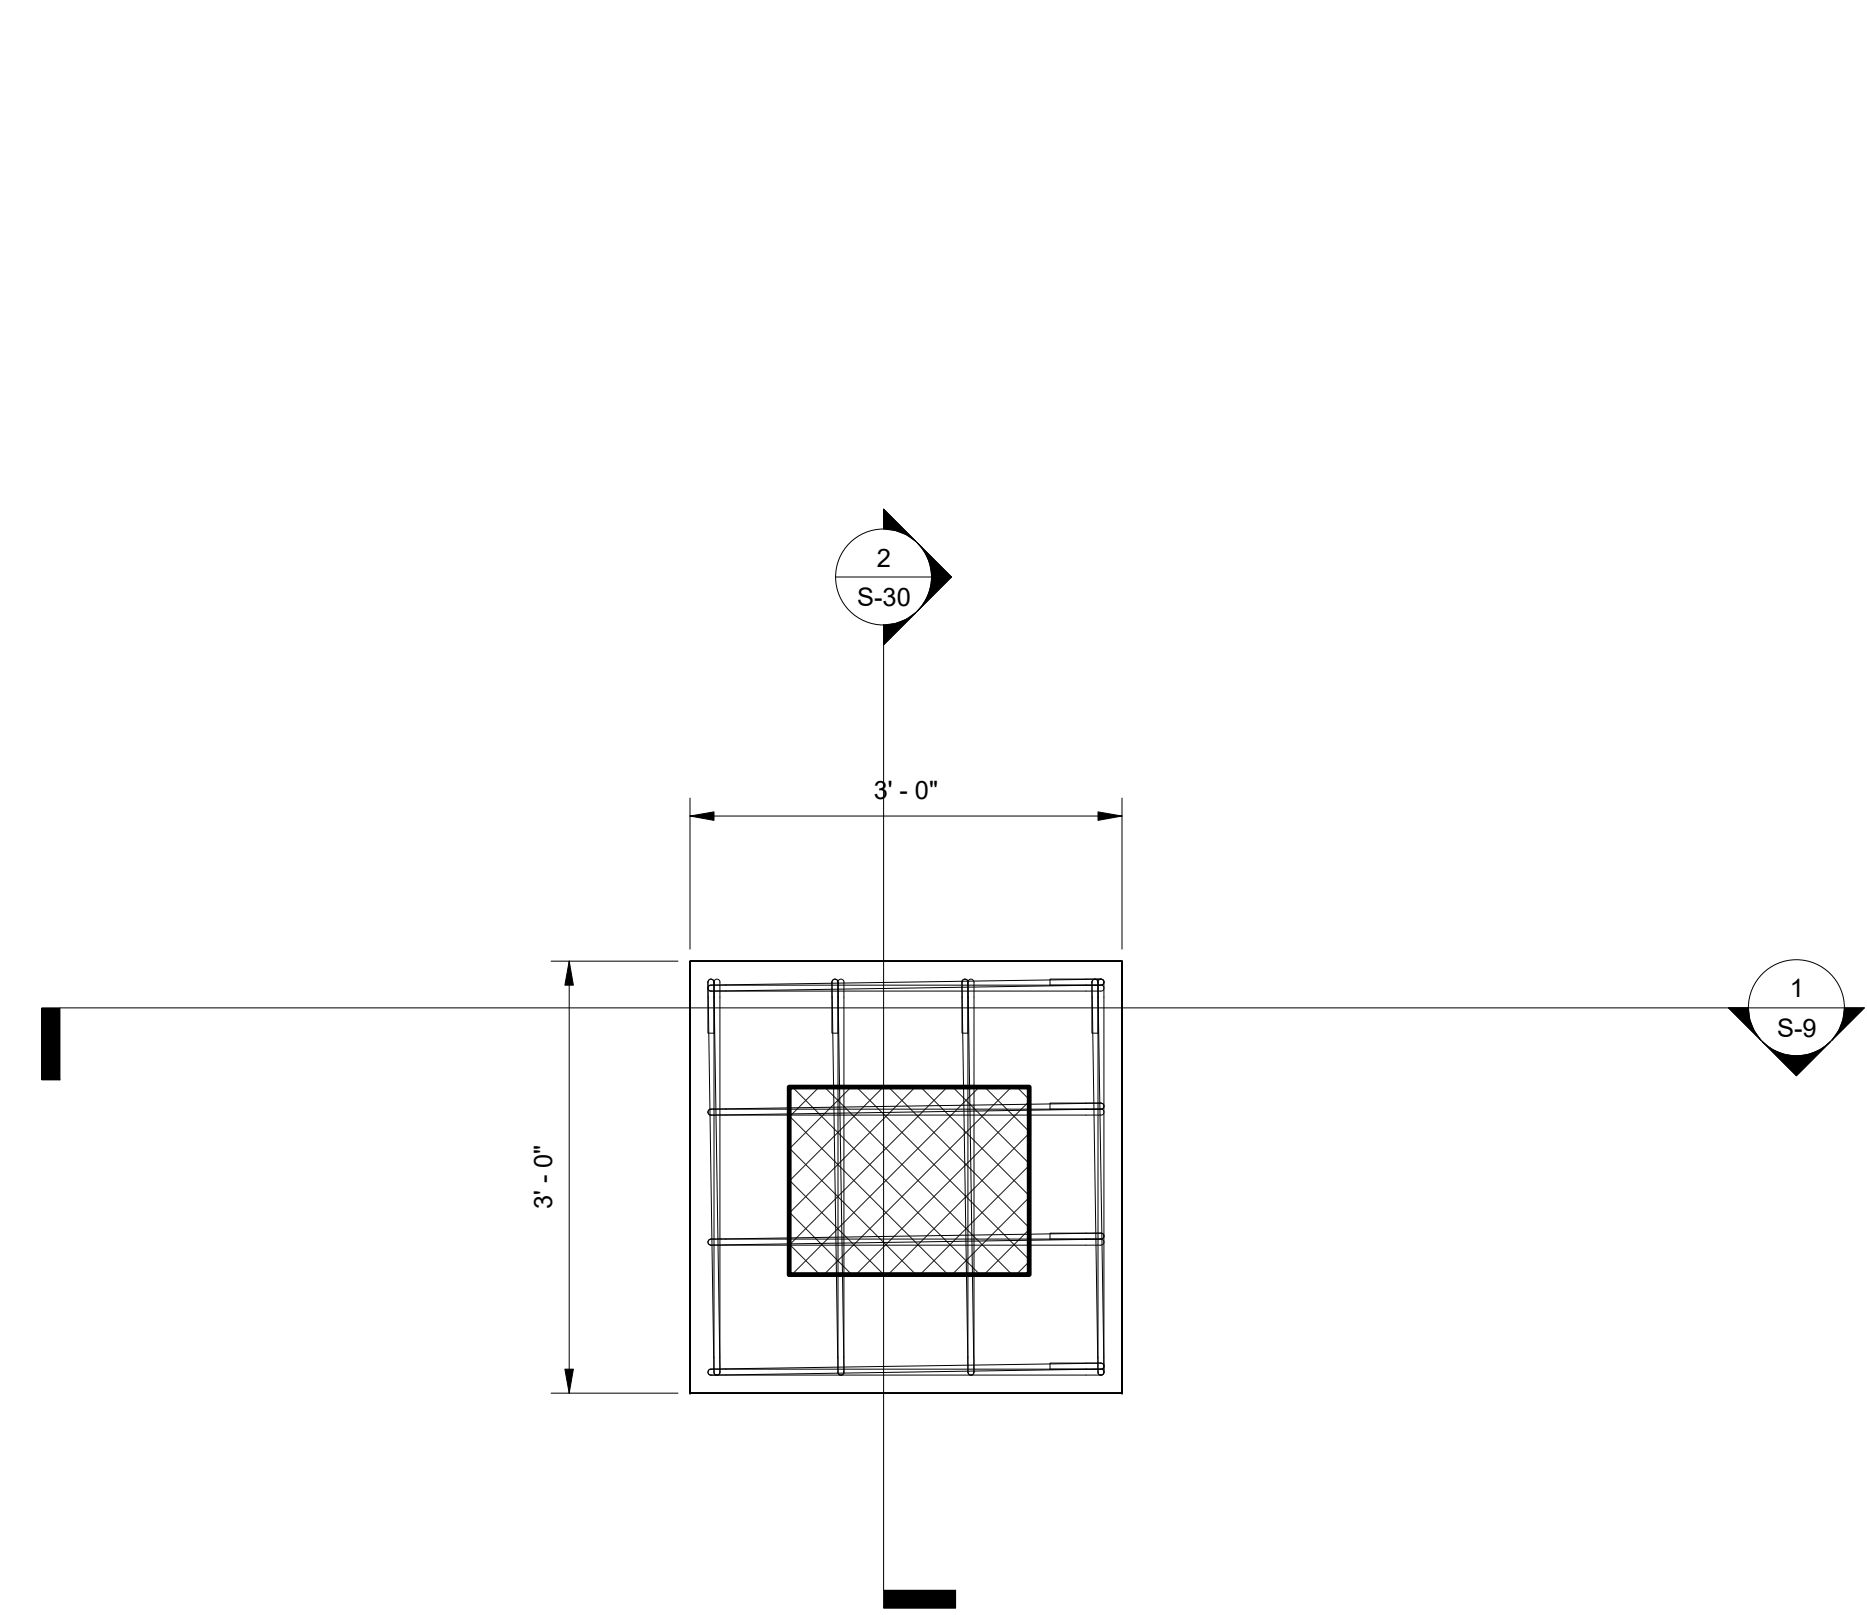

1 Column Spread Footing - Loop C
3/4" = 1'-0"

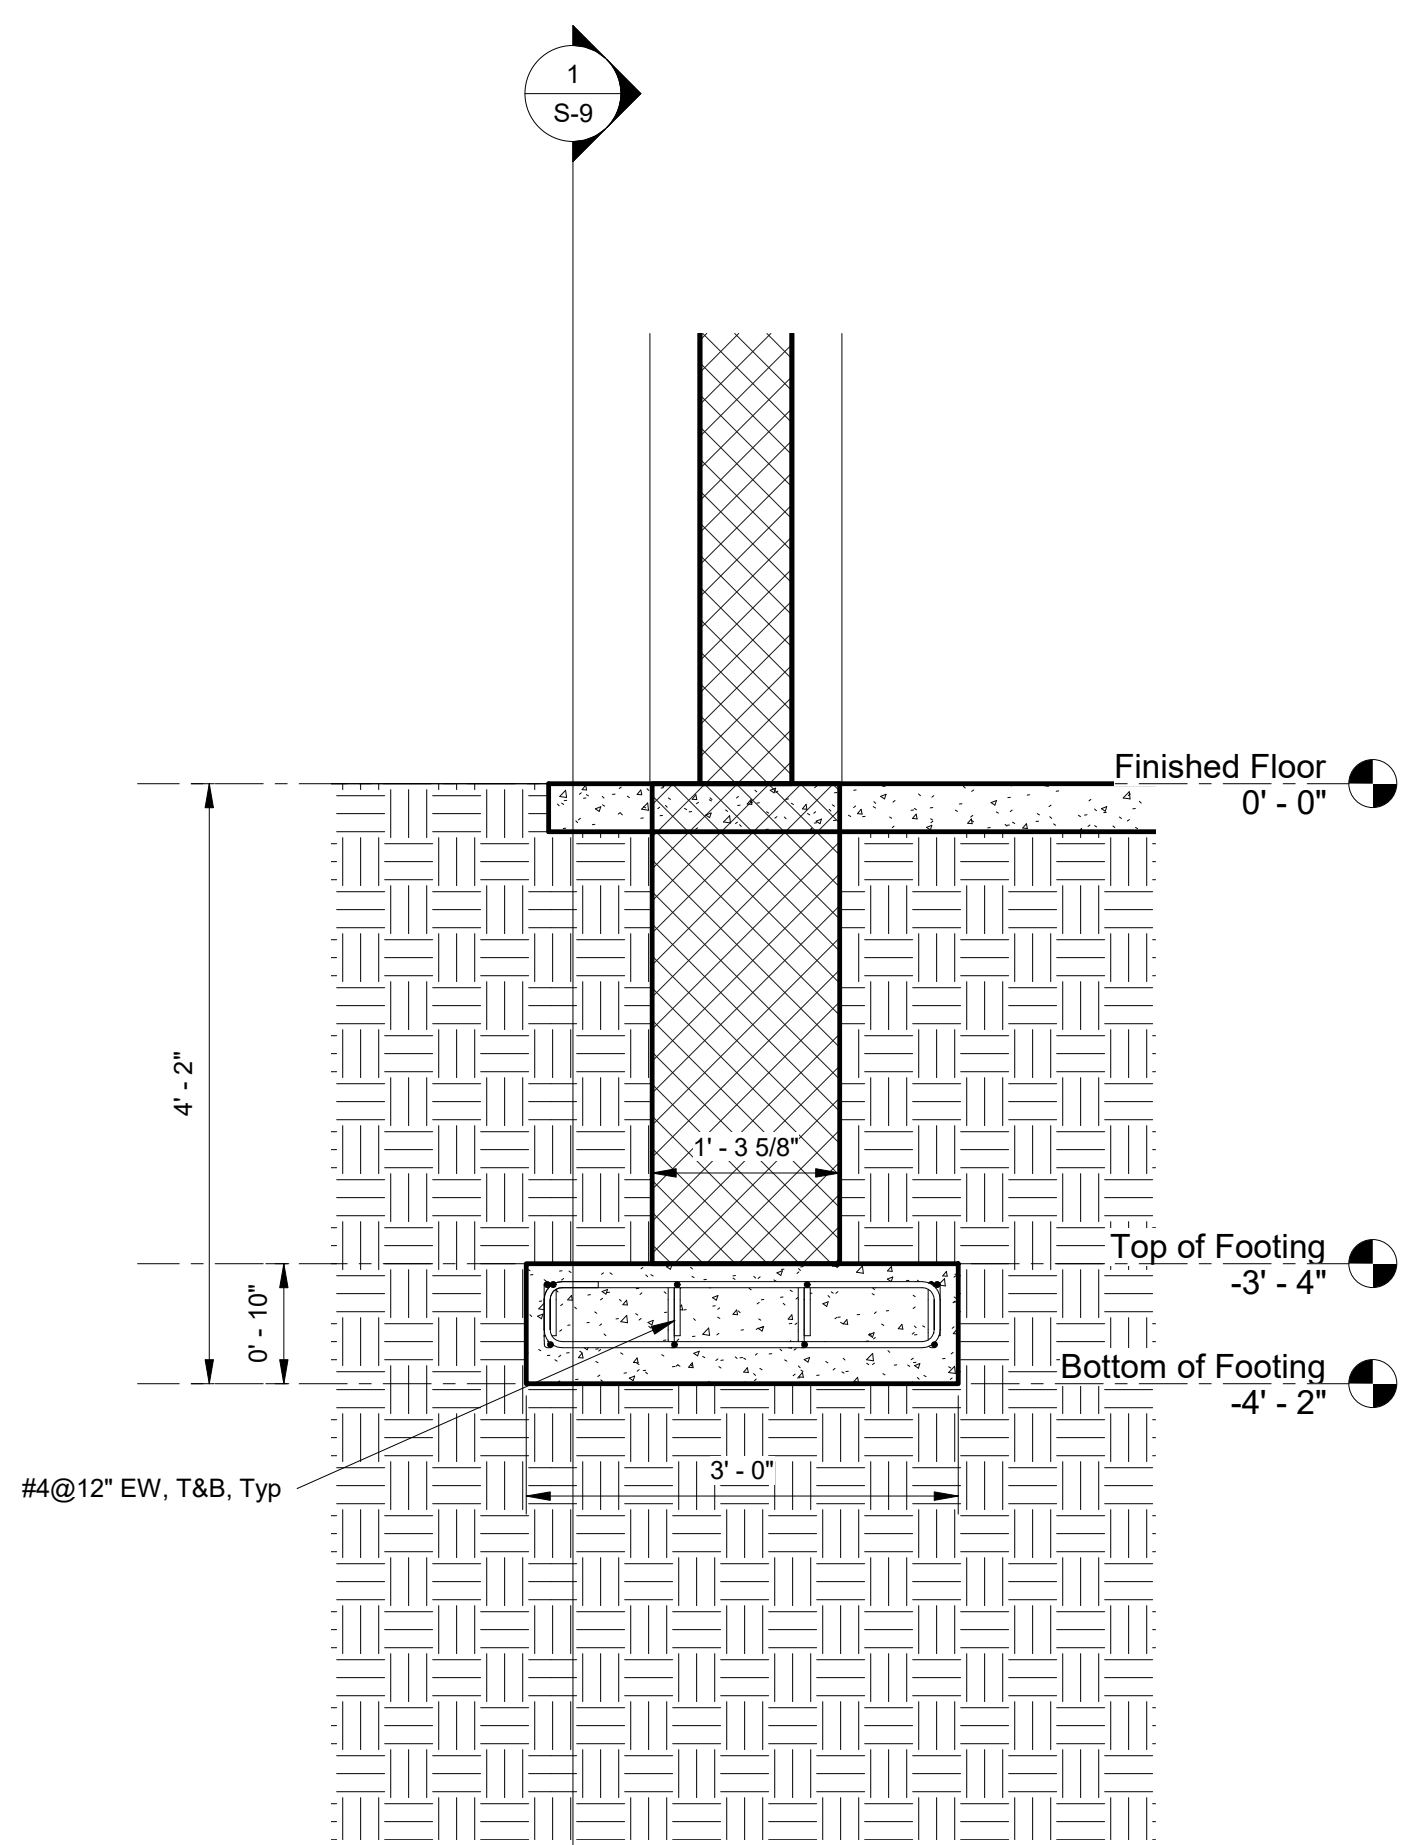

2 Section Loop C Spread Footing
3/4" = 1'-0"

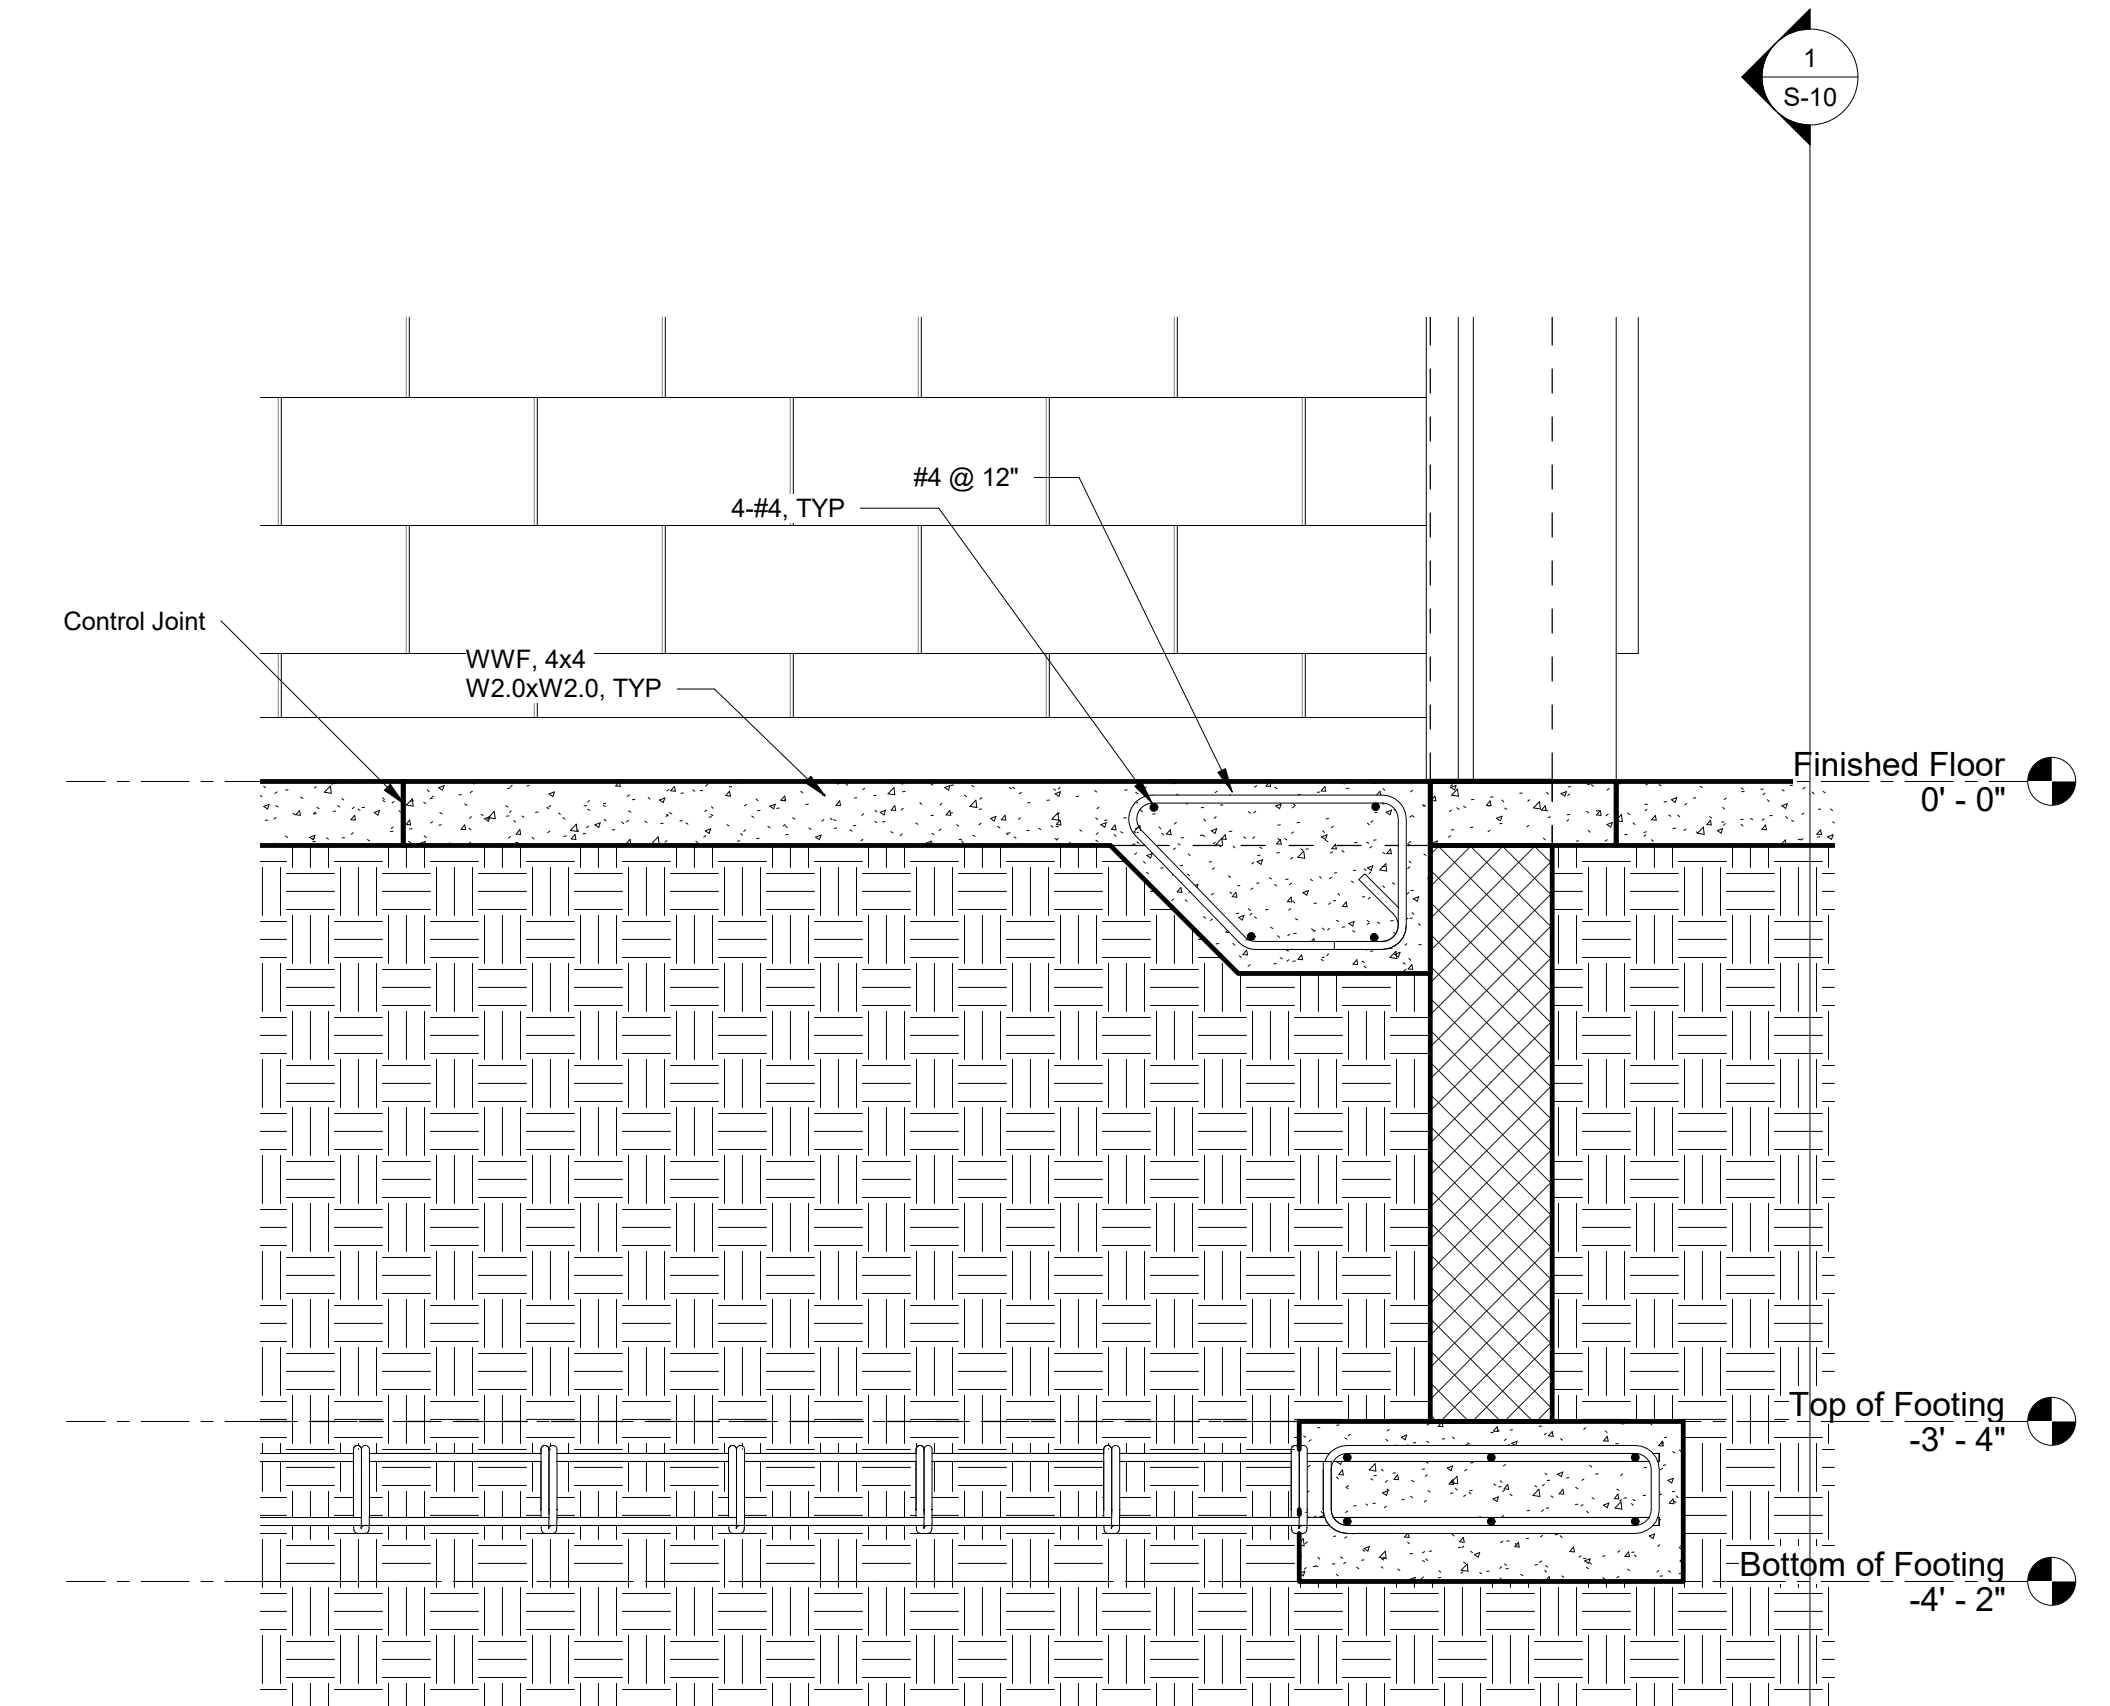

6 Thickened Slab Detail
1" = 1'-0"


NOTES:
1. FOR GENERAL NOTES SEE SHEET S-2
2. FOR SYMBOLS AND ABBREVIATIONS SEE SHEET S-1

VERIFY SCALE	
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CONSTRUCTION DOCUMENTS



RECORD REVISIONS

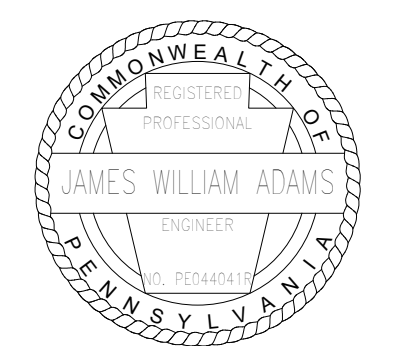

Signature: *James W. Adams* Date: 11/19/2021

SMP ARCHITECTS
1600 WALNUT STREET, SECOND FLOOR
PHILADELPHIA, PENNSYLVANIA


COMMONWEALTH OF PENNSYLVANIA
DEPARTMENT OF GENERAL SERVICES
HARRISBURG, PENNSYLVANIA

D.G.S. PROJECT No. C-114-0006 PHASE 1


HICKORY RUN STATE PARK
LATRINE IMPROVEMENTS
DEPT of CONSERVATION AND NATURAL RESOURCES
WHITE HAVEN, CARBON COUNTY, PA

FOUNDATION DETAILS, SHEET 1


DRAWN BY J ADAMS	DATE 06/17/2022	DRAWING No. S-30
CHECKED BY J ADAMS	SCALE AS NOTED	

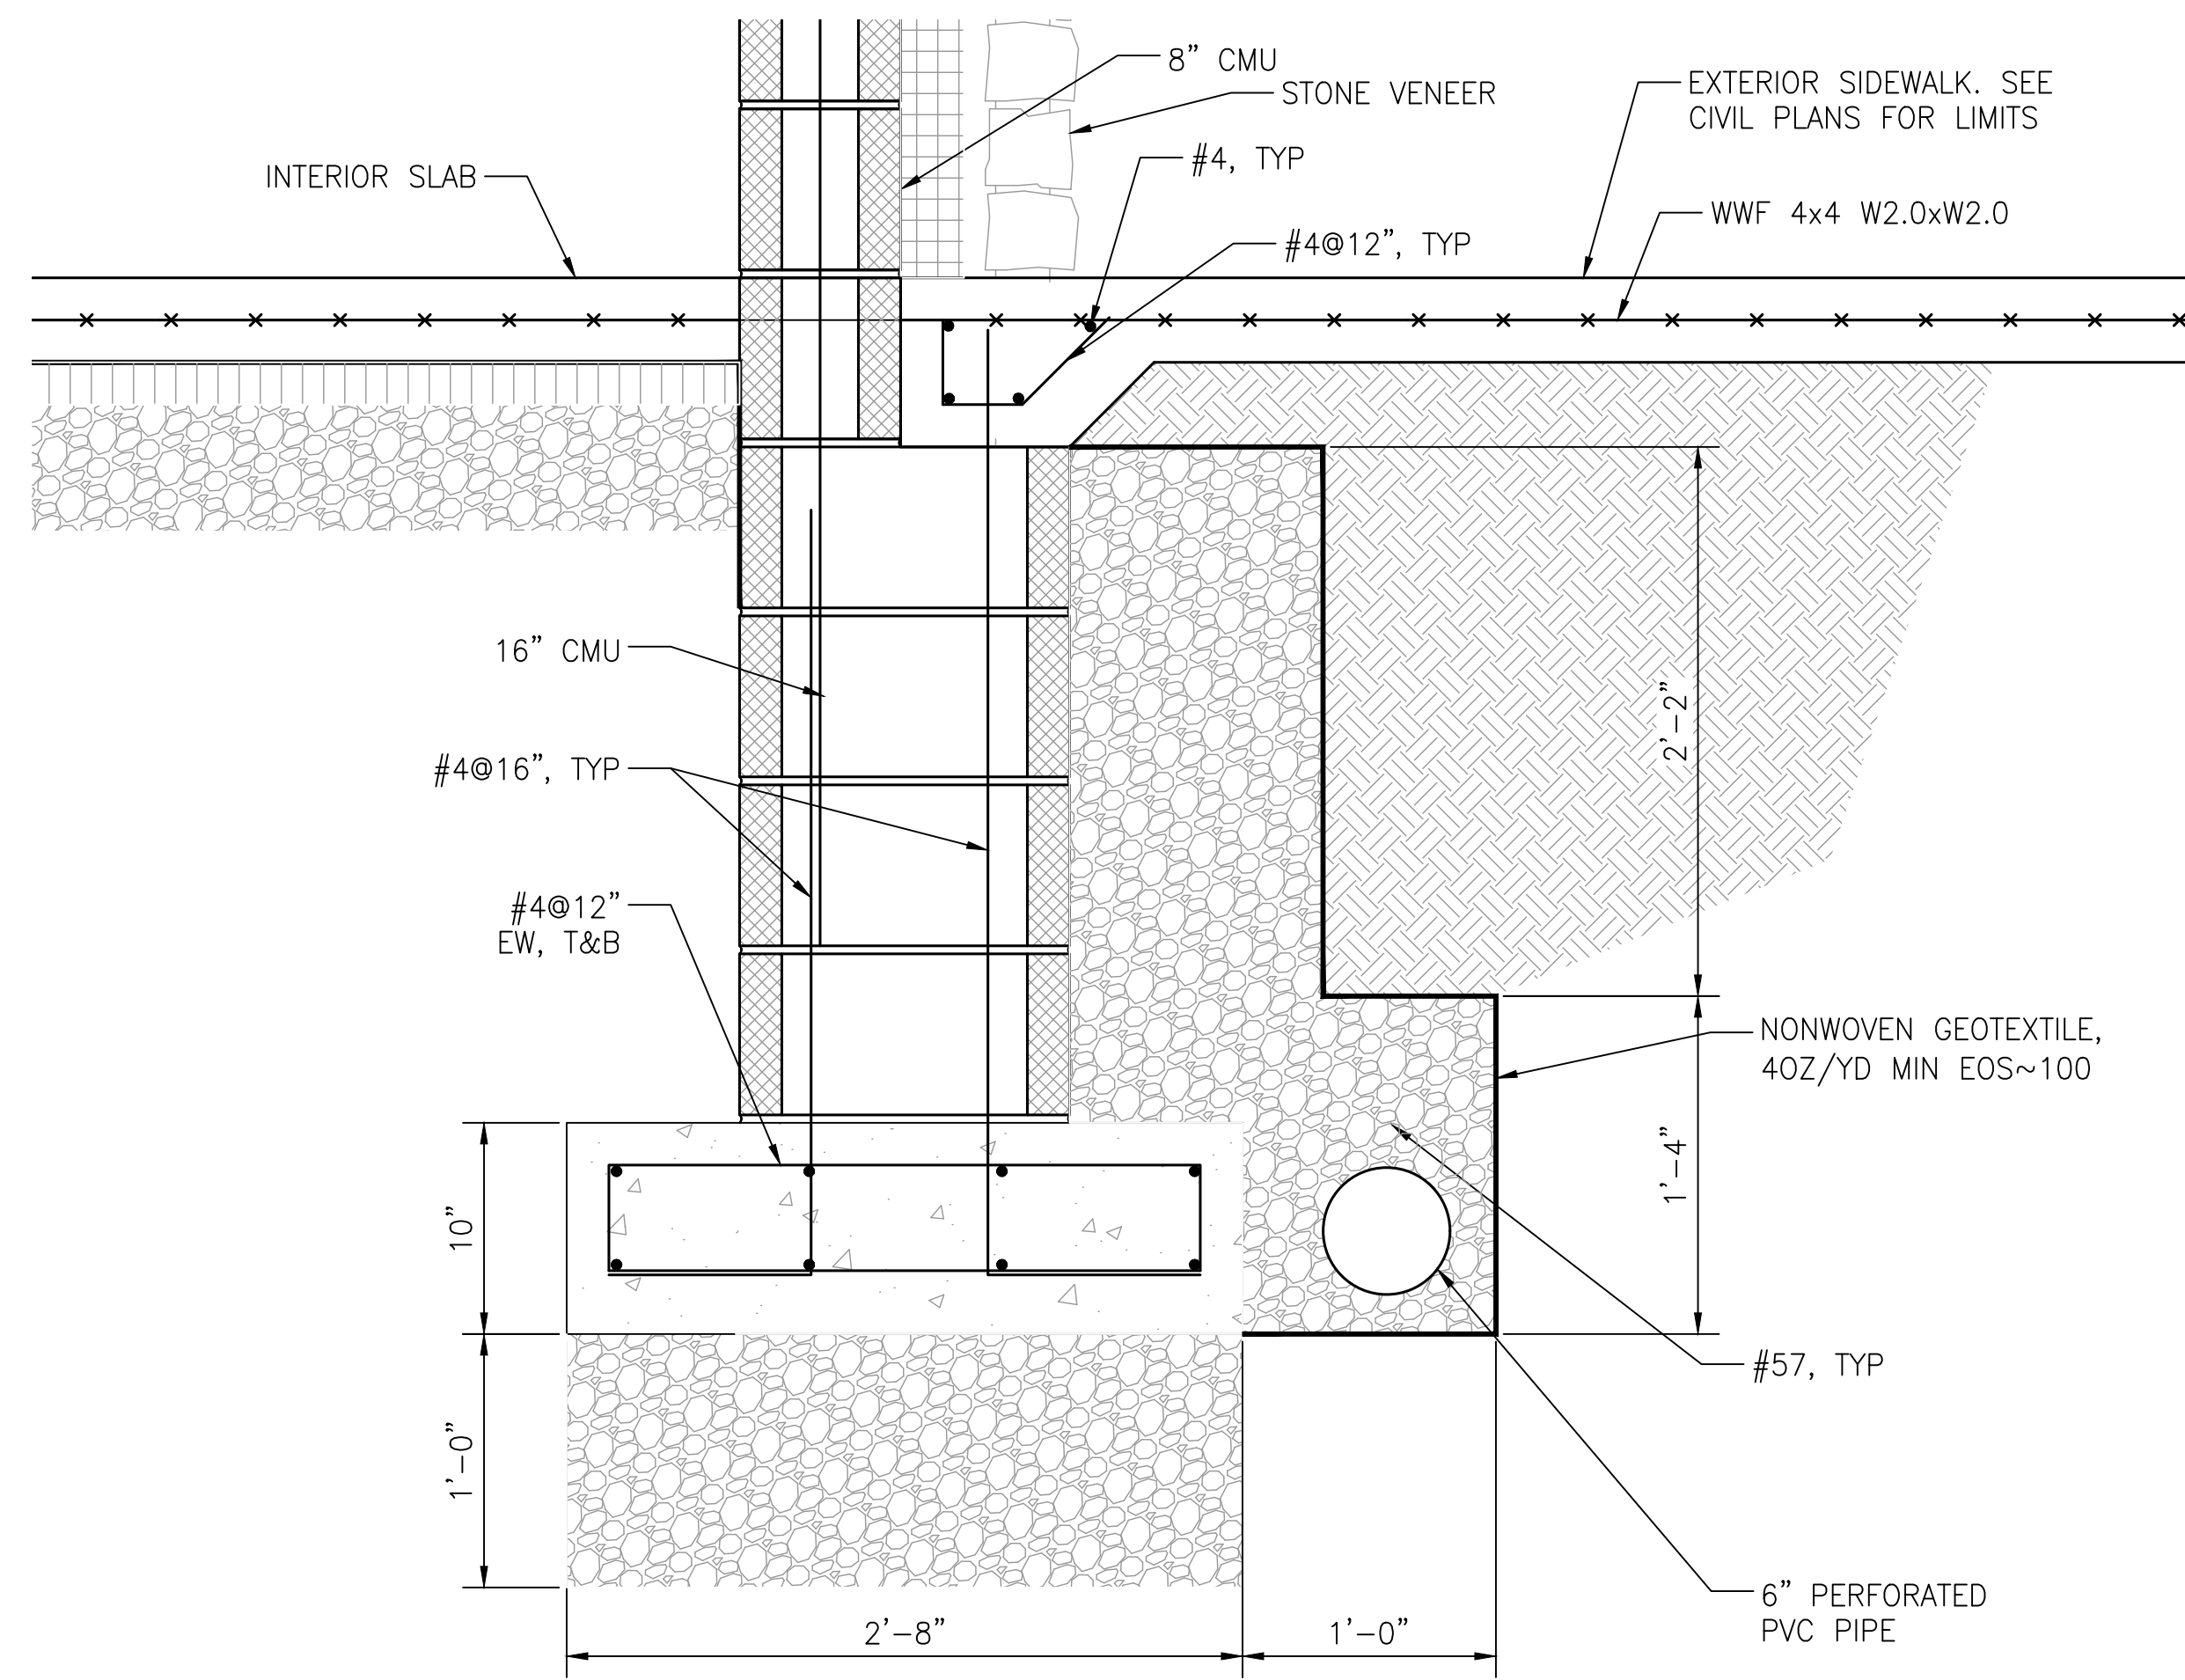

1
S-31 DETAIL - 16" FOUNDATION
FOUNDATION DRAINAGE AND EXTERIOR SLAB DETAIL 1 1/2"=1'-0"

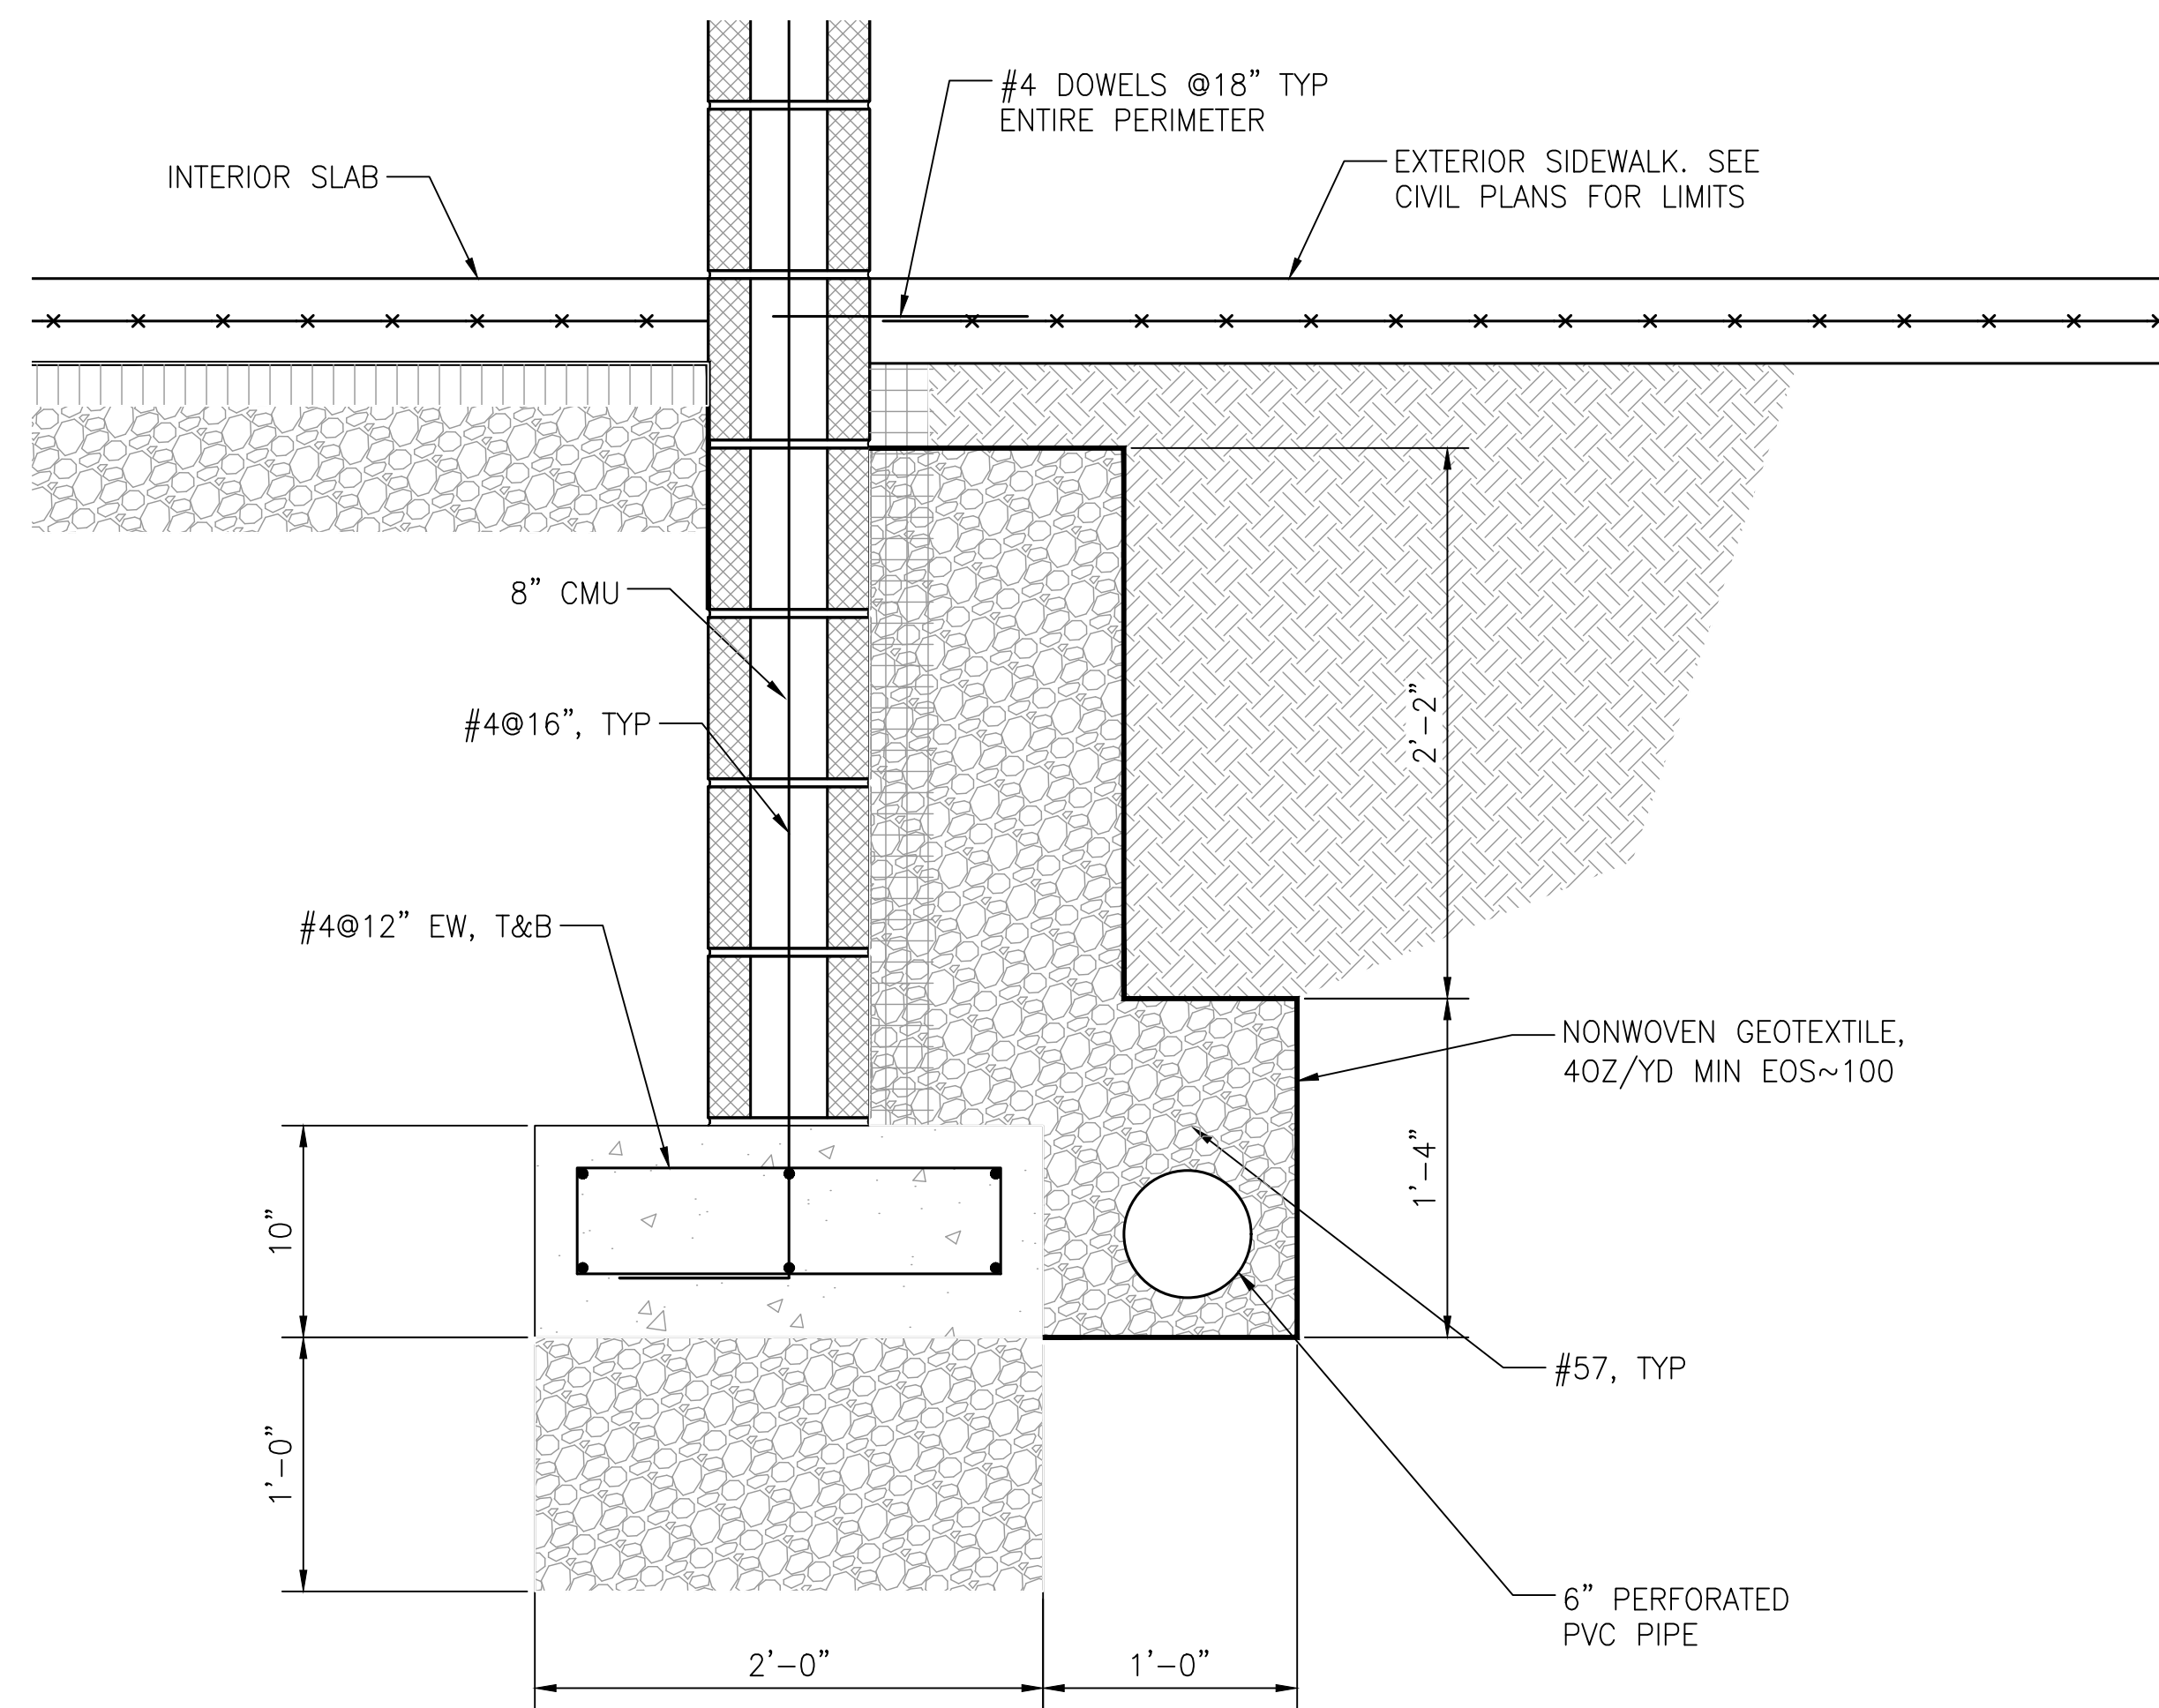

2
S-31 DETAIL - 8" FOUNDATION
FOUNDATION DRAINAGE AND EXTERIOR SLAB DETAIL 1 1/2"=1'-0"

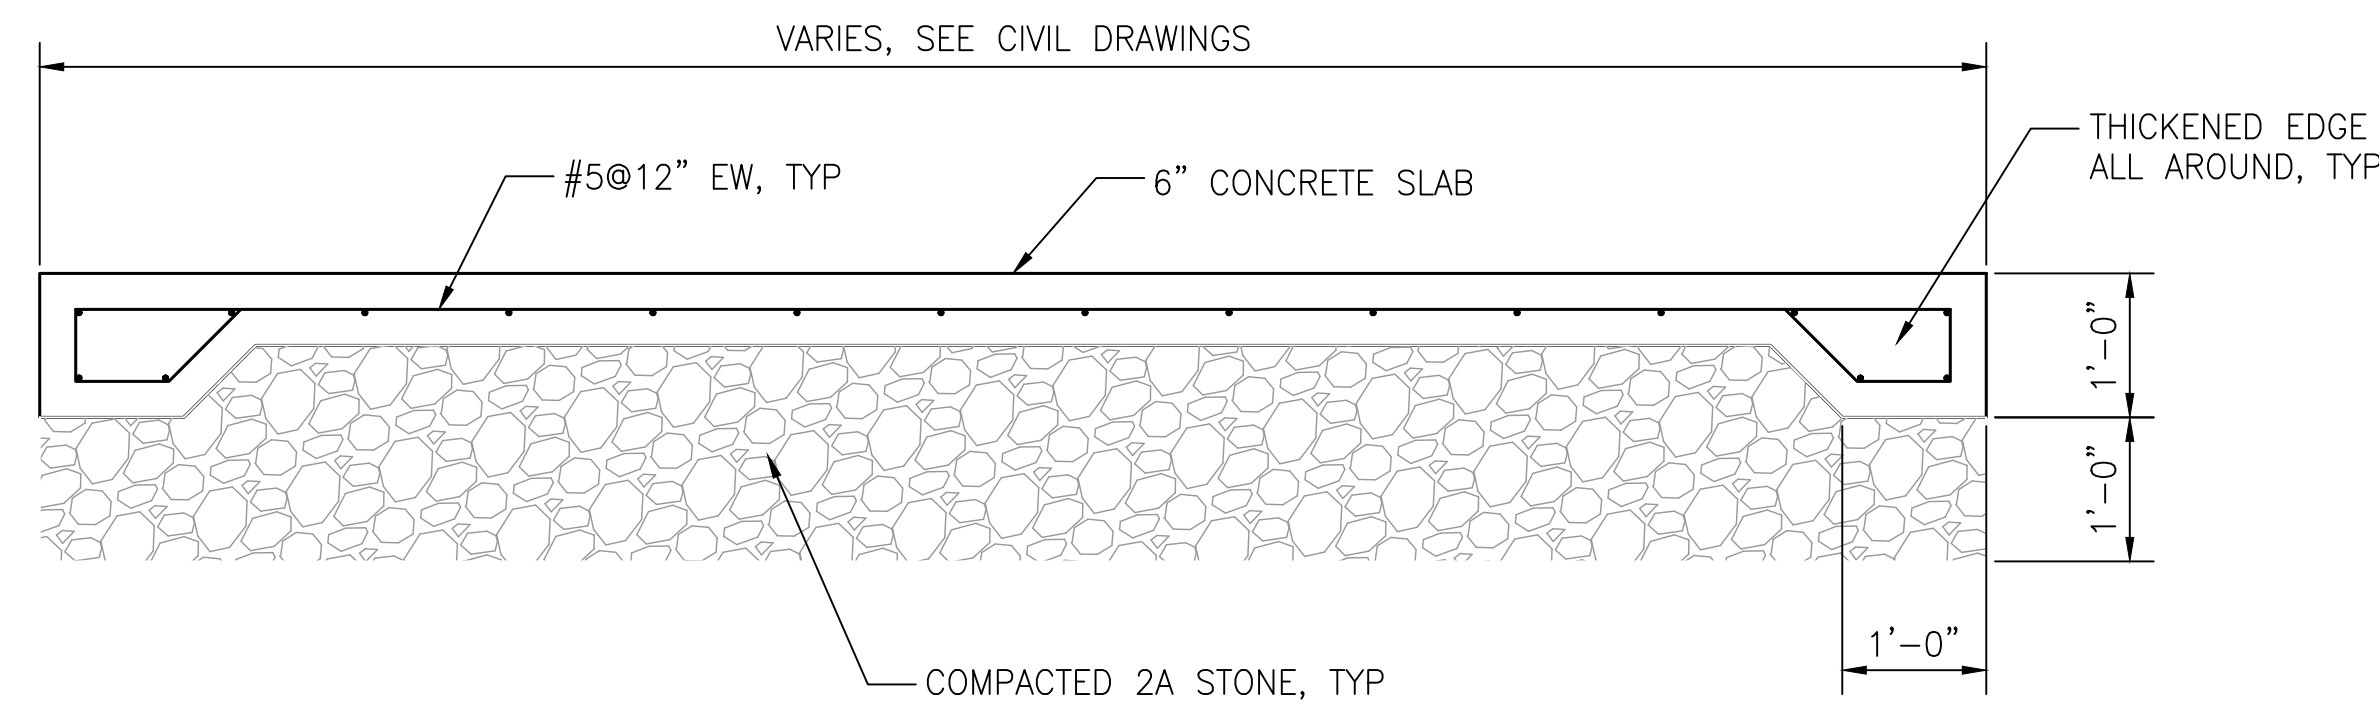


3
S-31 PARKING SLAB DETAIL 3/4"=1'-0"

NOTES:
1. FOR GENERAL NOTES SEE SHEET S-2
2. FOR SYMBOLS AND ABBREVIATIONS SEE SHEET S-1

CONSTRUCTION DOCUMENTS



RECORD REVISIONS

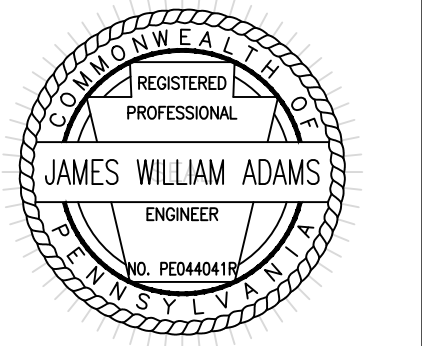

James W. Adams
SIGNATURE DATE 11/19/21

SMP ARCHITECTS
1600 WALNUT STREET, SECOND FLOOR
PHILADELPHIA, PENNSYLVANIA

COMMONWEALTH OF PENNSYLVANIA
DEPARTMENT OF GENERAL SERVICES
HARRISBURG, PENNSYLVANIA


D.G.S. PROJECT No.
C-114-0006 PHASE 1

HICKORY RUN STATE PARK
LATRINE IMPROVEMENTS
DEPT of CONSERVATION AND NATURAL RESOURCES
WHITE HAVEN, CARBON COUNTY, PA


FOUNDATION DETAILS - SHEET
2

VERIFY SCALE
BAR IS ONE (1) INCH LONG ON ORIGINAL DRAWING.
0 1
IF BAR IS NOT ONE (1) INCH LONG, ADJUST SCALE ACCORDINGLY
CONTRACTOR SHALL FIELD VERIFY ALL DIMENSIONS. VARIANCE FROM CONTRACT DOCUMENTS NOT PERMITTED WITHOUT PROFESSIONAL & BUREAU OF CONSTRUCTION APPROVAL.


DRAWN BY	DATE	DRAWING No.
M DIMONTE	06/17/2022	S-31
CHECKED BY	SCALE	AS NOTED
J ADAMS		

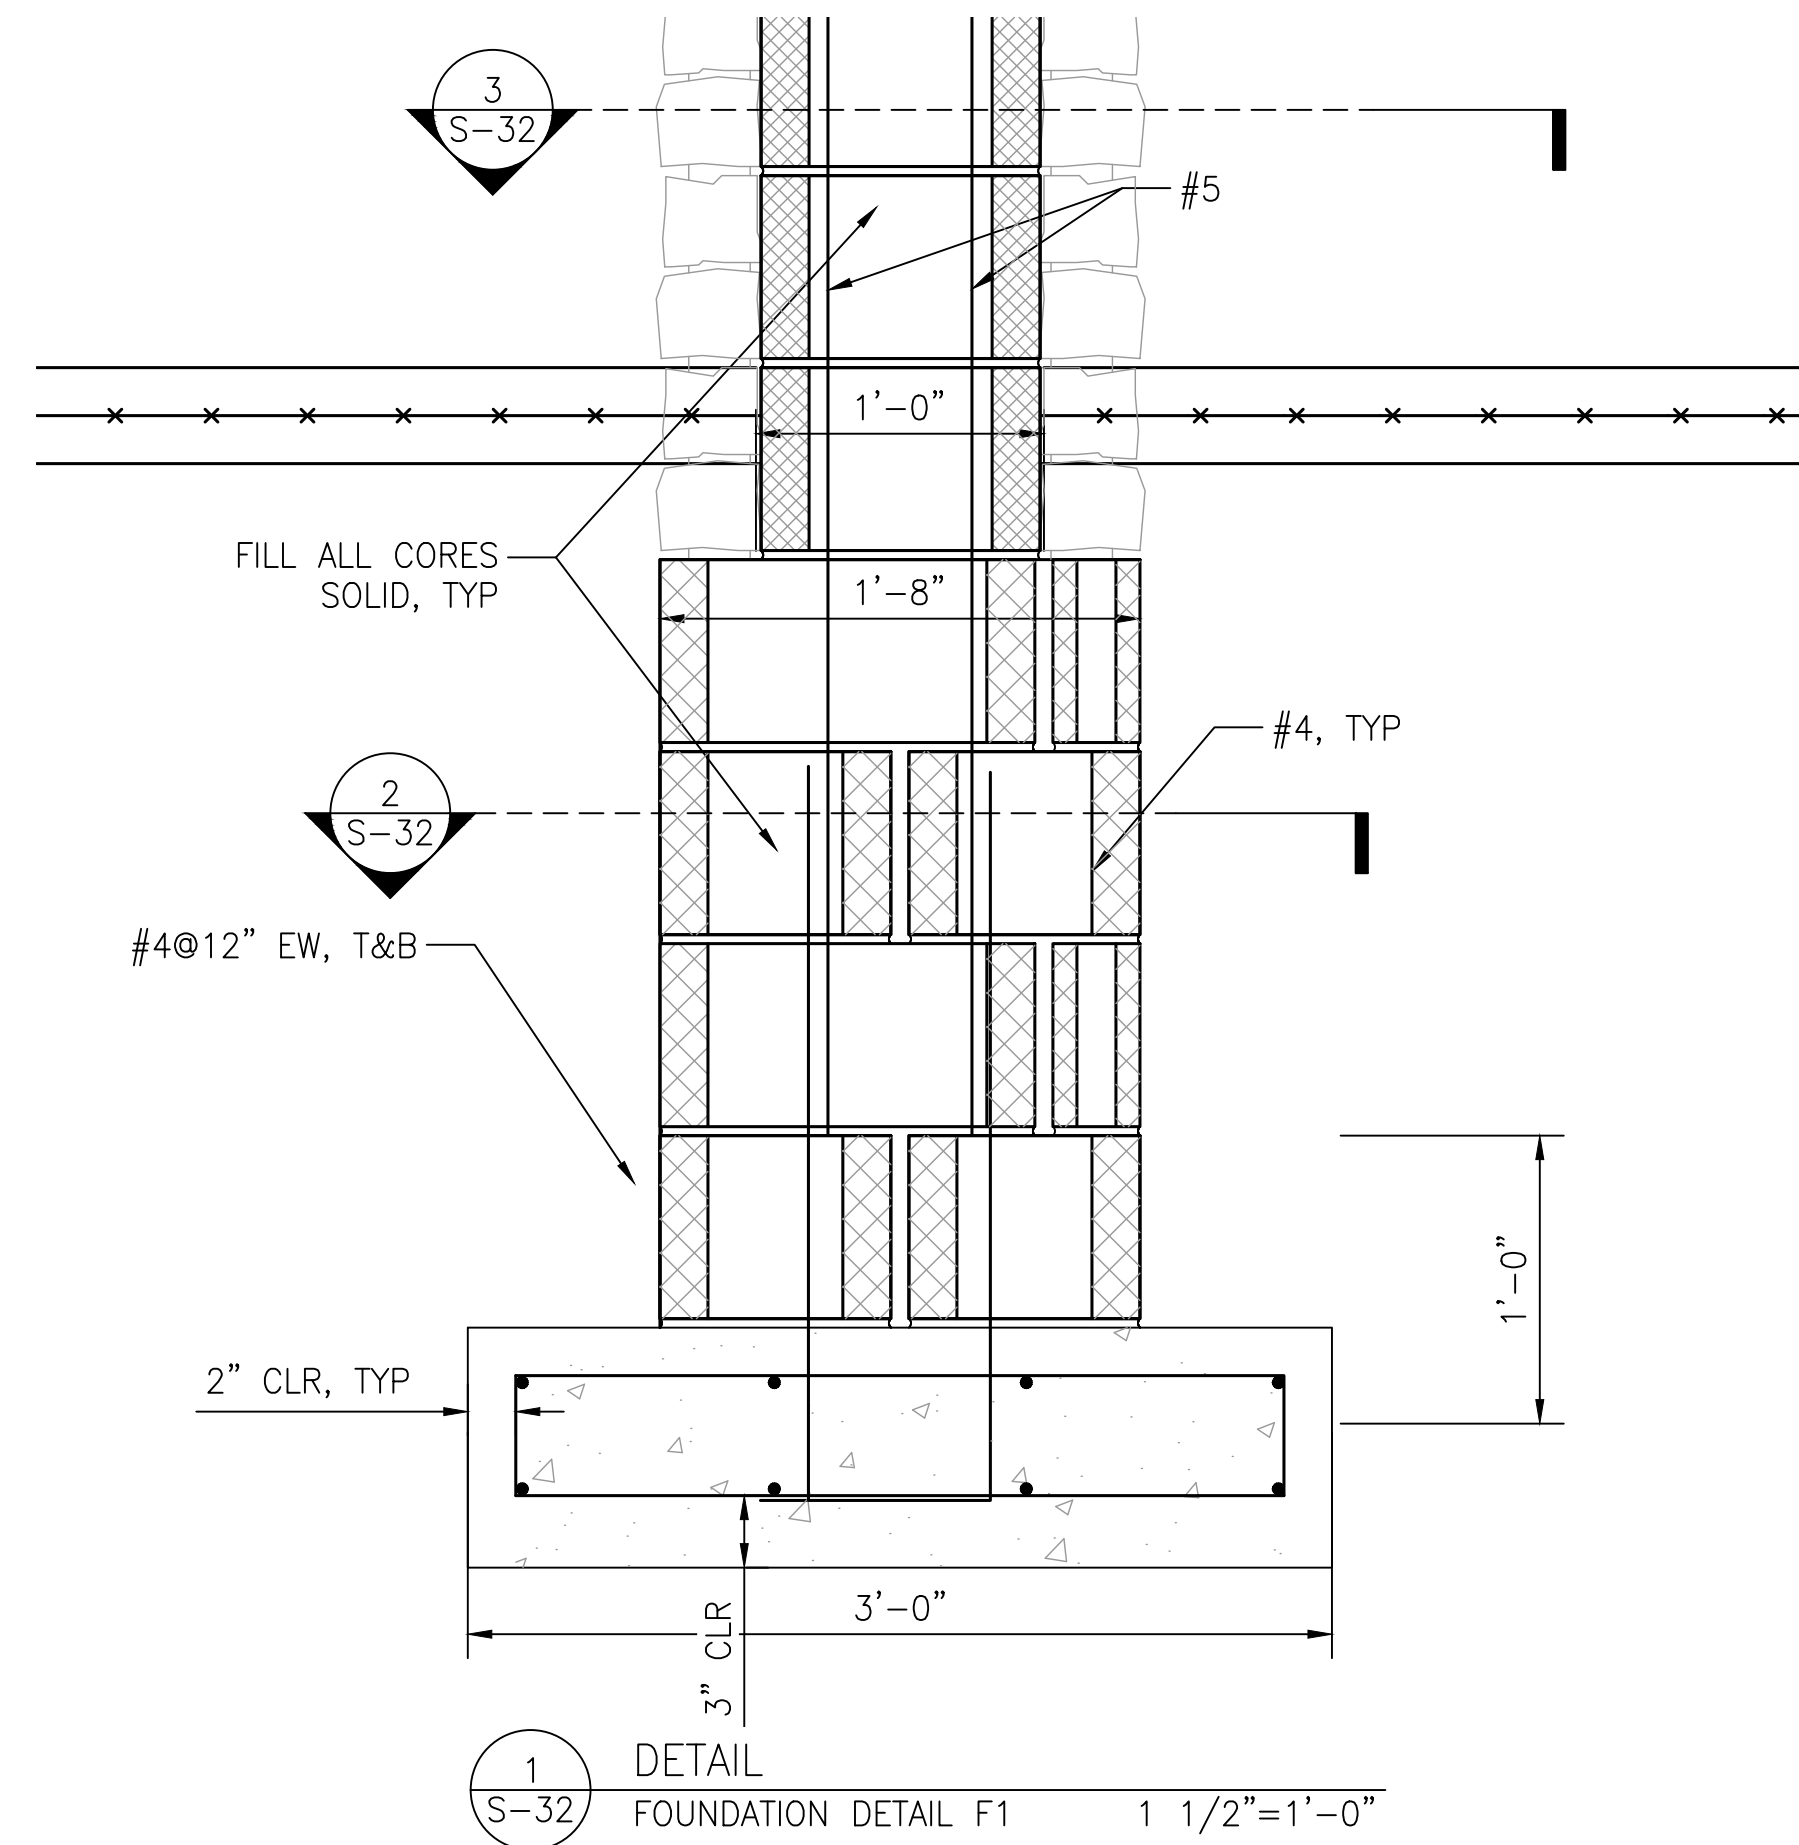


1 DETAIL
S-32 FOUNDATION DETAIL F1 1 1/2"=1'-0"

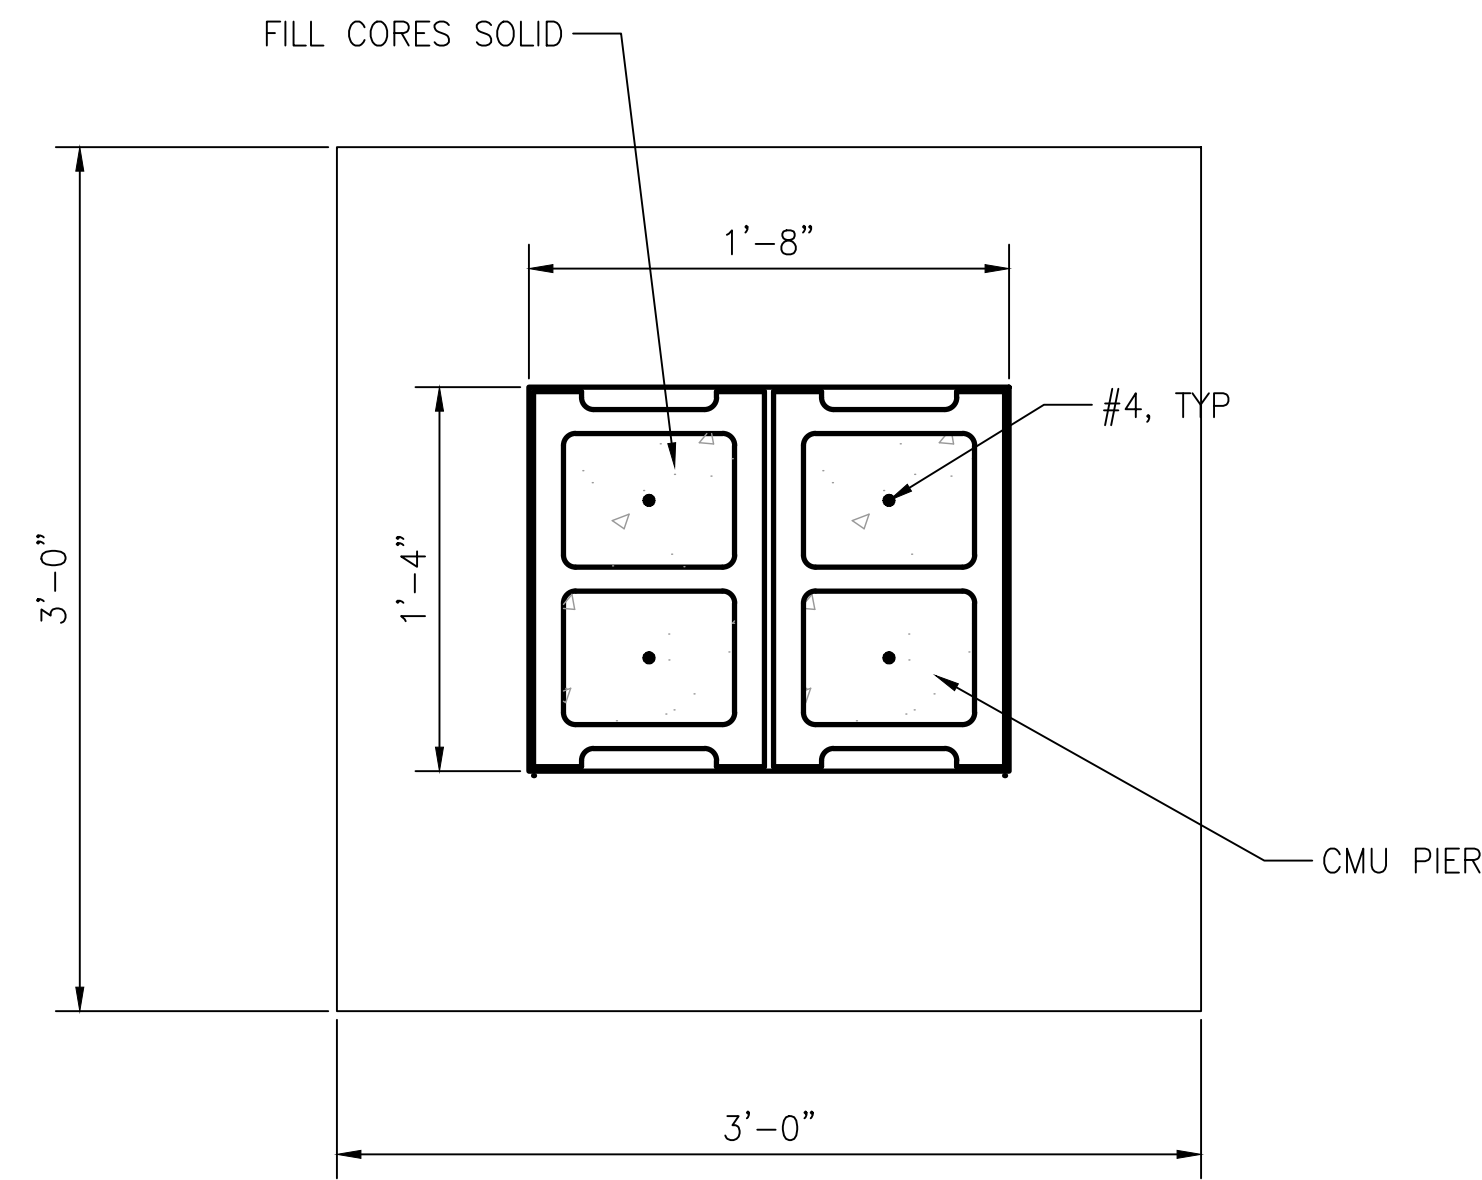

2 SECTION
S-32 FOUNDATION 1 1/2"=1'-0"

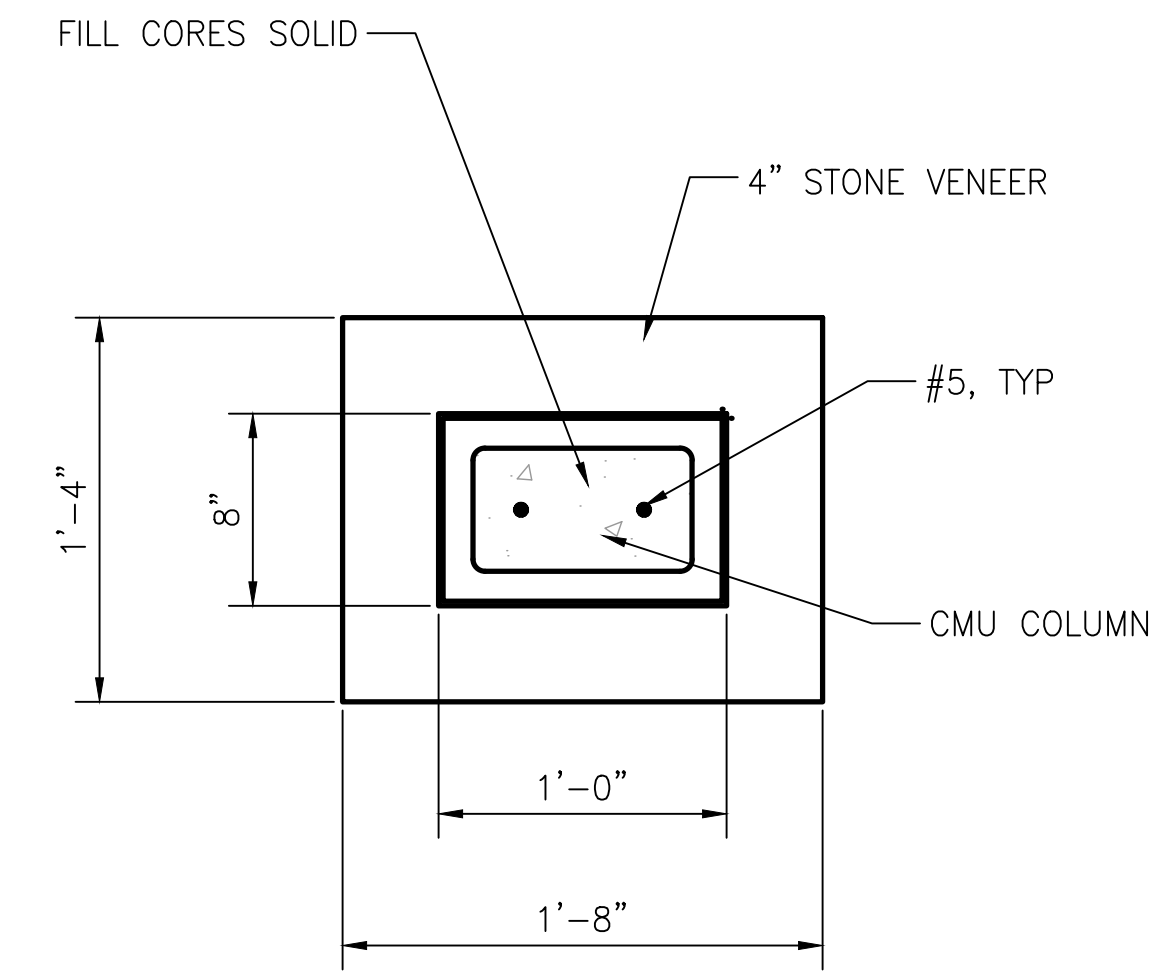

3 SECTION
S-32 CMU COLUMN 1 1/2"=1'-0"

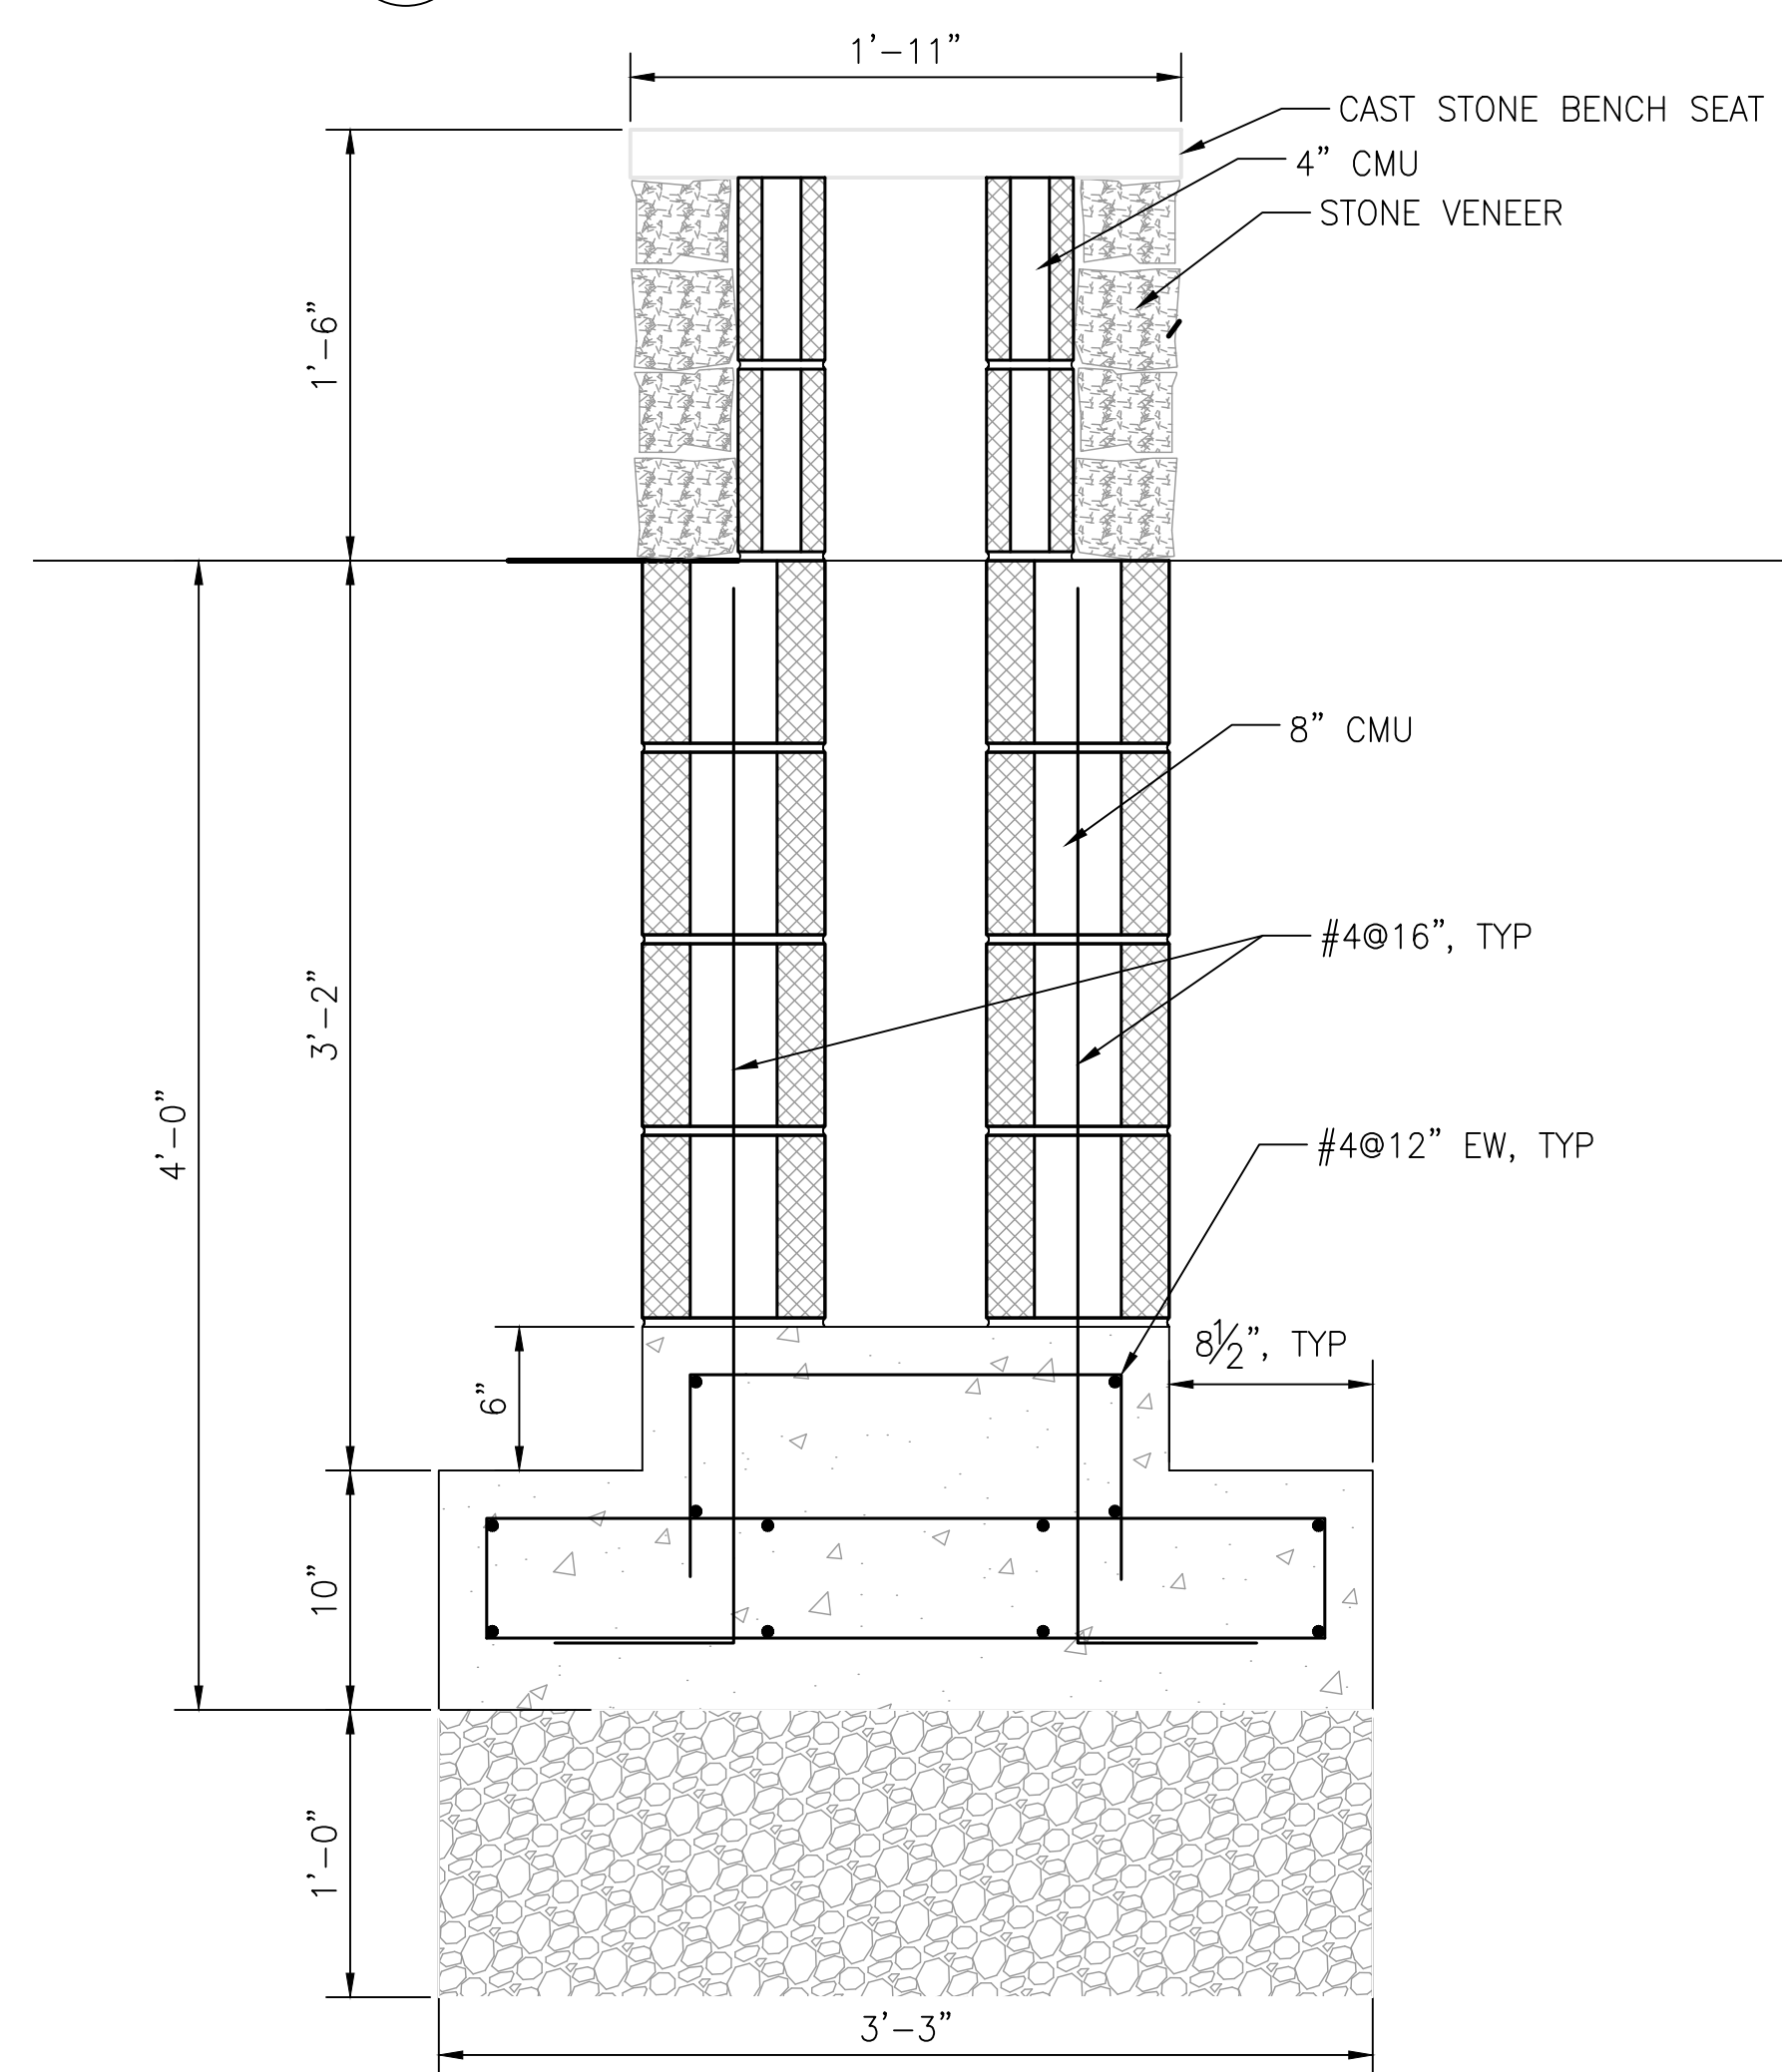

4 SECTION
S-32 LOOP C BENCH 1 1/2"=1'-0"


NOTES:
1. FOR GENERAL NOTES SEE SHEET S-2
2. FOR SYMBOLS AND ABBREVIATIONS SEE SHEET S-1

VERIFY SCALE	
BAR IS ONE (1) INCH LONG ON ORIGINAL DRAWING.	
0 1	
IF BAR IS NOT ONE (1) INCH LONG, ADJUST SCALE ACCORDINGLY	
CONTRACTOR SHALL FIELD VERIFY ALL DIMENSIONS. VARIANCE FROM CONTRACT DOCUMENTS NOT PERMITTED WITHOUT PROFESSIONAL & BUREAU OF CONSTRUCTION APPROVAL.	DRAWN BY M DIMONTE
CHECKED BY J ADAMS	DATE 06/17/2022
SCALE AS NOTED	DRAWING No. S-32

CONSTRUCTION DOCUMENTS



RECORD REVISIONS

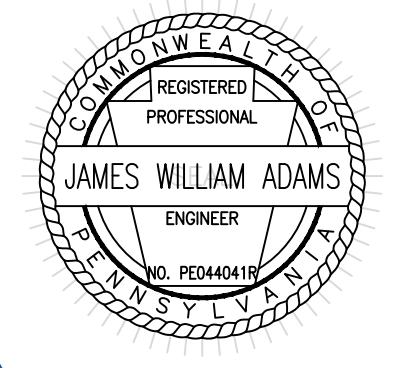

James W. Adams 11/19/21
SIGNATURE DATE

SMP ARCHITECTS
1600 WALNUT STREET, SECOND FLOOR
PHILADELPHIA, PENNSYLVANIA


COMMONWEALTH OF PENNSYLVANIA
DEPARTMENT OF GENERAL SERVICES
HARRISBURG, PENNSYLVANIA

D.G.S. PROJECT No.
C-114-0006 PHASE 1


HICKORY RUN STATE PARK
LATRINE IMPROVEMENTS
DEPT of CONSERVATION AND NATURAL RESOURCES
WHITE HAVEN, CARBON COUNTY, PA

FOUNDATION DETAILS - SHEET
3

FILE PATH: I:\2020\20027 - Hickory Run State Park\CD\sheet files\20027 - STRUCTURAL.dwg PLOTTED BY: James Adams LST SAVED: 2022.06.10 01:08 PM PLOTTED: 2022.06.17 09:08 AM LAYOUT TAB: S-32 FOUNDATION DETAILS - SHEET 3

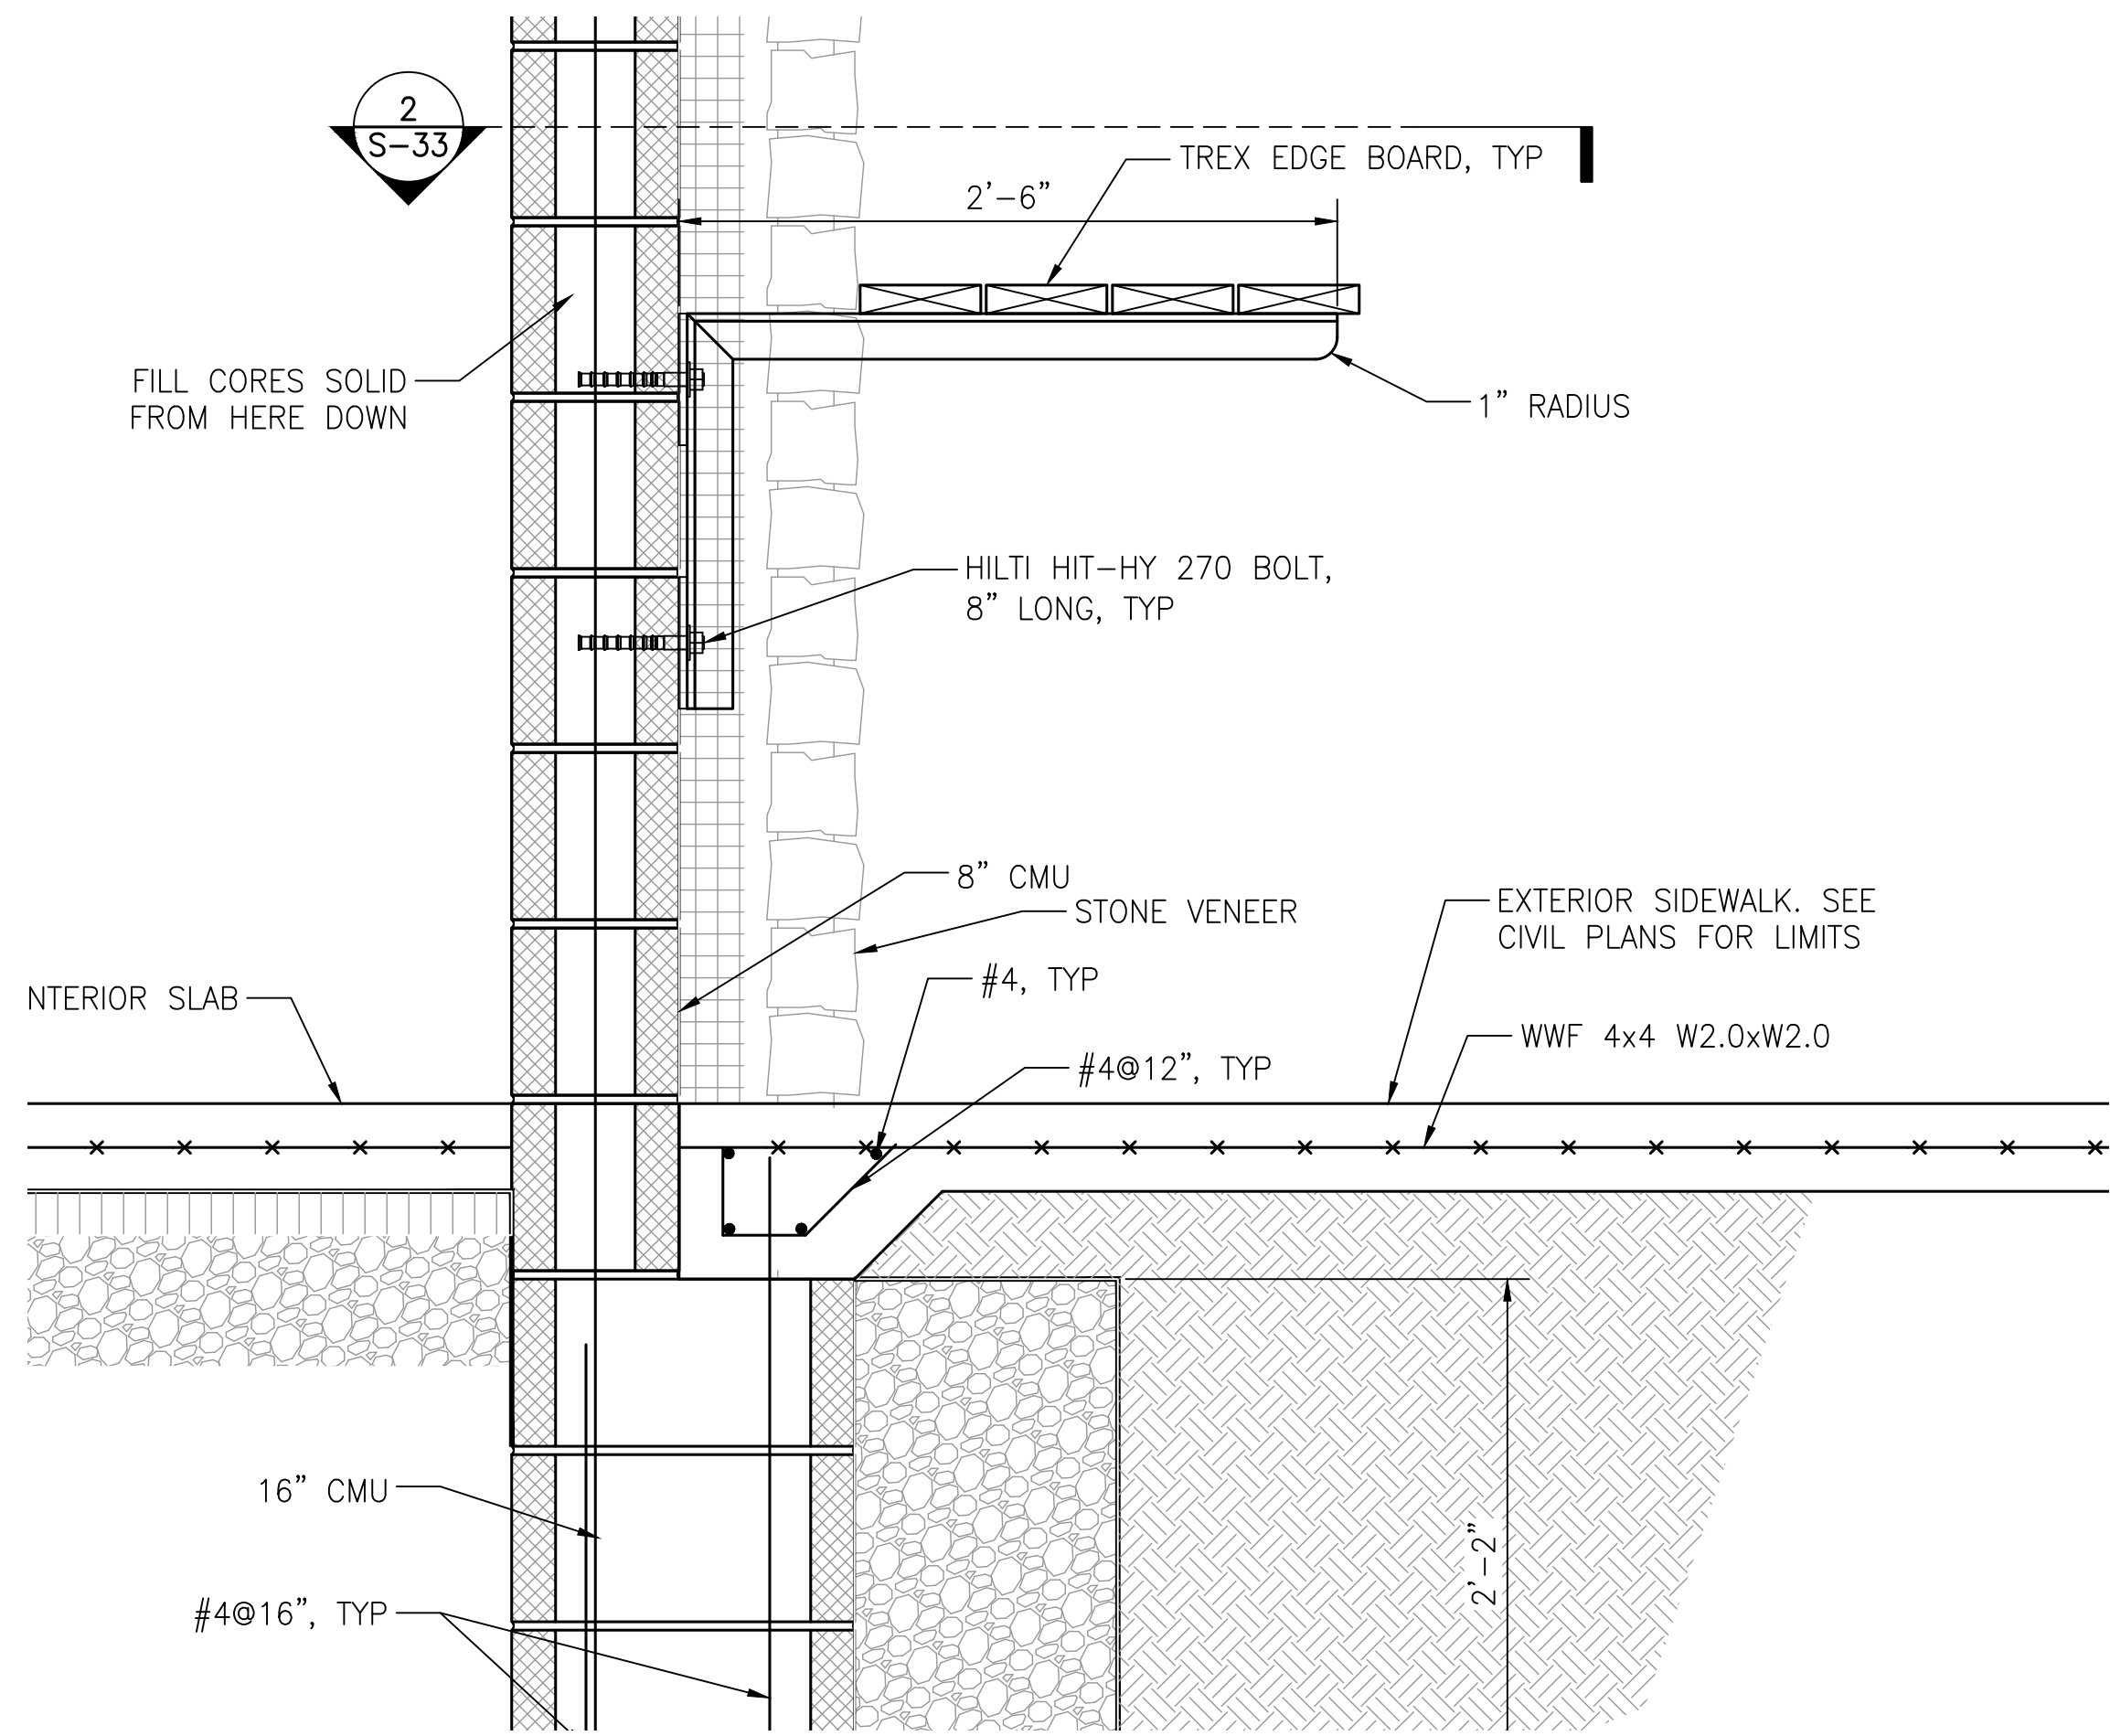


1 DETAIL
S-33 COUNTER SUPPORT 1 1/2"=1'-0"

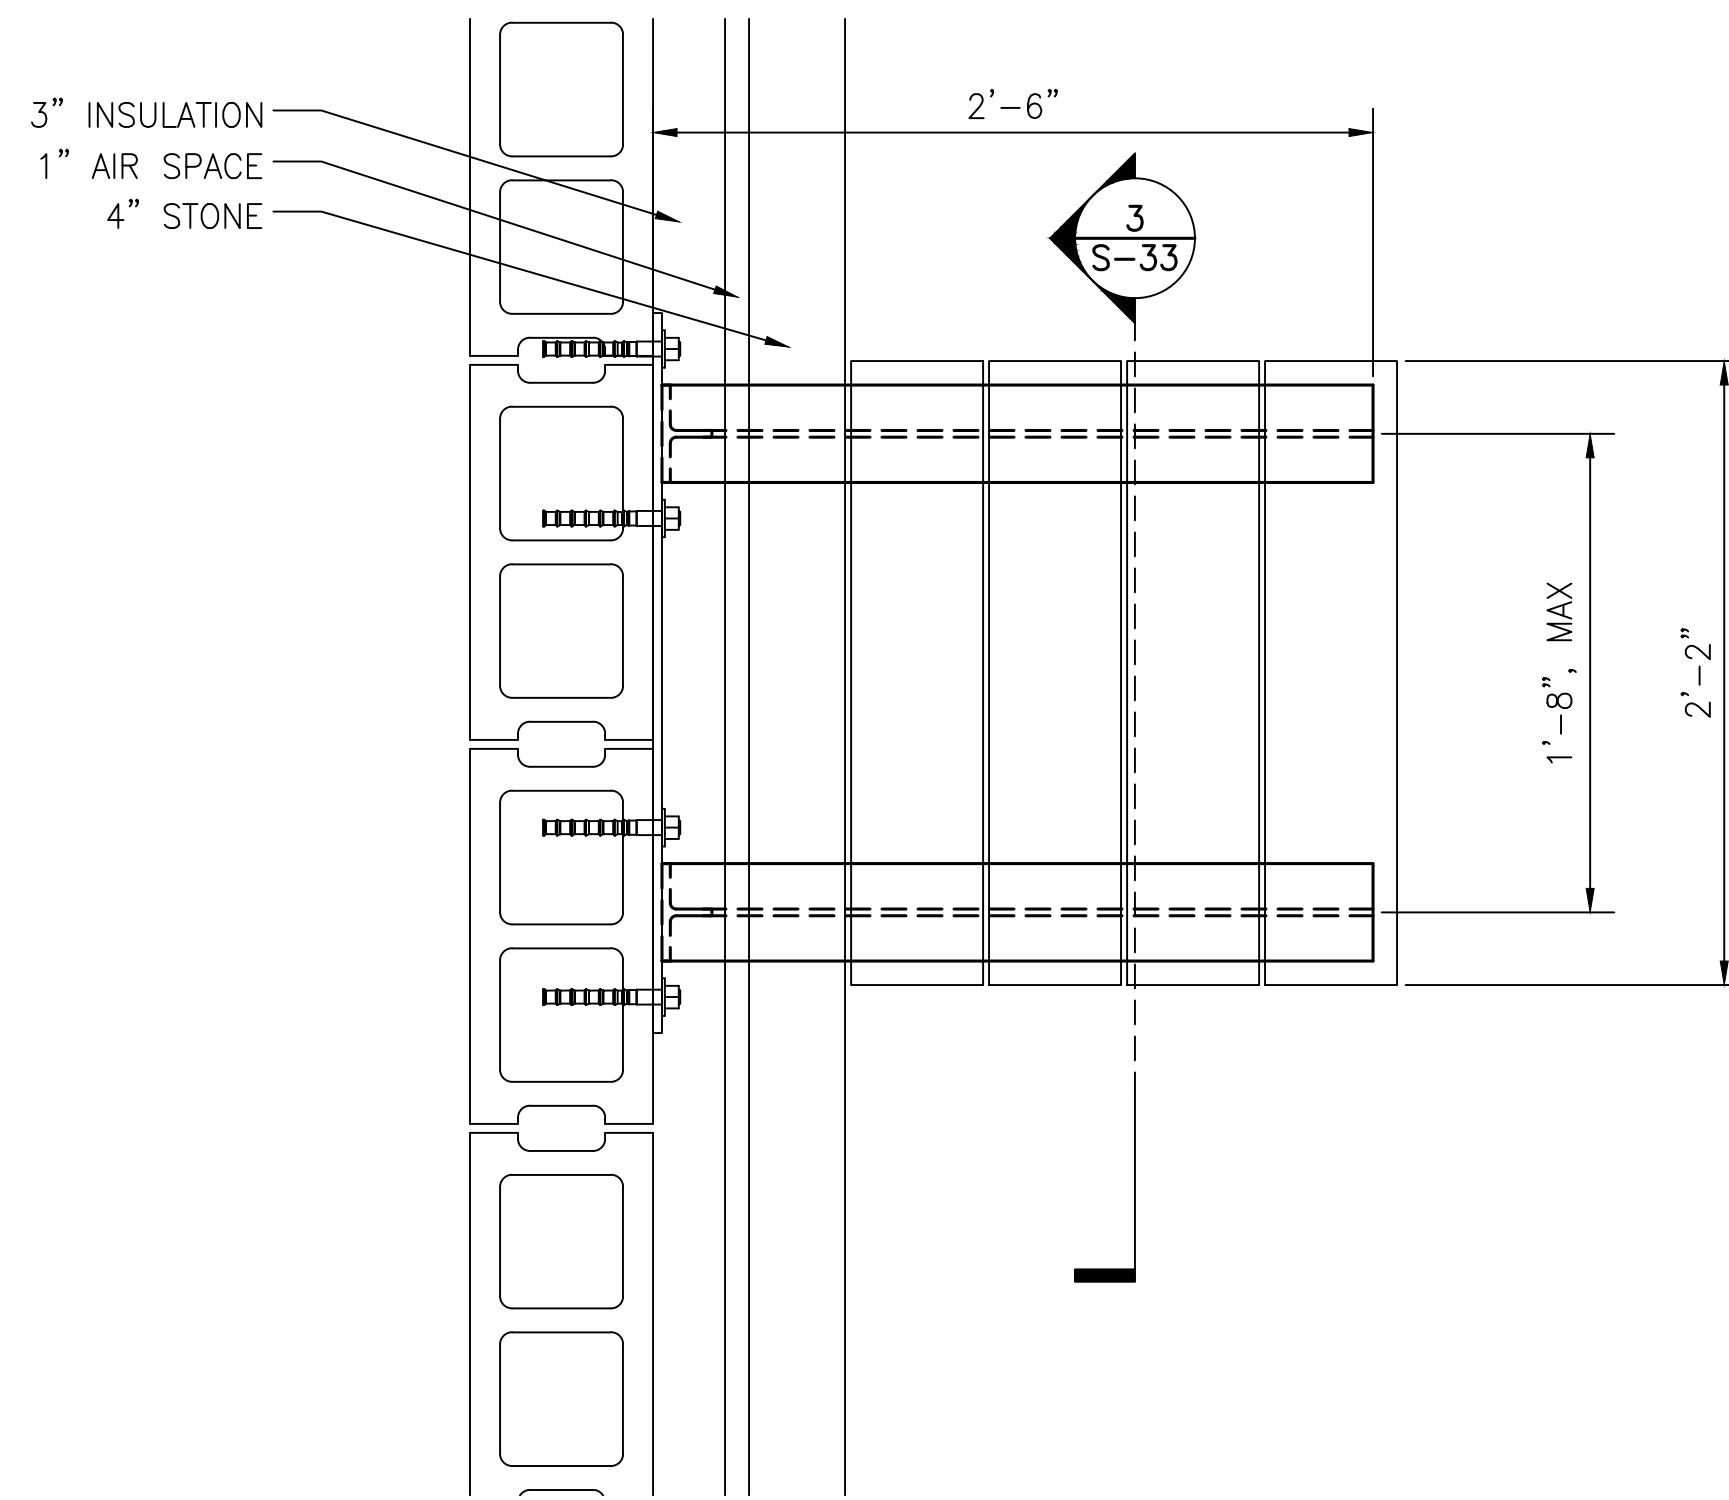

2 SECTION
S-33 COUNTER SUPPORT 1 1/2"=1'-0"

NOTE: 2'-2" COUNTER SHOWN. 1'-8" COUNTER SIMILAR. 3'-6" COUNTER REQUIRES 3 WT SUPPORT BRACKETS

1'-8" COUNTER, 2 REQUIRED
2'-2" COUNTER, 2 REQUIRED
3'-6" COUNTER, 3 REQUIRED

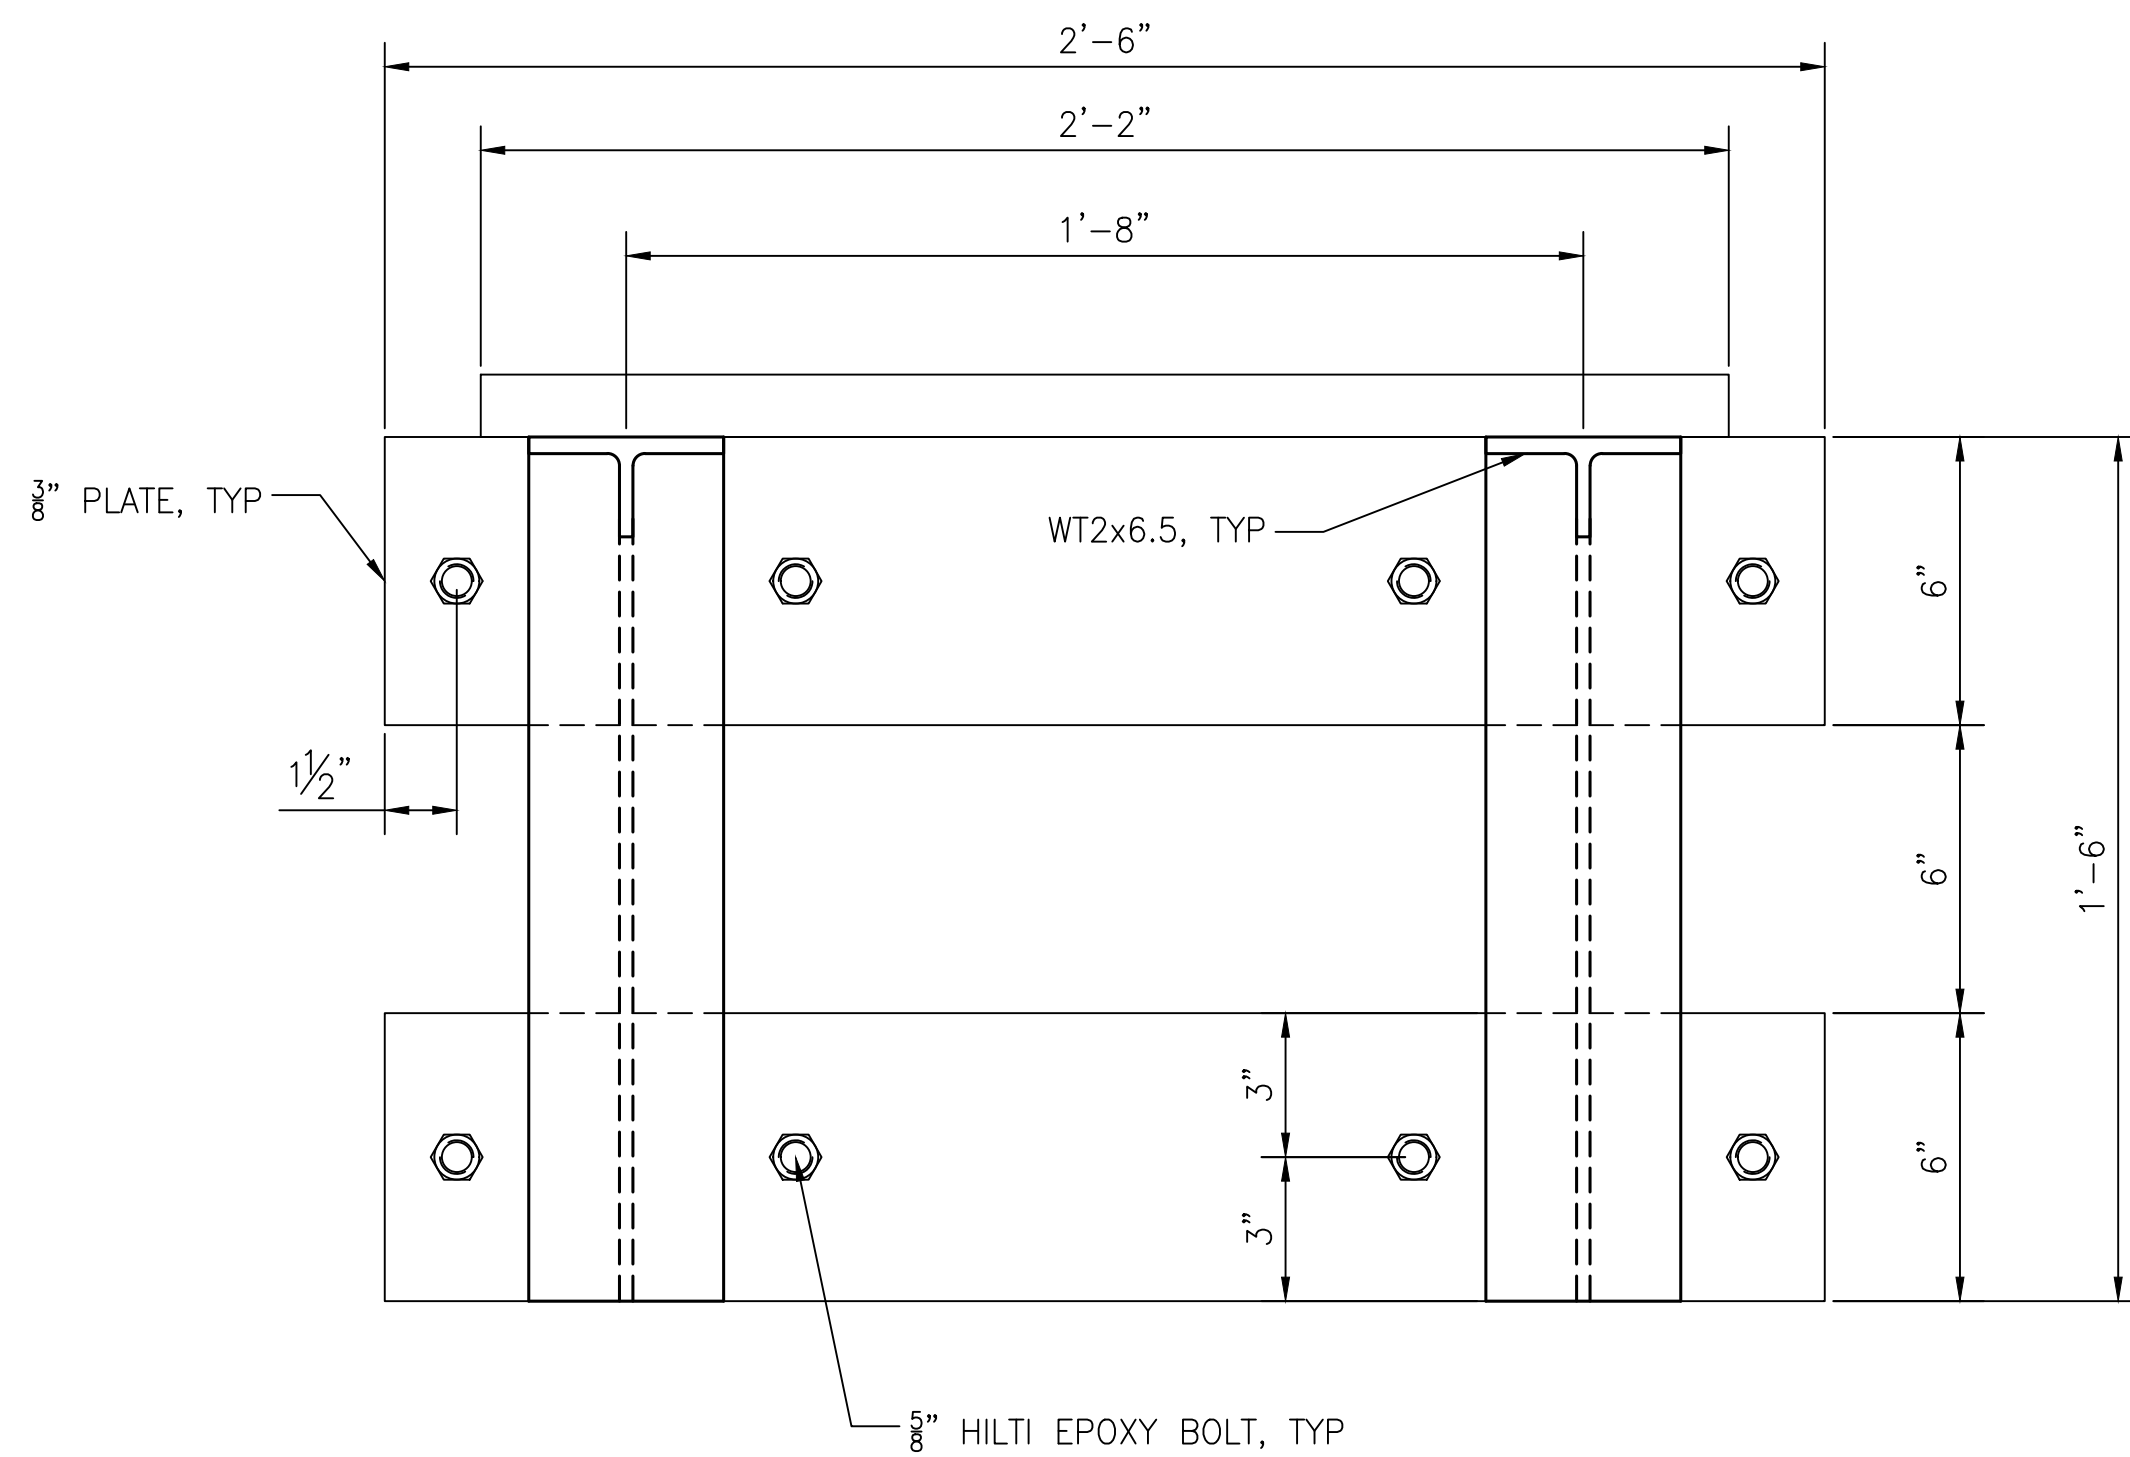


3 SECTION
S-33 COUNTER SUPPORT 3"=1'-0"

NOTES:
1. FOR GENERAL NOTES SEE SHEET S-2
2. FOR SYMBOLS AND ABBREVIATIONS SEE SHEET S-1

CONSTRUCTION DOCUMENTS



RECORD REVISIONS

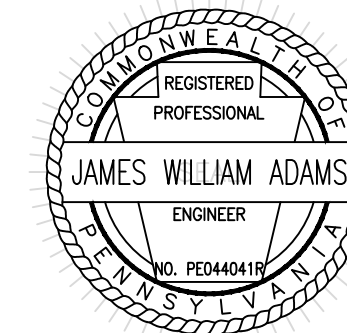

James W. Adams
SIGNATURE DATE 11/19/21

SMP ARCHITECTS
1600 WALNUT STREET, SECOND FLOOR
PHILADELPHIA, PENNSYLVANIA

COMMONWEALTH OF PENNSYLVANIA
DEPARTMENT OF GENERAL SERVICES
HARRISBURG, PENNSYLVANIA

D.G.S. PROJECT No.
C-114-0006 PHASE 1

HICKORY RUN STATE PARK
LATRINE IMPROVEMENTS
DEPT of CONSERVATION AND NATURAL RESOURCES
WHITE HAVEN, CARBON COUNTY, PA

COUNTER SUPPORTS


VERIFY SCALE

BAR IS ONE (1) INCH LONG
ON ORIGINAL DRAWING:
0 1
IF BAR IS NOT ONE (1) INCH LONG,
ADJUST SCALE ACCORDINGLY


CONTRACTOR SHALL FIELD VERIFY
ALL DIMENSIONS.
VARIANCE FROM CONTRACT
DOCUMENTS NOT PERMITTED
WITHOUT PROFESSIONAL & BUREAU
OF CONSTRUCTION APPROVAL.

DRAWN BY
M DIMONTE
DATE
06/17/2022
CHECKED BY
J ADAMS
SCALE
AS NOTED

DRAWING No.
S-33
114 OF 144

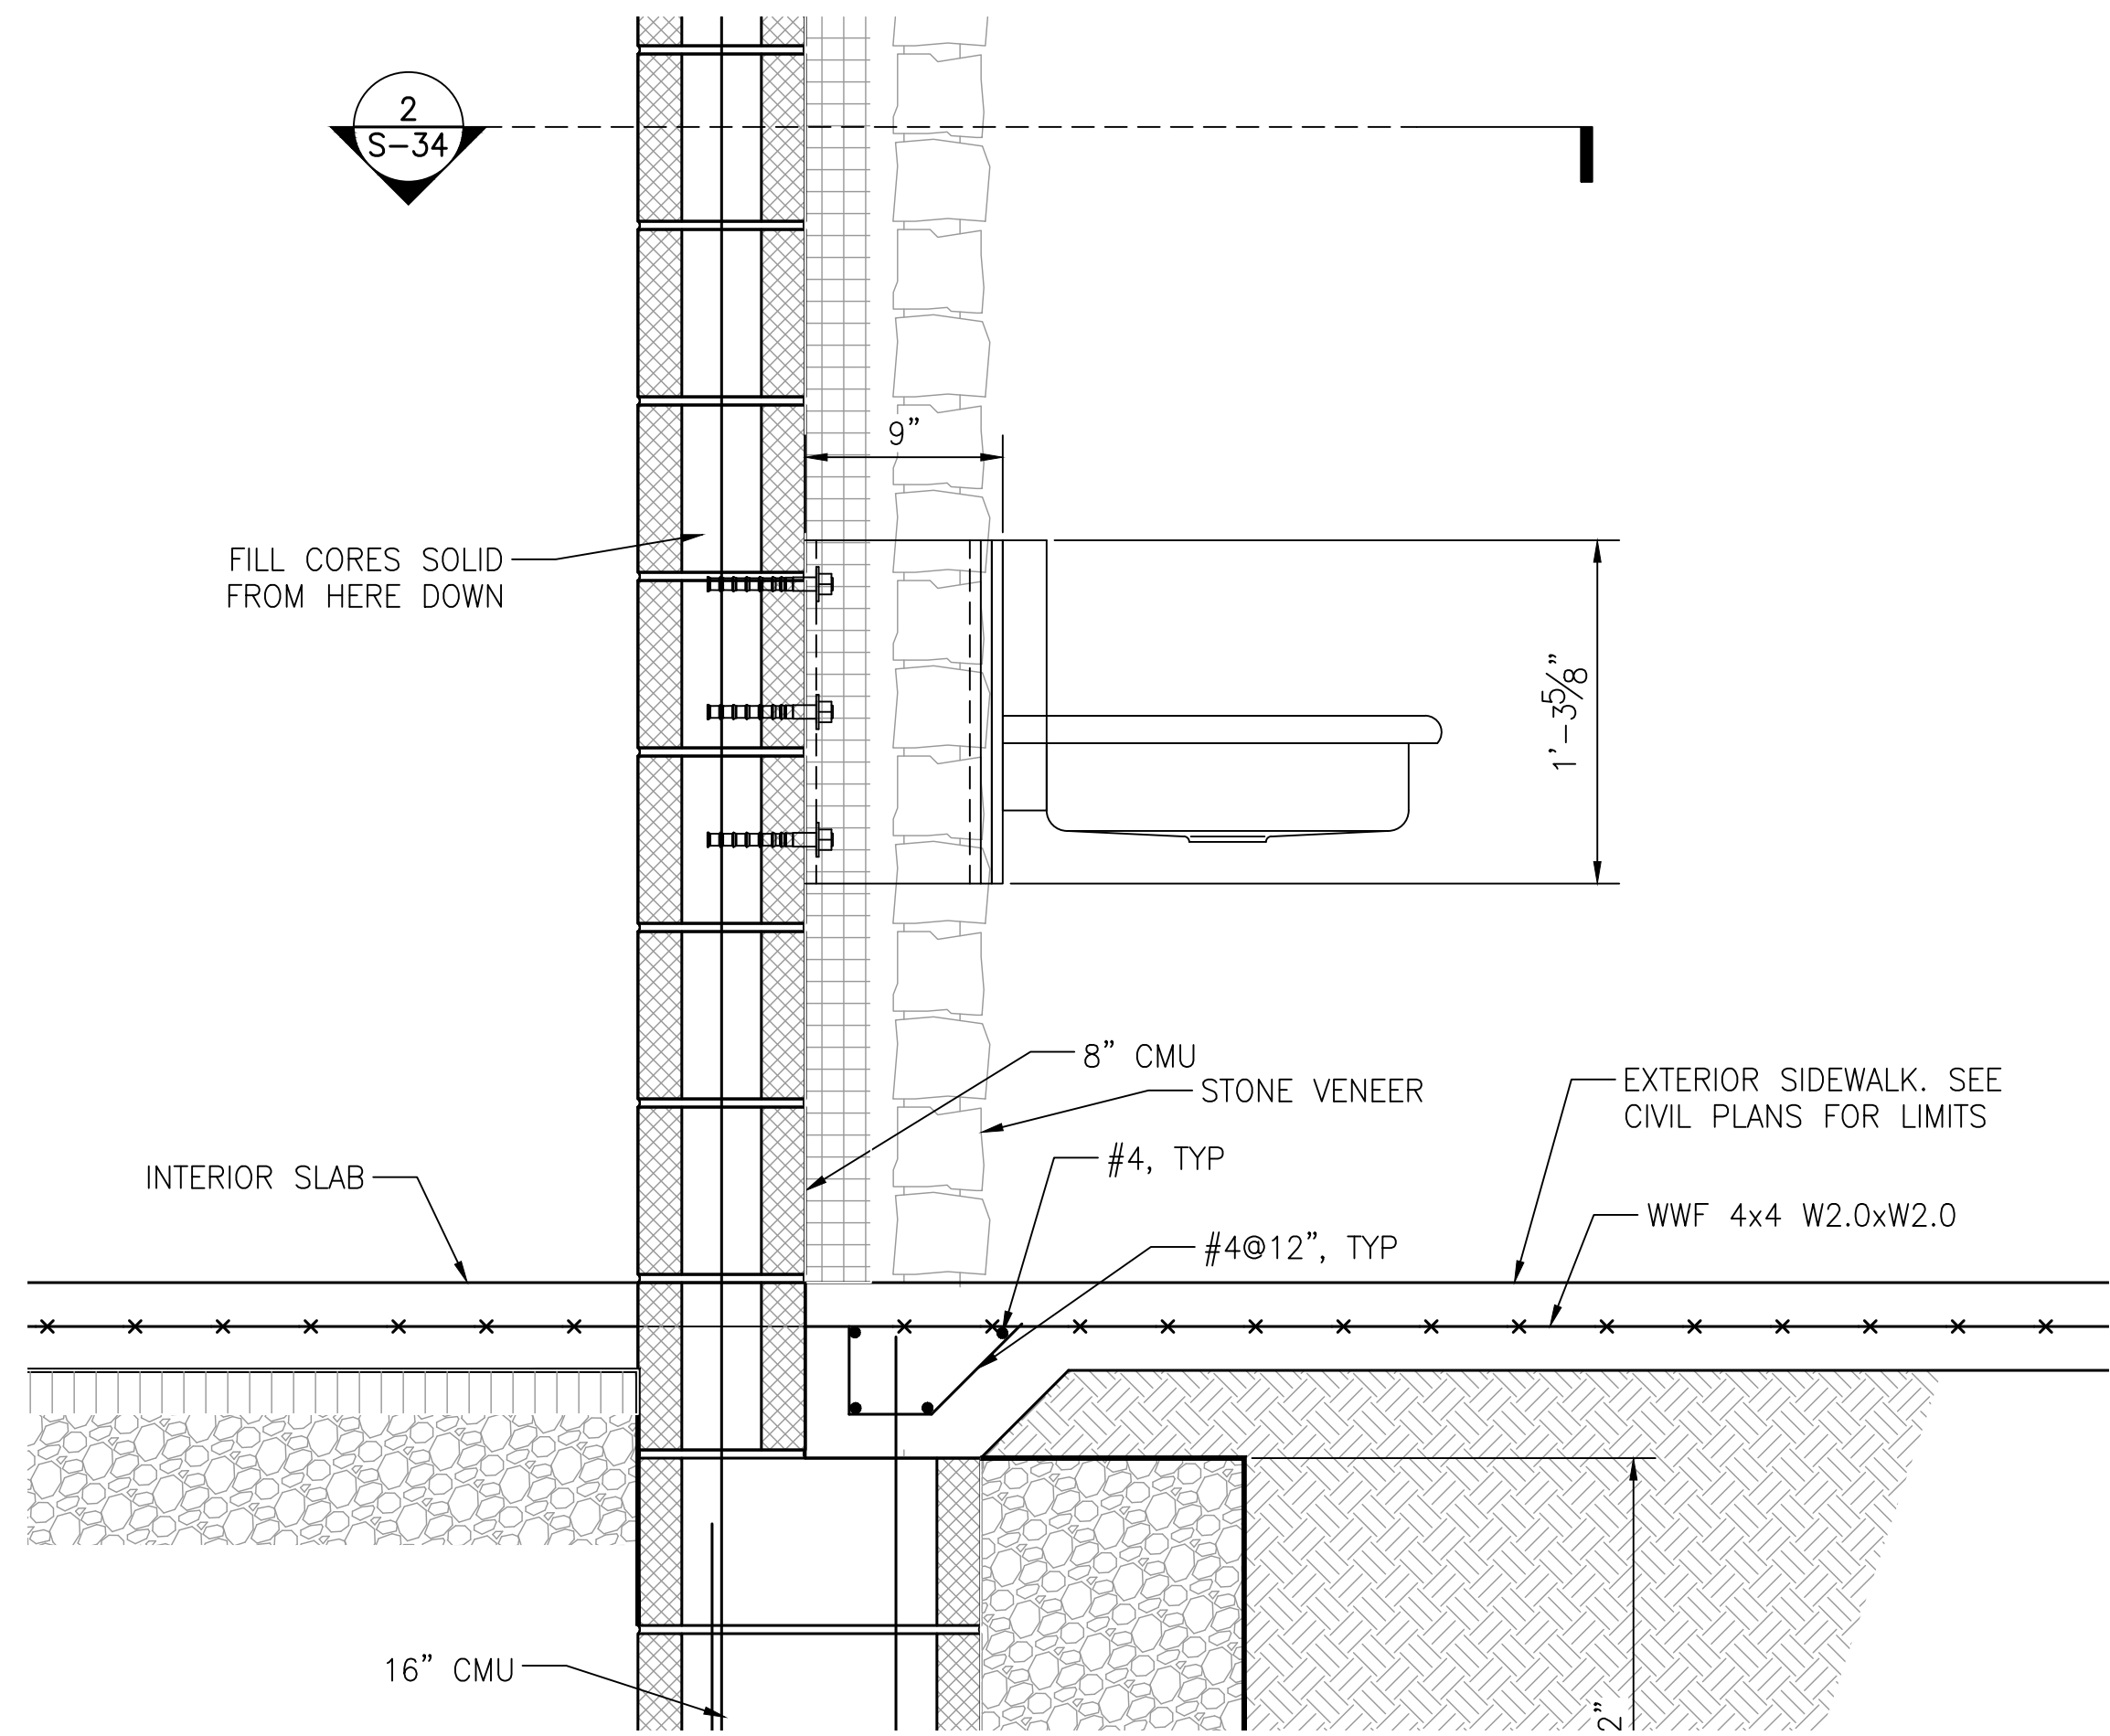


1 DETAIL
S-34 FOUNDATION DETAIL 16" 1 1/2"=1'-0"

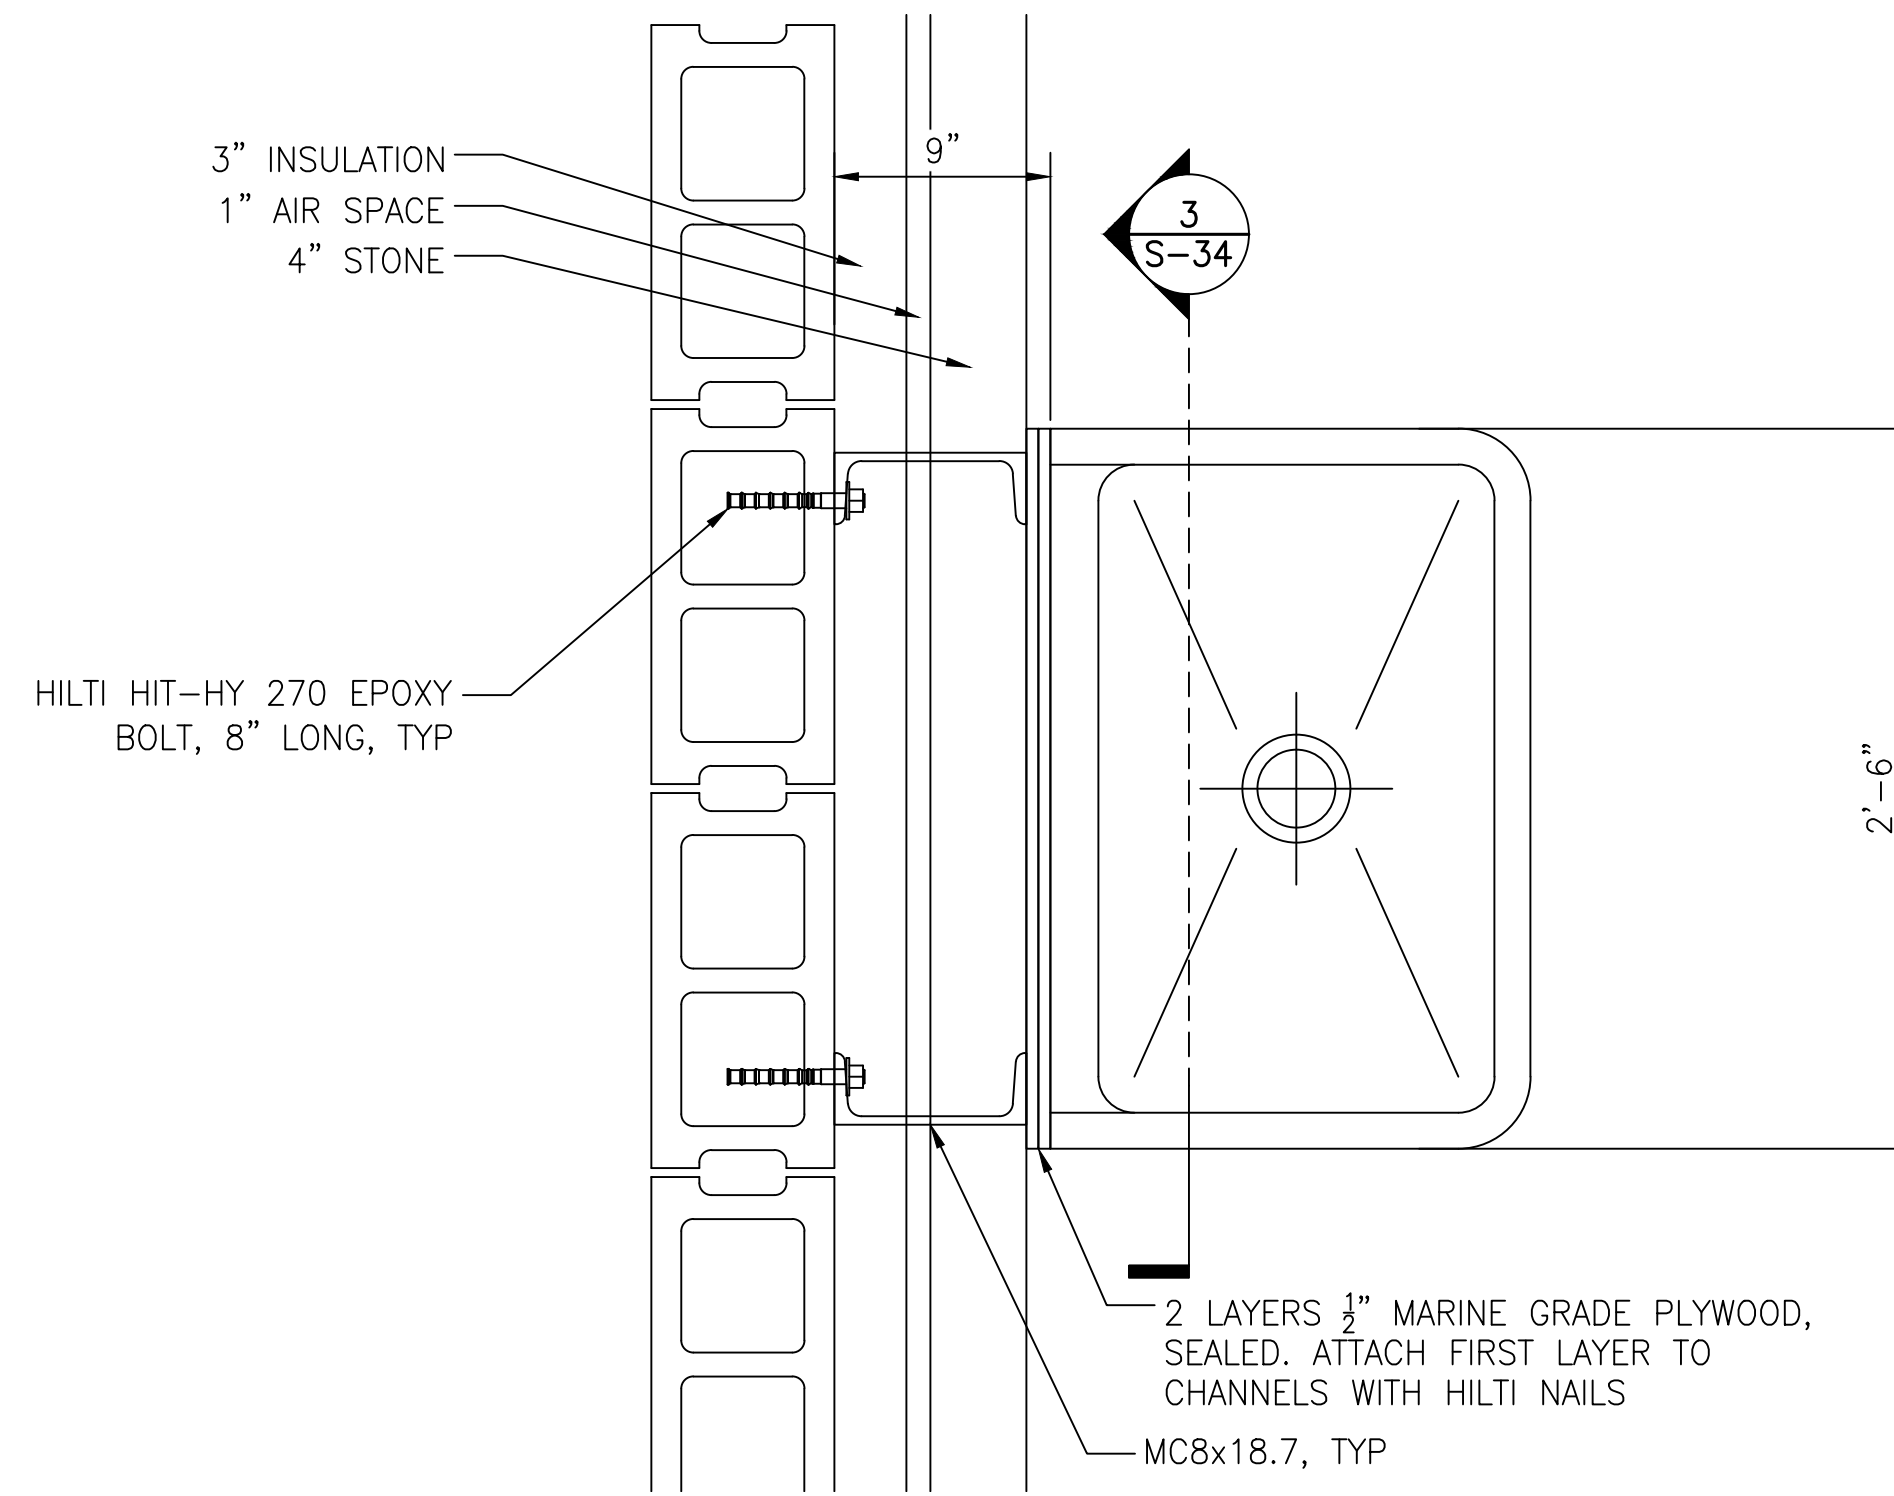

2 DETAIL
S-34 FOUNDATION DETAIL 16" 1 1/2"=1'-0"

NOTE: ADA SINK SHOWN. NON-ADA SINK SIMILAR

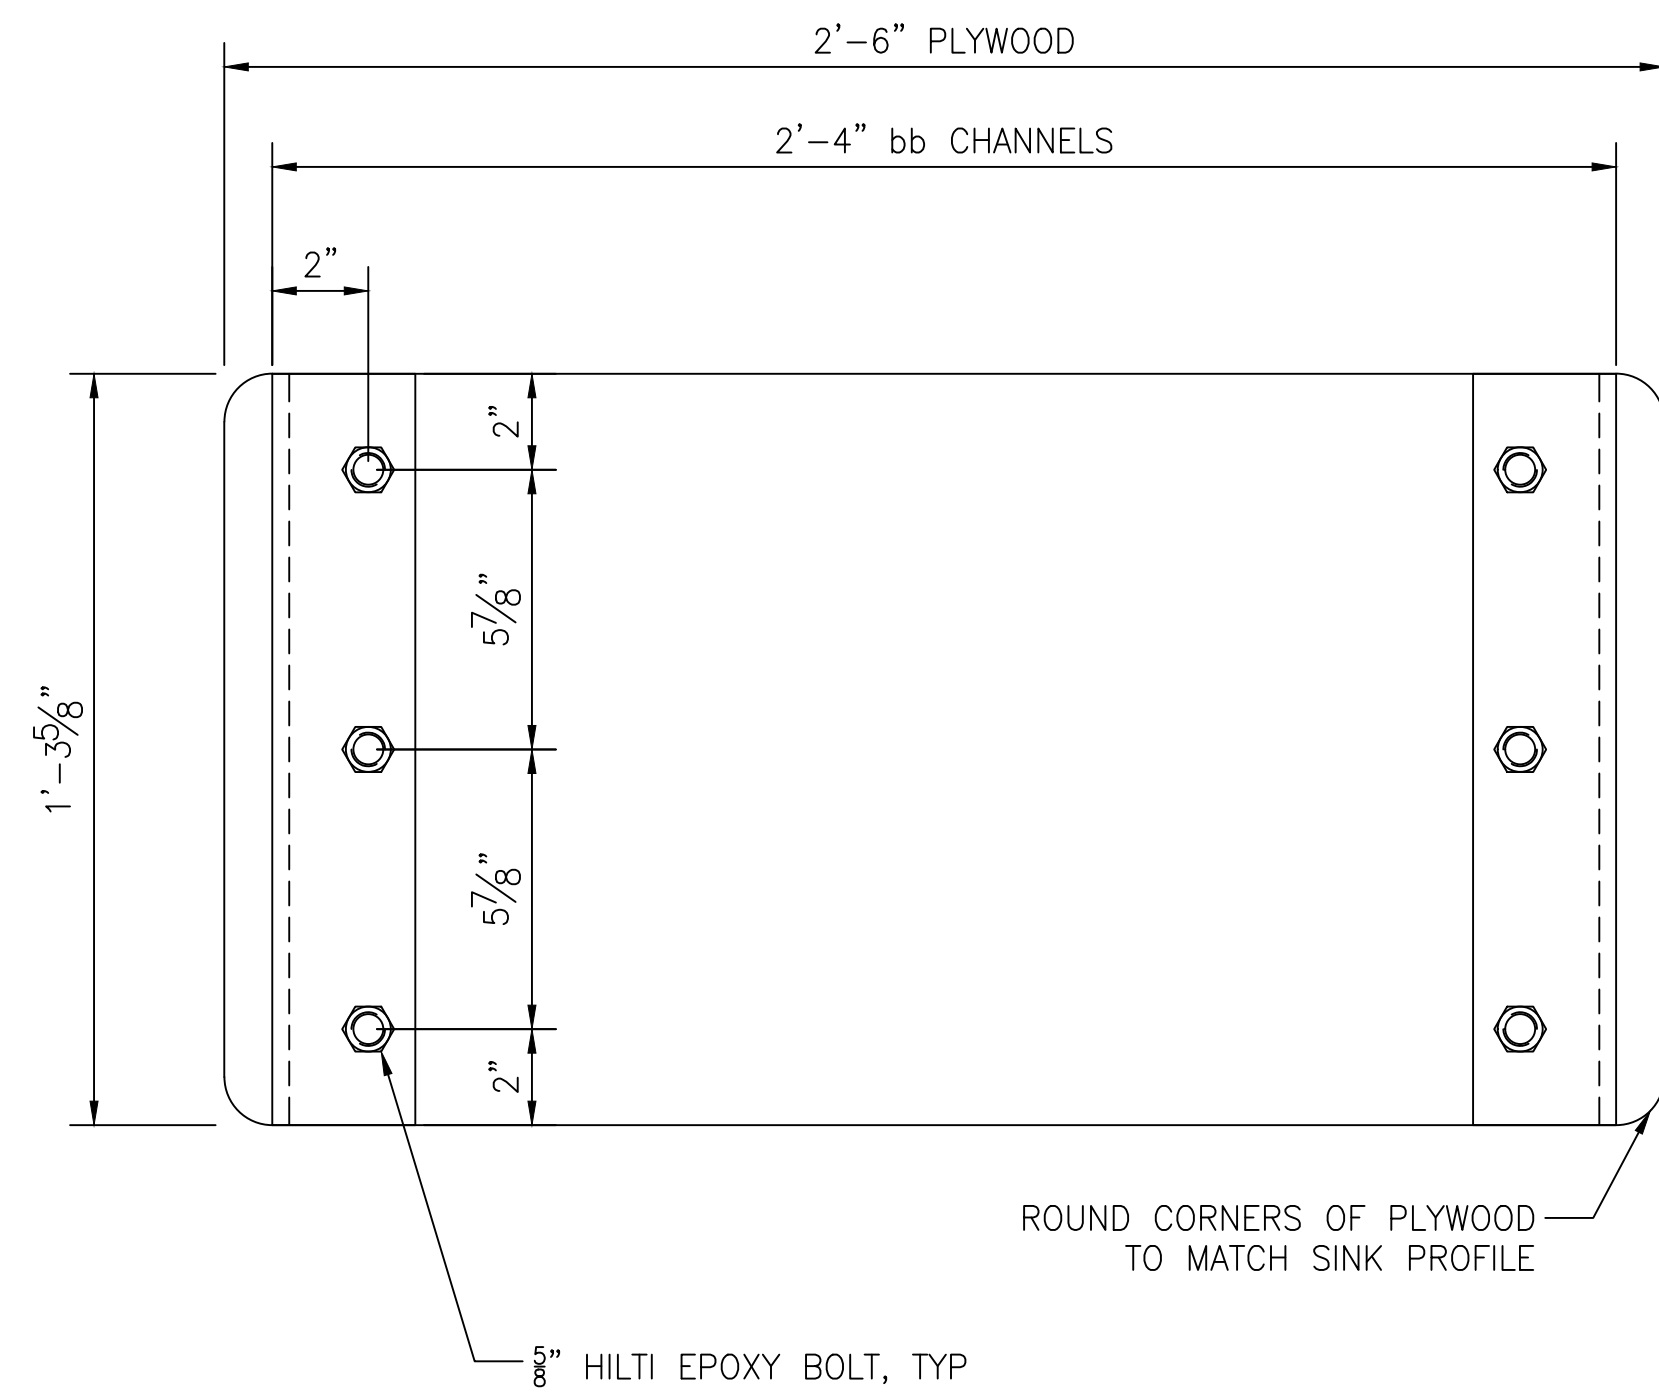


3 DETAIL
S-34 FOUNDATION DETAIL 16" 3"=1'-0"

NOTES:
1. FOR GENERAL NOTES SEE SHEET S-2
2. FOR SYMBOLS AND ABBREVIATIONS SEE SHEET S-1

CONSTRUCTION DOCUMENTS



RECORD REVISIONS

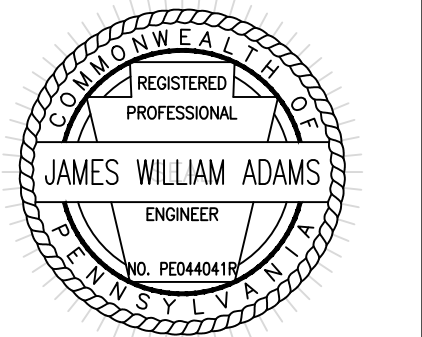

James W. Adams
SIGNATURE DATE 11/19/21

SMP ARCHITECTS
1600 WALNUT STREET, SECOND FLOOR
PHILADELPHIA, PENNSYLVANIA

COMMONWEALTH OF PENNSYLVANIA
DEPARTMENT OF GENERAL SERVICES
HARRISBURG, PENNSYLVANIA

D.G.S. PROJECT No.
C-114-0006 PHASE 1

HICKORY RUN STATE PARK
LATRINE IMPROVEMENTS
DEPT of CONSERVATION AND NATURAL RESOURCES
WHITE HAVEN, CARBON COUNTY, PA


SINK SUPPORTS

VERIFY SCALE
BAR IS ONE (1) INCH LONG ON ORIGINAL DRAWING.
0 1
IF BAR IS NOT ONE (1) INCH LONG, ADJUST SCALE ACCORDINGLY


CONTRACTOR SHALL FIELD VERIFY ALL DIMENSIONS. VARIANCE FROM CONTRACT DOCUMENTS NOT PERMITTED WITHOUT PROFESSIONAL & BUREAU OF CONSTRUCTION APPROVAL.	DRAWN BY M DIMONTE	DATE 06/17/2022	DRAWING No. S-34
	CHECKED BY J ADAMS	SCALE AS NOTED	

115 OF 144


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PLOTTED BY: James Adams
PLOTTED: 2022.06.17 09:08 AM
LAST SAVED: 2022.06.10 01:08 PM

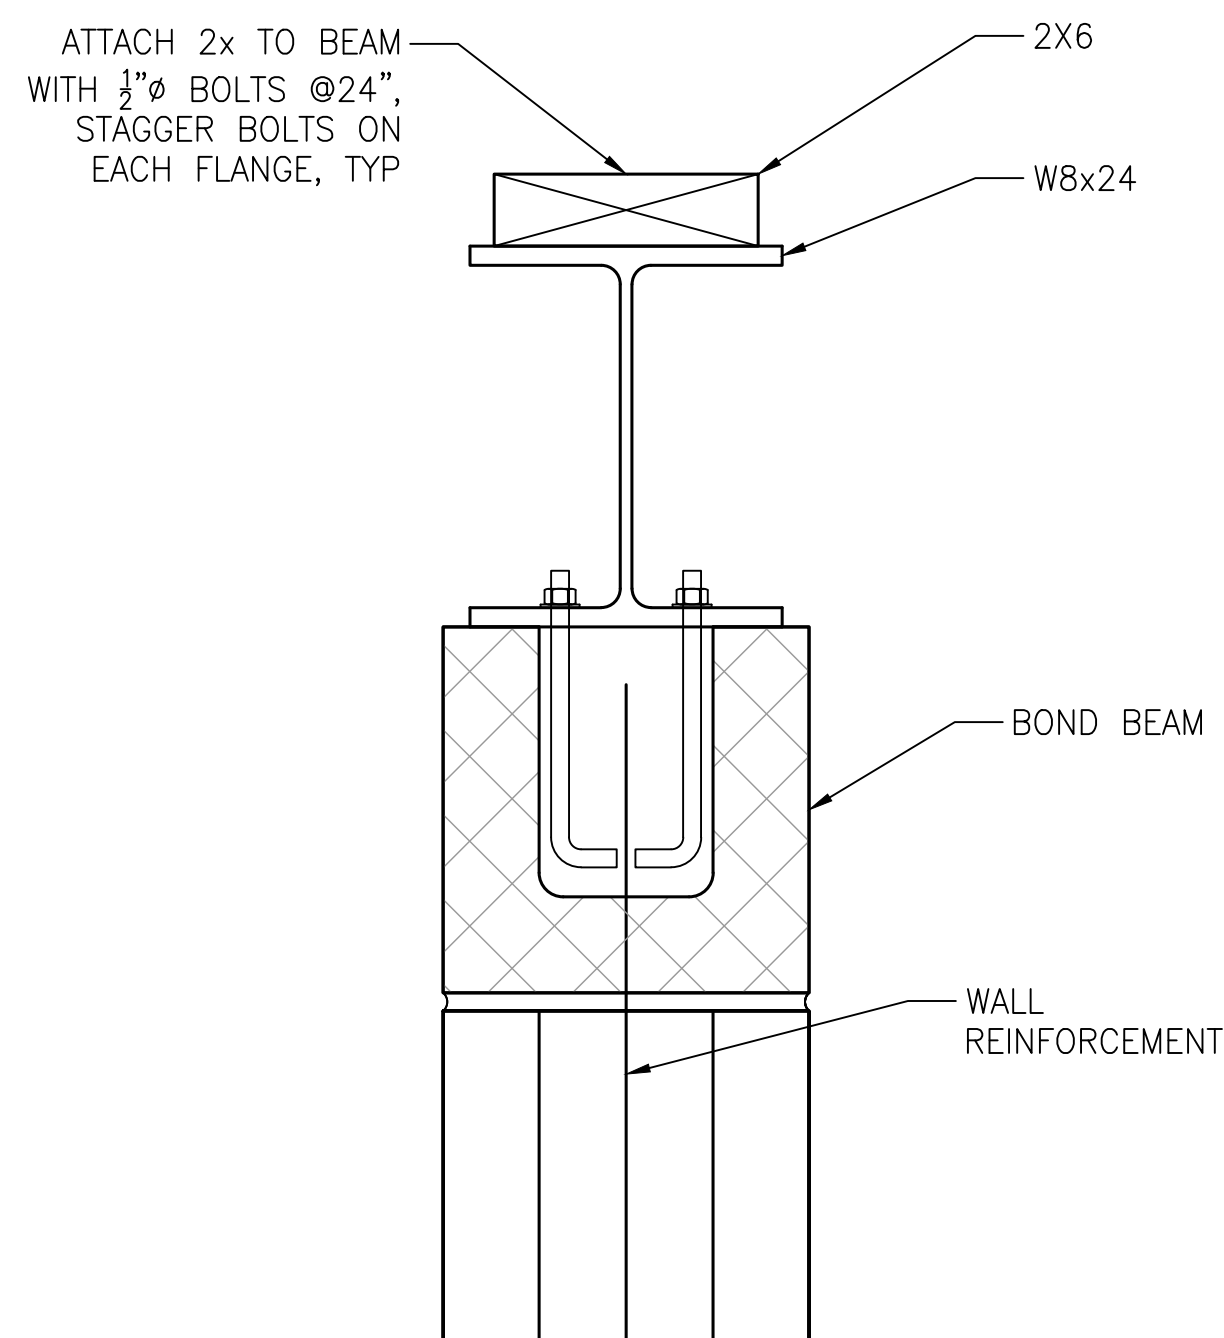


1 SECTION
S-35 END OF LINTEL 3"=1'-0"

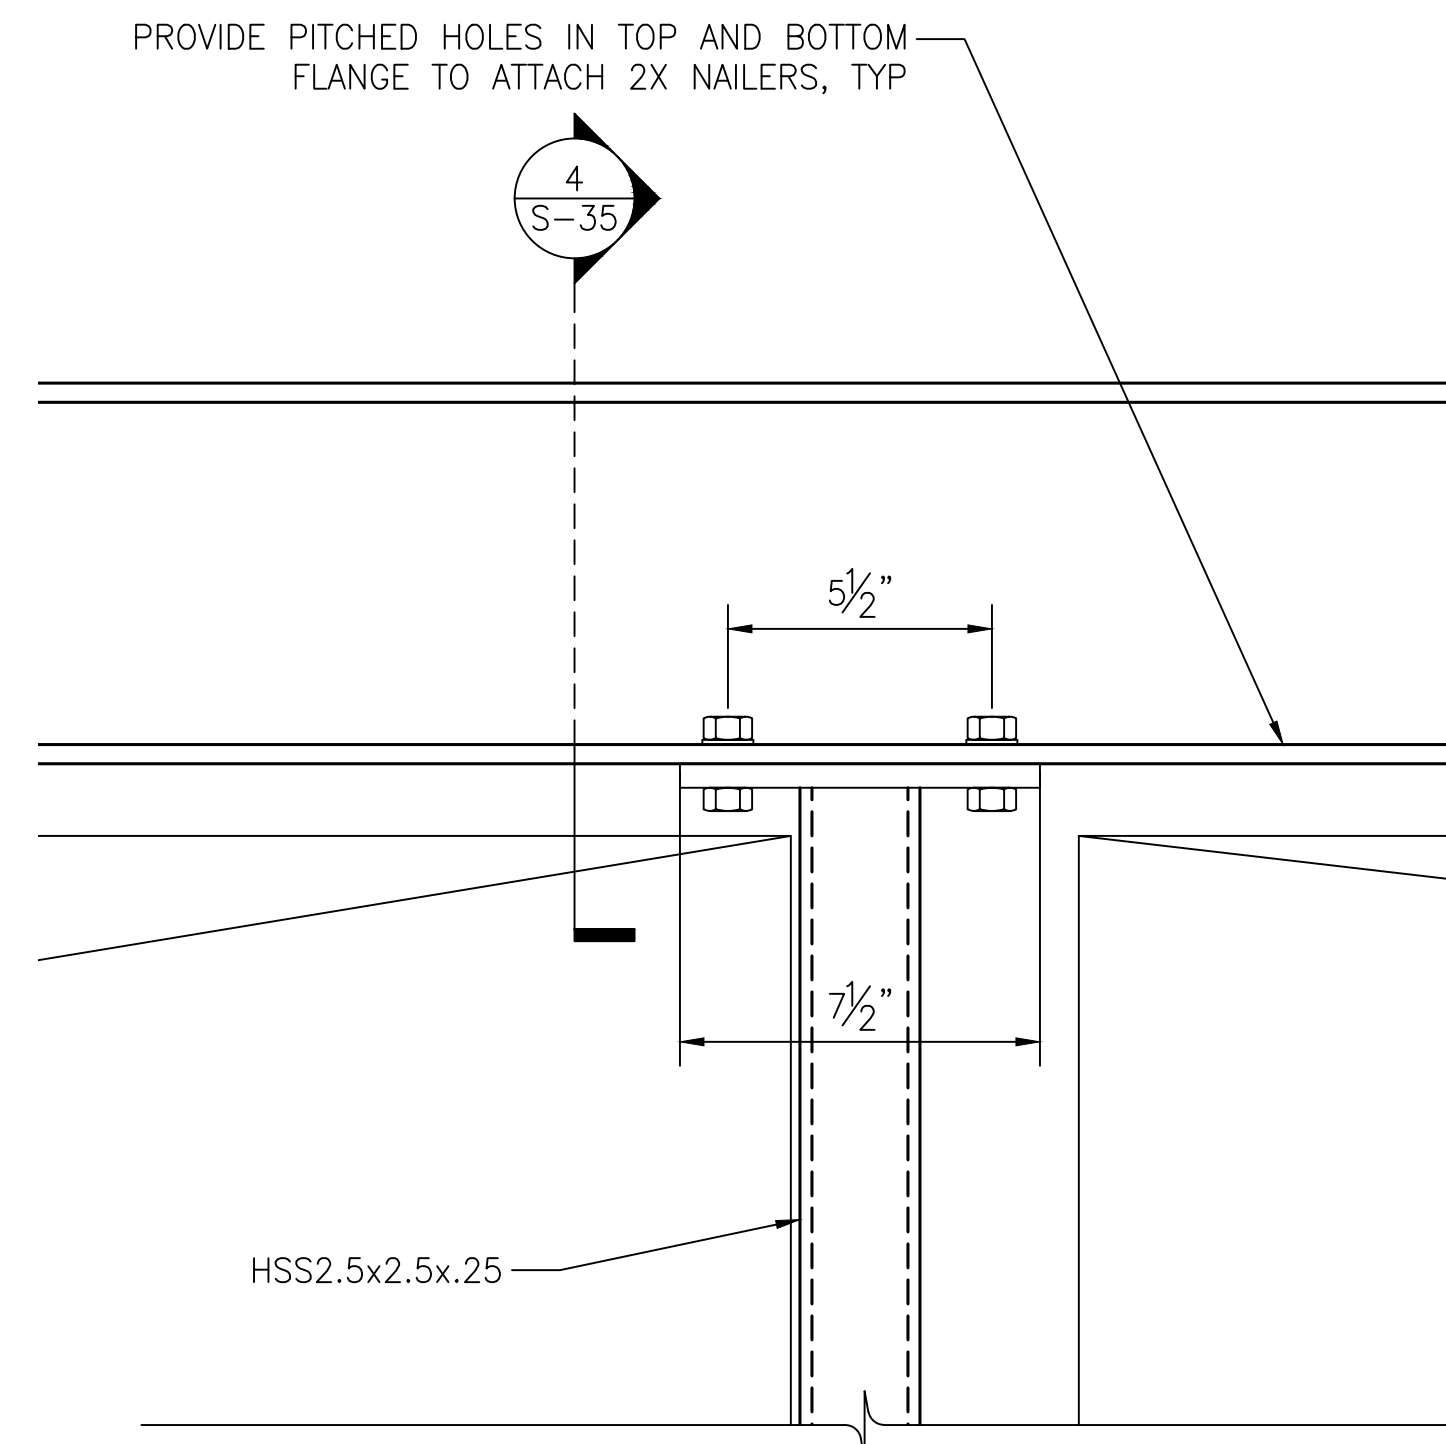


4 SECTION
S-35 COLUMN/WALL CONNECTION 3"=1'-0"

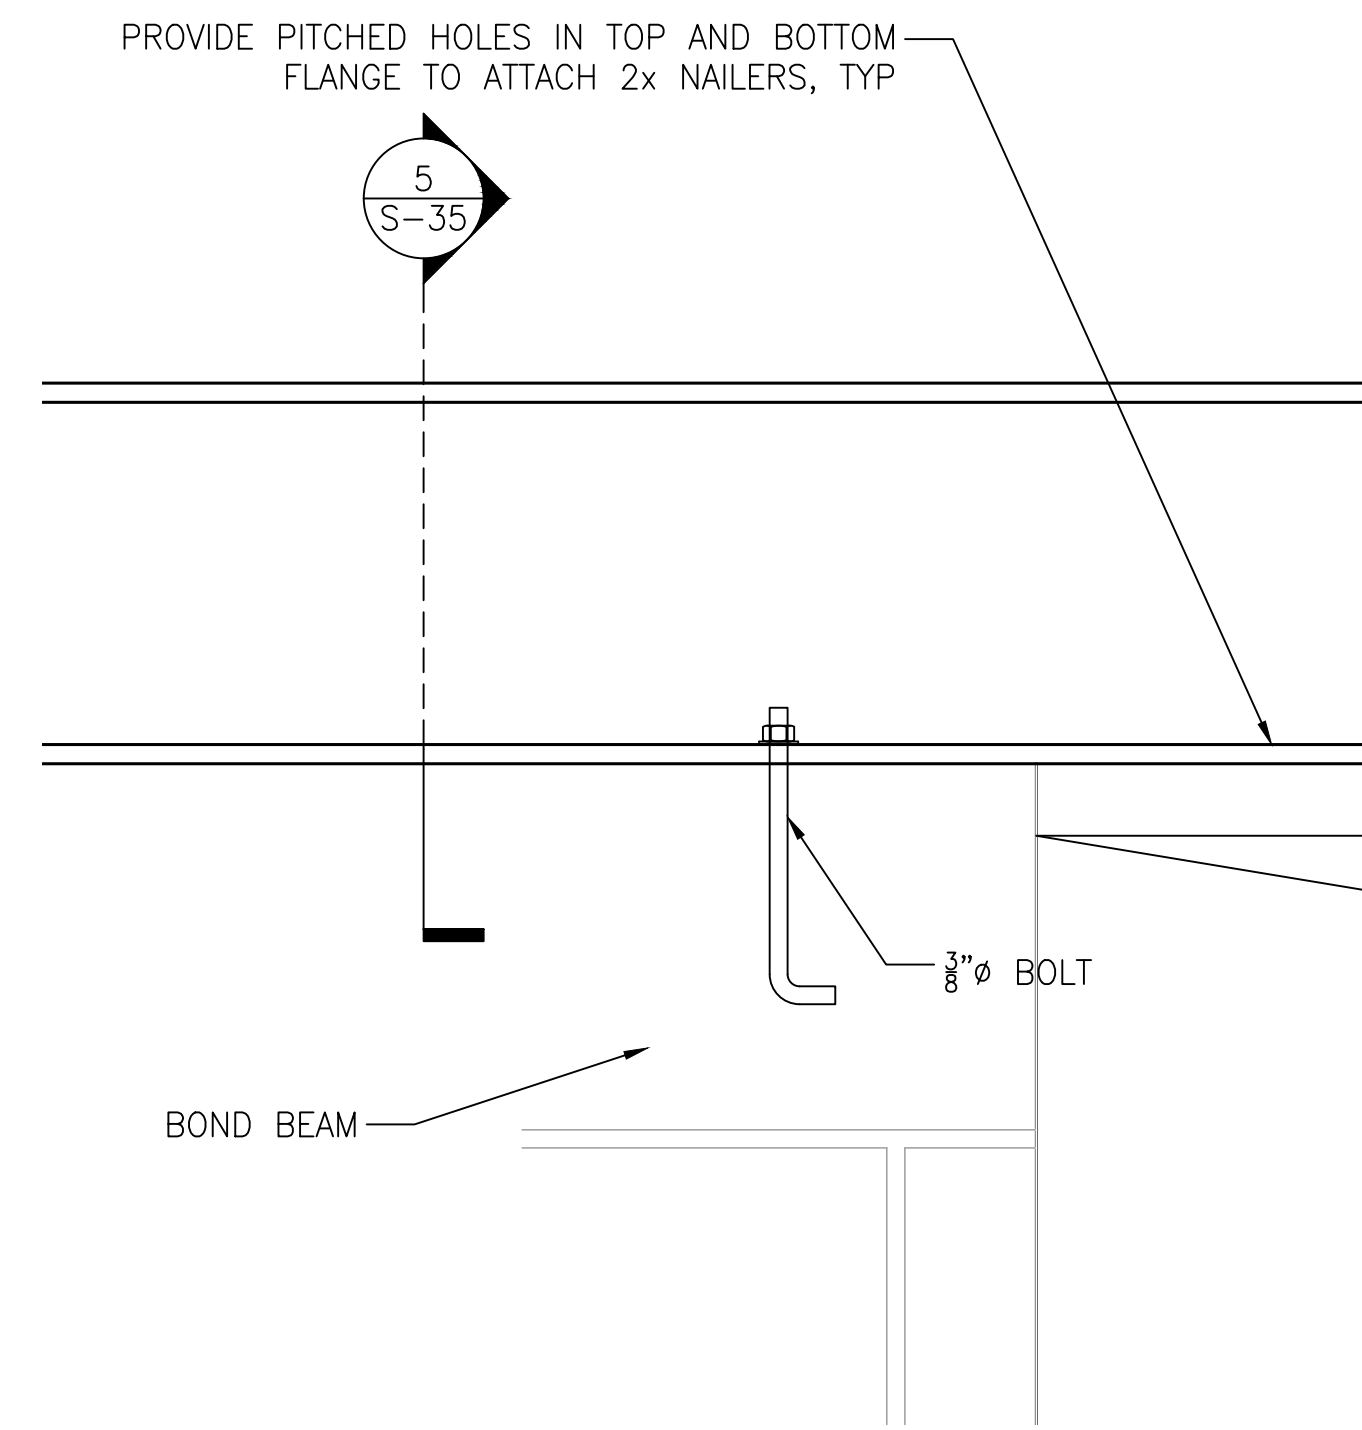


5 SECTION
S-35 COLUMN/WALL CONNECTION 1 1/2"=1'-0"

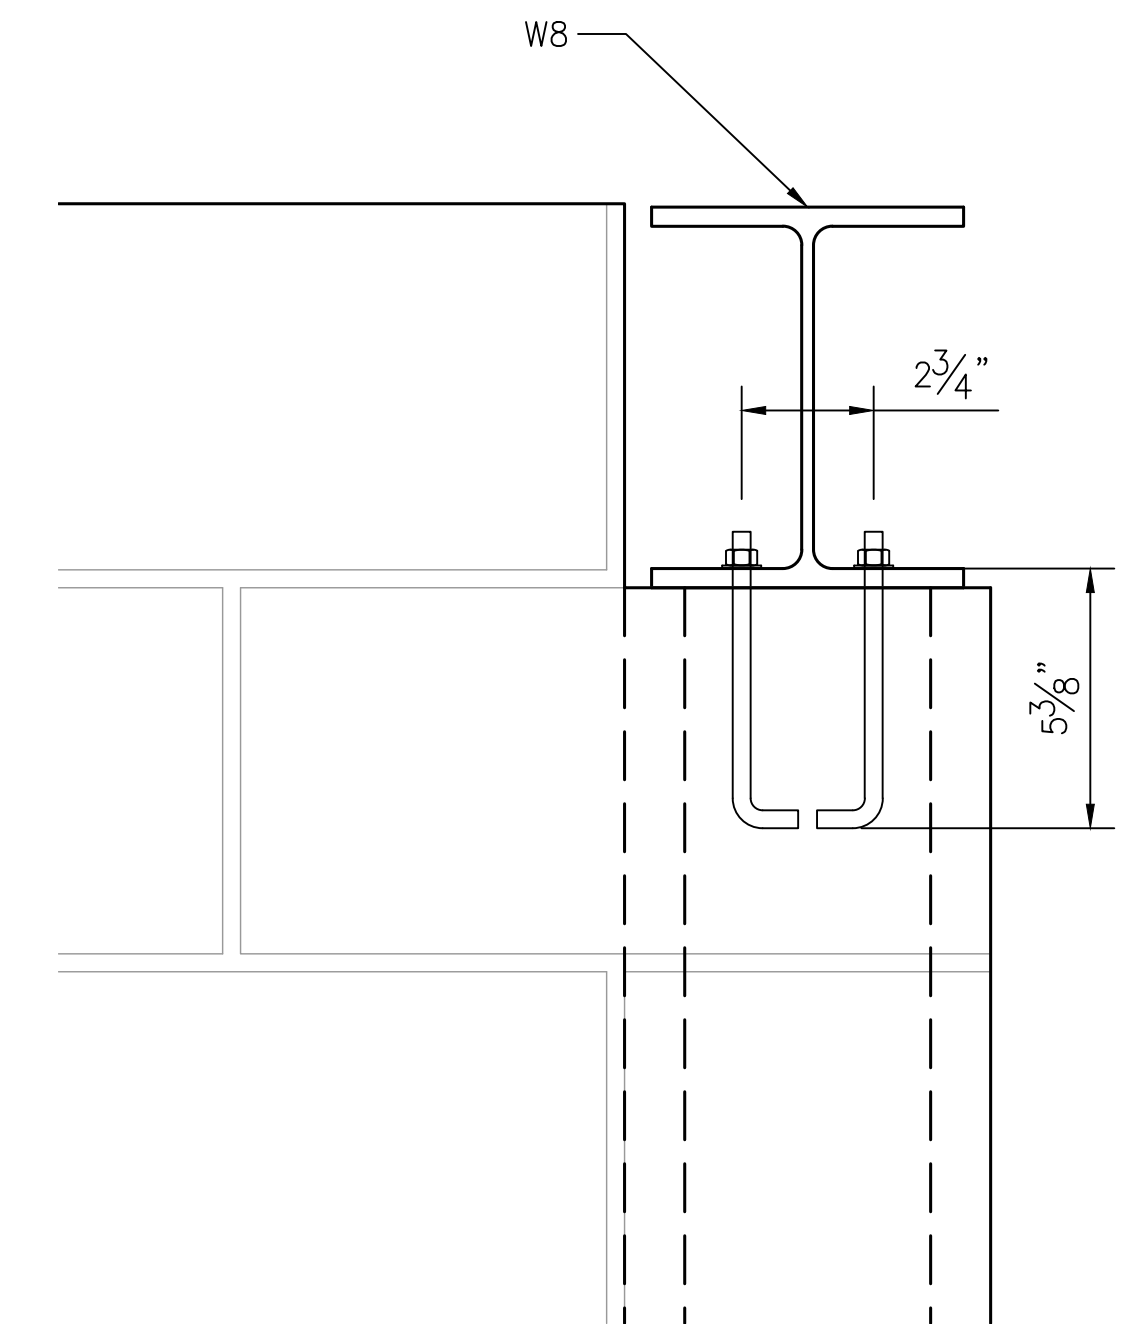


5 SECTION
S-35 COLUMN/BEAM CONNECTION 3"=1'-0"

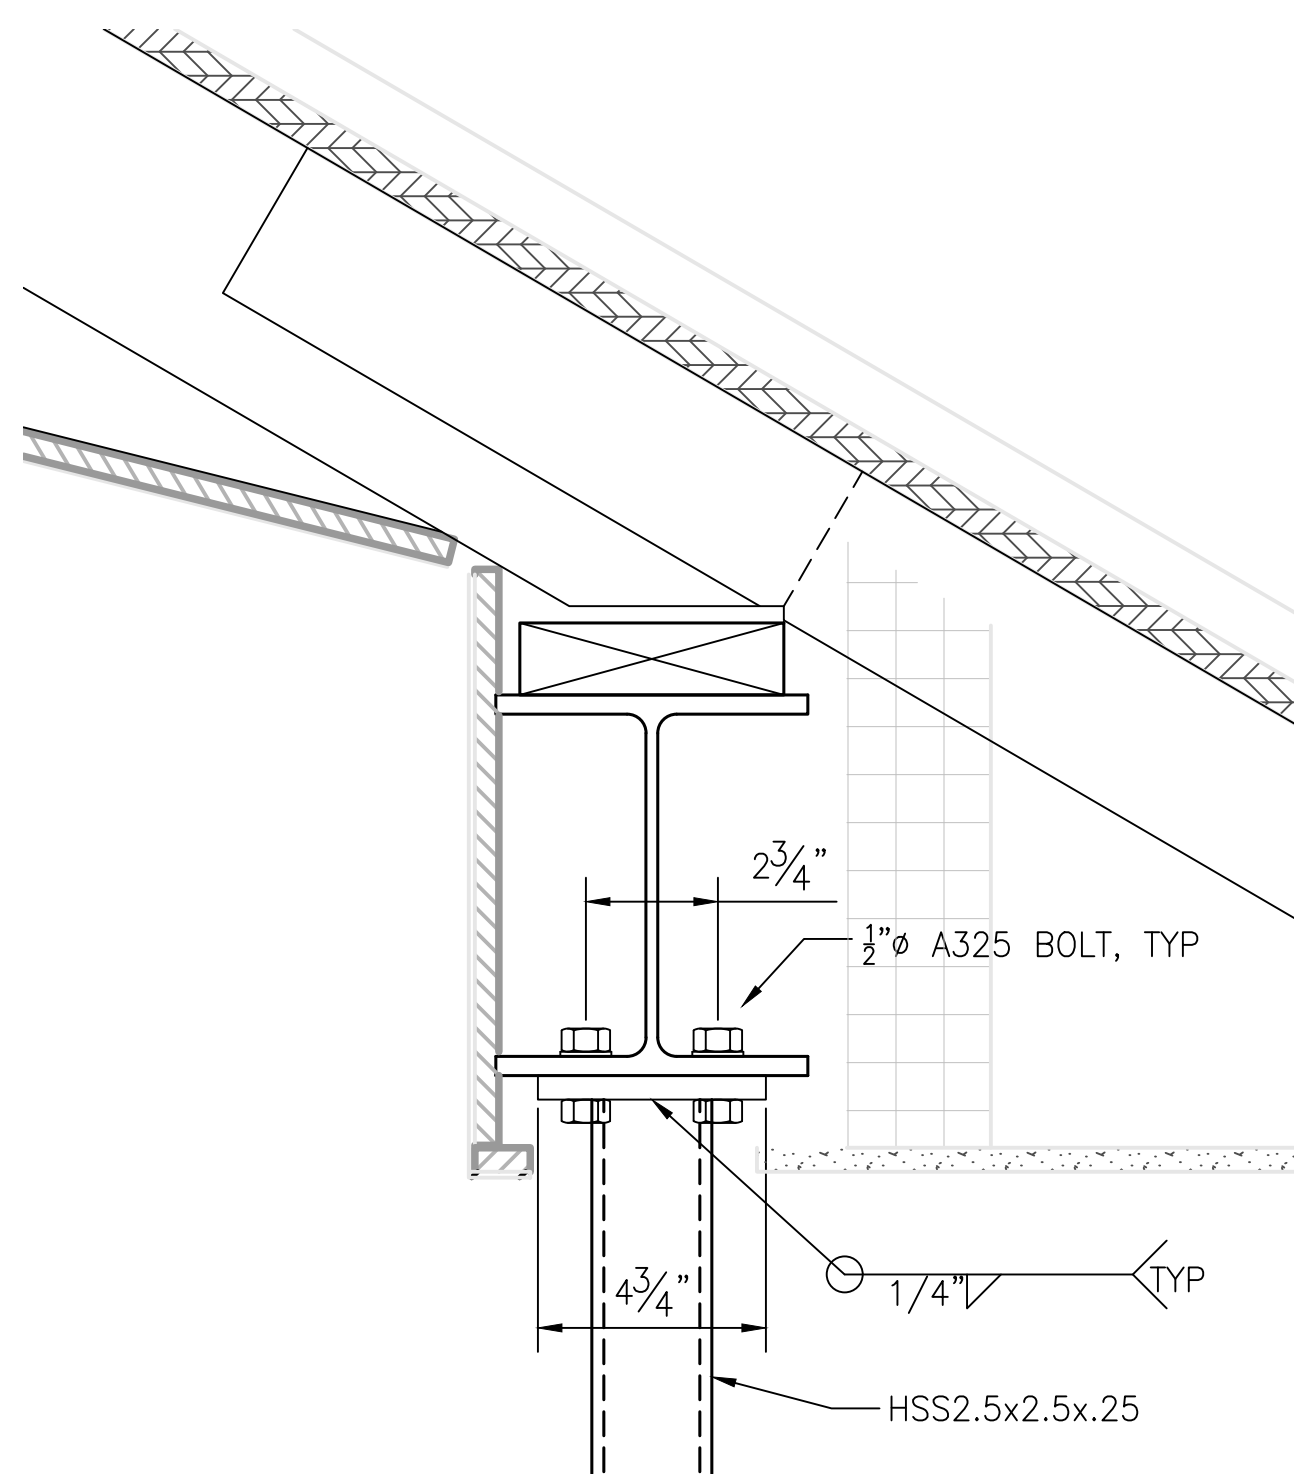

4 SECTION
S-35 COLUMN/BEAM CONNECTION 3"=1'-0"

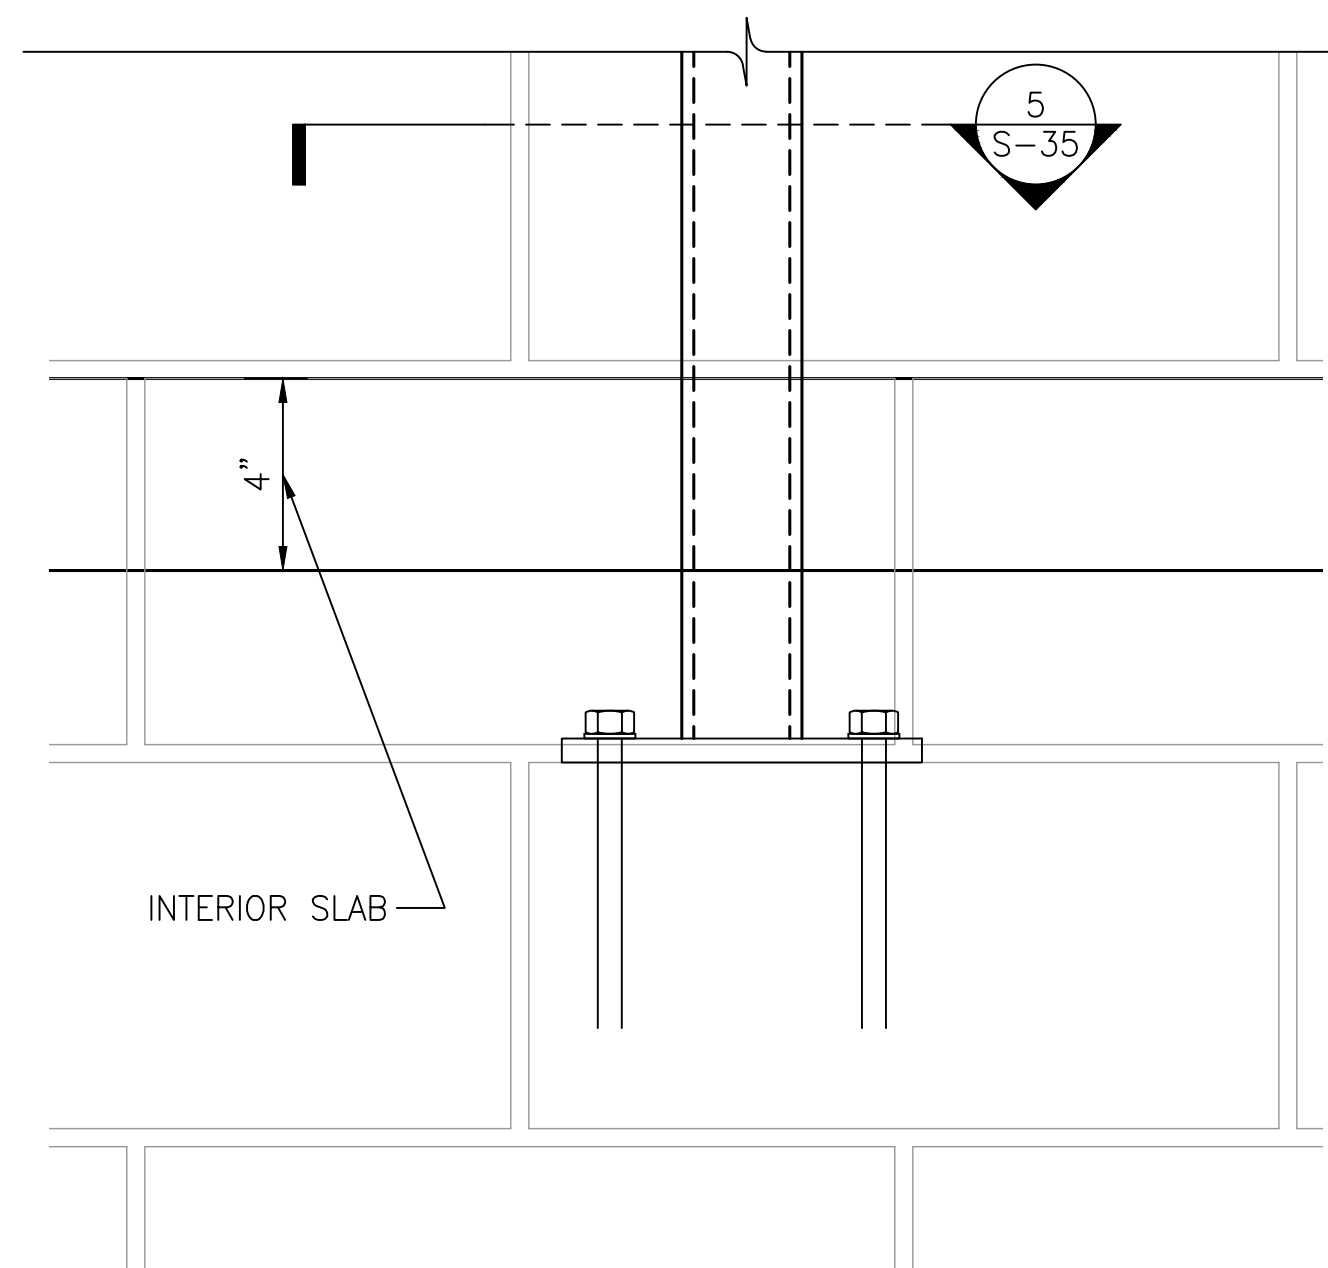

2 SECTION
S-35 COLUMN/BEAM CONNECTION 3"=1'-0"

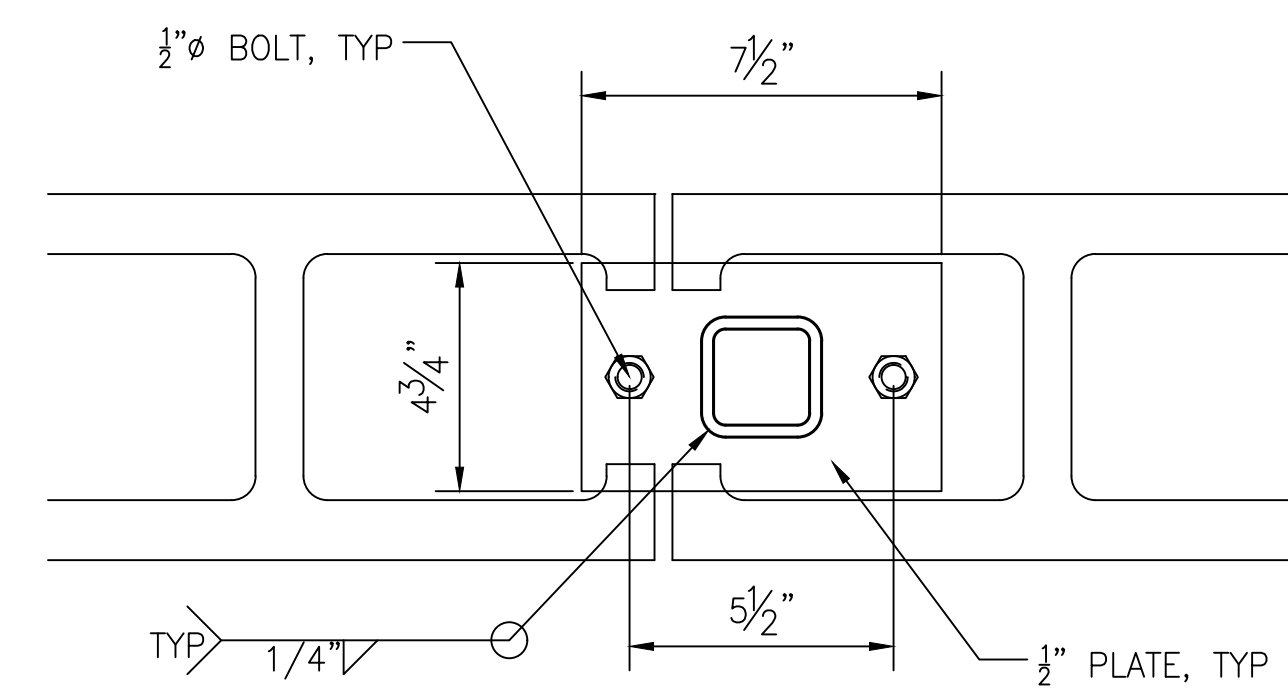

5 SECTION
S-35 COLUMN/BEAM CONNECTION 3"=1'-0"


NOTES:
1. FOR GENERAL NOTES SEE SHEET S-2
2. FOR SYMBOLS AND ABBREVIATIONS SEE SHEET S-1

CONSTRUCTION DOCUMENTS



NO.	DATE	DESCRIPTION

RECORD REVISIONS

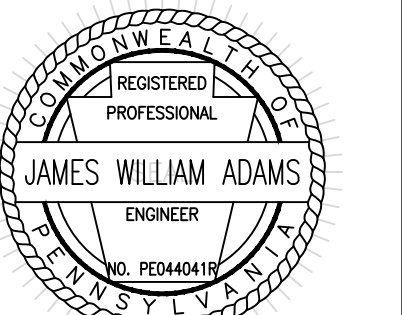

James W. Adams
11/19/21
SIGNATURE DATE

SMP ARCHITECTS
1600 WALNUT STREET, SECOND FLOOR
PHILADELPHIA, PENNSYLVANIA




COMMONWEALTH OF PENNSYLVANIA
DEPARTMENT OF GENERAL SERVICES
HARRISBURG, PENNSYLVANIA

D.G.S. PROJECT No.
C-114-0006 PHASE 1

HICKORY RUN STATE PARK
LATRINE IMPROVEMENTS
DEPT of CONSERVATION AND NATURAL RESOURCES
WHITE HAVEN, CARBON COUNTY, PA

COMMON DETAILS - SHEET 1

VERIFY SCALE	BAR IS ONE (1) INCH LONG ON ORIGINAL DRAWING. 0 1
IF BAR IS NOT ONE (1) INCH LONG, ADJUST SCALE ACCORDINGLY	
CONTRACTOR SHALL FIELD VERIFY ALL DIMENSIONS. VARIANCE FROM CONTRACT DOCUMENTS NOT PERMITTED WITHOUT PROFESSIONAL & BUREAU OF CONSTRUCTION APPROVAL.	DRAWN BY M DIMONTE
	DATE 06/17/2022
	DRAWING No. S-35
	CHECKED BY J ADAMS
	SCALE AS NOTED

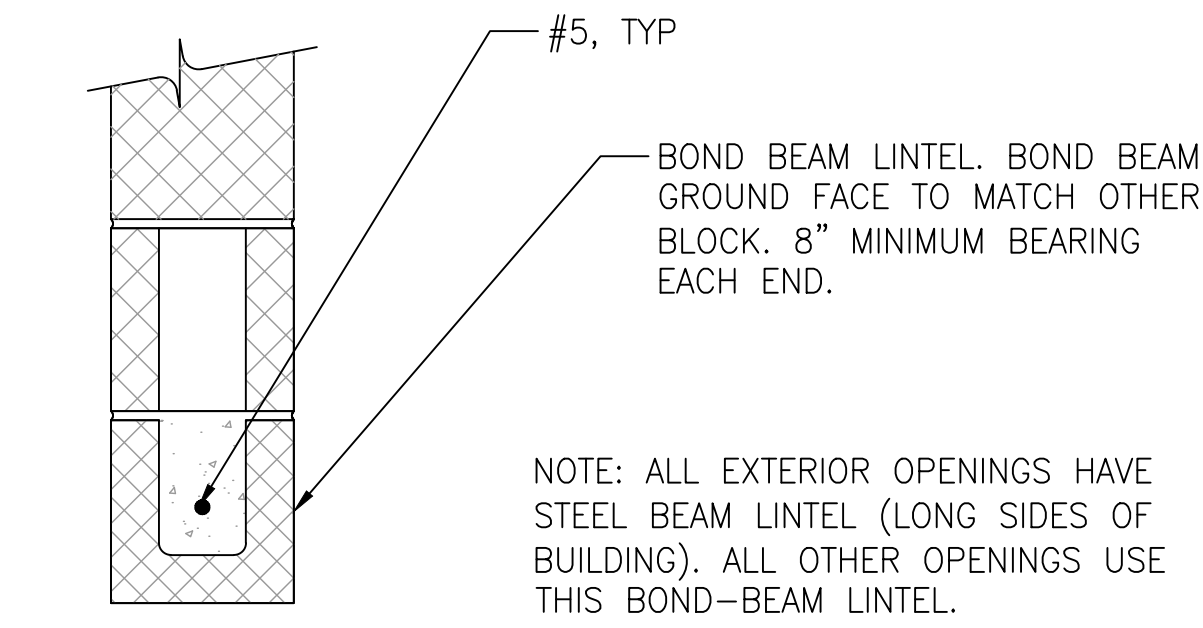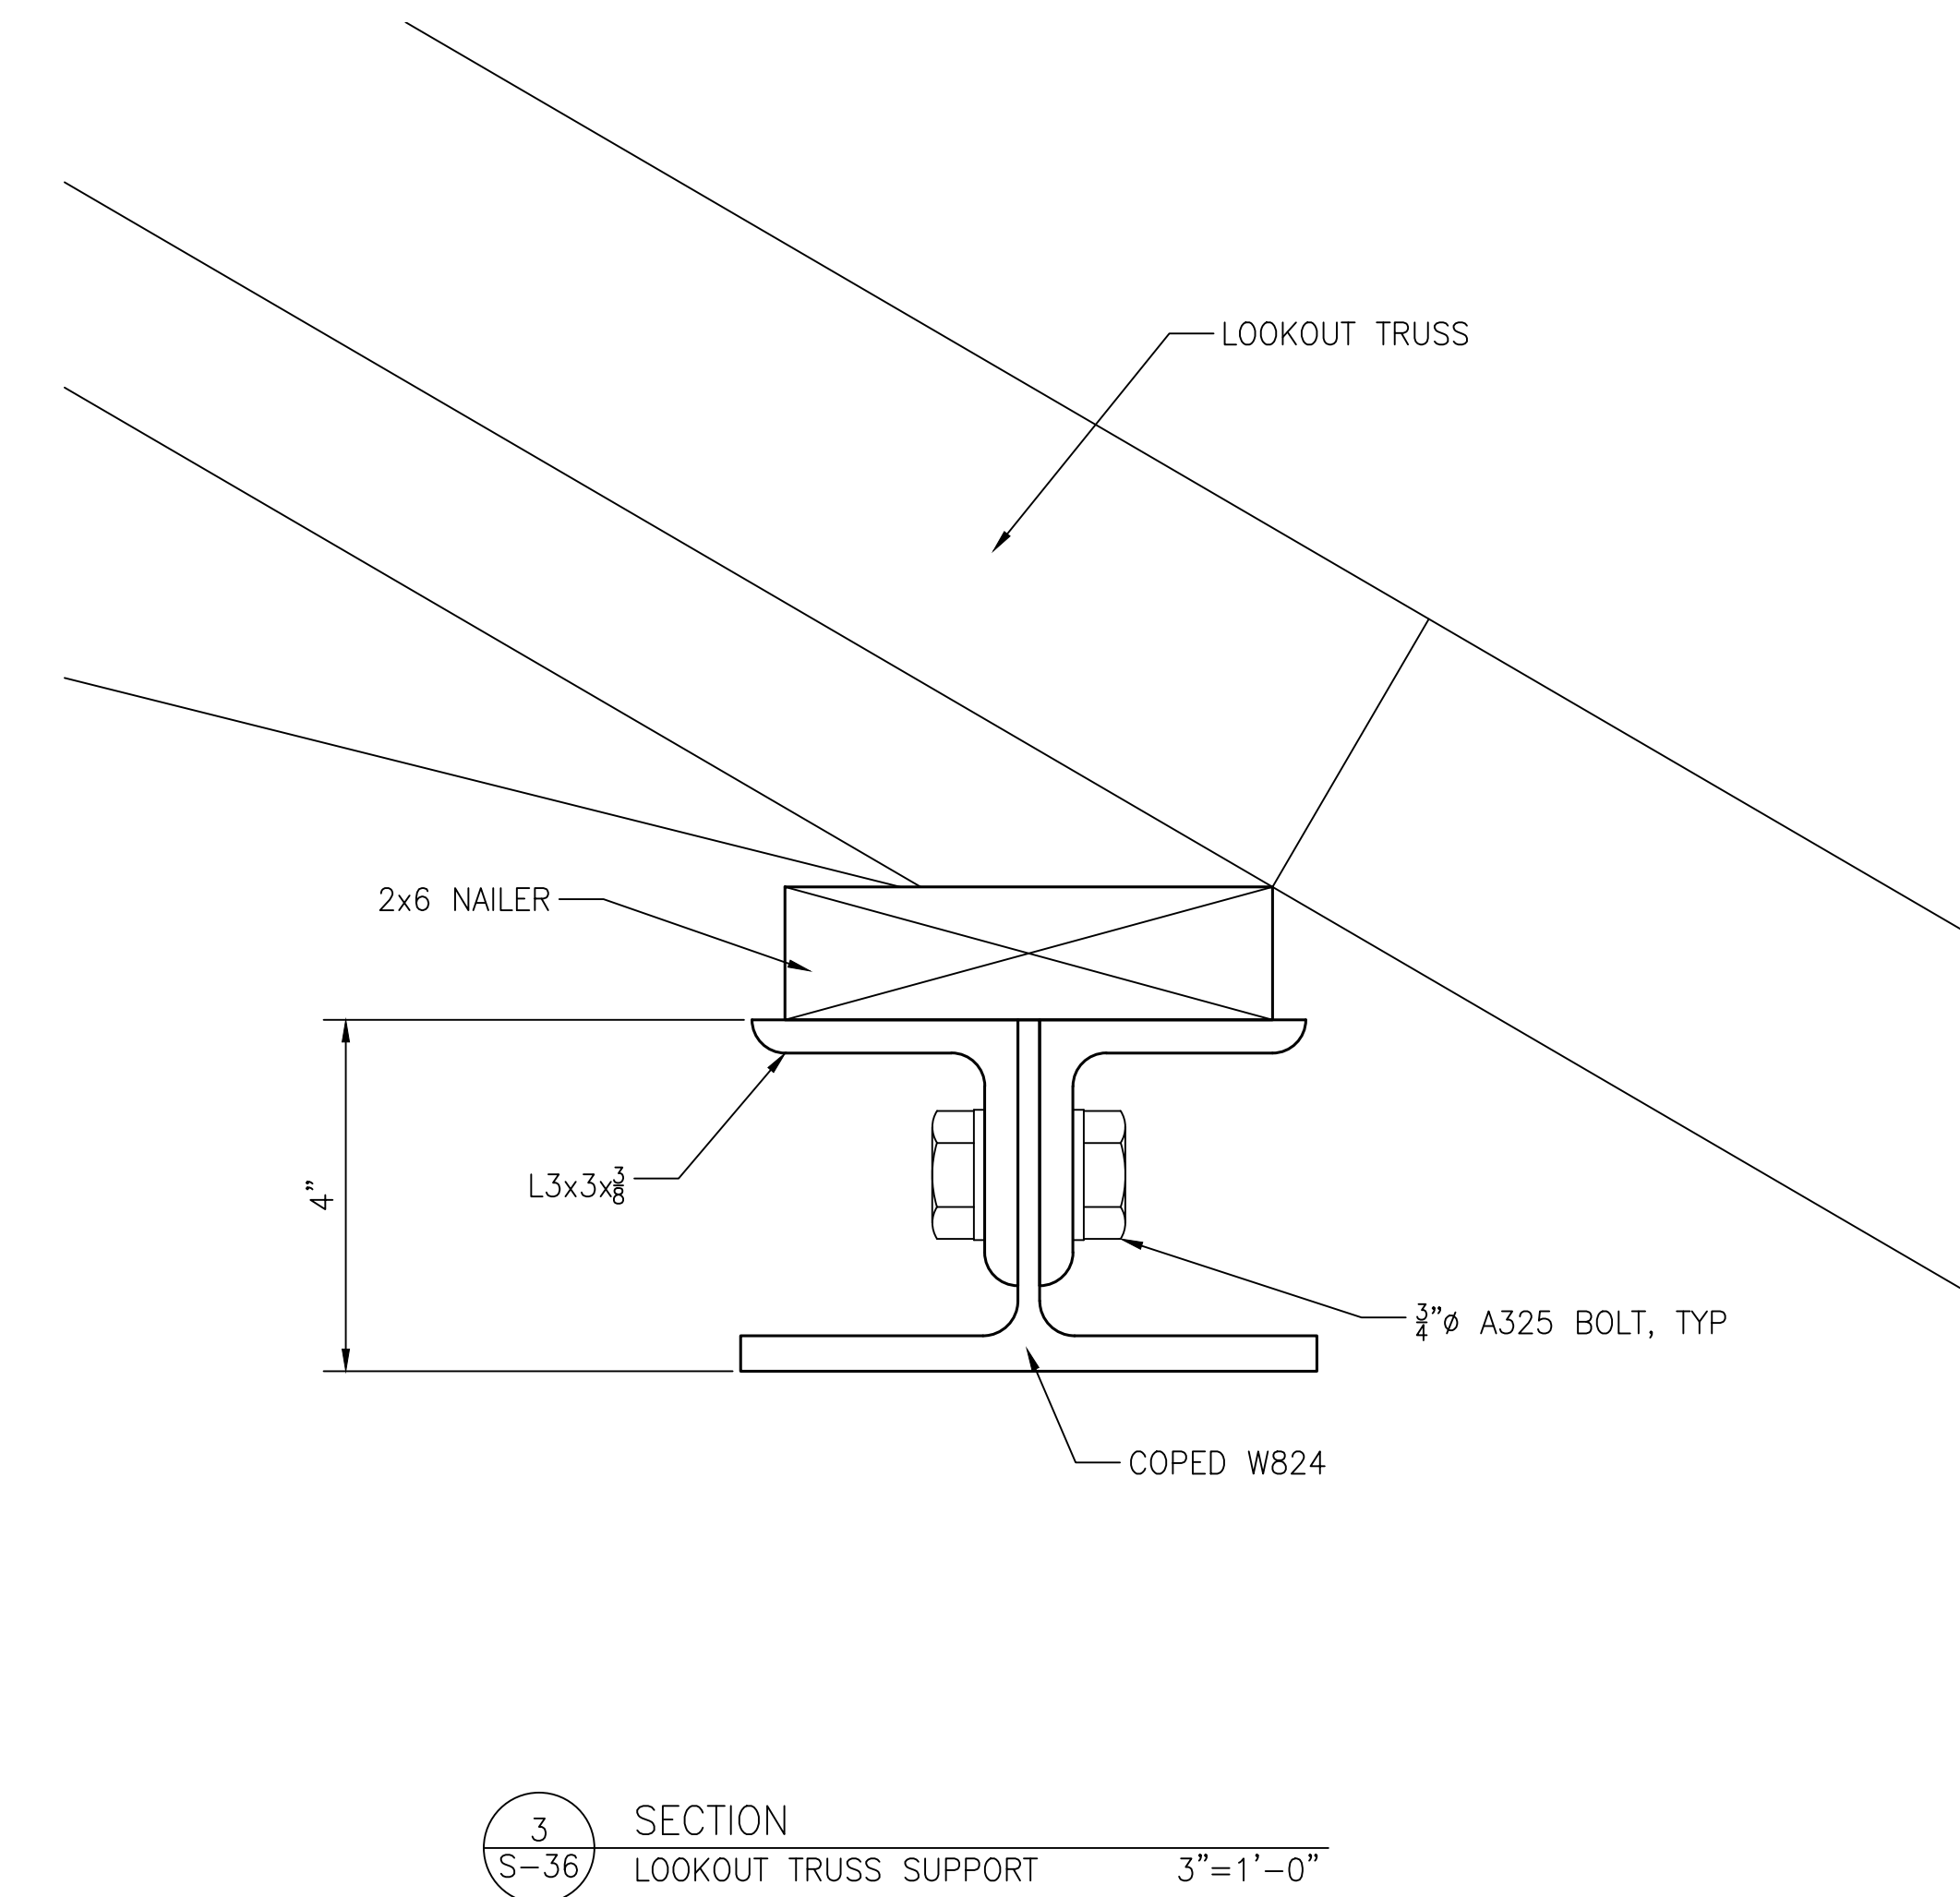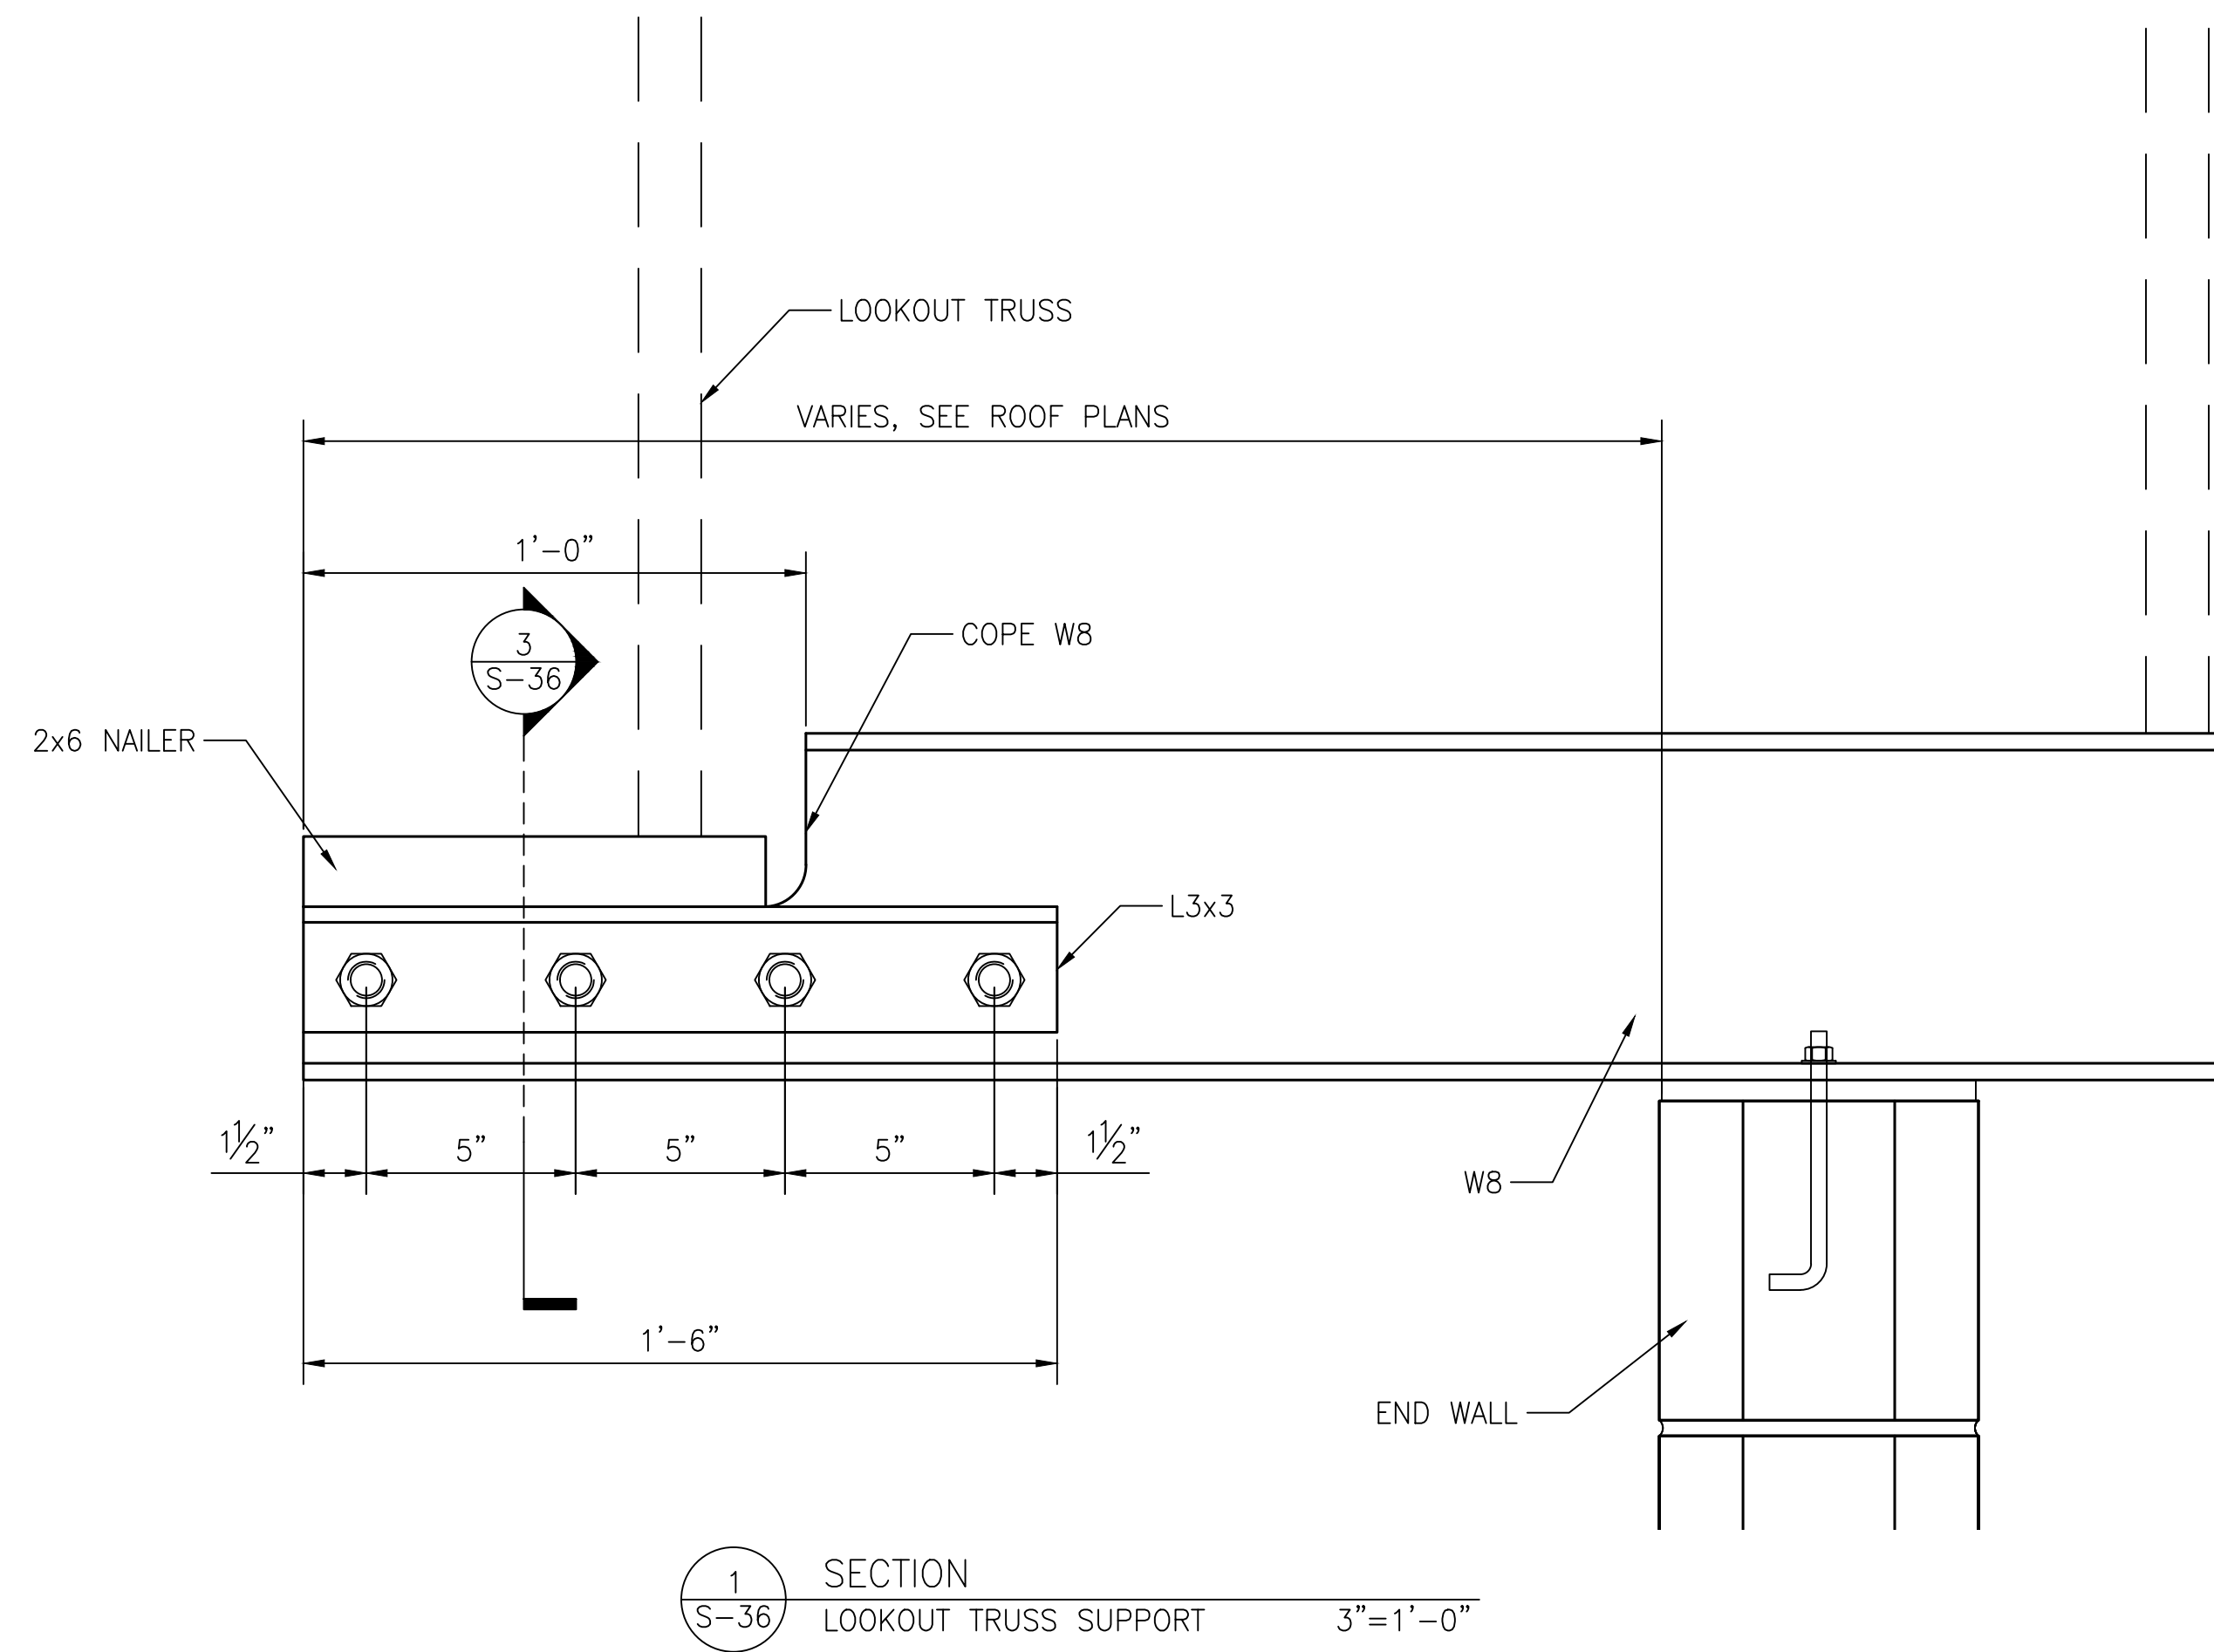

SPANS UP TO 5'-4"


2 SECTION
S-36 BOND-BEAM LINTEL 1 1/2"=1'-0"

- NOTES:
 1. FOR GENERAL NOTES SEE SHEET S-2
 2. FOR SYMBOLS AND ABBREVIATIONS SEE SHEET S-1

CONSTRUCTION DOCUMENTS



RECORD REVISIONS

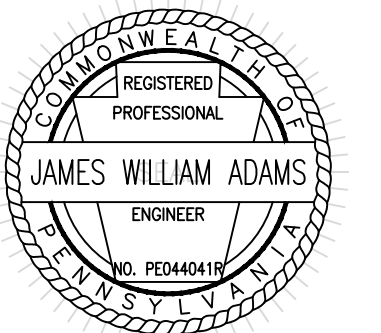

James W. Adams 11/19/21
SIGNATURE DATE

SMP ARCHITECTS
1600 WALNUT STREET, SECOND FLOOR
PHILADELPHIA, PENNSYLVANIA

COMMONWEALTH OF PENNSYLVANIA
DEPARTMENT OF GENERAL SERVICES
HARRISBURG, PENNSYLVANIA

D.G.S. PROJECT No.
C-114-0006 PHASE 1

HICKORY RUN STATE PARK
LATRINE IMPROVEMENTS
DEPT of CONSERVATION AND NATURAL RESOURCES
WHITE HAVEN, CARBON COUNTY, PA

COMMON DETAILS - SHEET 2

VERIFY SCALE
BAR IS ONE (1) INCH LONG ON ORIGINAL DRAWING: 0 1
IF BAR IS NOT ONE (1) INCH LONG, ADJUST SCALE ACCORDINGLY

CONTRACTOR SHALL FIELD VERIFY ALL DIMENSIONS. VARIANCE FROM CONTRACT DOCUMENTS NOT PERMITTED WITHOUT PROFESSIONAL & BUREAU OF CONSTRUCTION APPROVAL.

DRAWN BY M DIMONTE	DATE 06/17/2022
CHECKED BY J ADAMS	SCALE AS NOTED


DRAWING No.
S-36
117 OF 144

GENERAL NOTES:

- COORDINATE HEIGHT OF ENERGY RECOVERY VENTILATOR BOTTOM DUCT CONNECTION HEIGHTS WITH PLUMBING FIXTURES IN ALL BUILDINGS
- ALL DUCTWORK OUTSIDE OF THE MECHANICAL ROOMS SHALL BE ROUTED ABOVE THE CEILING IN THE TRUSS SPACE.
- ALL DUCTWORK SHALL BE CONSTRUCTED OF ALUMINUM. PROVIDE ALUMINUM OR STAINLESS STEEL HANGERS.


MECHANICAL KEYNOTES

- RADIANT FLOOR MANIFOLD (RFM-1, RFM-2 AND RFM-3) SHALL BE MOUNTED ON WALL PER MANUFACTURERS RECOMMENDATIONS. REFER TO DWG M-6 FOR PIPING LAYOUT IN THIS AREA.
- ROUTE SUPPLY DUCTWORK SERVING RESTROOM A102 AND A104 ABOVE CEILING IN TRUSS SPACE. DUCT SHALL BE TAPPED FROM THE TOP OF THE ASSOCIATED 12X12 AS SHOWN.
- REMOTE CONTROL DAMPER ACTUATOR. LOCATE IN MECHANICAL SPACE ON WALL.
- DUCT MOUNTED THERMOSTAT IN SUPPLY AIR DUCT DOWNSTREAM OF DUCT HEATING COIL TO CONTROL DUCT HEATING COIL CONTROL VALVE.

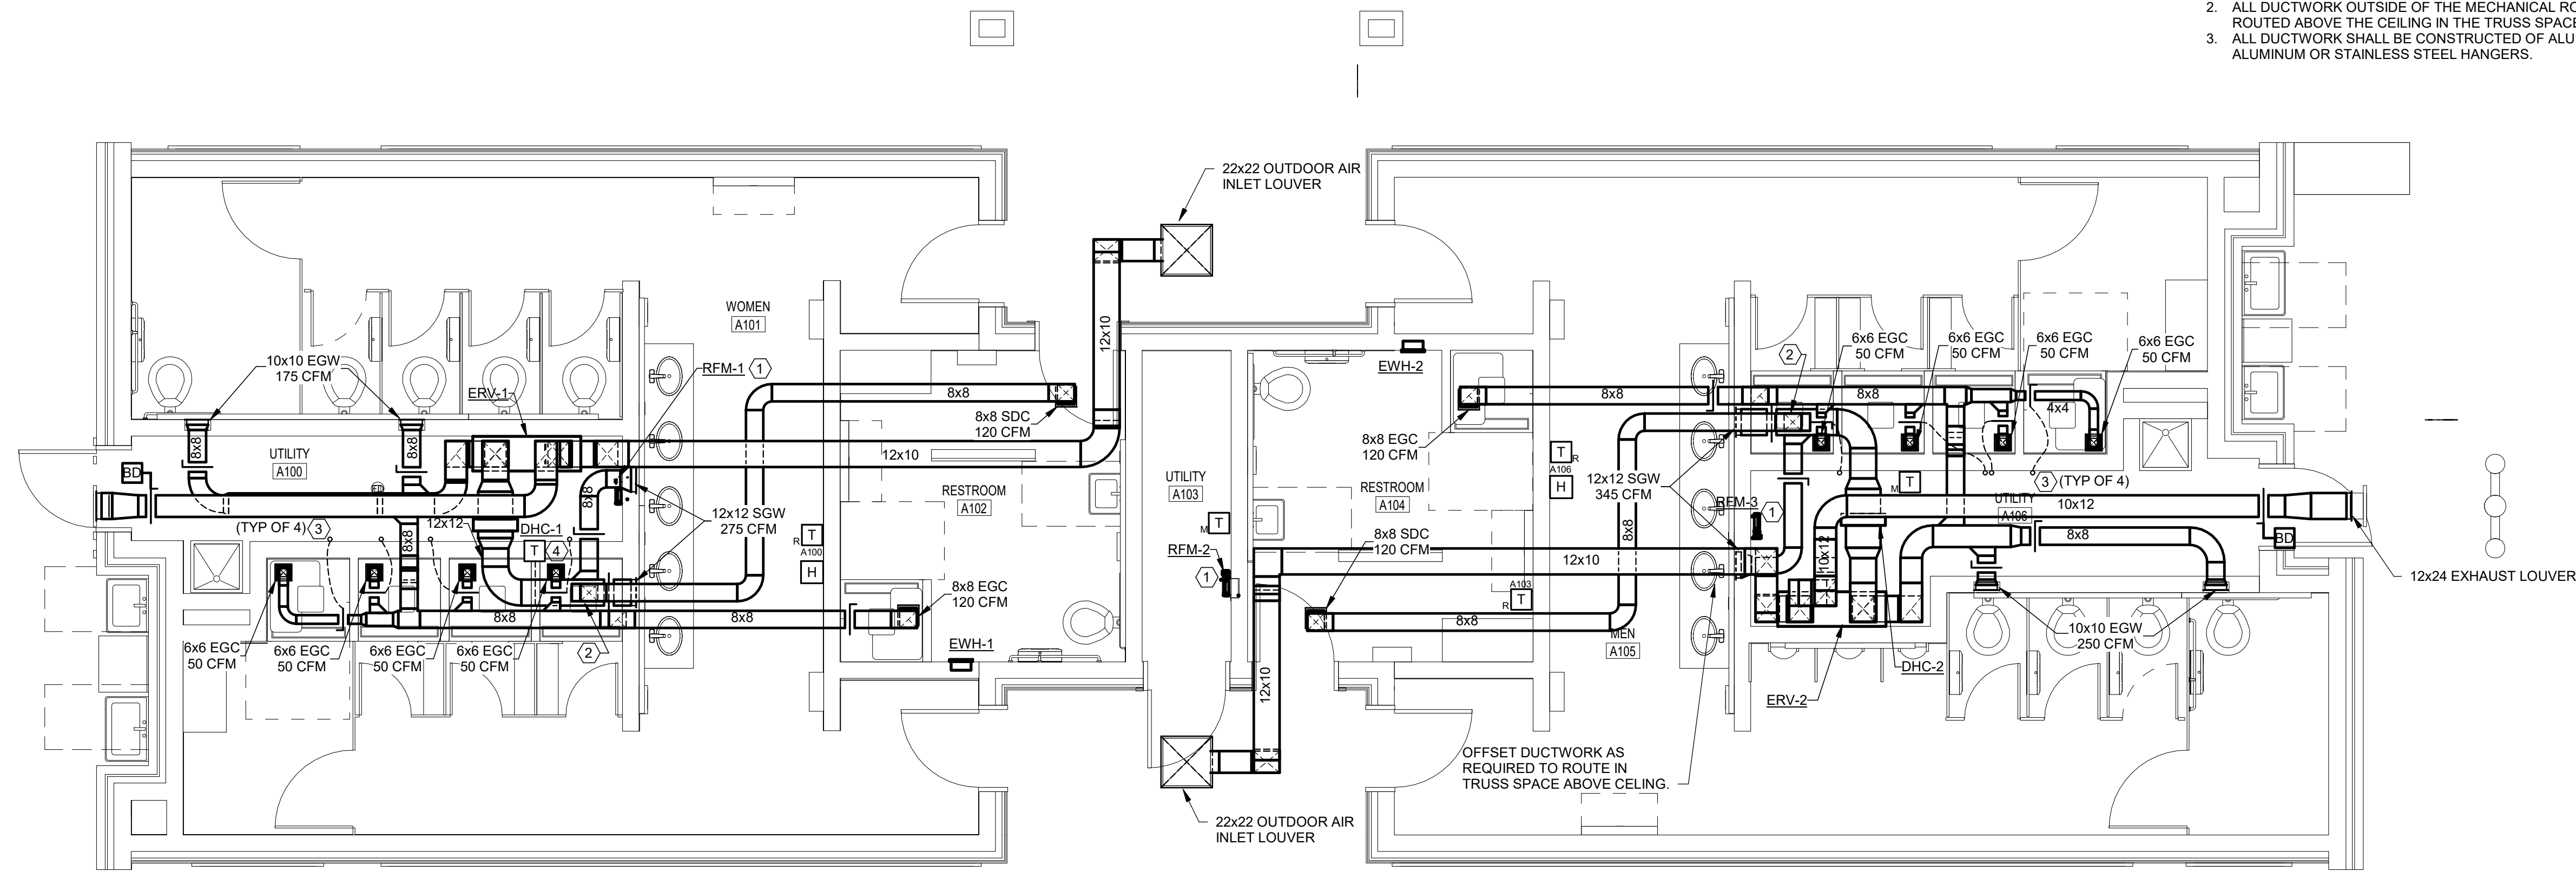


REFER TO 3D VIEWS THIS SHEET FOR ADDITIONAL DUCT ROUTING INFORMATION

1 LOOP-C - DUCTWORK
SCALE: 1/4" = 1'-0"

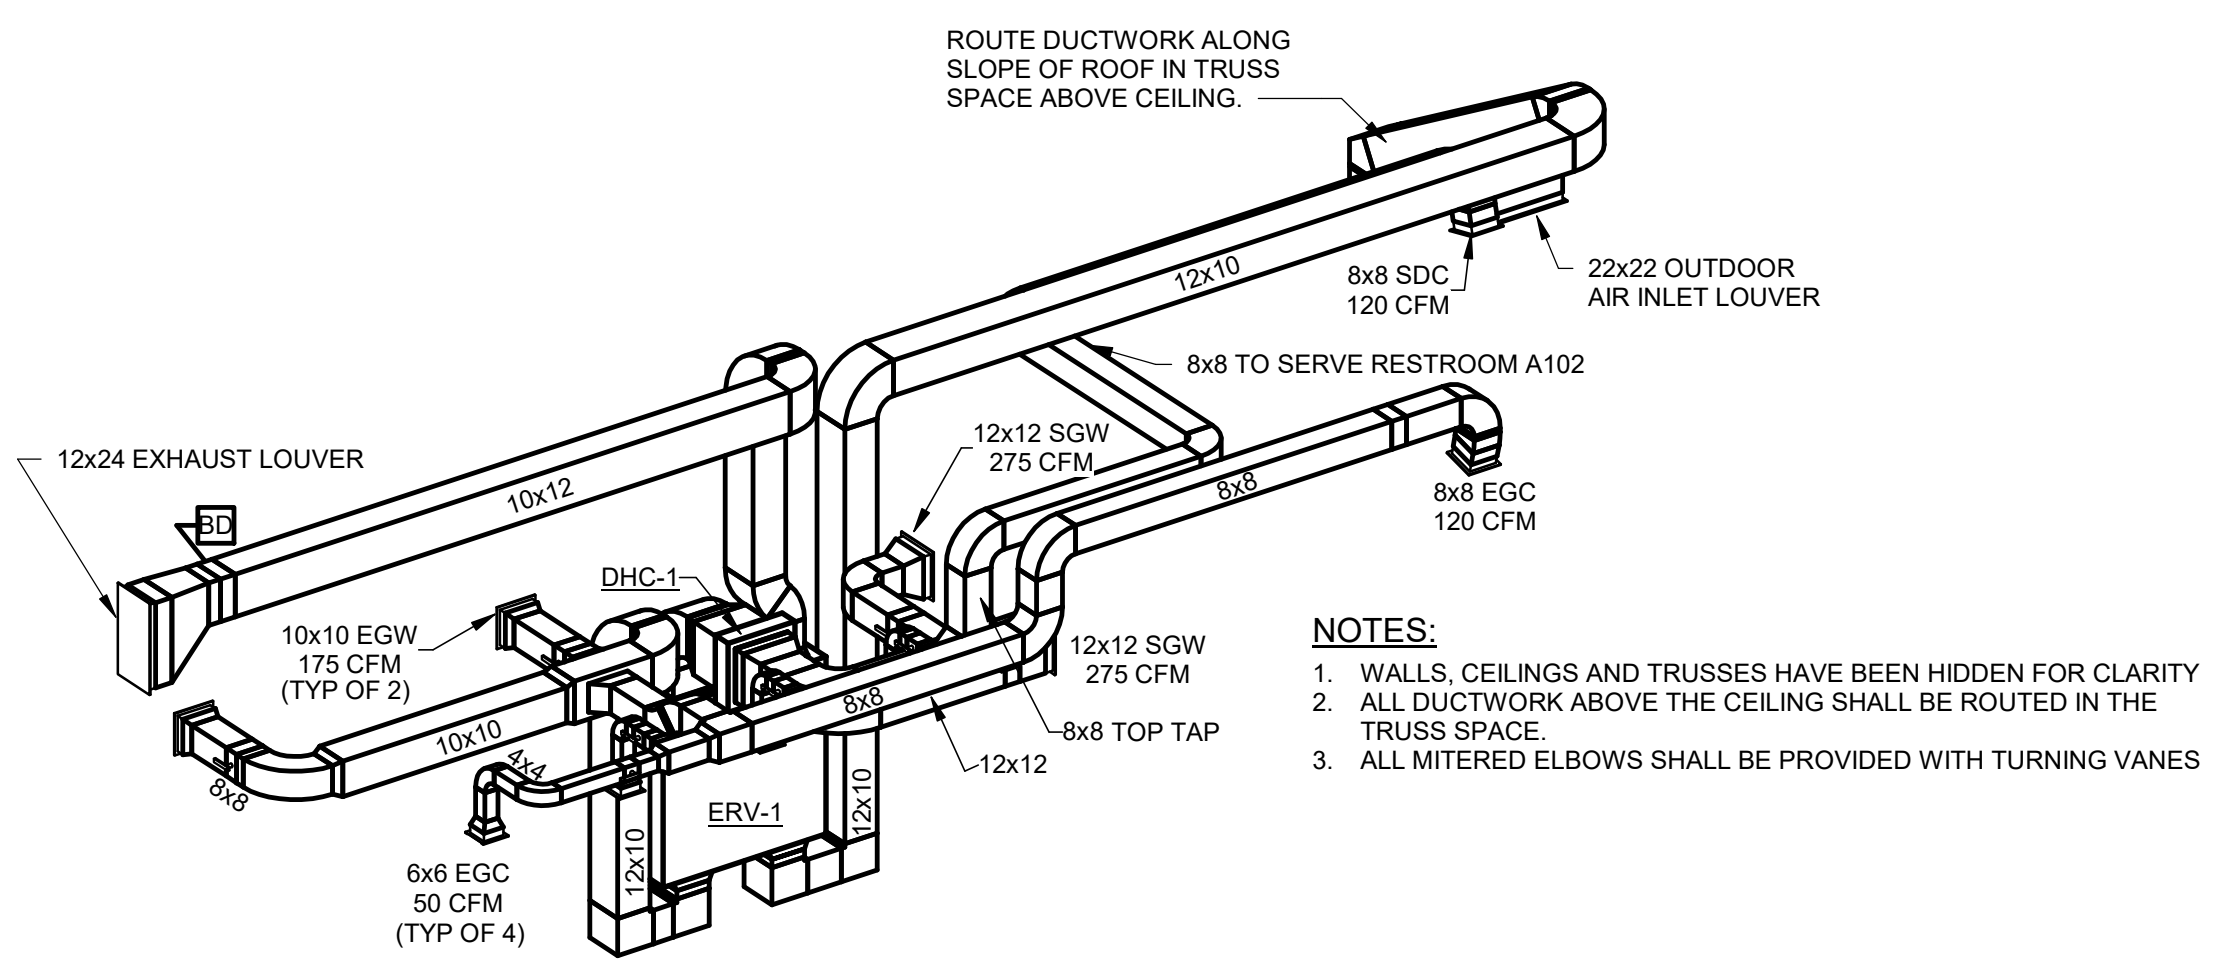


- NOTES:**
- WALLS, CEILINGS AND TRUSSES HAVE BEEN HIDDEN FOR CLARITY
 - ALL DUCTWORK ABOVE THE CEILING SHALL BE ROUTED IN THE TRUSS SPACE.
 - ALL MITERED ELBOWS SHALL BE PROVIDED WITH TURNING VANES

2 LOOP-C - ERV DUCTWORK 3D VIEW - WOMEN'S ROOM
SCALE:

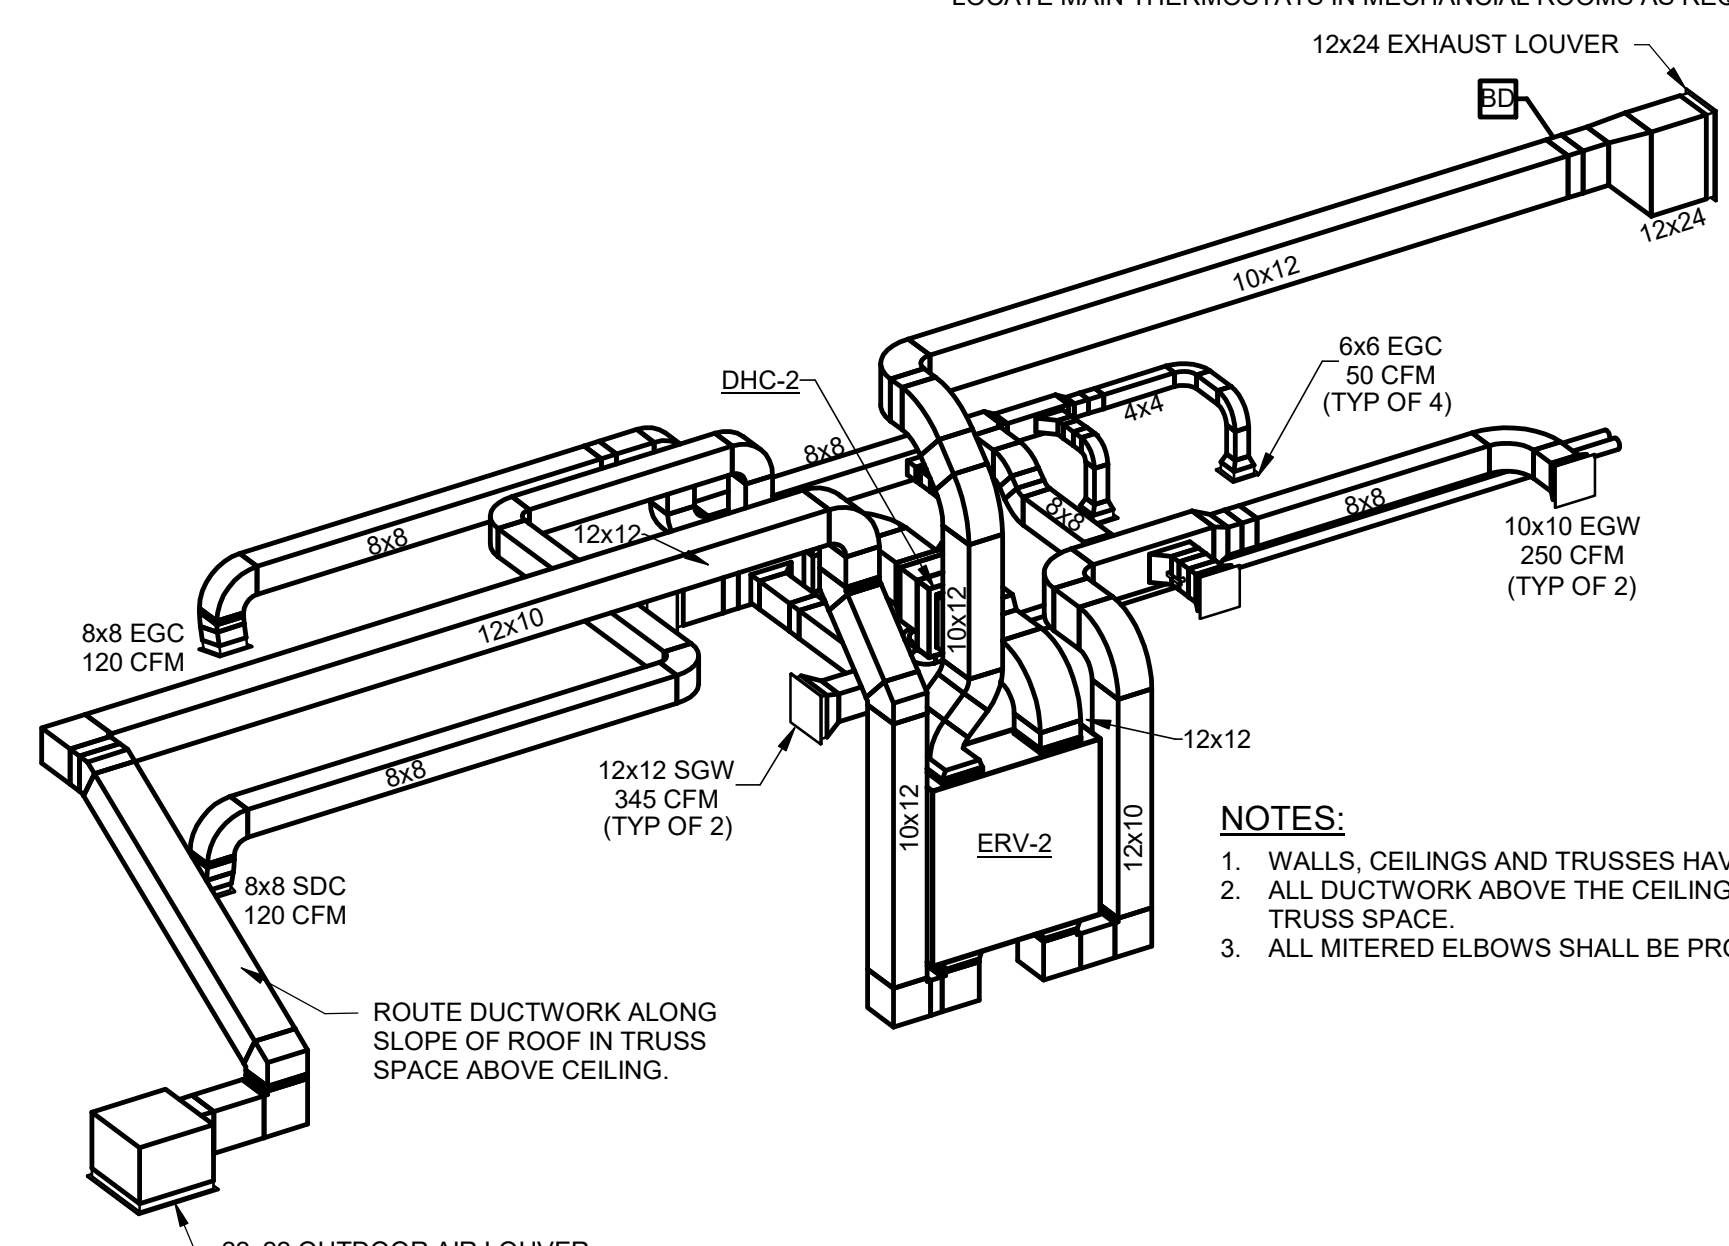


- NOTES:**
- WALLS, CEILINGS AND TRUSSES HAVE BEEN HIDDEN FOR CLARITY
 - ALL DUCTWORK ABOVE THE CEILING SHALL BE ROUTED IN THE TRUSS SPACE.
 - ALL MITERED ELBOWS SHALL BE PROVIDED WITH TURNING VANES

4 LOOP-C - ERV DUCTWORK 3D VIEW - MEN'S ROOM
SCALE:

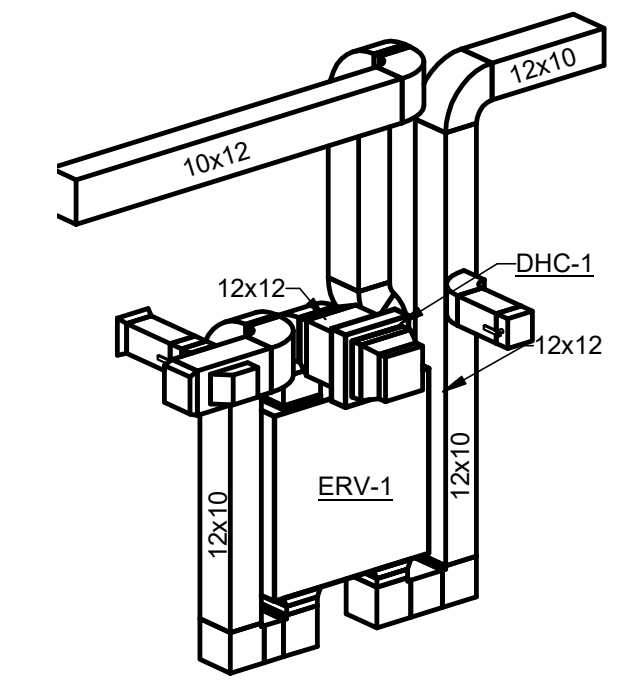


3 LOOP-C - ERV DUCTWORK CONNECTIONS - WOMEN'S ROOM
SCALE:

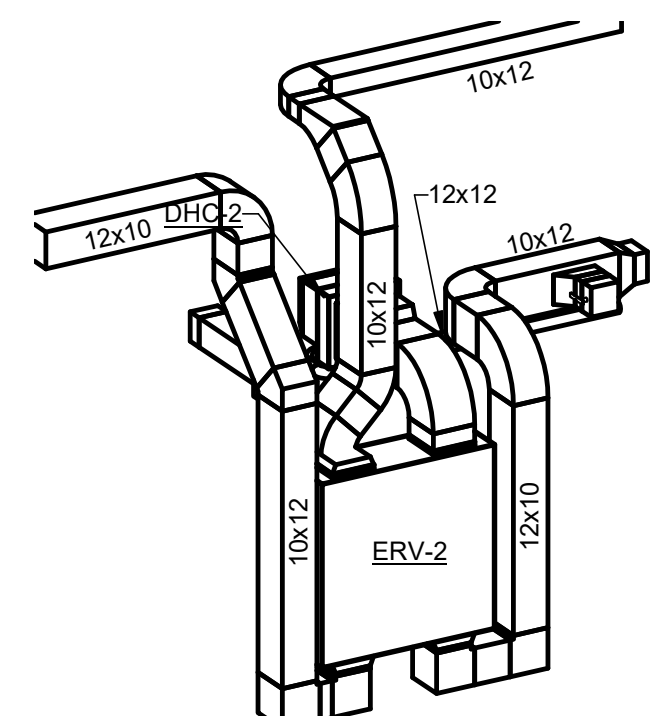

5 LOOP-C - ERV DUCTWORK CONNECTIONS - MEN'S ROOM
SCALE:

CONSTRUCTION DOCUMENTS

RECORD REVISIONS

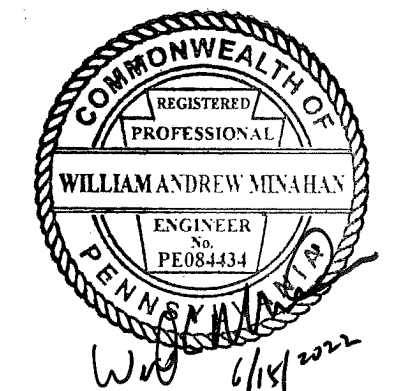

SIGNATURE DATE

SMP ARCHITECTS
1600 WALNUT STREET, SECOND FLOOR
PHILADELPHIA, PENNSYLVANIA

COMMONWEALTH OF PENNSYLVANIA
DEPARTMENT OF GENERAL SERVICES
HARRISBURG, PENNSYLVANIA

D.G.S. PROJECT No. C-114-0006 PHASE 1

HICKORY RUN STATE PARK
LATRINE IMPROVEMENTS
DEPT of CONSERVATION AND NATURAL RESOURCES
WHITE HAVEN, CARBON COUNTY, PA

LOOP - C FLOOR PLAN - MECHANICAL

VERIFY SCALE
BAR IS ONE (1) INCH LONG
ON ORIGINAL DRAWING: 0 1
IF BAR IS NOT ONE (1) INCH LONG, ADJUST SCALE ACCORDINGLY

CONTRACTOR SHALL FIELD VERIFY ALL DIMENSIONS. VARIANCE FROM CONTRACT DOCUMENTS NOT PERMITTED WITHOUT PROFESSIONAL & BUREAU OF CONSTRUCTION APPROVAL.


DRAWN BY W MINAHAN	DATE 06/17/2022	DRAWING No. M-2
CHECKED BY T HOVAN	SCALE AS NOTED	119 OF 144

GENERAL NOTES:

- COORDINATE HEIGHT OF ENERGY RECOVERY VENTILATOR BOTTOM DUCT CONNECTION HEIGHTS WITH PLUMBING FIXTURES IN ALL BUILDINGS
- INSTALL ALL WALL MOUNTED GRILLES SERVING B100 MEN, B102 WOMEN AND B103 RESTROOM ABOVE THE CMU. REFER TO THE ARCHITECTURAL DRAWINGS FOR EXACT ELEVATIONS.
- ALL DUCTWORK SHALL BE CONSTRUCTED OF ALUMINUM. PROVIDE ALUMINUM OR STAINLESS STEEL HANGERS.


MECHANICAL KEYNOTES

- DUCT MOUNTED THERMOSTAT IN SUPPLY AIR DUCT DOWNSTREAM OF DUCT HEATING COIL TO CONTROL DUCT HEATING COIL CONTROL VALVE.

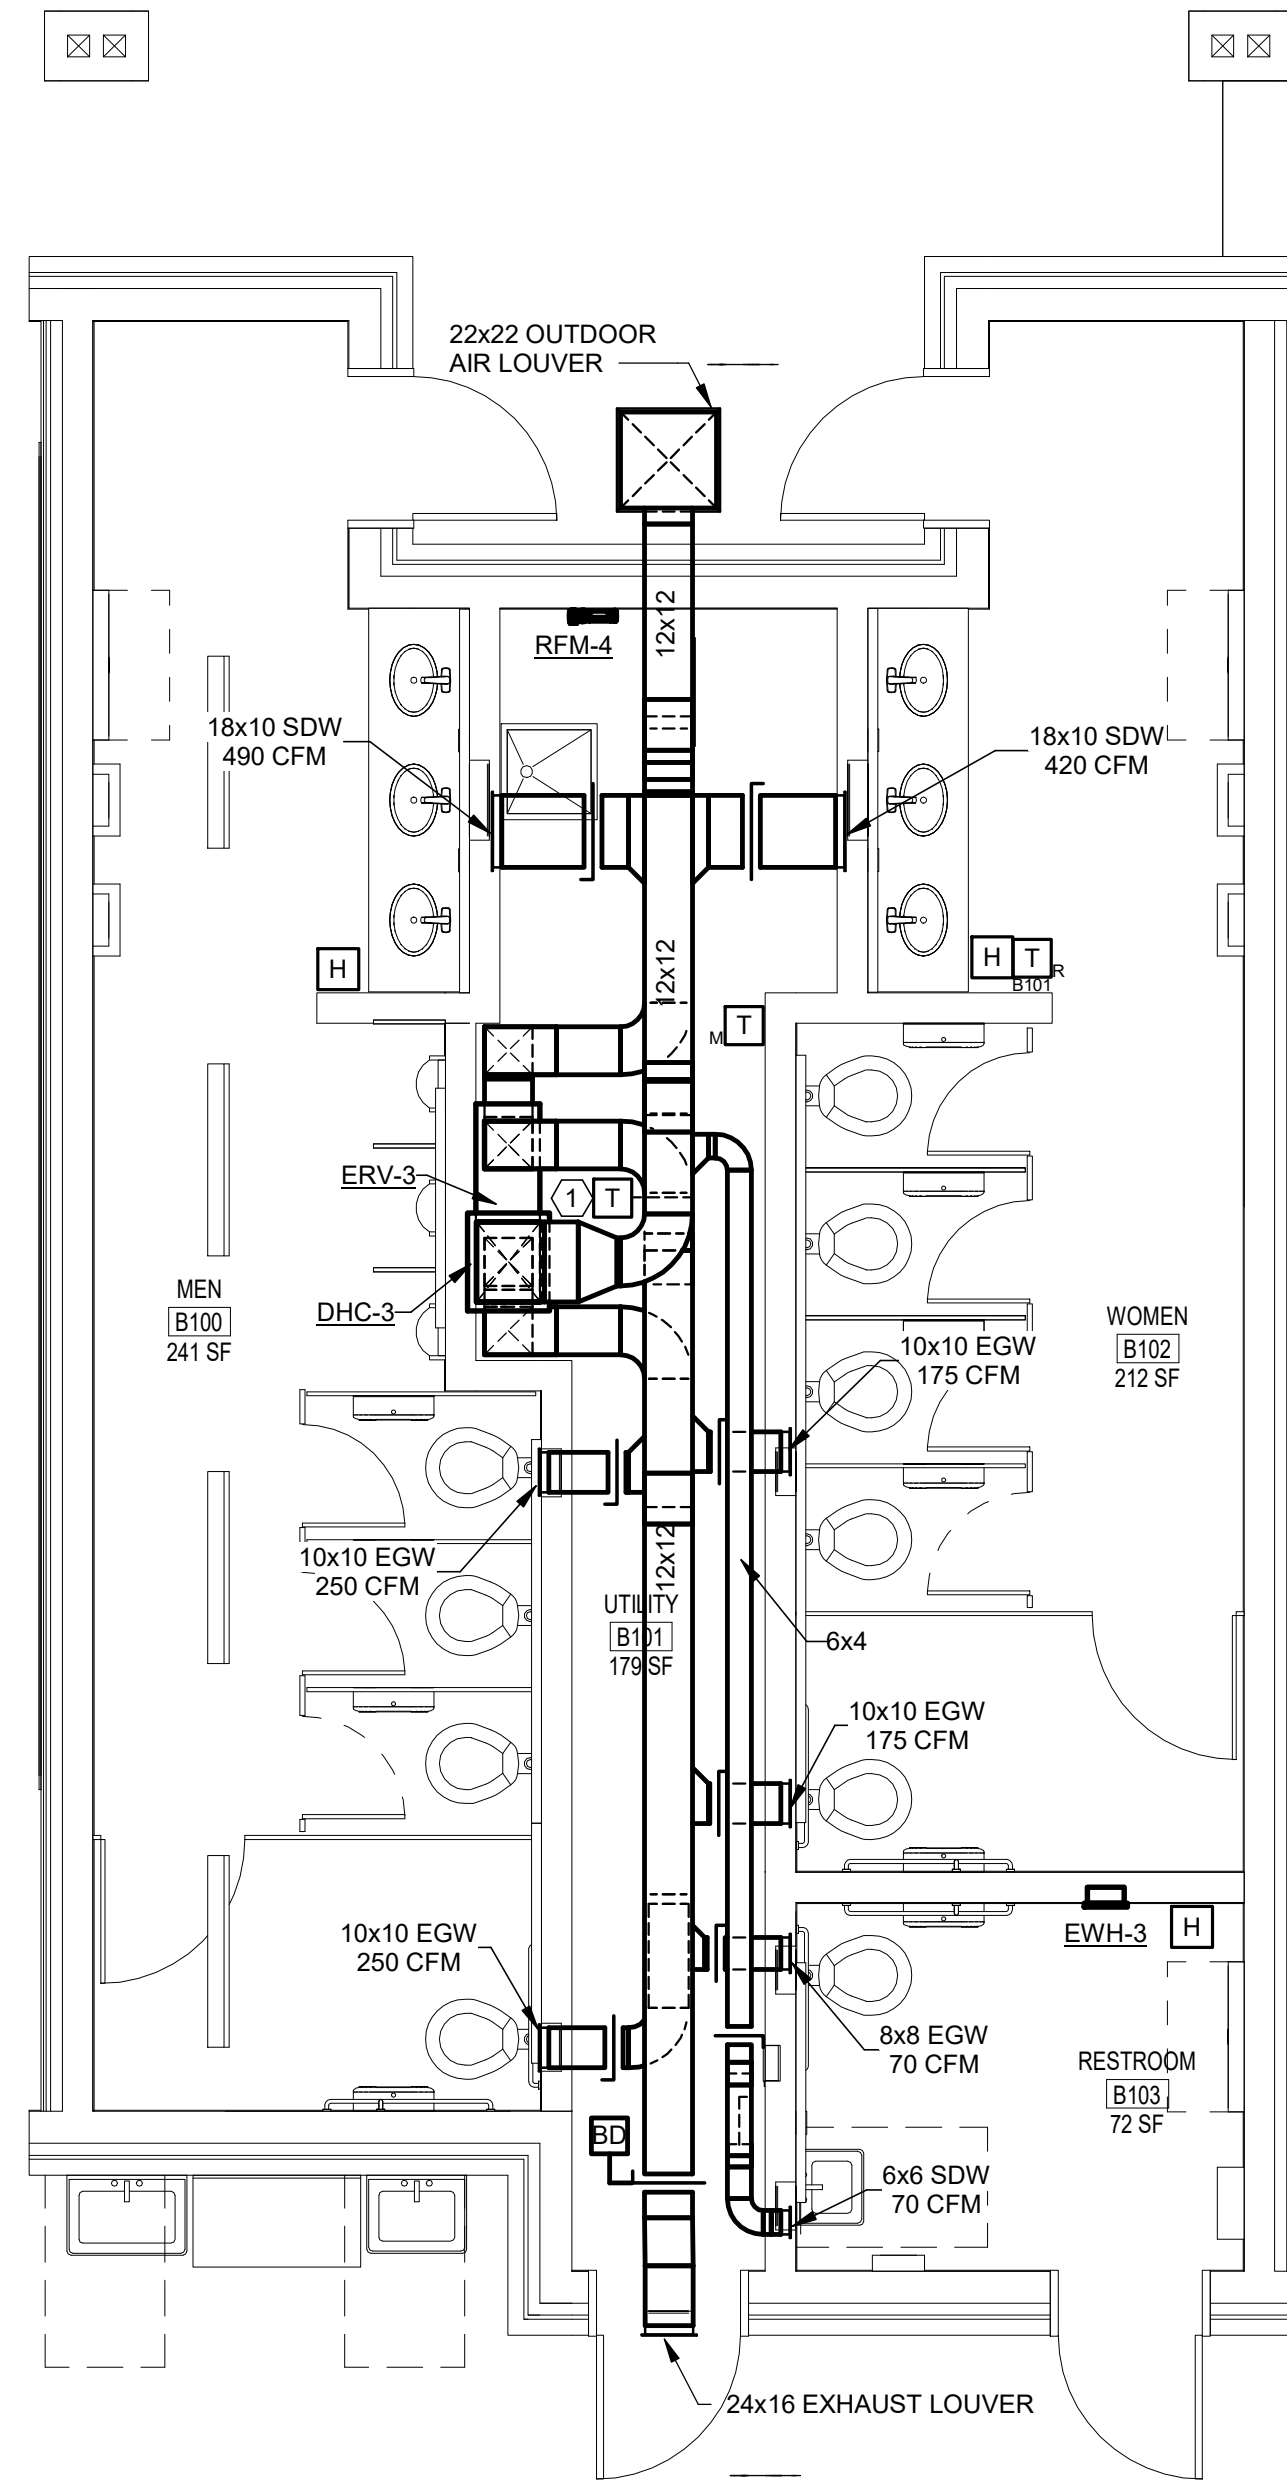


REFER TO 3D VIEWS THIS SHEET FOR ADDITIONAL DUCT ROUTING INFORMATION

NOTE: LOCATE MAIN THERMOSTATS IN MECHANICAL ROOMS AS REQUIRED FOR EASE OF ACCESS

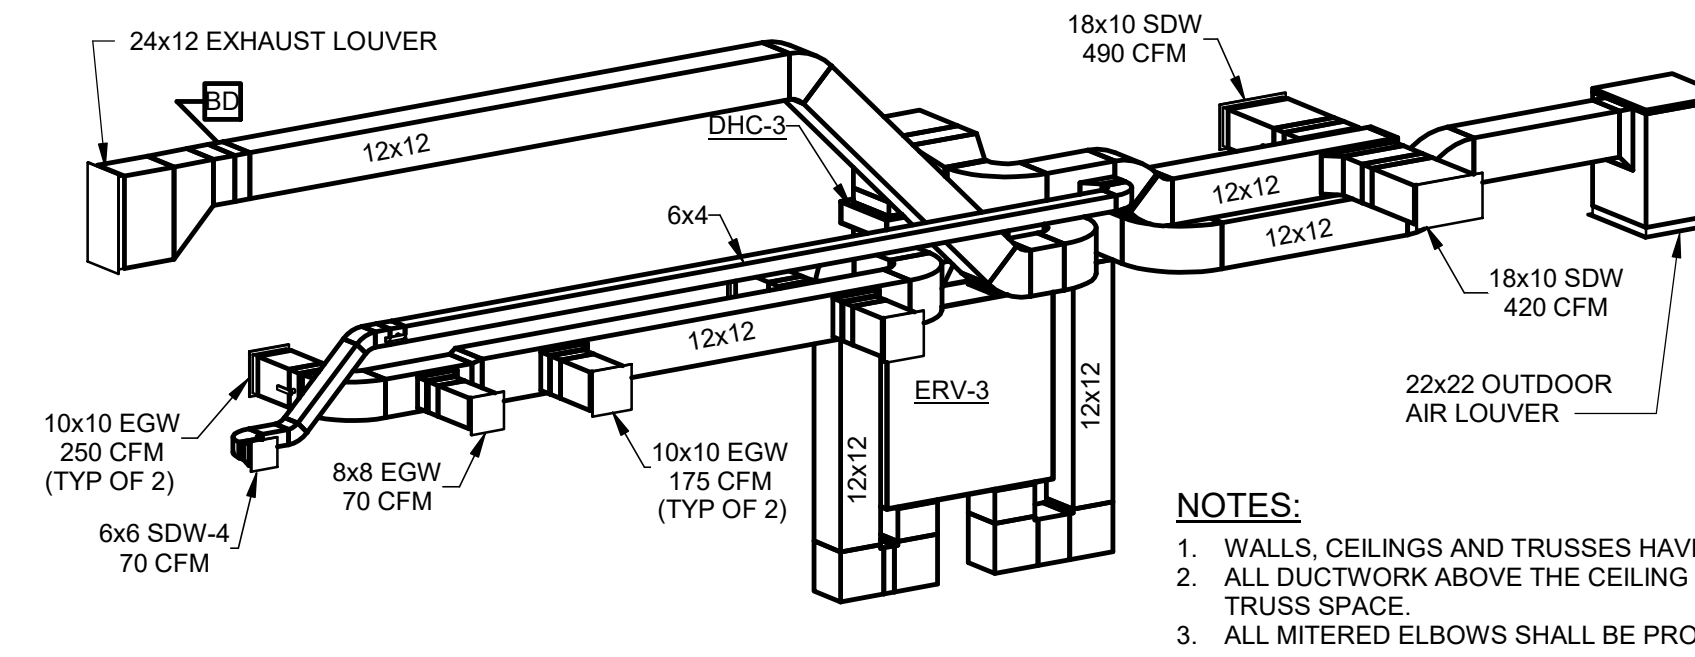

- NOTES:**
- WALLS, CEILINGS AND TRUSSES HAVE BEEN HIDDEN FOR CLARITY
 - ALL DUCTWORK ABOVE THE CEILING SHALL BE ROUTED IN THE TRUSS SPACE.
 - ALL MITERED ELBOWS SHALL BE PROVIDED WITH TURNING VANES

2 OGTC - ERV DUCTWORK 3D VIEW
NOT TO SCALE

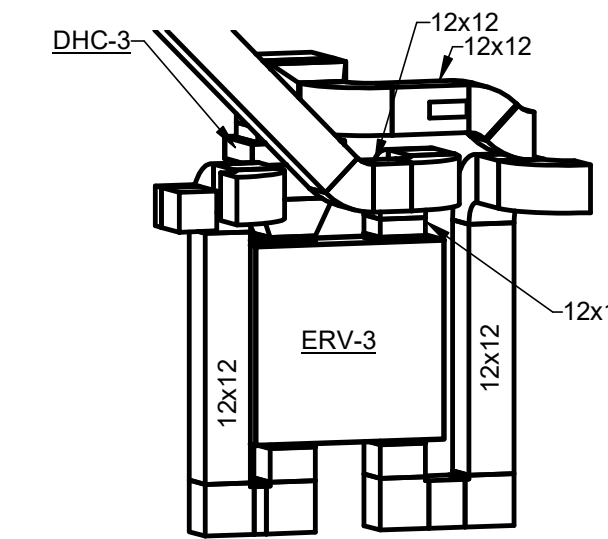


3 OGTC - ERV DUCTWORK CONNECTIONS - 3D VIEW
SCALE:

1 OGTC - DUCTWORK
SCALE: 1/4" = 1'-0"

CONSTRUCTION DOCUMENTS

RECORD REVISIONS

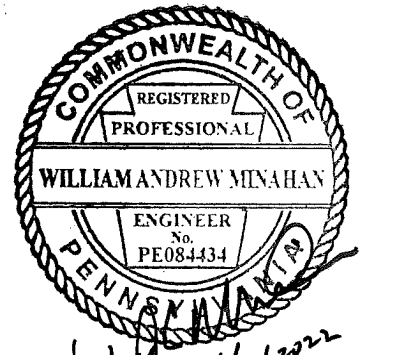

SIGNATURE DATE

SMP ARCHITECTS
1600 WALNUT STREET, SECOND FLOOR
PHILADELPHIA, PENNSYLVANIA

COMMONWEALTH OF PENNSYLVANIA
DEPARTMENT OF GENERAL SERVICES
HARRISBURG, PENNSYLVANIA

D.G.S. PROJECT No.
C-114-0006 PHASE 1

HICKORY RUN STATE PARK
LATRINE IMPROVEMENTS
DEPT of CONSERVATION AND NATURAL RESOURCES
WHITE HAVEN, CARBON COUNTY, PA

OGTC FLOOR PLAN - MECHANICAL

VERIFY SCALE

BAR IS ONE (1) INCH LONG
ON ORIGINAL DRAWING: 0 1
IF BAR IS NOT ONE (1) INCH LONG, ADJUST SCALE ACCORDINGLY

CONTRACTOR SHALL FIELD VERIFY ALL DIMENSIONS. VARIANCE FROM CONTRACT DOCUMENTS NOT PERMITTED WITHOUT PROFESSIONAL & BUREAU OF CONSTRUCTION APPROVAL.

DRAWN BY: W MINAHAN
DATE: 06/17/2022
CHECKED BY: T HOVAN
SCALE: AS NOTED

DRAWING No.
M-3
120 OF 144


ALL WORK ON THIS SHEET IS BASE BID #3

GENERAL NOTES:

1. ALL DUCTWORK OUTSIDE OF THE MECHANICAL ROOMS SHALL BE ROUTED ABOVE THE CEILING IN THE TRUSS SPACE.
2. ALL DUCTWORK SHALL BE CONSTRUCTED OF ALUMINUM. PROVIDE ALUMINUM OR STAINLESS STEEL HANGERS.
3. BRANCH DUCTWORK SERVING 6x6 EXHAUST GRILLES SHALL BE 6x6.

MECHANICAL KEYNOTES

1. REMOTE CONTROL DAMPER ACTUATOR. LOCATE IN MECHANICAL SPACE ON WALL.
2. INSTALL WALL MOUNTED GRILLES ABOVE THE CMU WALL. REFER TO ARCHITECTURAL DRAWINGS FOR ELEVATIONS.
3. ROUTE DUCTWORK IN TRUSS SPACE

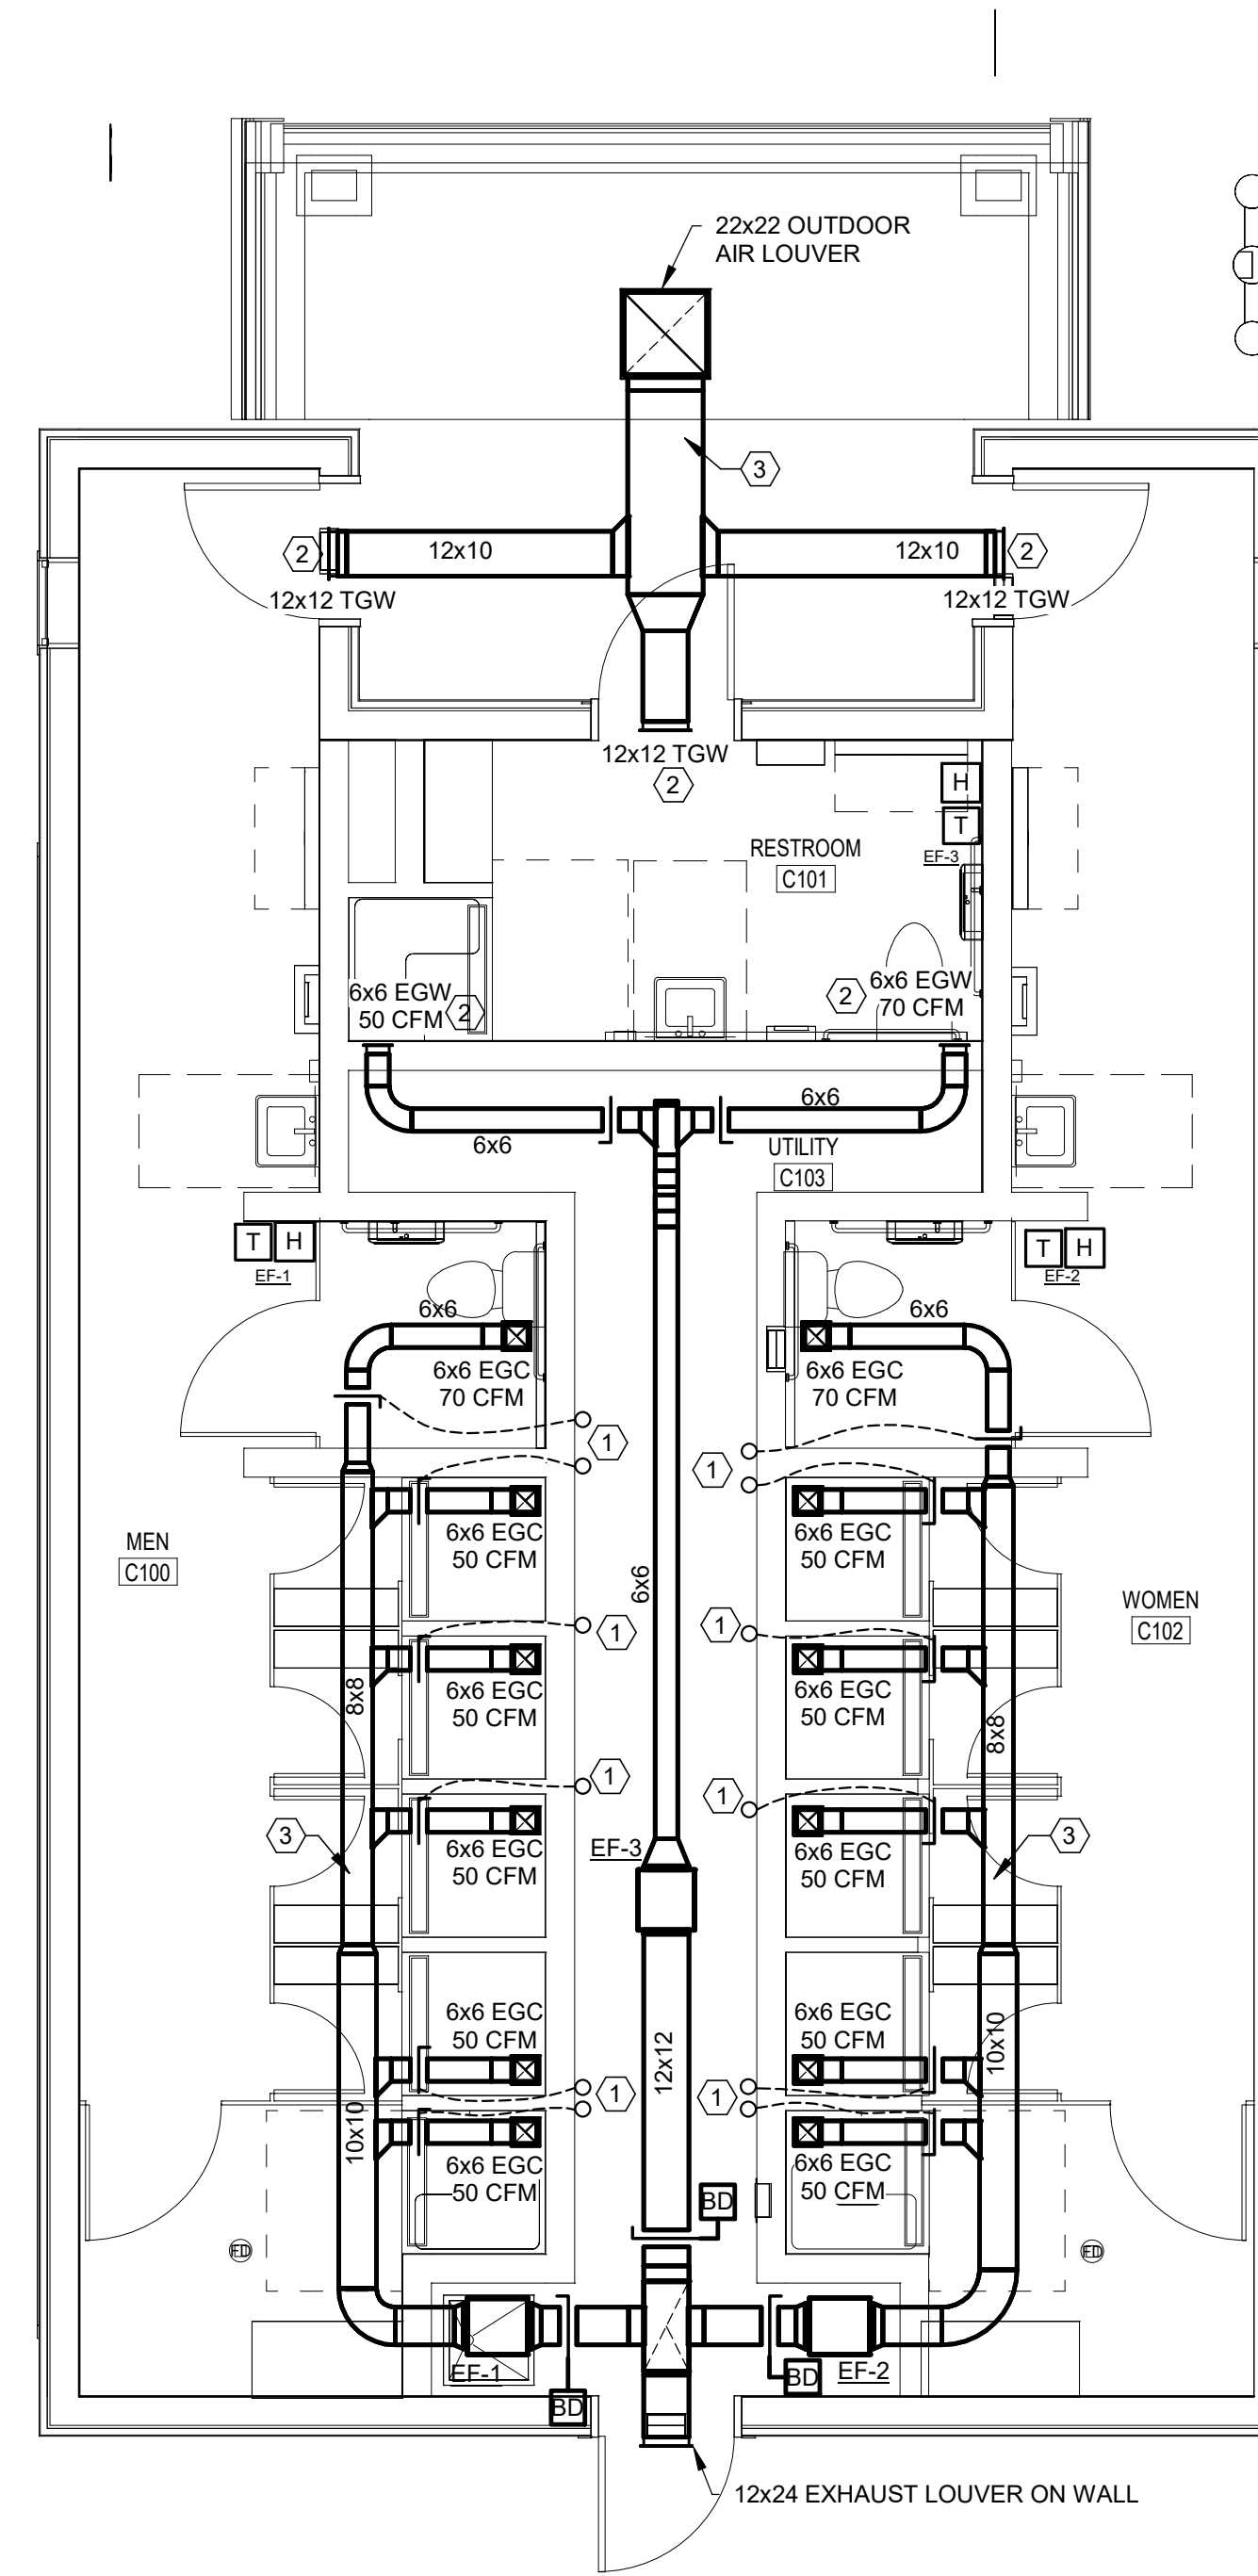

1 OGC - DADDY ALLEN FLOOR PLAN - MECHANICAL
SCALE: 1/4" = 1'-0"

THIS BUILDING IS EXHAUST ONLY, NO HEATING IS BEING PROVIDED

CONSTRUCTION DOCUMENTS

RECORD REVISIONS



SIGNATURE DATE

SMP ARCHITECTS
1600 WALNUT STREET, SECOND FLOOR
PHILADELPHIA, PENNSYLVANIA

COMMONWEALTH OF PENNSYLVANIA
DEPARTMENT OF GENERAL SERVICES
HARRISBURG, PENNSYLVANIA

D.G.S. PROJECT No.
C-114-0006 PHASE 1

HICKORY RUN STATE PARK
LATRINE IMPROVEMENTS

DEPT of CONSERVATION AND NATURAL RESOURCES
WHITE HAVEN, CARBON COUNTY, PA

CAMP DADDY ALLEN FLOOR PLAN - MECHANICAL

VERIFY SCALE

BAR IS ONE (1) INCH LONG
ON ORIGINAL DRAWING: 0 1
IF BAR IS NOT ONE (1) INCH LONG, ADJUST SCALE ACCORDINGLY

CONTRACTOR SHALL FIELD VERIFY ALL DIMENSIONS. VARIANCE FROM CONTRACT DOCUMENTS NOT PERMITTED WITHOUT PROFESSIONAL & BUREAU OF CONSTRUCTION APPROVAL.

DRAWN BY W MINAHAN	DATE 06/17/2022	DRAWING No. M-4
CHECKED BY T HOVAN	SCALE AS NOTED	


ALL WORK ON THIS SHEET IS BASE BID #2

GENERAL NOTES:

1. ALL DUCTWORK OUTSIDE OF THE MECHANICAL ROOMS SHALL BE ROUTED ABOVE THE CEILING IN THE TRUSS SPACE.
2. ALL DUCTWORK SHALL BE CONSTRUCTED OF ALUMINUM. PROVIDE ALUMINUM OR STAINLESS STEEL HANGERS.
3. BRANCH DUCTWORK SERVING 6x6 EXHAUST GRILLES SHALL BE 6x6.

MECHANICAL KEYNOTES

1. REMOTE CONTROL DAMPER ACTUATOR. LOCATE IN MECHANICAL SPACE ON WALL.
2. INSTALL WALL MOUNTED GRILLES ABOVE THE CMU WALL. REFER TO ARCHITECTURAL DRAWINGS FOR ELEVATIONS.
3. ROUTE DUCTWORK IN TRUSS SPACE

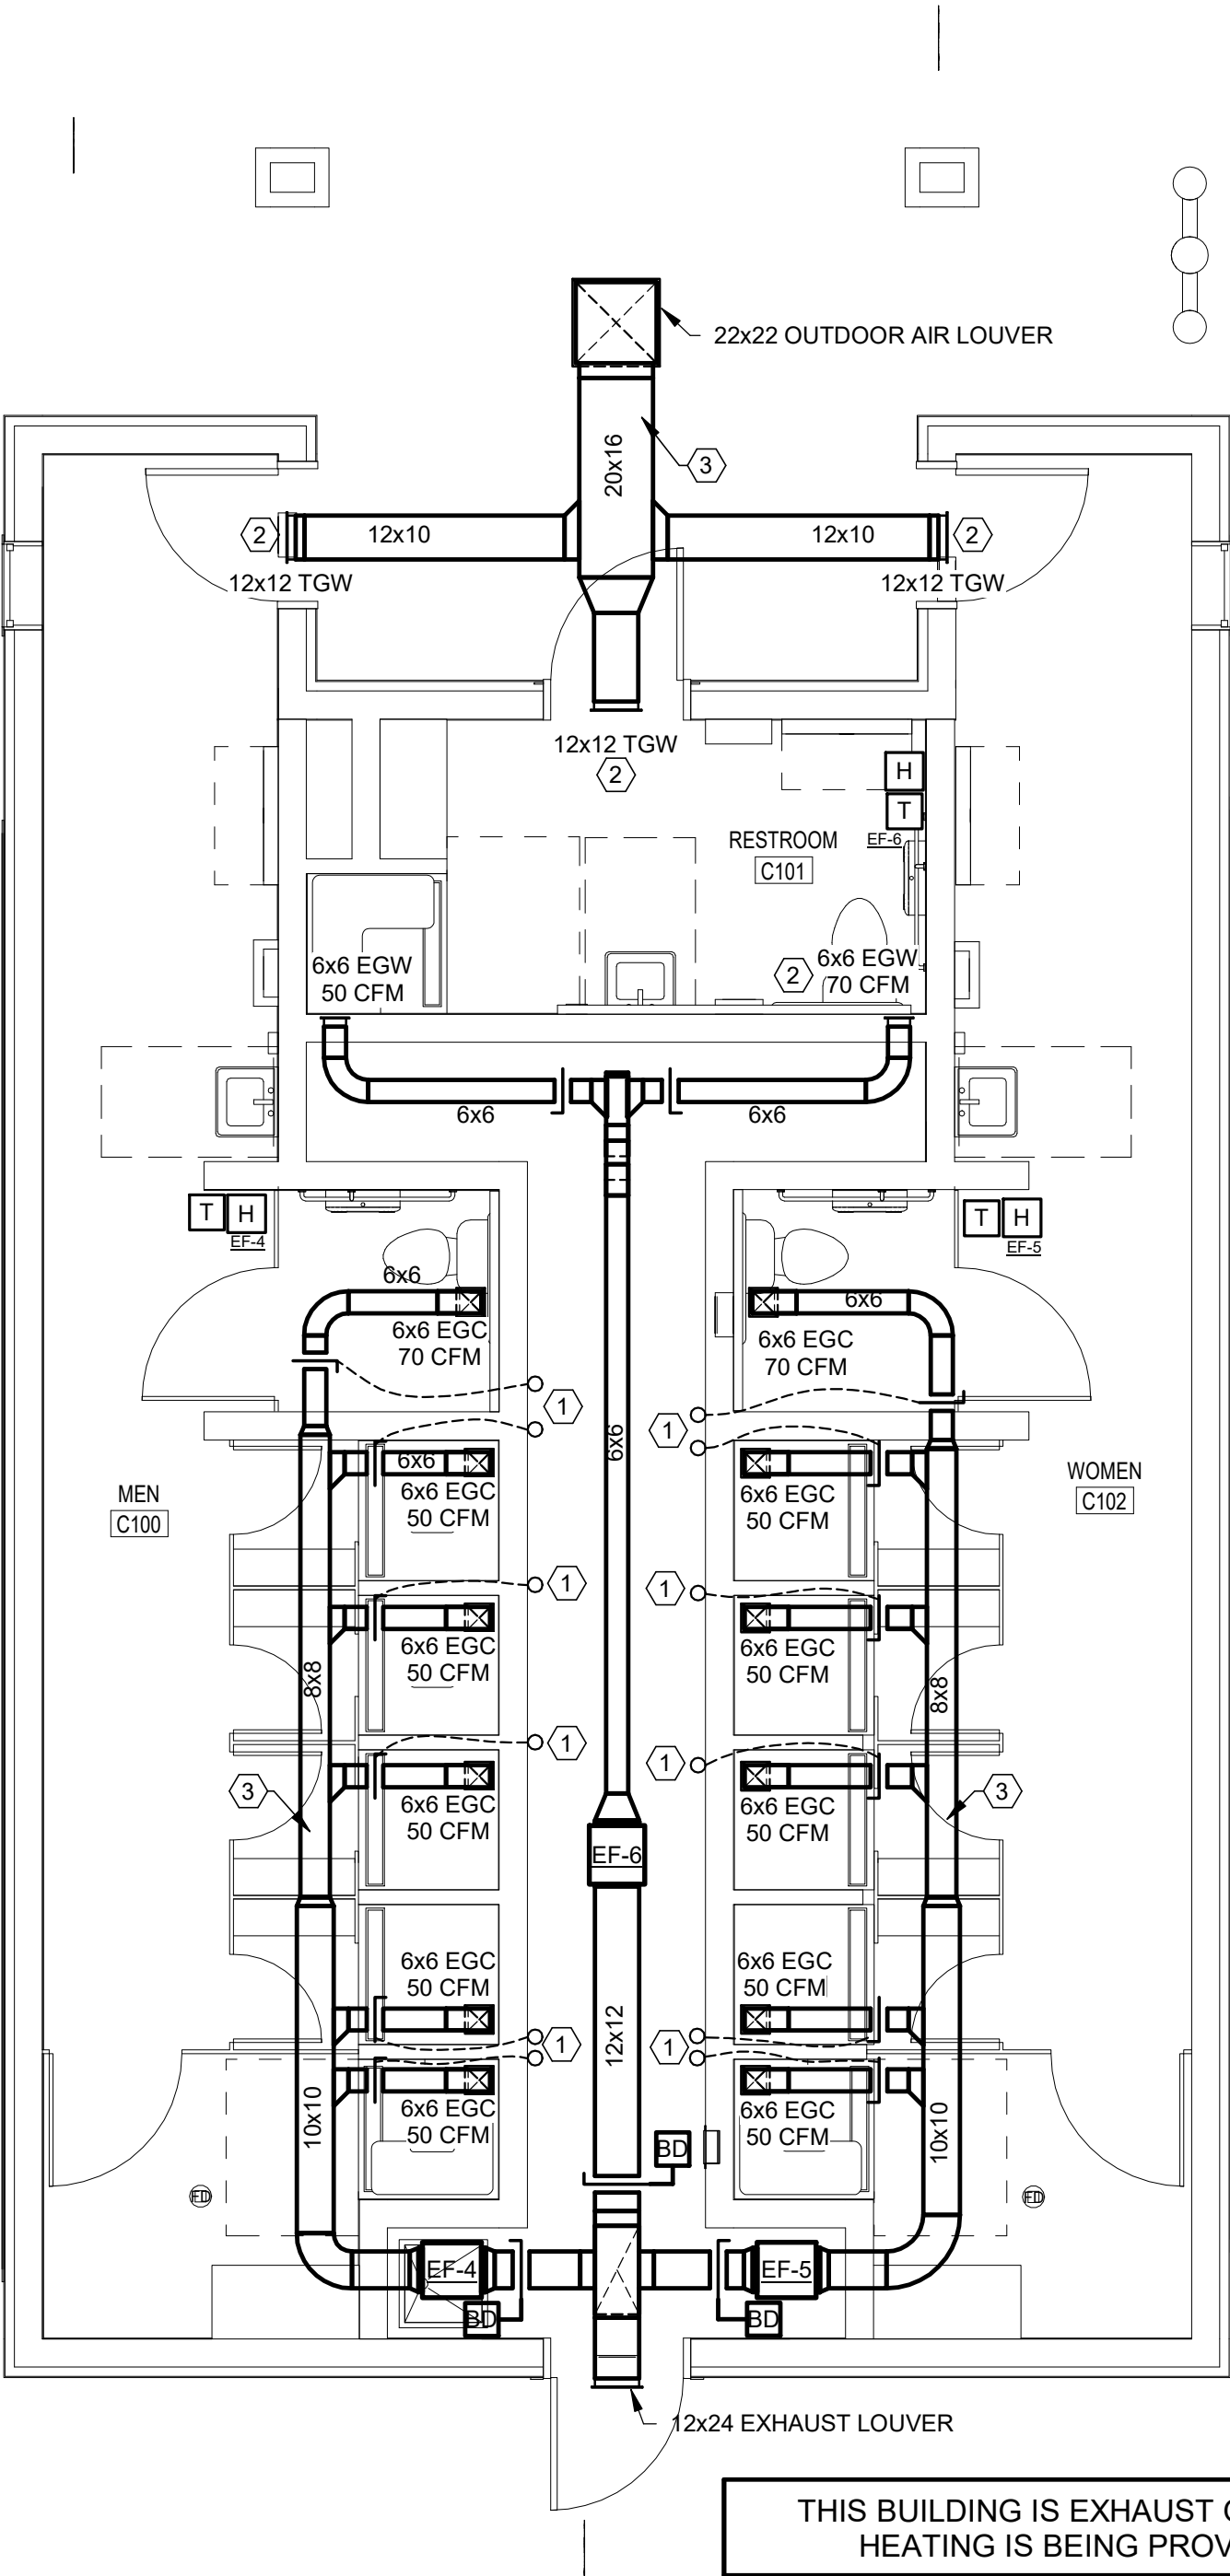

1 OGC - SHEHAQUA FLOOR PLAN - MECHANICAL
SCALE: 1/4" = 1'-0"

CONSTRUCTION DOCUMENTS

RECORD REVISIONS

WILLIAM ANDREW MINAHAN
REGISTERED PROFESSIONAL ENGINEER
PE084434

WAM 6/17/2022

SIGNATURE DATE

SMP ARCHITECTS
1600 WALNUT STREET, SECOND FLOOR
PHILADELPHIA, PENNSYLVANIA

COMMONWEALTH OF PENNSYLVANIA
DEPARTMENT OF GENERAL SERVICES
HARRISBURG, PENNSYLVANIA

D.G.S. PROJECT No. C-114-0006 PHASE 1

HICKORY RUN STATE PARK
LATRINE IMPROVEMENTS
DEPT of CONSERVATION AND NATURAL RESOURCES
WHITE HAVEN, CARBON COUNTY, PA

CAMP SHEHAQUA FLOOR PLAN - MECHANICAL

VERIFY SCALE
BAR IS ONE (1) INCH LONG
ON ORIGINAL DRAWING: 0 1
IF BAR IS NOT ONE (1) INCH LONG, ADJUST SCALE ACCORDINGLY


CONTRACTOR SHALL FIELD VERIFY ALL DIMENSIONS. VARIANCE FROM CONTRACT DOCUMENTS NOT PERMITTED WITHOUT PROFESSIONAL & BUREAU OF CONSTRUCTION APPROVAL.

DRAWN BY W MINAHAN
DATE 06/17/2022
CHECKED BY T HOVAN
SCALE AS NOTED

DRAWING No. M-5
122 OF 144

MECHANICAL KEYNOTES


1 1/2" HOT WATER SUPPLY AND RETURN FROM UTILITY ROOM A106 TO SERVE UTILITY ROOM A103. TRANSITION TO 1 1/4" TO SERVE UTILITY ROOM A100. ALL PIPE TAPS SERVING DUCT HEATING COIL, HORIZONTAL UNIT HEATERS SHALL BE 3/4" UNLESS NOTED OTHERWISE.

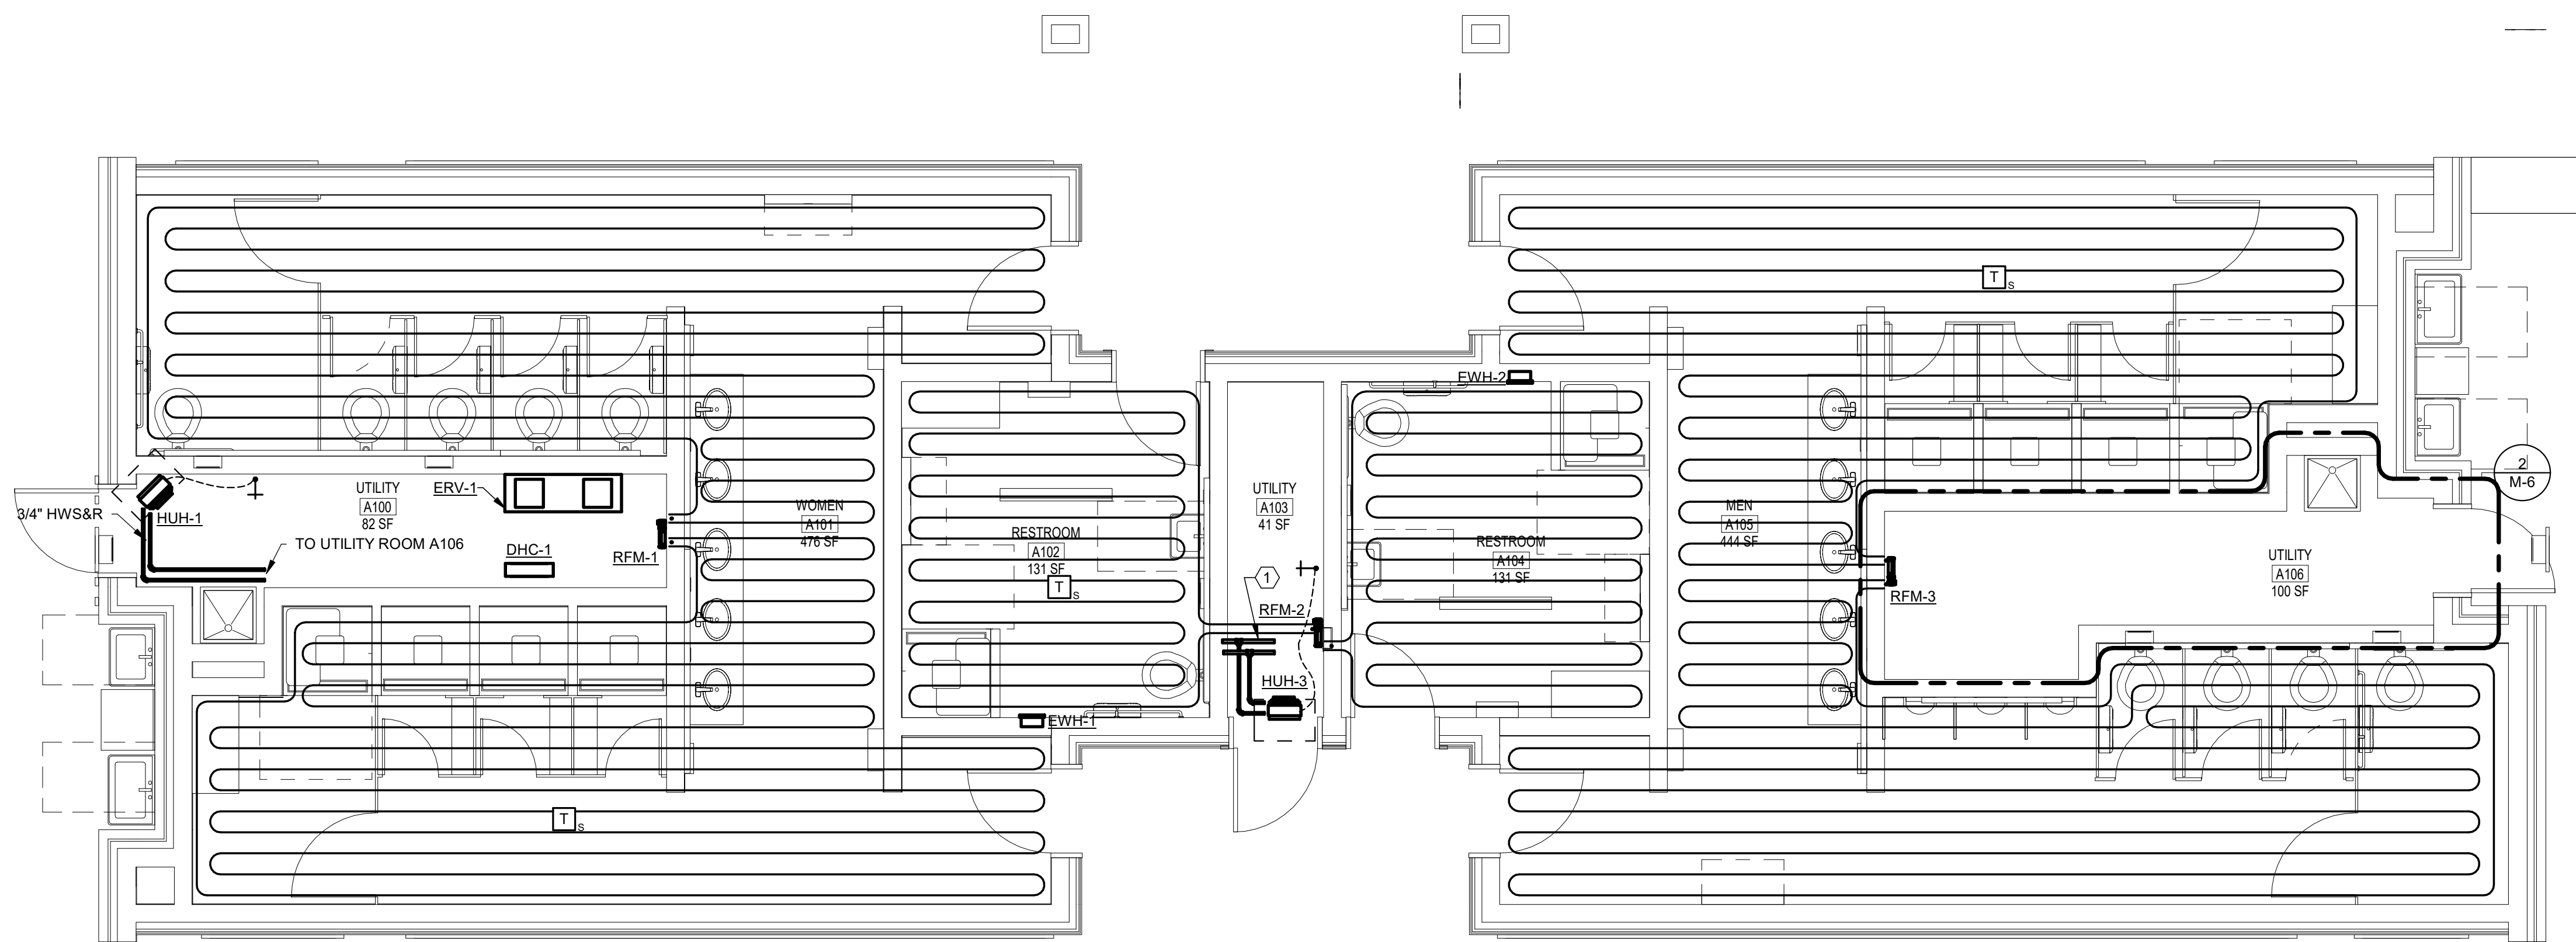

RADIANT FLOOR NOTES (TYPICAL FOR ALL RADIANT FLOOR IN THIS BUILDING)

1. SPACE ALL PEX TUBING ON 12" OC
2. ALL PEX TUBING SHALL BE 3/4" ID
3. PROVIDE SLAB TEMPERATURE SENSOR FOR EACH HEATING ZONE AS INDICATED.
4. MODIFY ROUTING SHOWN AS REQUIRED FOR COORDINATION WITH FLOOR DRAINS AND OTHER FLOOR PENETRATING APPURTENANCES.
5. REFER TO RADIANT FLOOR DETAIL ON DWG M-9 FOR ADDITIONAL INFORMATION.
6. PROVIDE PEX INSULATION BELOW SLAB PER DETAIL UNDER ENTIRE FLOOR SERVED BY RADIANT SYSTEM.


1 LOOP-C - FLOOR PLAN - MECHANICAL PIPING
SCALE: 1/4" = 1'-0"

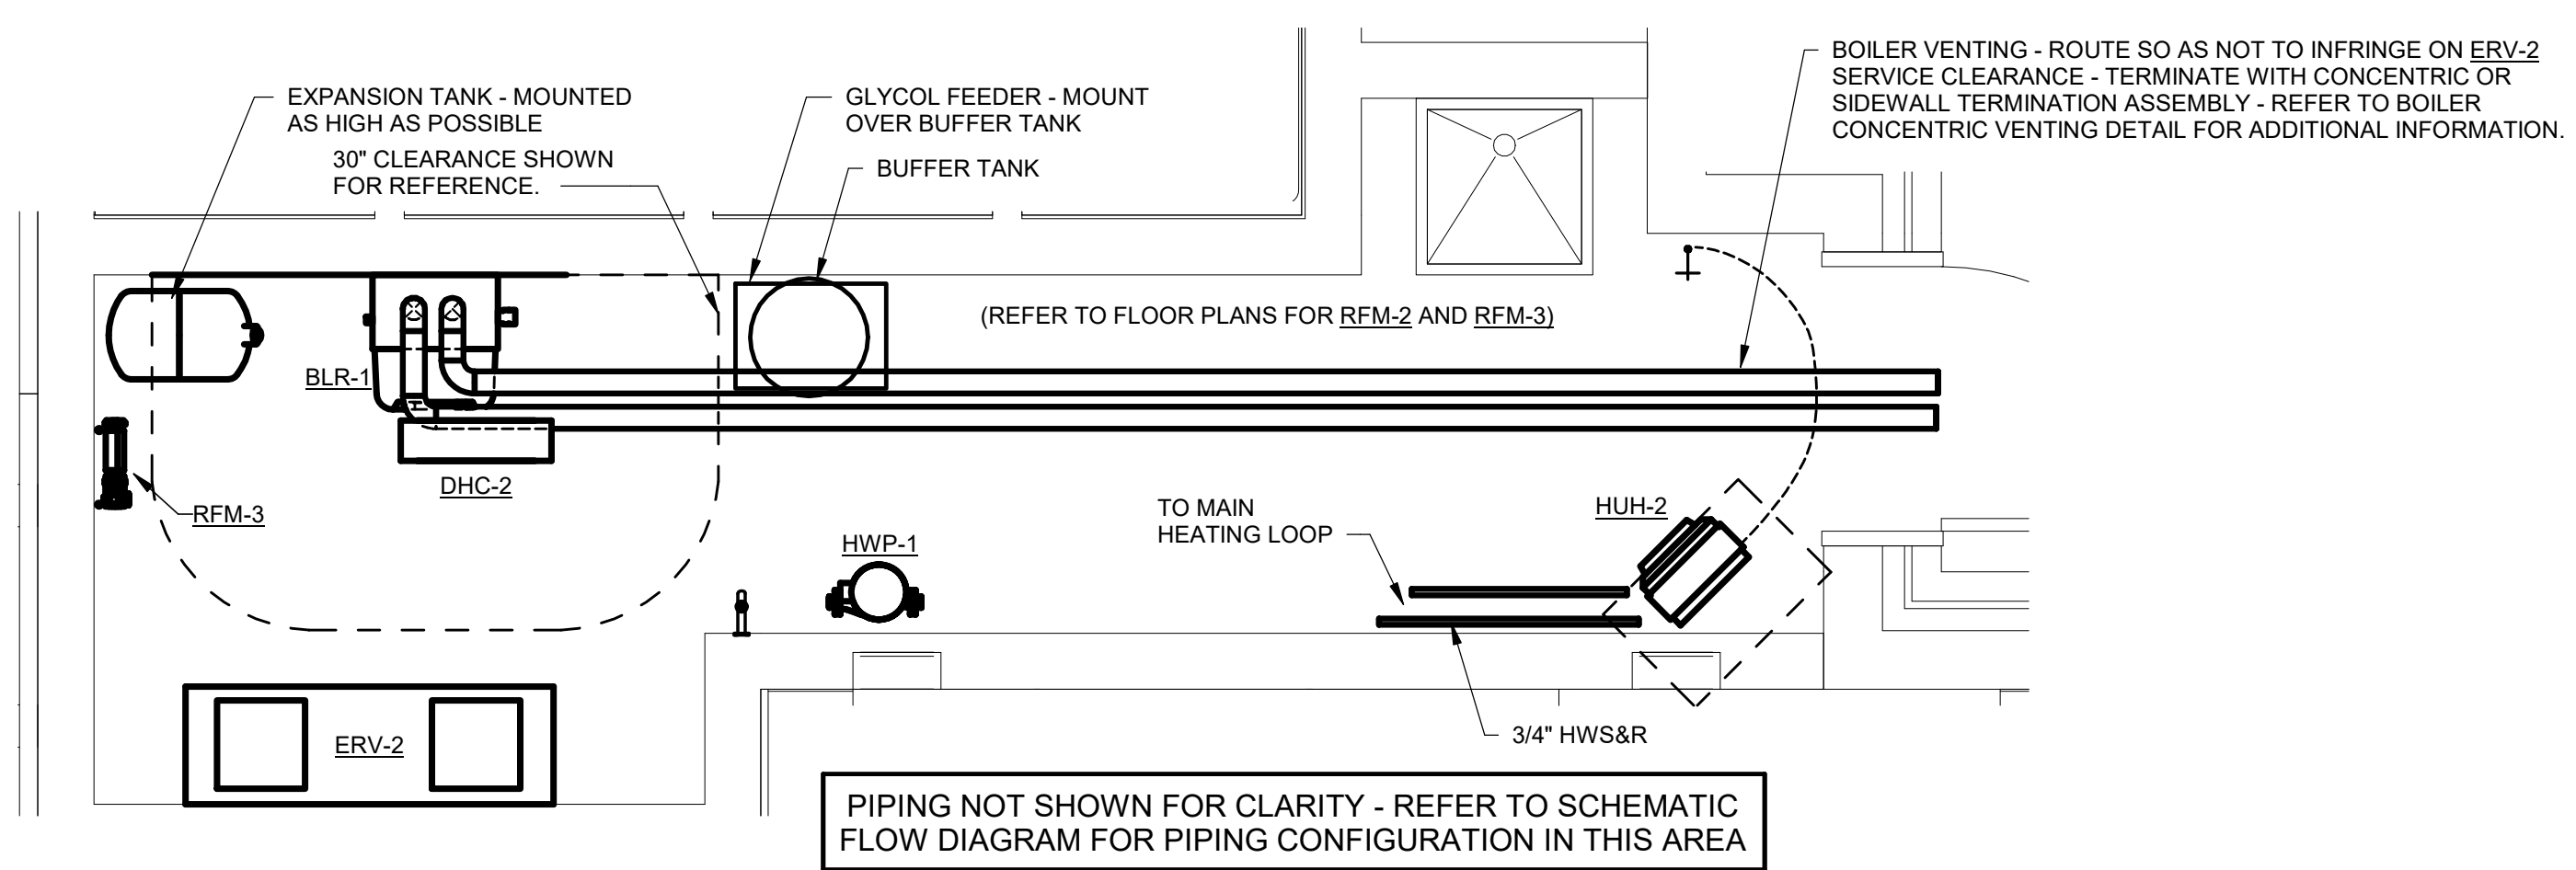

2 LOOP-C - MECHANICAL ROOM ENLARGED VIEW
SCALE: 1/2" = 1'-0"

CONSTRUCTION DOCUMENTS

RECORD REVISIONS

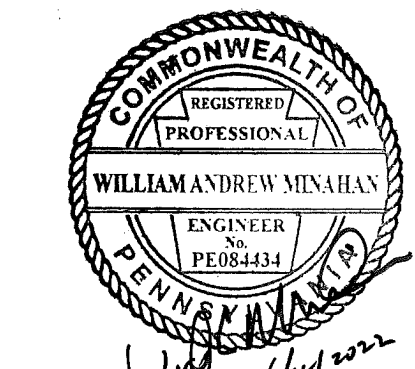

SIGNATURE DATE

SMP ARCHITECTS
1600 WALNUT STREET, SECOND FLOOR
PHILADELPHIA, PENNSYLVANIA

COMMONWEALTH OF PENNSYLVANIA
DEPARTMENT OF GENERAL SERVICES
HARRISBURG, PENNSYLVANIA

D.G.S. PROJECT No. C-114-0006 PHASE 1

HICKORY RUN STATE PARK
LATRINE IMPROVEMENTS

DEPT of CONSERVATION AND NATURAL RESOURCES
WHITE HAVEN, CARBON COUNTY, PA

LOOP-C FLOOR PLAN - MECHANICAL PIPING


VERIFY SCALE

BAR IS ONE (1) INCH LONG
ON ORIGINAL DRAWING: 0 1
IF BAR IS NOT ONE (1) INCH LONG, ADJUST SCALE ACCORDINGLY

CONTRACTOR SHALL FIELD VERIFY ALL DIMENSIONS. VARIANCE FROM CONTRACT DOCUMENTS NOT PERMITTED WITHOUT PROFESSIONAL & BUREAU OF CONSTRUCTION APPROVAL.

DRAWN BY W MINAHAN
DATE 06/17/2022
CHECKED BY T HOVAN
SCALE AS NOTED


DRAWING No. M-6
123 OF 144

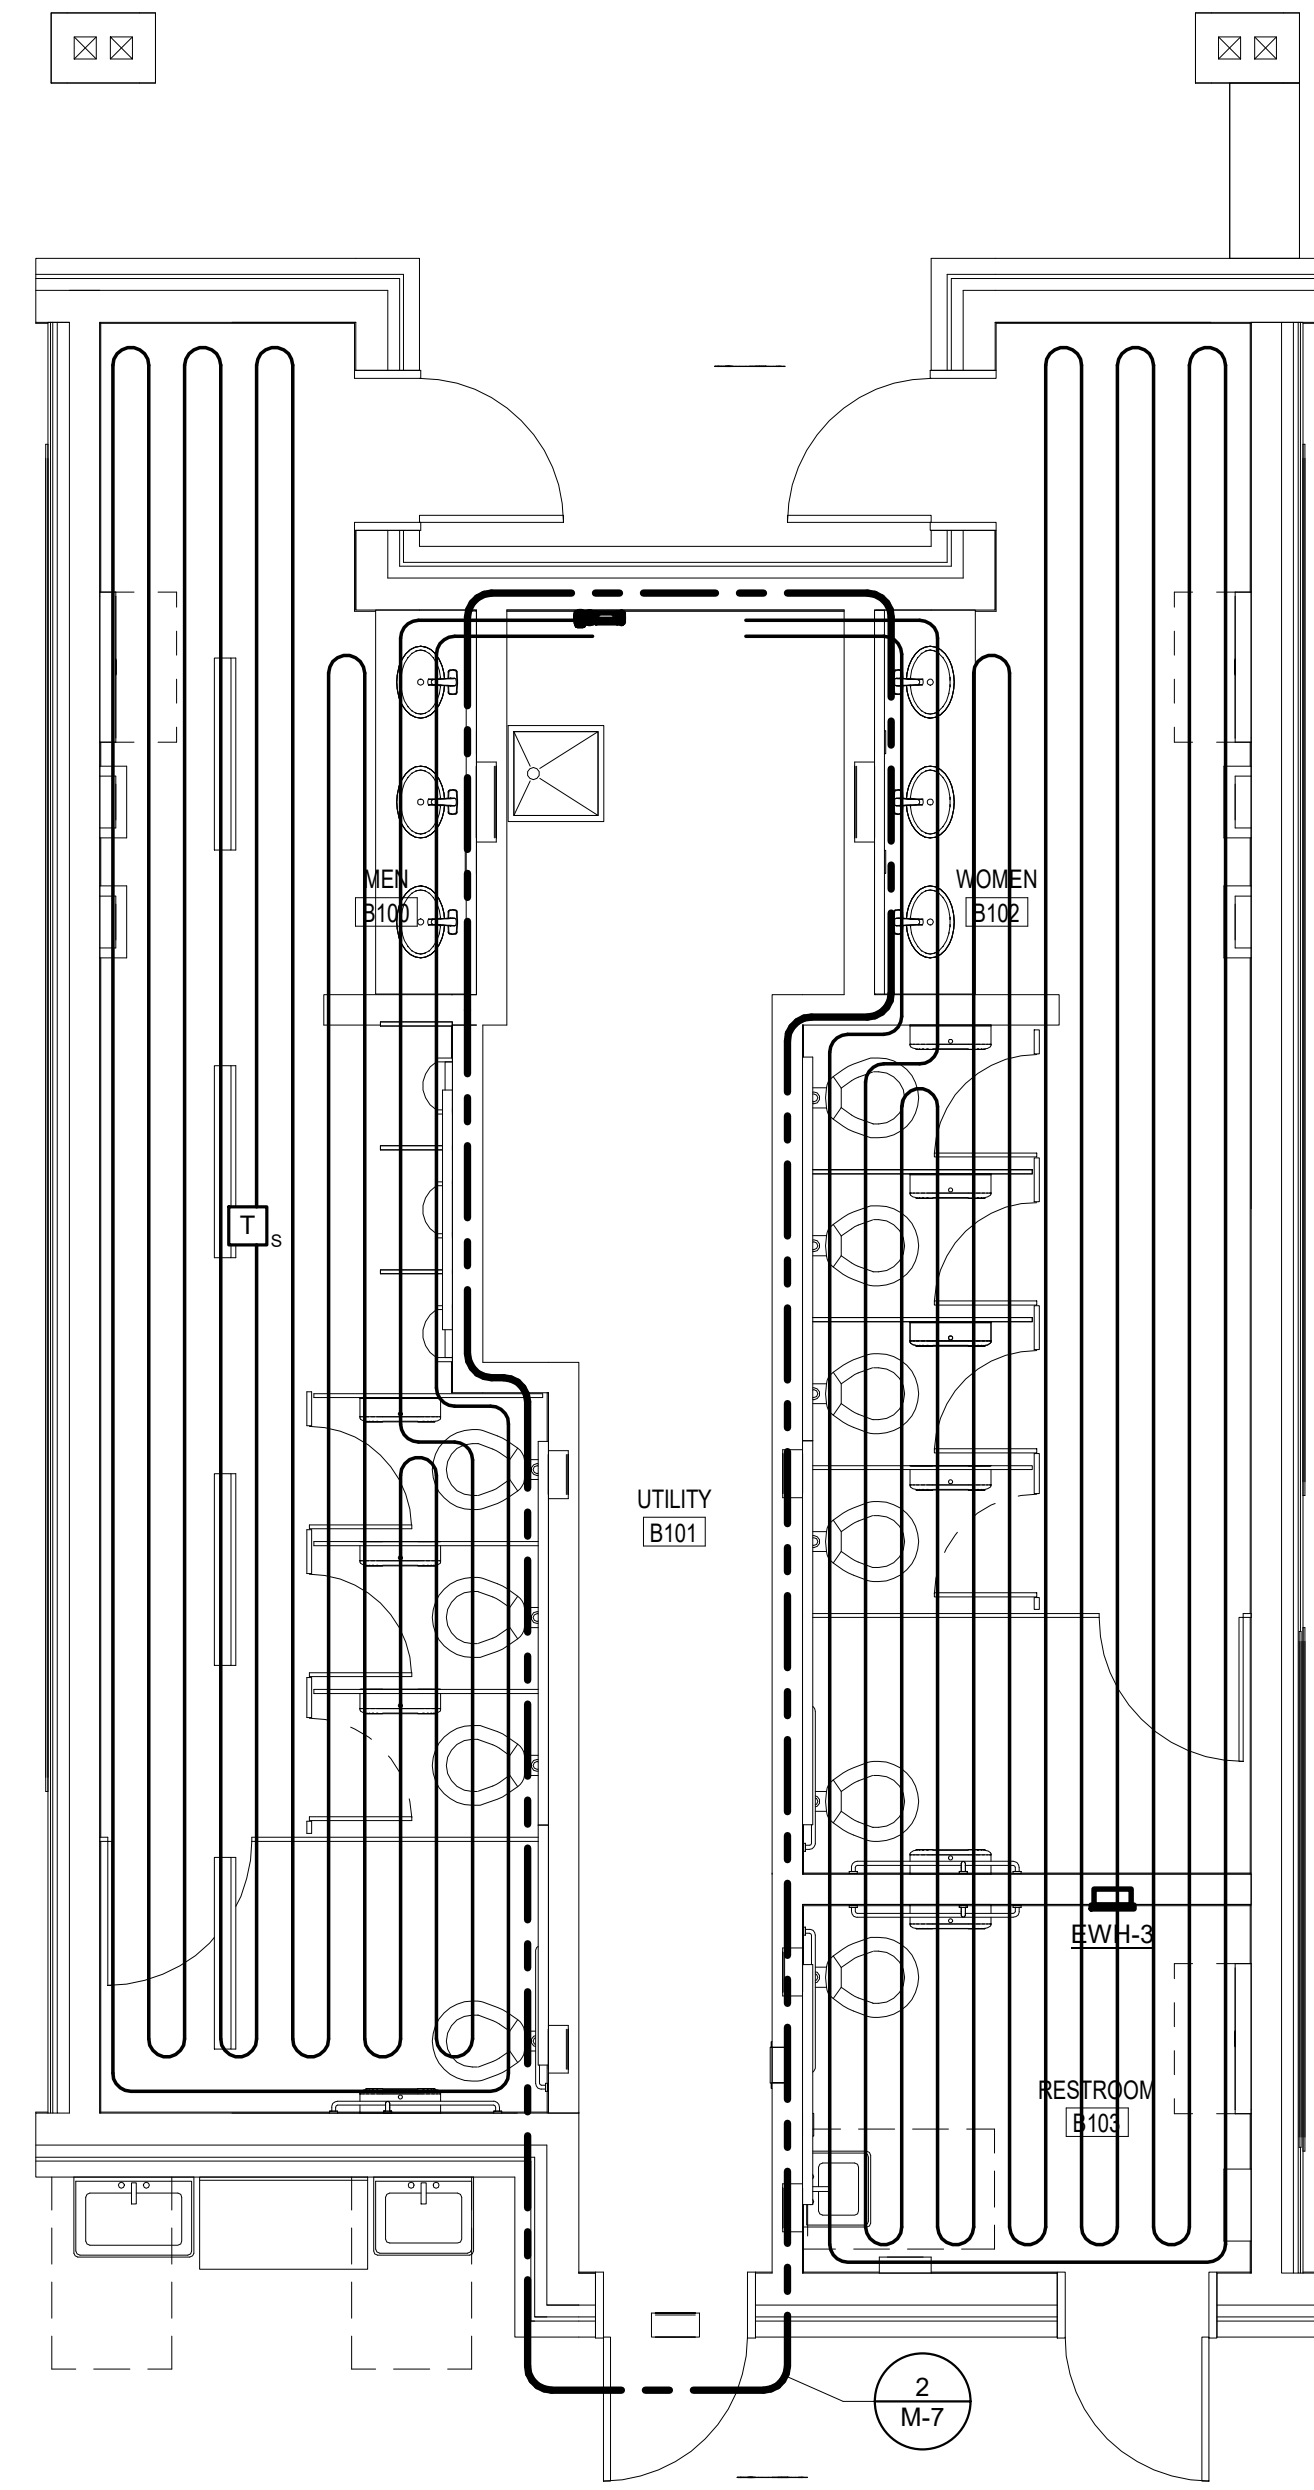

RADIANT FLOOR NOTES (TYPICAL FOR ALL RADIANT FLOOR IN THIS BUILDING)

1. SPACE ALL PEX TUBING ON 12" OC
2. ALL PEX TUBING SHALL BE 3/4" ID
3. PROVIDE SLAB TEMPERATURE SENSOR FOR EACH HEATING ZONE AS INDICATED.
4. MODIFY ROUTING SHOWN AS REQUIRED FOR COORDINATION WITH FLOOR DRAINS AND OTHER FLOOR PENETRATING APPURTENANCES.
5. REFER TO RADIANT FLOOR DETAIL ON DWG M-9 FOR ADDITIONAL INFORMATION.
6. PROVIDE PEX INSULATION BELOW SLAB PER DETAIL UNDER ENTIRE FLOOR SERVED BY RADIANT SYSTEM.

1 OGTC - PIPING
SCALE: 1/4" = 1'-0"

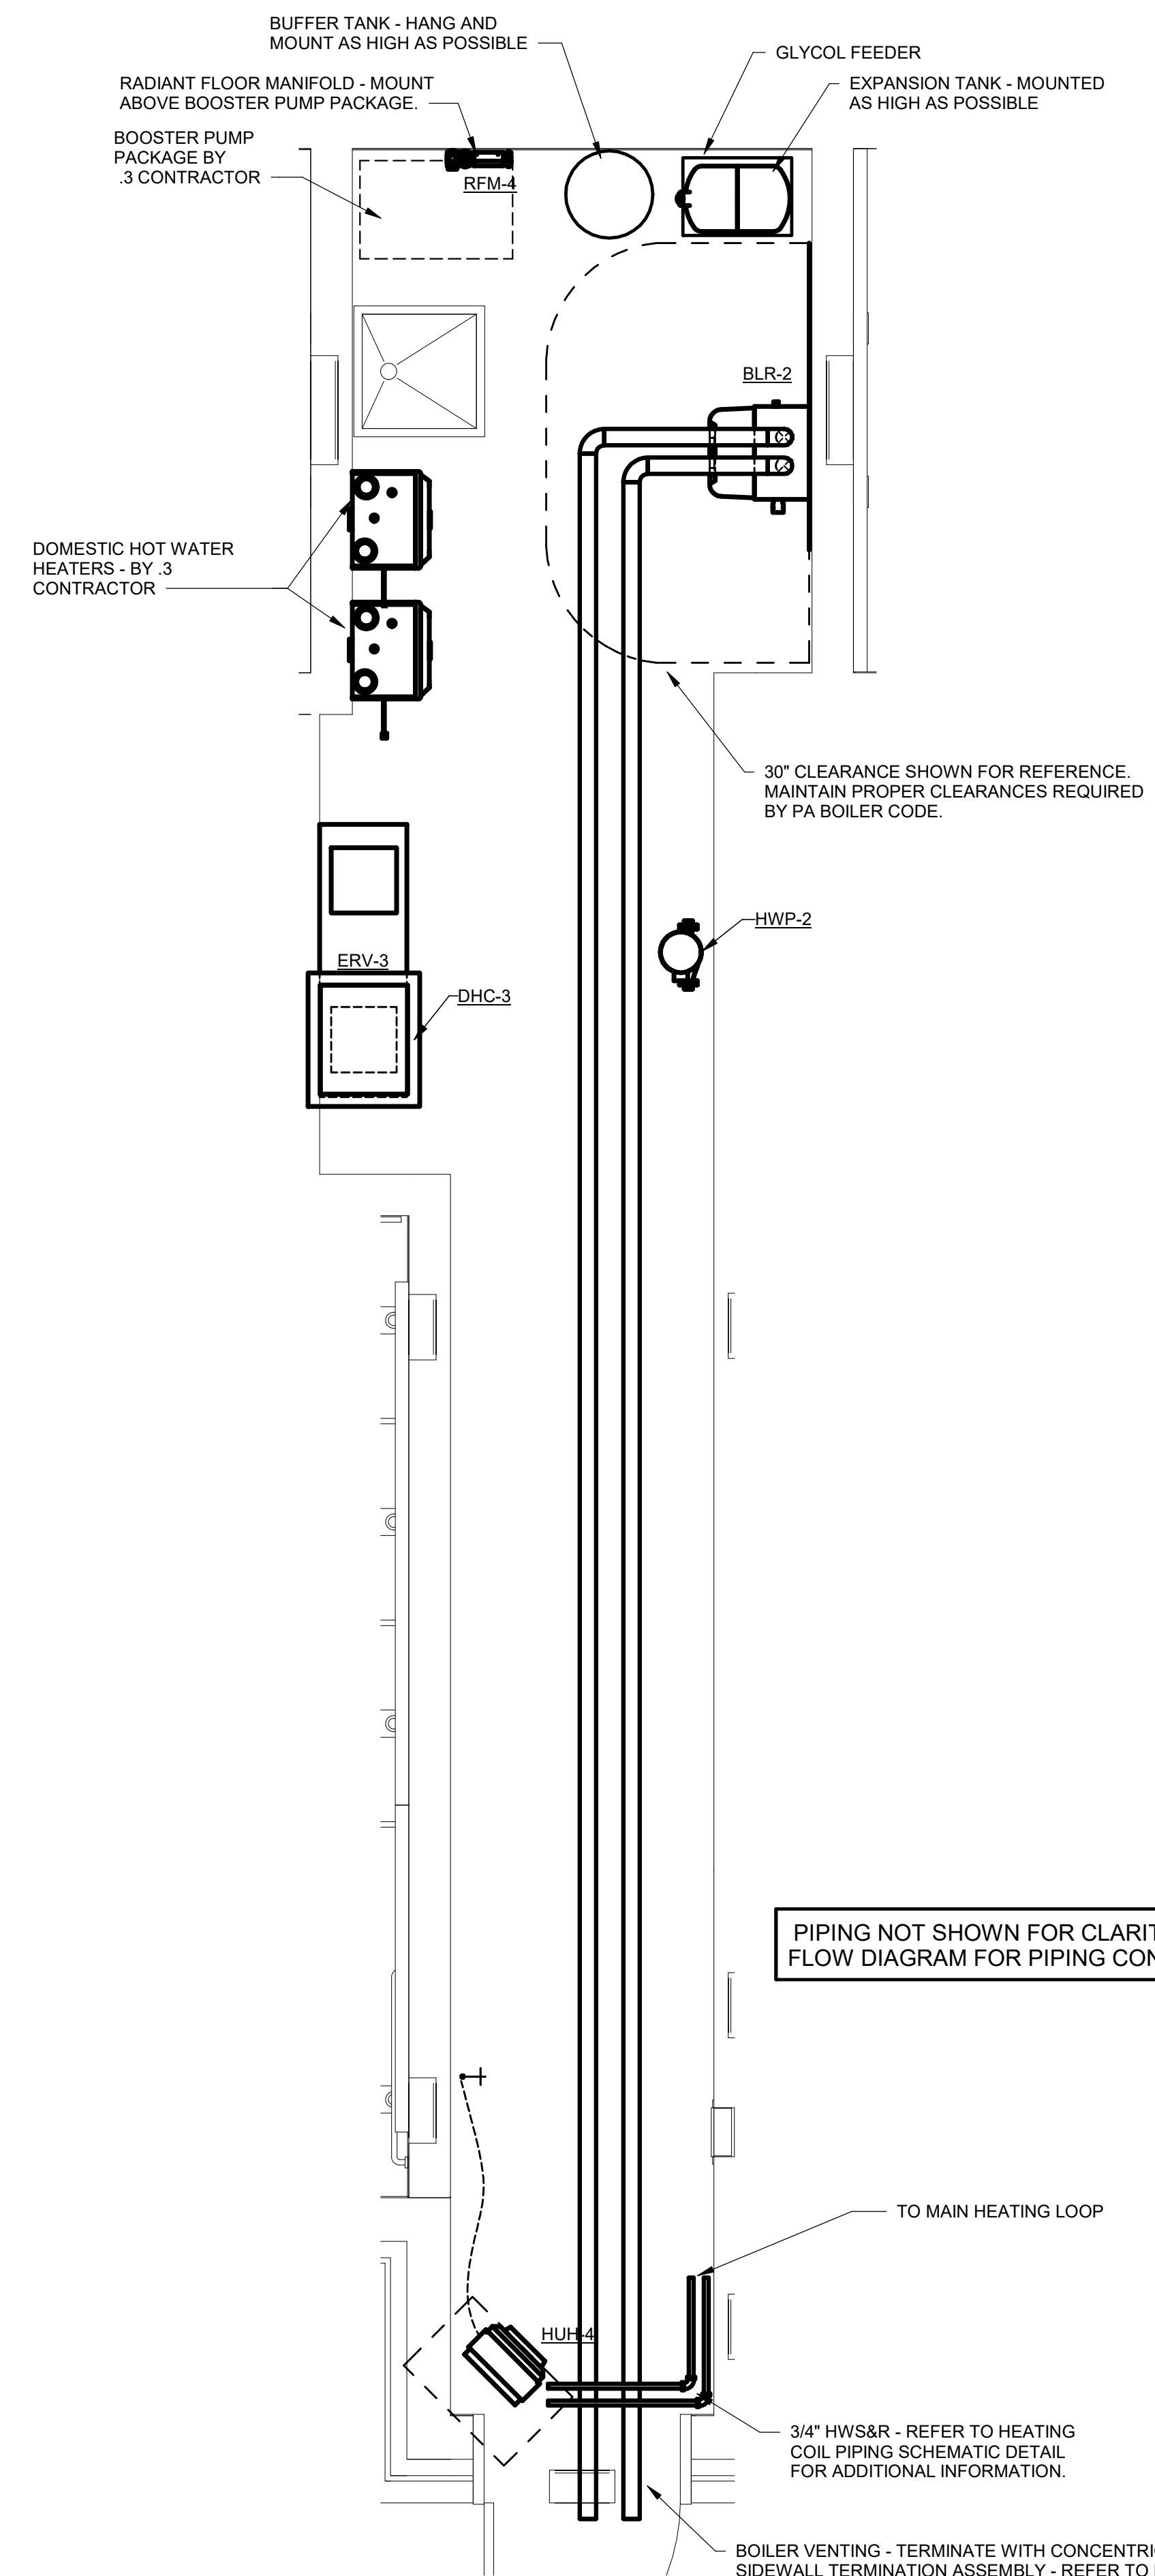

2 OGTC - MECHANICAL ROOM ENLARGED VIEW
SCALE: 1/2" = 1'-0"

VERIFY SCALE

BAR IS ONE (1) INCH LONG
ON ORIGINAL DRAWING: 0 1

IF BAR IS NOT ONE (1) INCH LONG, ADJUST SCALE ACCORDINGLY

CONTRACTOR SHALL FIELD VERIFY ALL DIMENSIONS. VARIANCE FROM CONTRACT DOCUMENTS NOT PERMITTED WITHOUT PROFESSIONAL & BUREAU OF CONSTRUCTION APPROVAL.

DRAWN BY: W MINAHAN
DATE: 06/17/2022
CHECKED BY: T HOVAN
SCALE: AS NOTED

DRAWING No. **M-7**
124 OF 144

CONSTRUCTION DOCUMENTS

RECORD	REVISIONS


SIGNATURE: *W.A. Minahan* DATE: _____

SMP ARCHITECTS
1600 WALNUT STREET, SECOND FLOOR
PHILADELPHIA, PENNSYLVANIA


COMMONWEALTH OF PENNSYLVANIA
DEPARTMENT OF GENERAL SERVICES
HARRISBURG, PENNSYLVANIA

D.G.S. PROJECT No. **C-114-0006 PHASE 1**
HICKORY RUN STATE PARK
LATRINE IMPROVEMENTS
DEPT of CONSERVATION AND NATURAL RESOURCES
WHITE HAVEN, CARBON COUNTY, PA


OGTC FLOOR PLAN - MECHANICAL PIPING

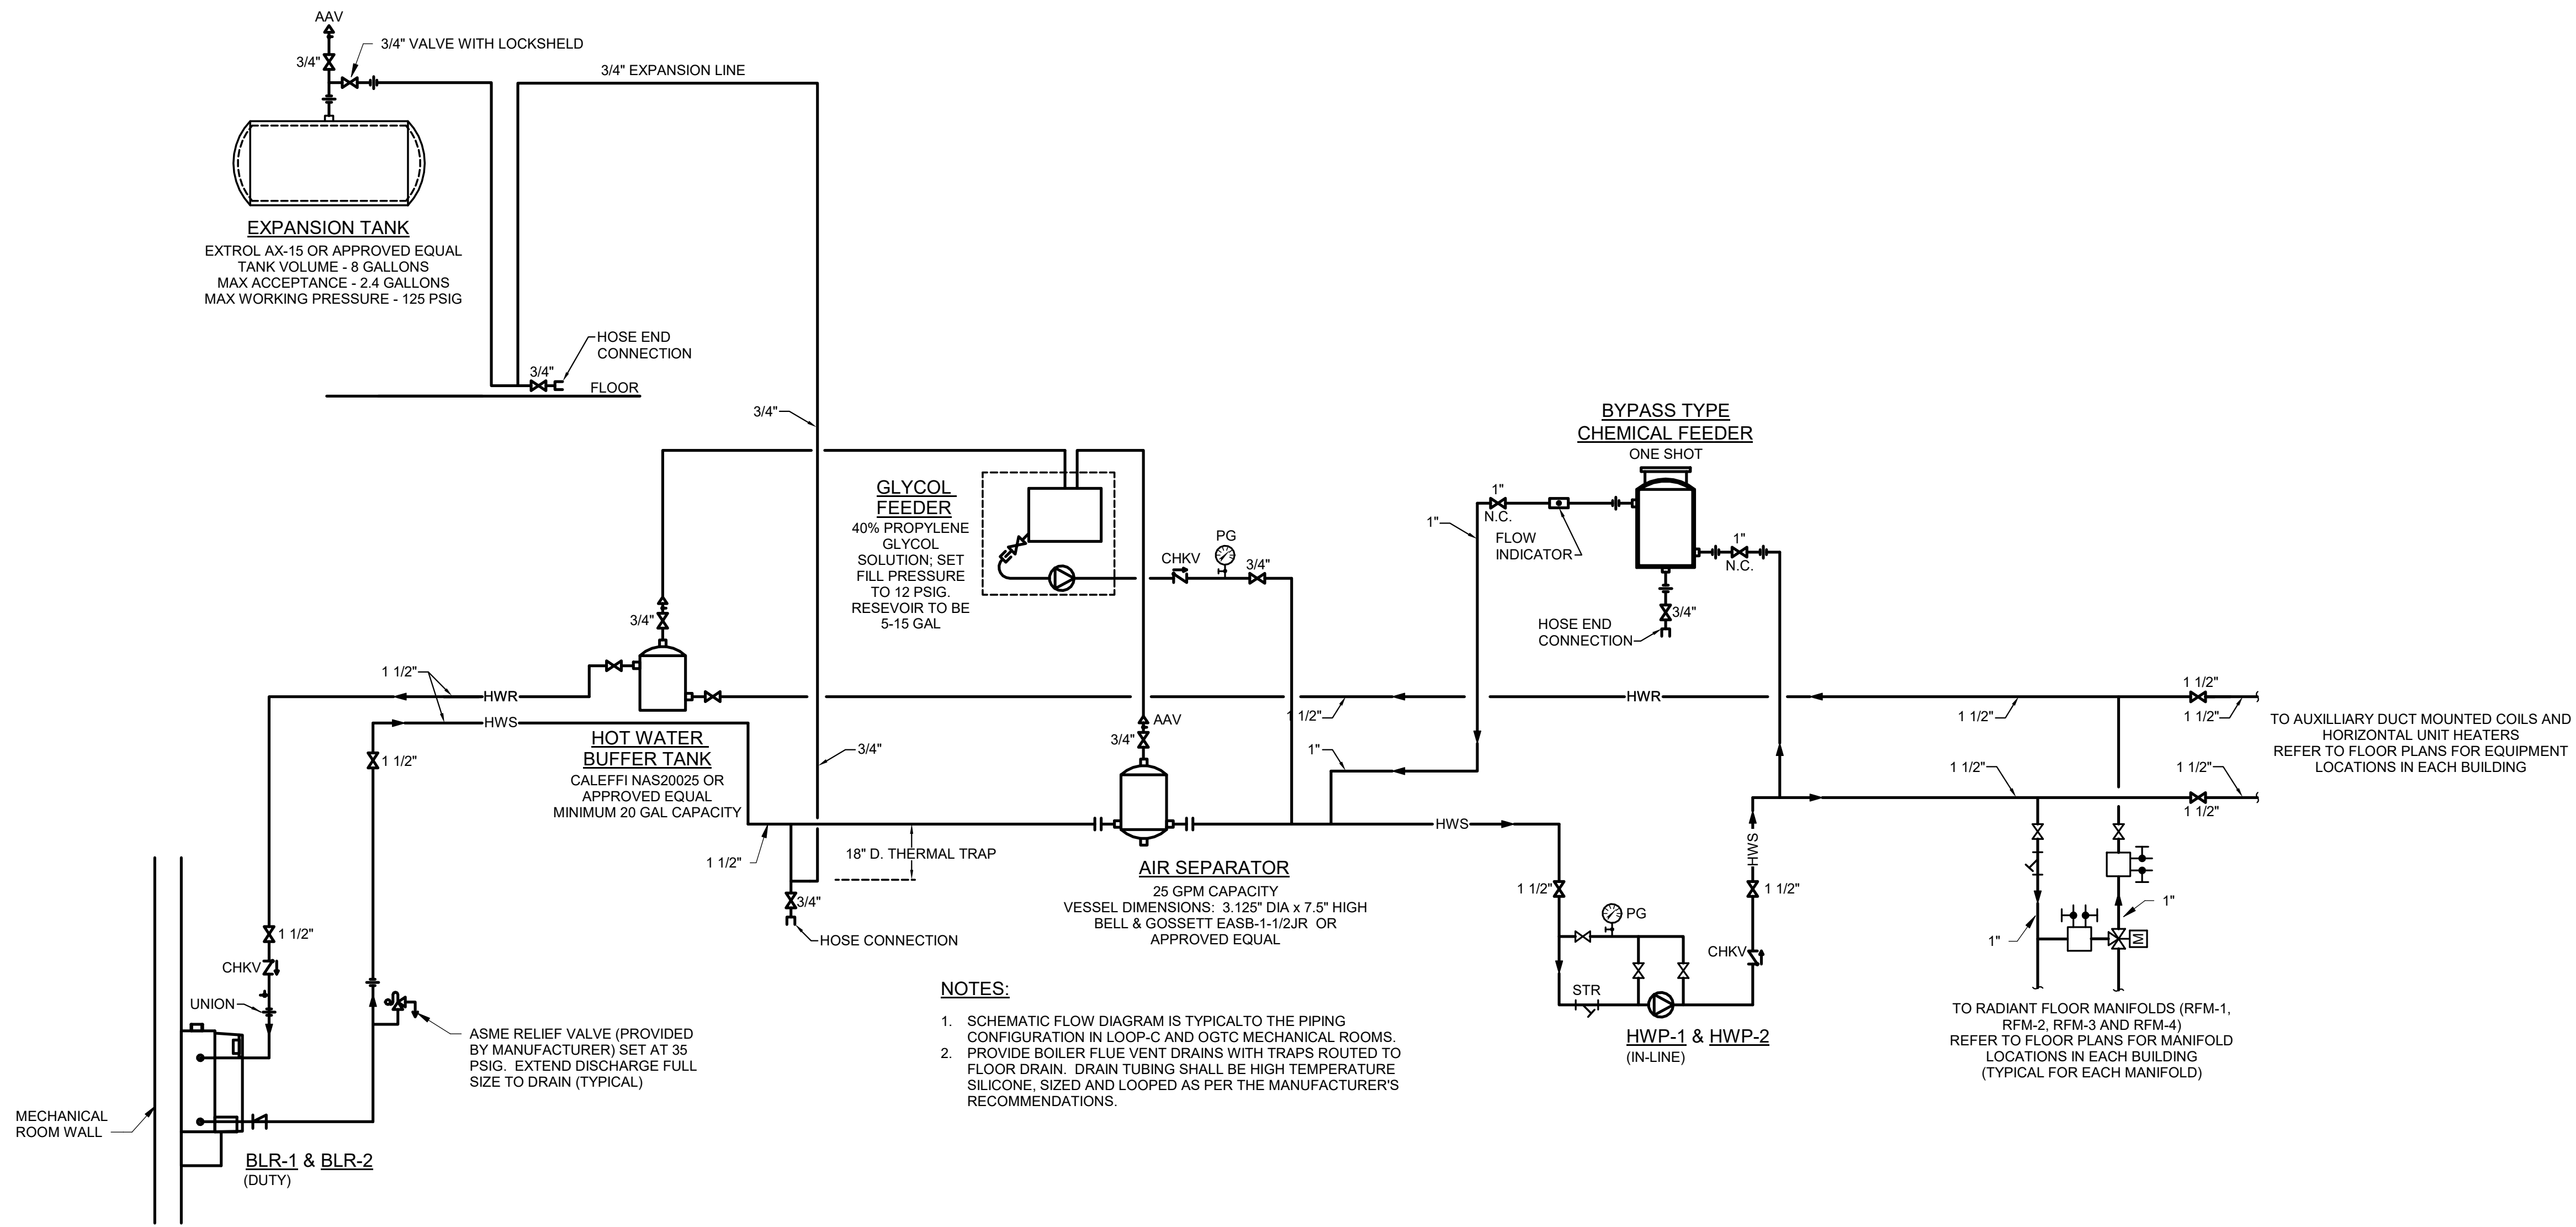

1 LOOP-C AND OGTC HOT WATER SCHEMATIC FLOW DIAGRAM
NOT TO SCALE

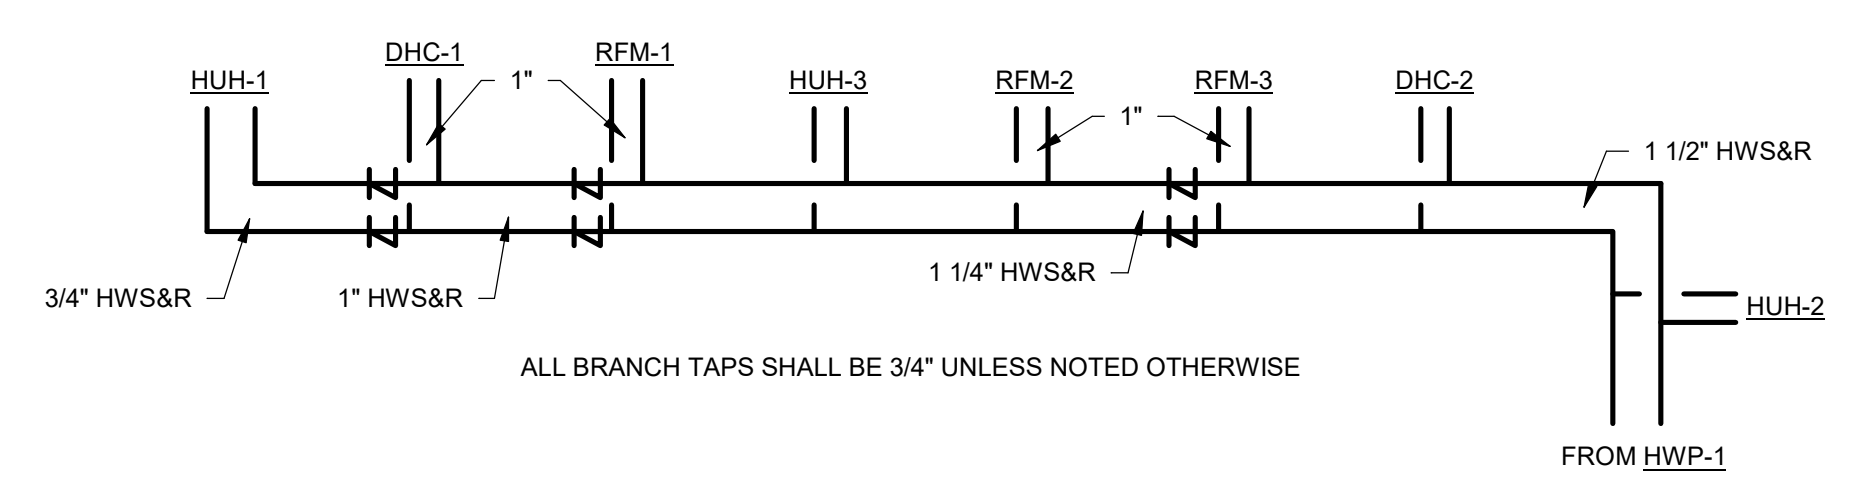


2 LOOP-C PIPING RISER DIAGRAM
NOT TO SCALE

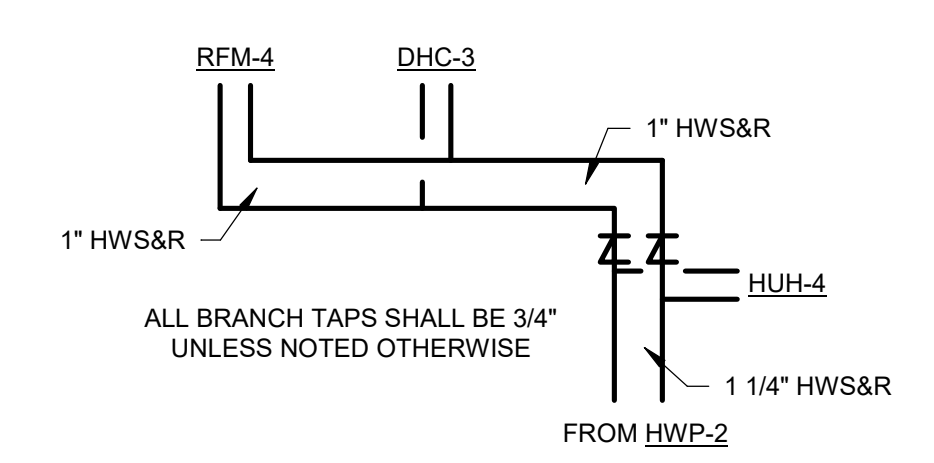

3 OGTC PIPING RISER DIAGRAM
NOT TO SCALE


VERIFY SCALE
BAR IS ONE (1) INCH LONG
ON ORIGINAL DRAWING: 0 1
IF BAR IS NOT ONE (1) INCH LONG, ADJUST SCALE ACCORDINGLY

CONSTRUCTION DOCUMENTS		
RECORD REVISIONS		
SIGNATURE DATE		
SMP ARCHITECTS 1600 WALNUT STREET, SECOND FLOOR PHILADELPHIA, PENNSYLVANIA		
COMMONWEALTH OF PENNSYLVANIA DEPARTMENT OF GENERAL SERVICES HARRISBURG, PENNSYLVANIA		
D.G.S. PROJECT No. C-114-0006 PHASE 1		
HICKORY RUN STATE PARK LATRINE IMPROVEMENTS		
DEPT of CONSERVATION AND NATURAL RESOURCES WHITE HAVEN, CARBON COUNTY, PA		
HOT WATER SCHEMATIC FLOW DIAGRAM		
CONTRACTOR SHALL FIELD VERIFY ALL DIMENSIONS. VARIANCE FROM CONTRACT DOCUMENTS NOT PERMITTED WITHOUT PROFESSIONAL & BUREAU OF CONSTRUCTION APPROVAL.	DRAWN BY W MINAHAN CHECKED BY T HOVAN	DATE 06/17/2022 SCALE AS NOTED
		DRAWING No. M-8
125 OF 144		

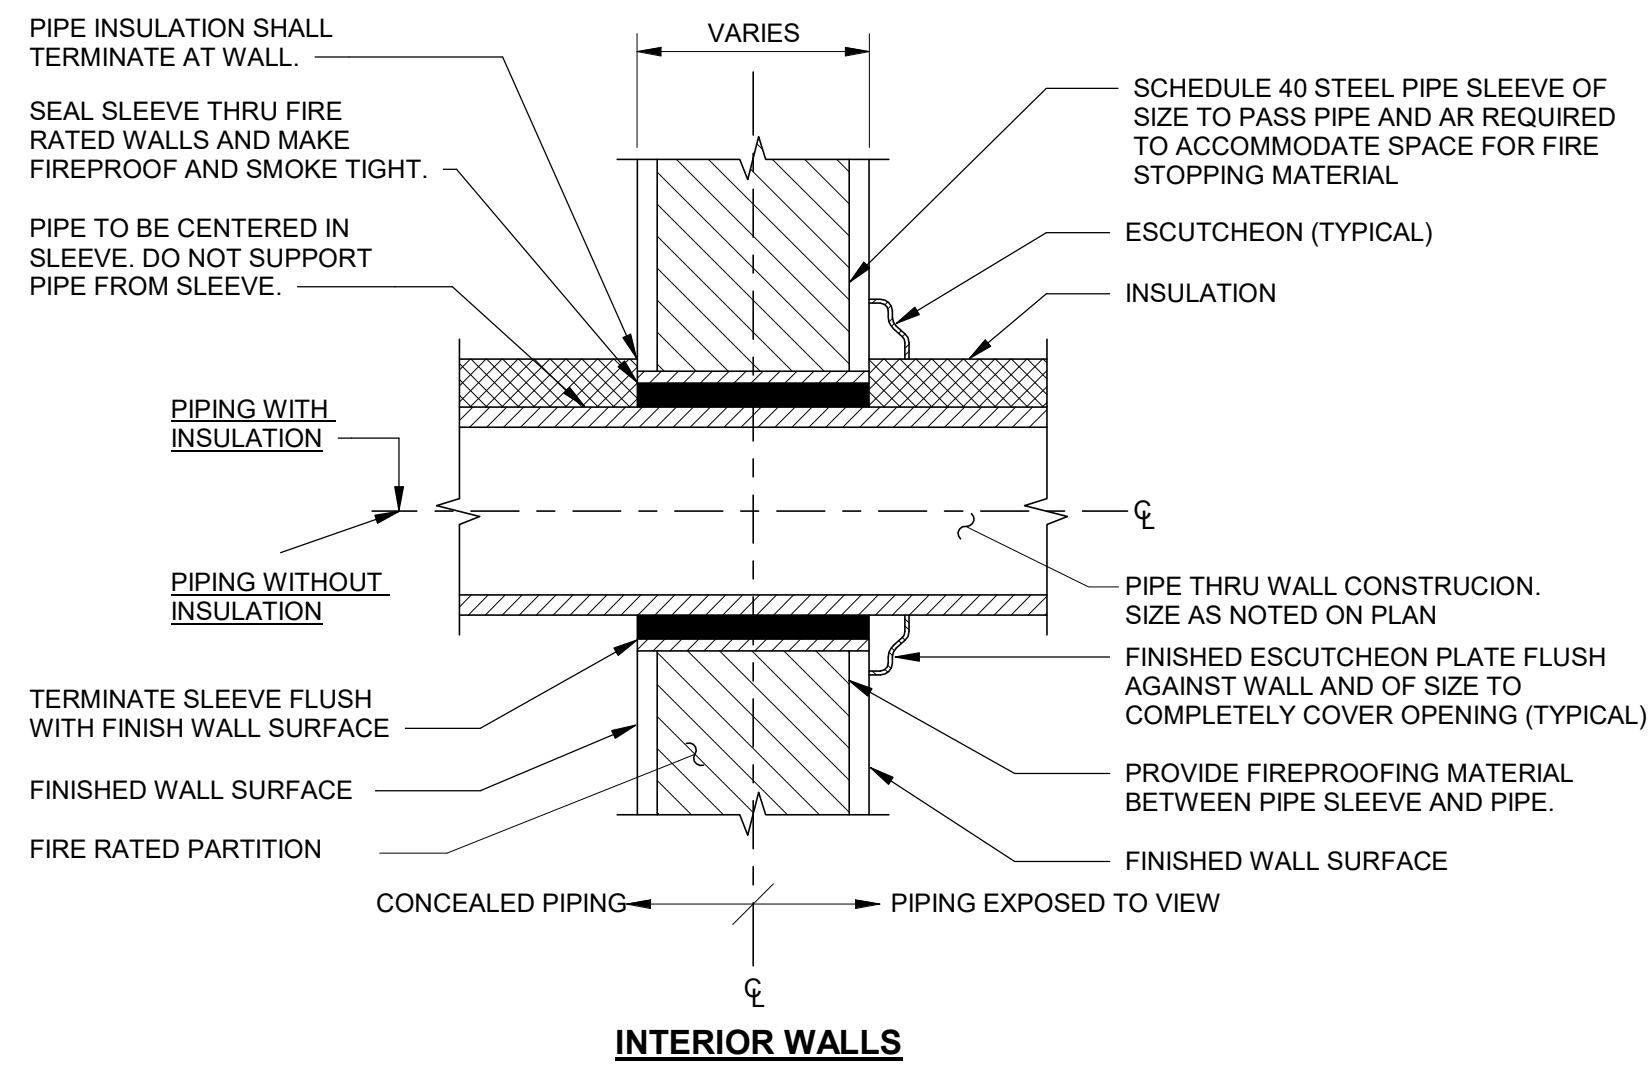


INTERIOR WALLS


- NOTES:**
- APPROVED FIRE STOPPING SHALL BE PROVIDED AND INSTALLED AT ALL EXISTING AND NEW WALL PENETRATION THRU TIME RATED WALLS AND PARTITIONS.

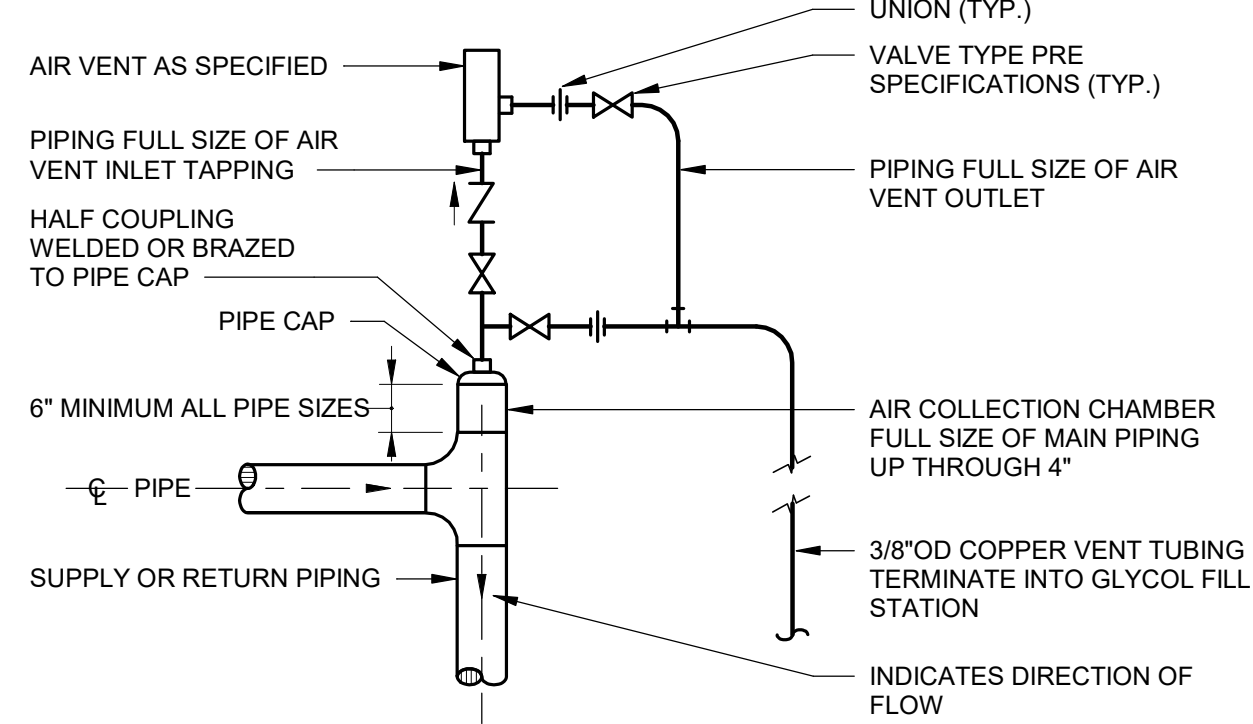

2 AUTOMATIC AIR VENT DETAIL FOR MAIN 4" DIAMETER OR SMALLER
NOT TO SCALE

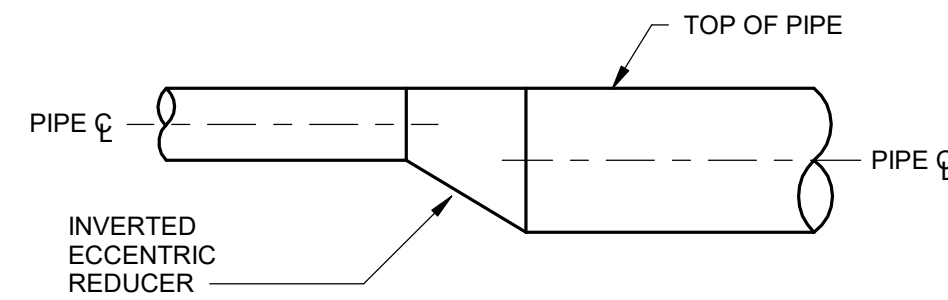


3 TYPICAL PIPE SIZE CHANGE FOR WATER
NOT TO SCALE

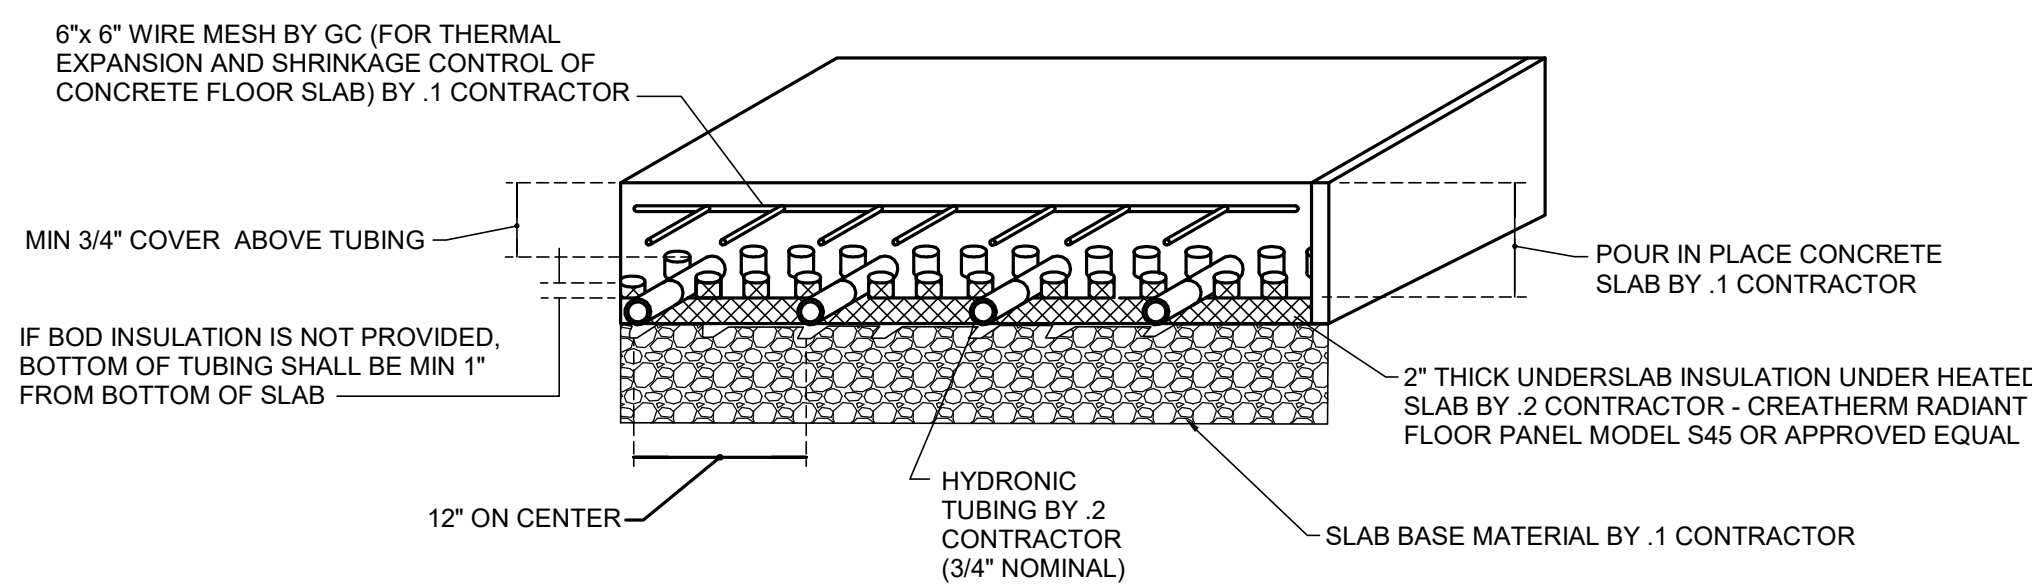


- NOTES:**
- REFER TO ARCHITECTURAL, CIVIL, LANDSCAPING, AND STRUCTURAL DRAWINGS FOR ADDITIONAL INFORMATION. IN THE EVENT OF A CONFLICT BETWEEN THIS DETAIL AND INFORMATION IN THE STRUCTURAL OR ARCHITECTURAL CONSTRUCTION DOCUMENTS, THE LATTER SHALL TAKE PRECEDENCE.
 - METAL DECK, CONCRETE SLAB, SLAB REINFORCEMENT, AND SIDE INSULATION SHALL BE PROVIDED BY THE .1 CONTRACTOR
 - TUBING AND INSULATED RADIANT FLOOR PANELS FOR SECURING TUBING SHALL BE PROVIDED BY THE .2 CONTRACTOR
 - 2" THICK UNDERSLAB INSULATION, REQUIRED FOR RADIANT FLOOR, SHALL COVER ENTIRE SLAB AREA INCLUDING MECHANICAL SPACES.

7 RADIANT HEATING SLAB ON GRADE DETAIL
NOT TO SCALE

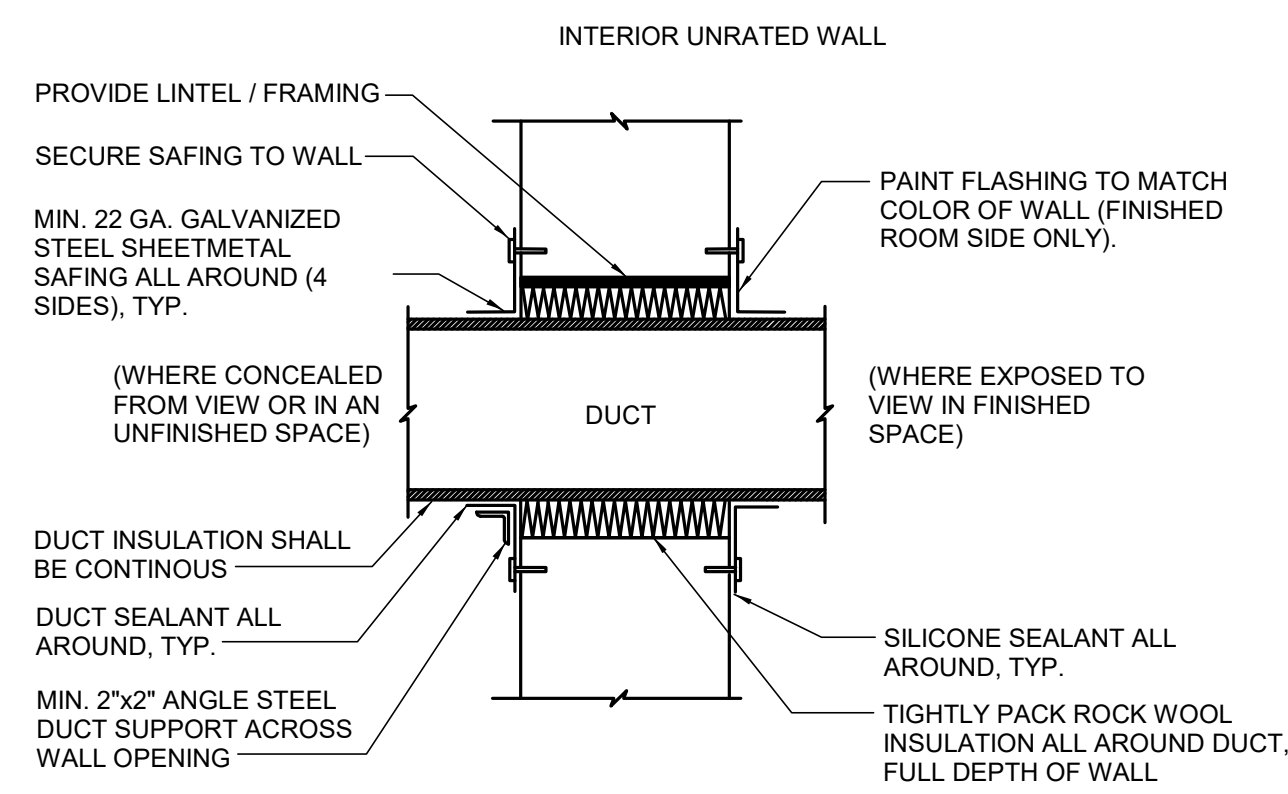


NOTE: THIS DETAIL DOES NOT APPLY TO FIRE OR SMOKE RATED WALLS.


9 DUCT PENETRATION DETAIL - INTERIOR WALL
NOT TO SCALE

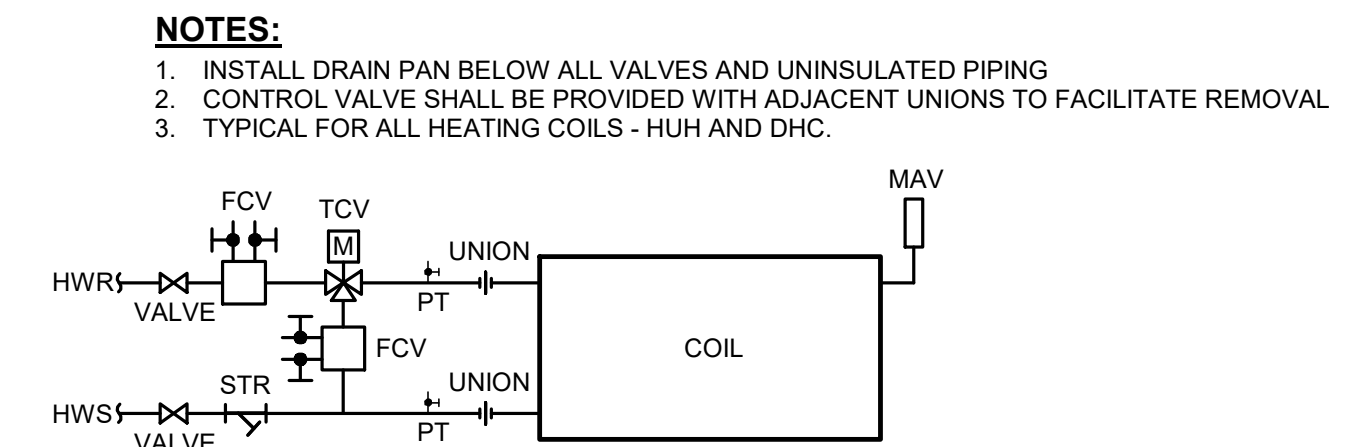

4 HEATING COIL PIPING SCHEMATIC - HOT WATER - 3-WAY
NOT TO SCALE

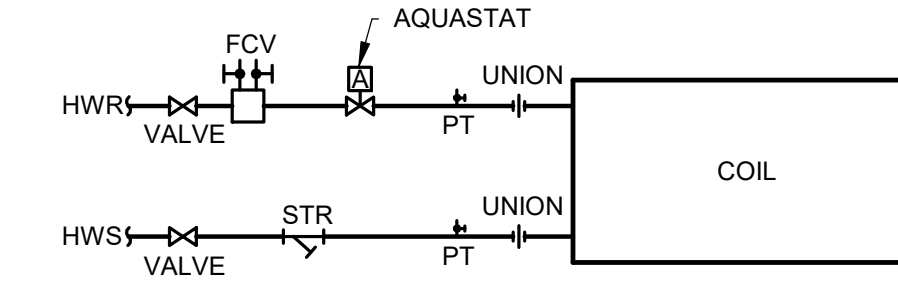


5 HORIZONTAL UNIT HEATER COIL PIPING SCHEMATIC - HOT WATER - 2-WAY
SCALE: 1/8" = 1'-0"

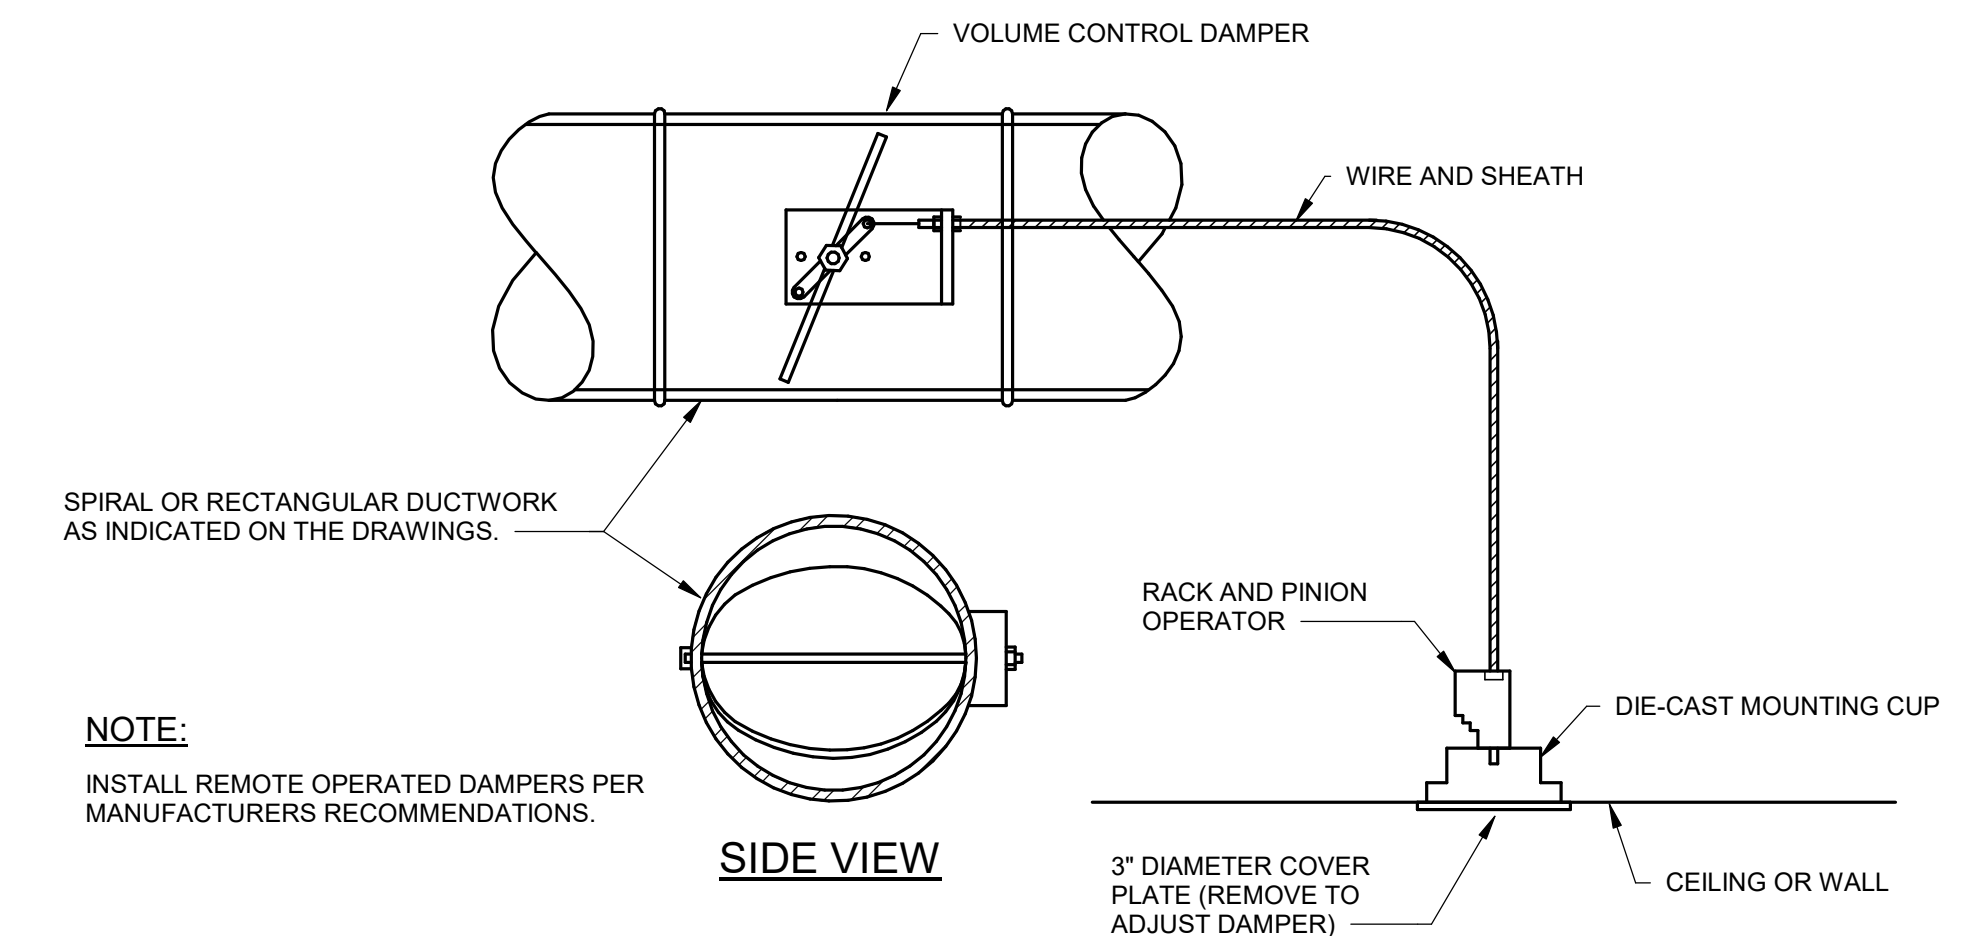

NOTE:
INSTALL REMOTE OPERATED DAMPERS PER MANUFACTURERS RECOMMENDATIONS.

8 CABLE CONTROL VOLUME CONTROL DAMPER - (CONTROL FROM WALL OR CEILING)
NOT TO SCALE

1 PIPE SLEEVE THRU WALL DETAIL
NOT TO SCALE

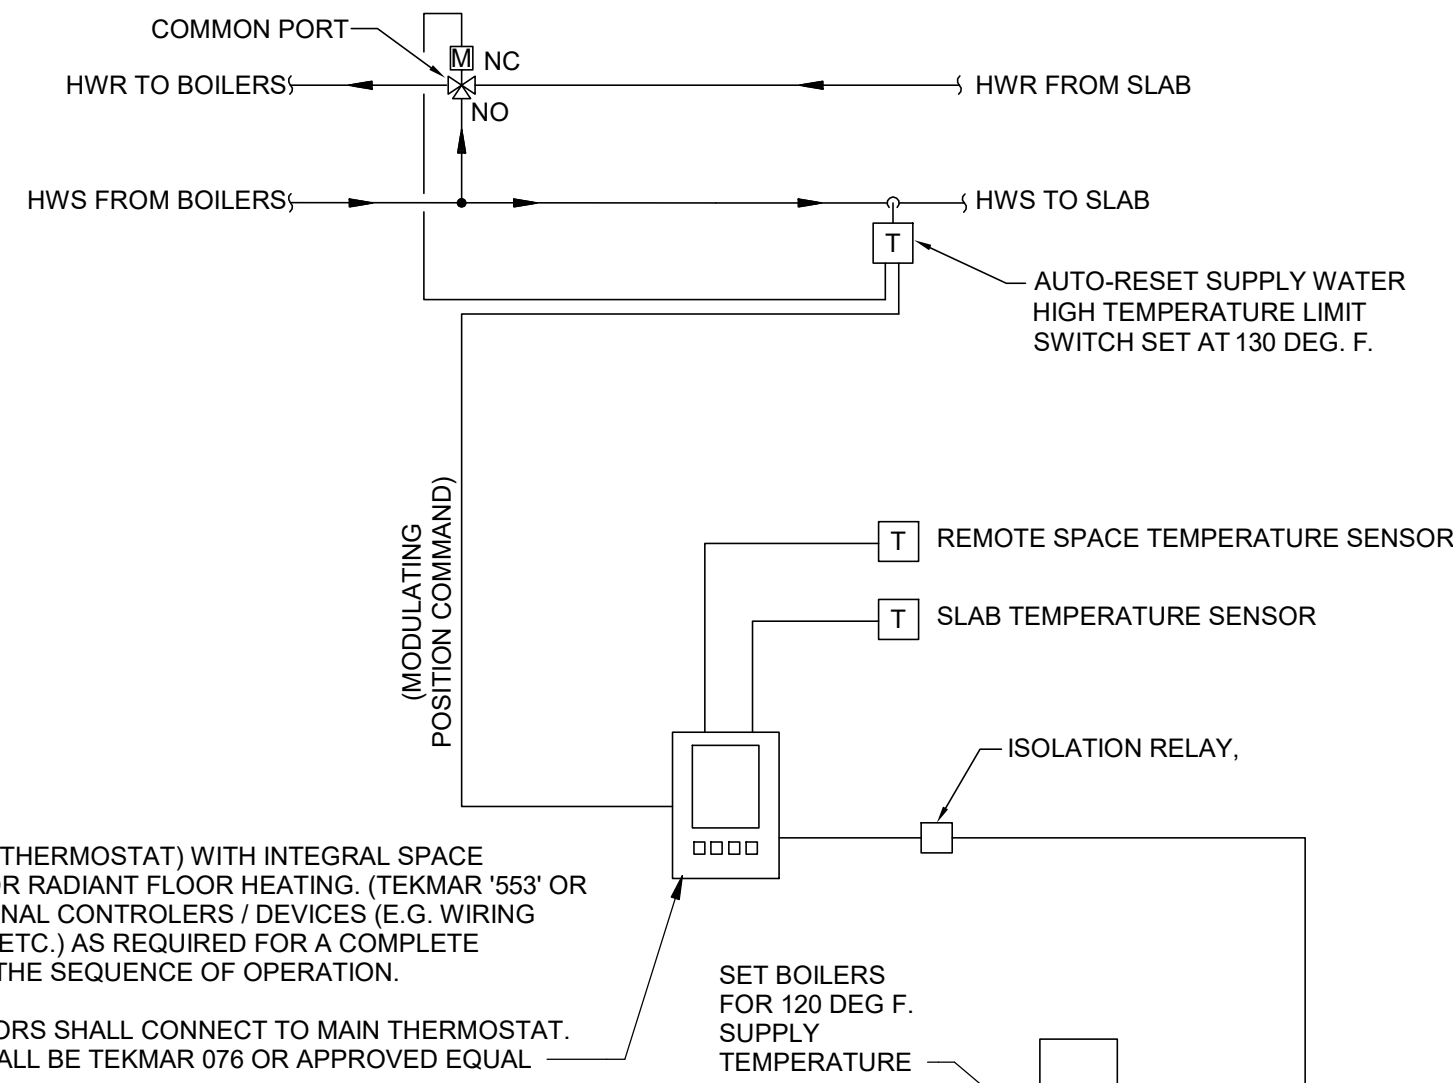

NOTE: ALL CONTROL WORK, INCLUDING CONTROL POWER NOT SHOWN ON THIS DIAGRAM, SHALL BE BY .2 CONTRACTOR.

NOTE: LOCATE ON NORTH WALL OF BUILDING WITH SUNSHIELD. ALSO LOCATE AWAY FROM EXHAUST AIR SOURCES.


6 RADIANT FLOOR SLAB HEATING SYSTEM CONTROL DIAGRAM
NOT TO SCALE

OUTDOOR AIR SENSOR FOR BOILER OPERATION

ALL WORK ASSOCIATED WITH SHEHAQUA IS BASE BID #2
ALL WORK ASSOCIATED WITH CAMP DADDY ALLEN IS BASE BID #3

CONSTRUCTION DOCUMENTS

RECORD REVISIONS

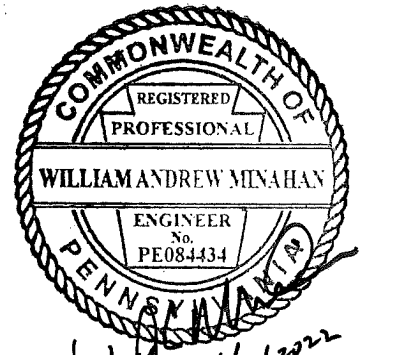

SIGNATURE DATE

SMP ARCHITECTS
1600 WALNUT STREET, SECOND FLOOR
PHILADELPHIA, PENNSYLVANIA

COMMONWEALTH OF PENNSYLVANIA
DEPARTMENT OF GENERAL SERVICES
HARRISBURG, PENNSYLVANIA

D.G.S. PROJECT No. C-114-0006 PHASE 1

HICKORY RUN STATE PARK
LATRINE IMPROVEMENTS
DEPT OF CONSERVATION AND NATURAL RESOURCES
WHITE HAVEN, CARBON COUNTY, PA

MECHANICAL DETAILS


VERIFY SCALE

BAR IS ONE (1) INCH LONG ON ORIGINAL DRAWING: 0 1


IF BAR IS NOT ONE (1) INCH LONG, ADJUST SCALE ACCORDINGLY

CONTRACTOR SHALL FIELD VERIFY ALL DIMENSIONS. VARIANCE FROM CONTRACT DOCUMENTS NOT PERMITTED WITHOUT PROFESSIONAL & BUREAU OF CONSTRUCTION APPROVAL.


DRAWN BY W MINAHAN	DATE 06/17/2022	DRAWING No. M-9
CHECKED BY T HOVAN	SCALE AS NOTED	

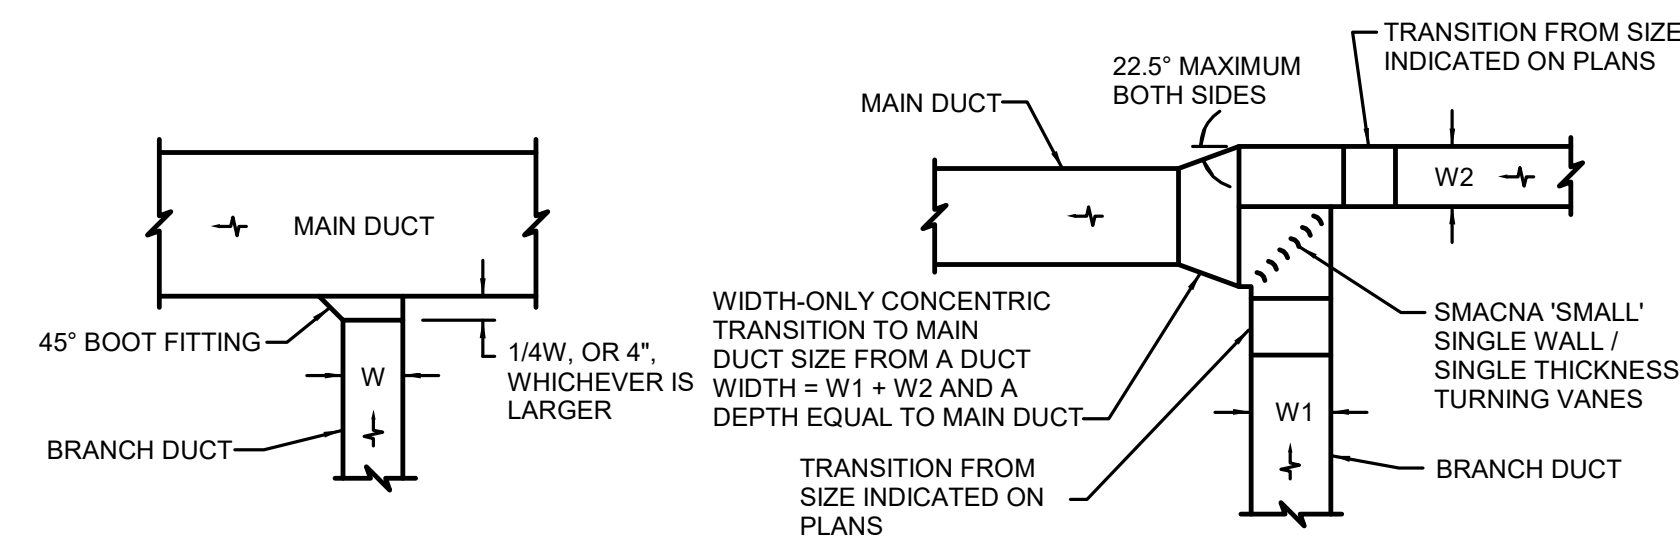


CONVERGING BRANCH DUCT TAKE-OFF WHERE BRANCH DUCT FLOW AREA IS LESS THAN 25% OF MAIN DUCT AREA

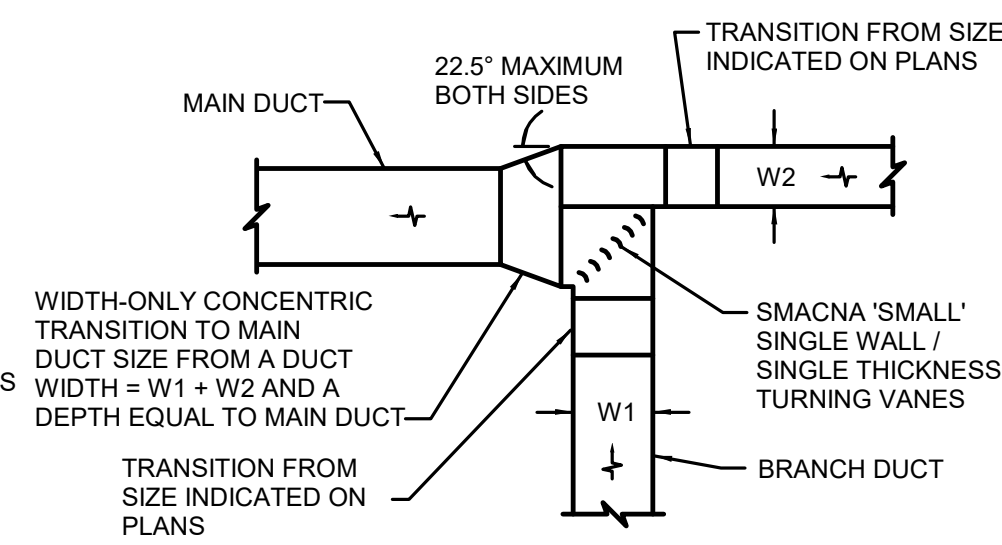

CONVERGING BRANCH DUCT TAKE-OFF WHERE BRANCH DUCT FLOW AREA IS GREATER THAN 25% OF MAIN DUCT AREA

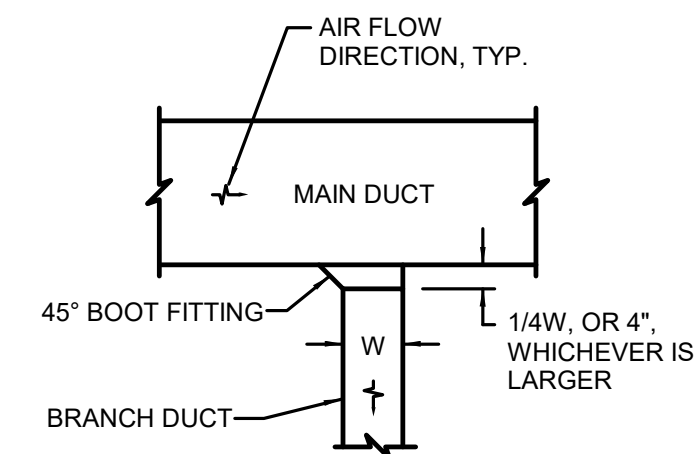


DIVERGING BRANCH DUCT TAKE-OFF WHERE BRANCH DUCT AREA IS LESS THAN 25% OF MAIN DUCT AREA

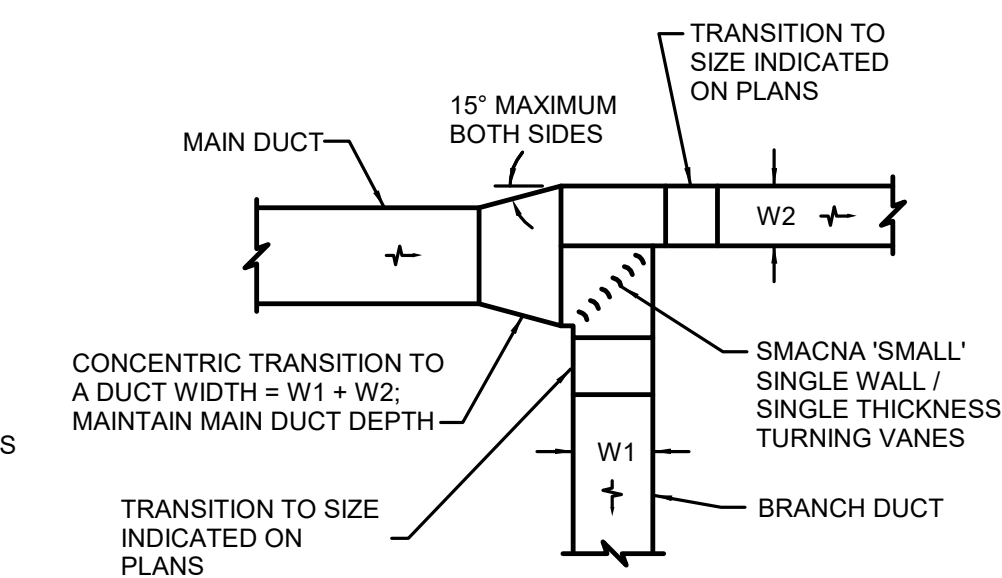


DIVERGING BRANCH DUCT TAKE-OFF WHERE BRANCH DUCT AREA IS GREATER THAN 25% OF MAIN DUCT AREA

RECTANGULAR BRANCH DUCT CONNECTIONS TO RECTANGULAR DUCT

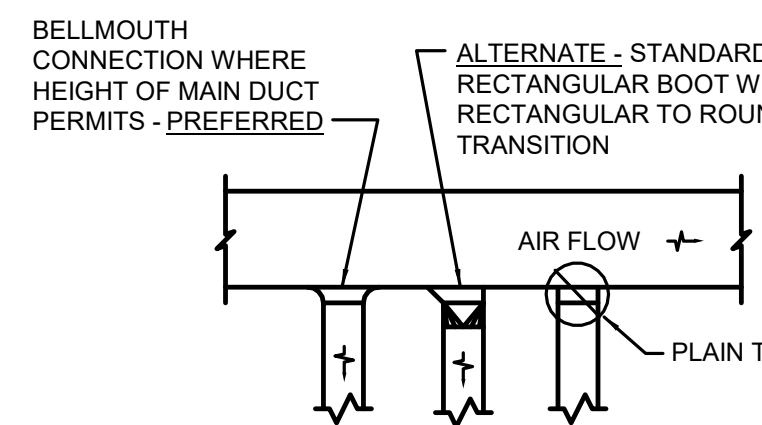


DIVERGING BRANCH FLOW

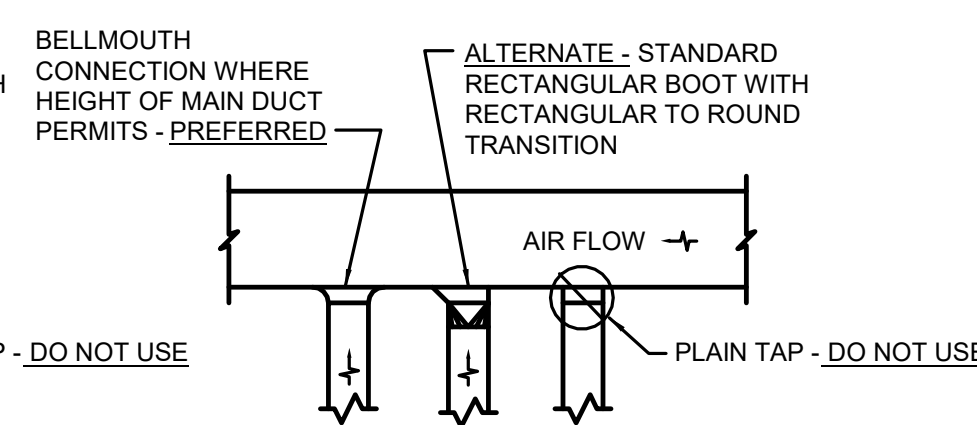

CONVERGING BRANCH FLOW


- NOTES:
1. ALTERNATE FITTINGS SHALL BE USED WHEN DUCT HEIGHT DOES NOT PERMIT THE USE OF THE PREFERRED FULL SIZE BELLMOUTH.
 2. THIS DETAIL APPLIES TO BRANCH RUNOUTS TO DIFFUSERS AS WELL AS SUB-MAIN BRANCH DUCT TAKEOFFS.
 3. FOR ALTERNATE RECTANGULAR CONNECTIONS, THE ROUND TO RECTANGULAR TRANSITION SHALL BE TO A SIZE EQUAL TO THE MAIN DUCT HEIGHT, AND A WIDTH AS REQUIRED TO MAINTAIN AN EQUAL OR GREATER FLOW AREA AS THE CONNECTING ROUND BRANCH DUCT.

ROUND BRANCH DUCT CONNECTIONS TO RECTANGULAR MAIN DUCT

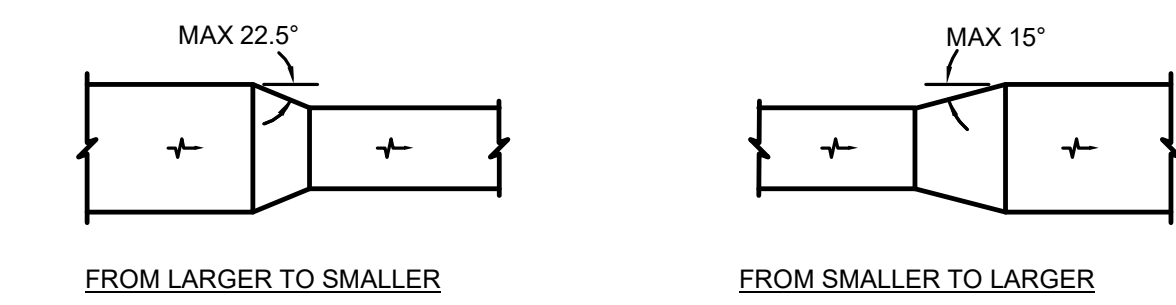

NOTE: CONCENTRIC TRANSITIONS SHOWN, HOWEVER ANGLE LIMITATIONS APPLY TO ECCENTRIC TRANSITIONS.

TRANSITIONS

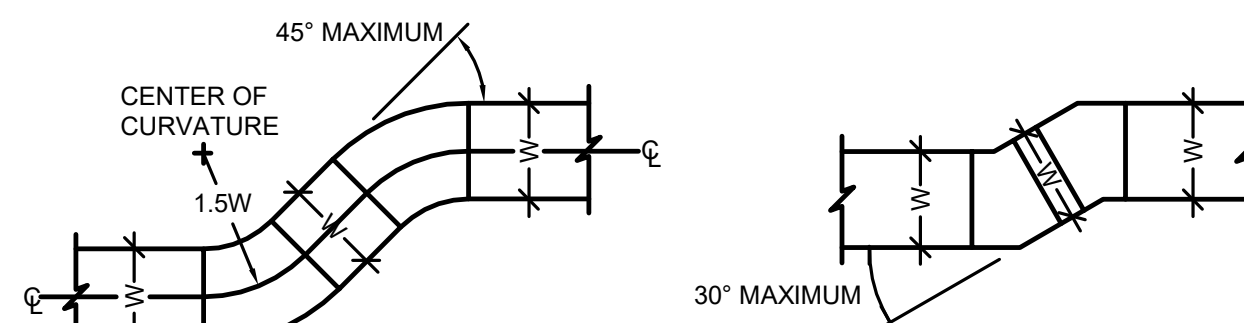


NOTE: FULL RADIUS ELBOWS WHERE POSSIBLE (CENTERLINE RADIUS = 1.5W), WHERE NECESSARY USE REDUCED RADIUS ELBOWS (CENTERLINE RADIUS = 1W)

RADIUS ELBOW OFFSETS

NOTE: MITERED ELBOWS SHALL ONLY BE USED WHERE THE OFFSET DISTANCE IS TOO SMALL FOR RADIUS ELBOWS.

MITERED ELBOW OFFSETS

OFFSETS

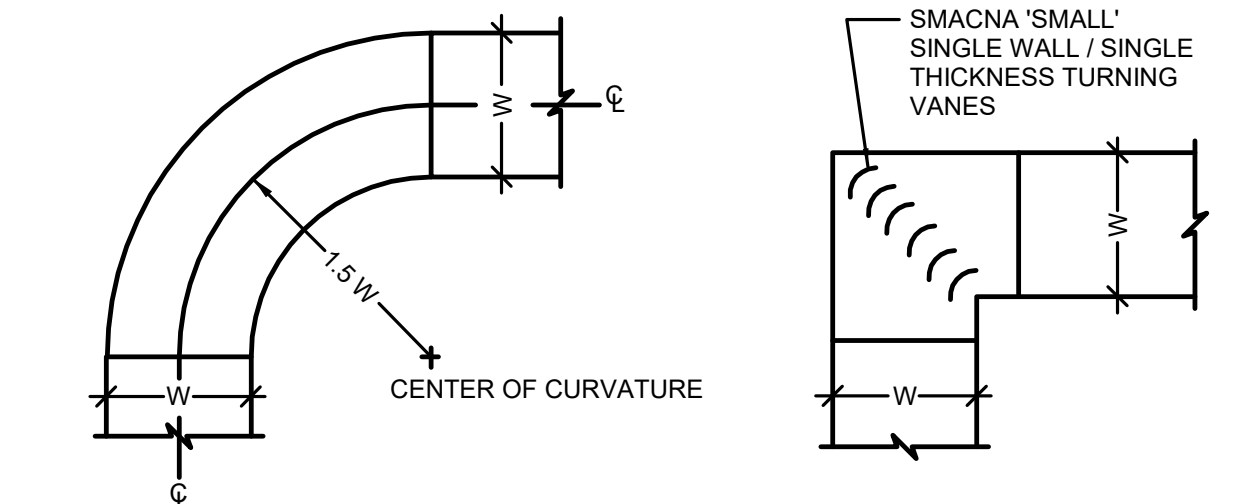


- NOTES:
1. 90° ELBOW SHOWN, HOWEVER SIMILAR RADIUS CONSTRUCTION SHALL BE PROVIDED FOR ALL ANGLES.
 2. THIS DETAIL APPLIES TO RECTANGULAR RADIUS ELLS AND TO ROUND ELBOWS WITH DIAMETERS SMALLER THAN 13" DIA. ROUND ELBOWS 13" DIA. AND LARGER SHALL BE GORED TYPE, WITH NO LESS THAN FIVE (5) SEGMENTS (FOUR 22.5 DEG. CHANGES IN DIRECTION PER 90 DEG. ELL) CENTERLINE RADIUS MAY BE REDUCED TO 1W WHERE THE FULL 1.5W RADIUS ELL DOES NOT FIT, WITH THE PRIOR APPROVAL OF THE ENGINEER.
 3. PROVIDE SPLITTER VANES WHERE INDICATED ON THE PLANS.

RADIUS ELBOWS

ELBOWS

- NOTES:
1. USE THIS DESIGN WHERE MITERED 90 ELLS ARE SHOWN ON PLANS OR IF SPACE CONDITIONS DO NOT PERMIT INSTALLATION OF FULL RADIUS 90 DEG. ELLS.
 2. PROVIDE TURNING VANES IN ALL MITERED DUCT ELBOWS, EXCEPT FOR TRANSFER DUCTS, AND GREASE EXHAUST DUCTS, AND SOLID MATERIAL-HANDLING DUCTS. VANES MAY NOT BE EXPLICITLY SHOWN ON THE PLANS FOR CLARITY PURPOSES ONLY.

MITERED 90 DEG. ELBOW - RECTANGULAR DUCT

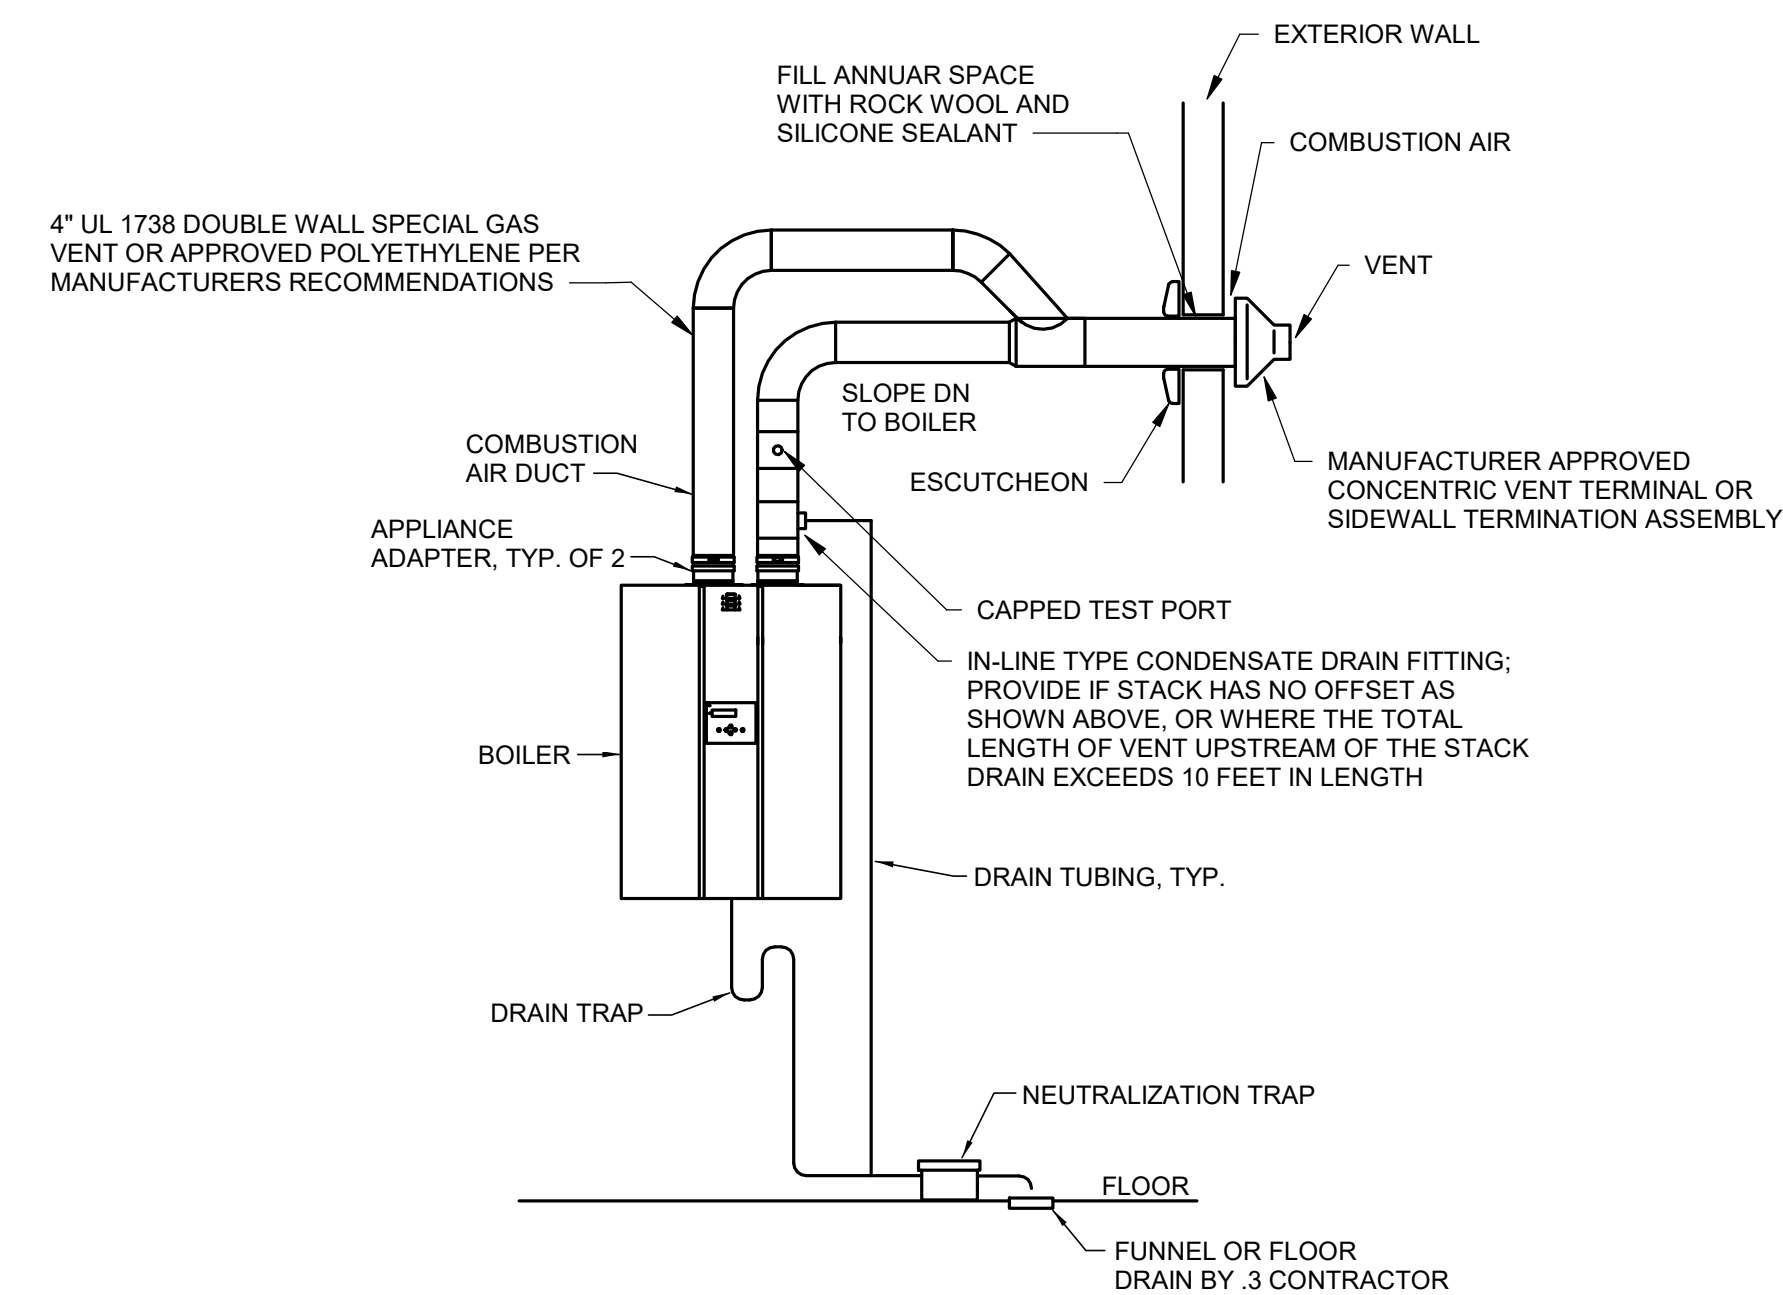


- NOTES:
1. IF THIS DETAIL CONFLICTS WITH THE APPLIANCE MANUFACTURER'S STRICT REQUIREMENTS, THEN THOSE STRICT REQUIREMENTS SHALL TAKE PRECEDENCE.
 2. VENTING MATERIAL SHALL BE AS SPECIFIED. PVC, CPVC, AND OTHER MATERIALS PERMITTED (BUT NOT REQUIRED) BY THE APPLIANCE MANUFACTURER THAT ARE NOT SPECIFIED ARE NOT PERMITTED.
 3. DRAIN TUBING SHALL BE CPVC, STAINLESS STEEL, OR ANOTHER MATERIAL ACCEPTABLE TO THE APPLIANCE MANUFACTURER. MATERIAL SHALL BE SUITABLE FOR 180 DEG F. WATER.
 4. DRAIN SIZES AND TRAP DEPTHS SHALL BE AS RECOMMENDED BY THE APPLIANCE MANUFACTURER OR VENTING SYSTEM MANUFACTURER.
 5. PROVIDE REQUIRED HORIZONTAL AND VERTICAL CLEARANCES BETWEEN COMBUSTION AIR INTAKE AND VENT OUTLET AS PER BOILER MANUFACTURER'S REQUIREMENTS.

2 BOILER CONCENTRIC VENTING DETAIL

NOT TO SCALE

1 DUCTWORK FITTING DETAILS


NOT TO SCALE

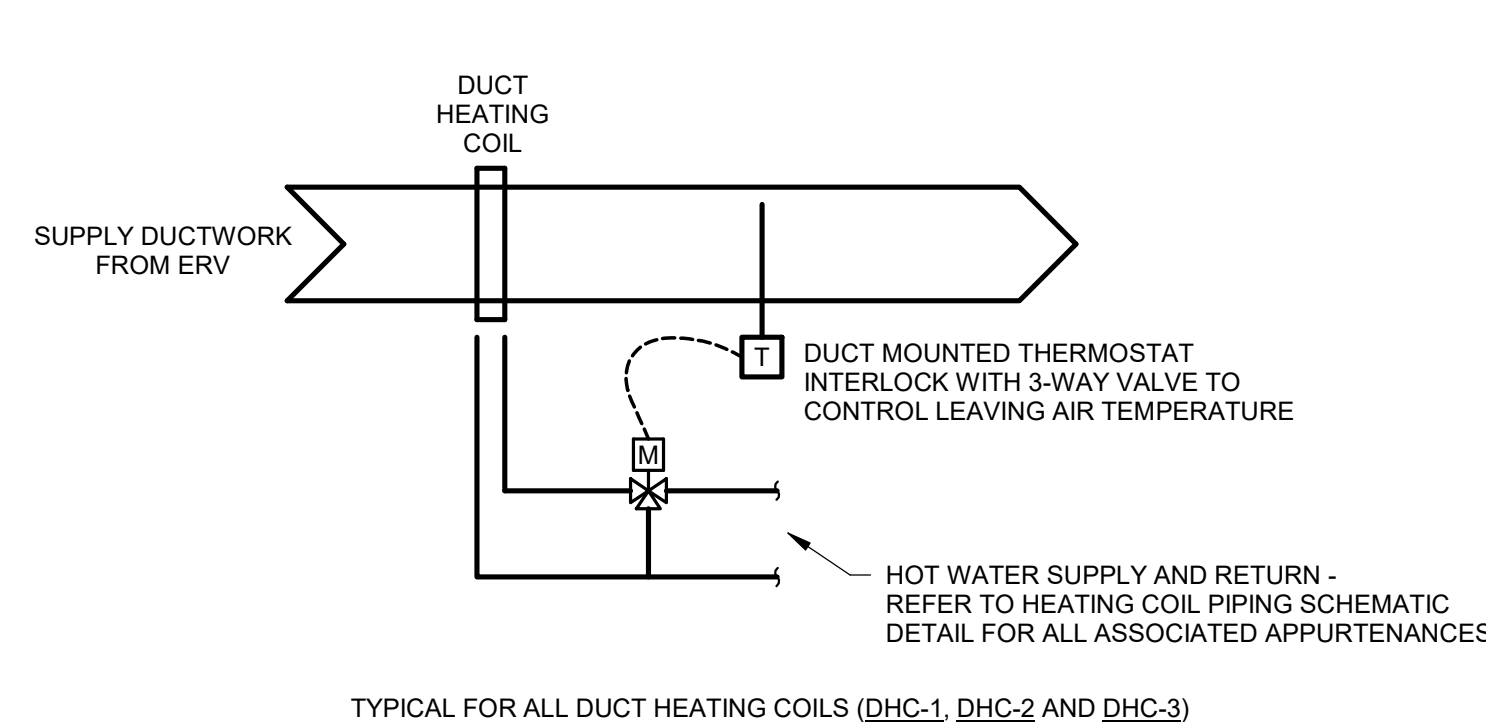

TYPICAL FOR ALL DUCT HEATING COILS (DHC-1, DHC-2 AND DHC-3)

3 DUCT HEATING COIL - CONTROL DIAGRAM


NOT TO SCALE

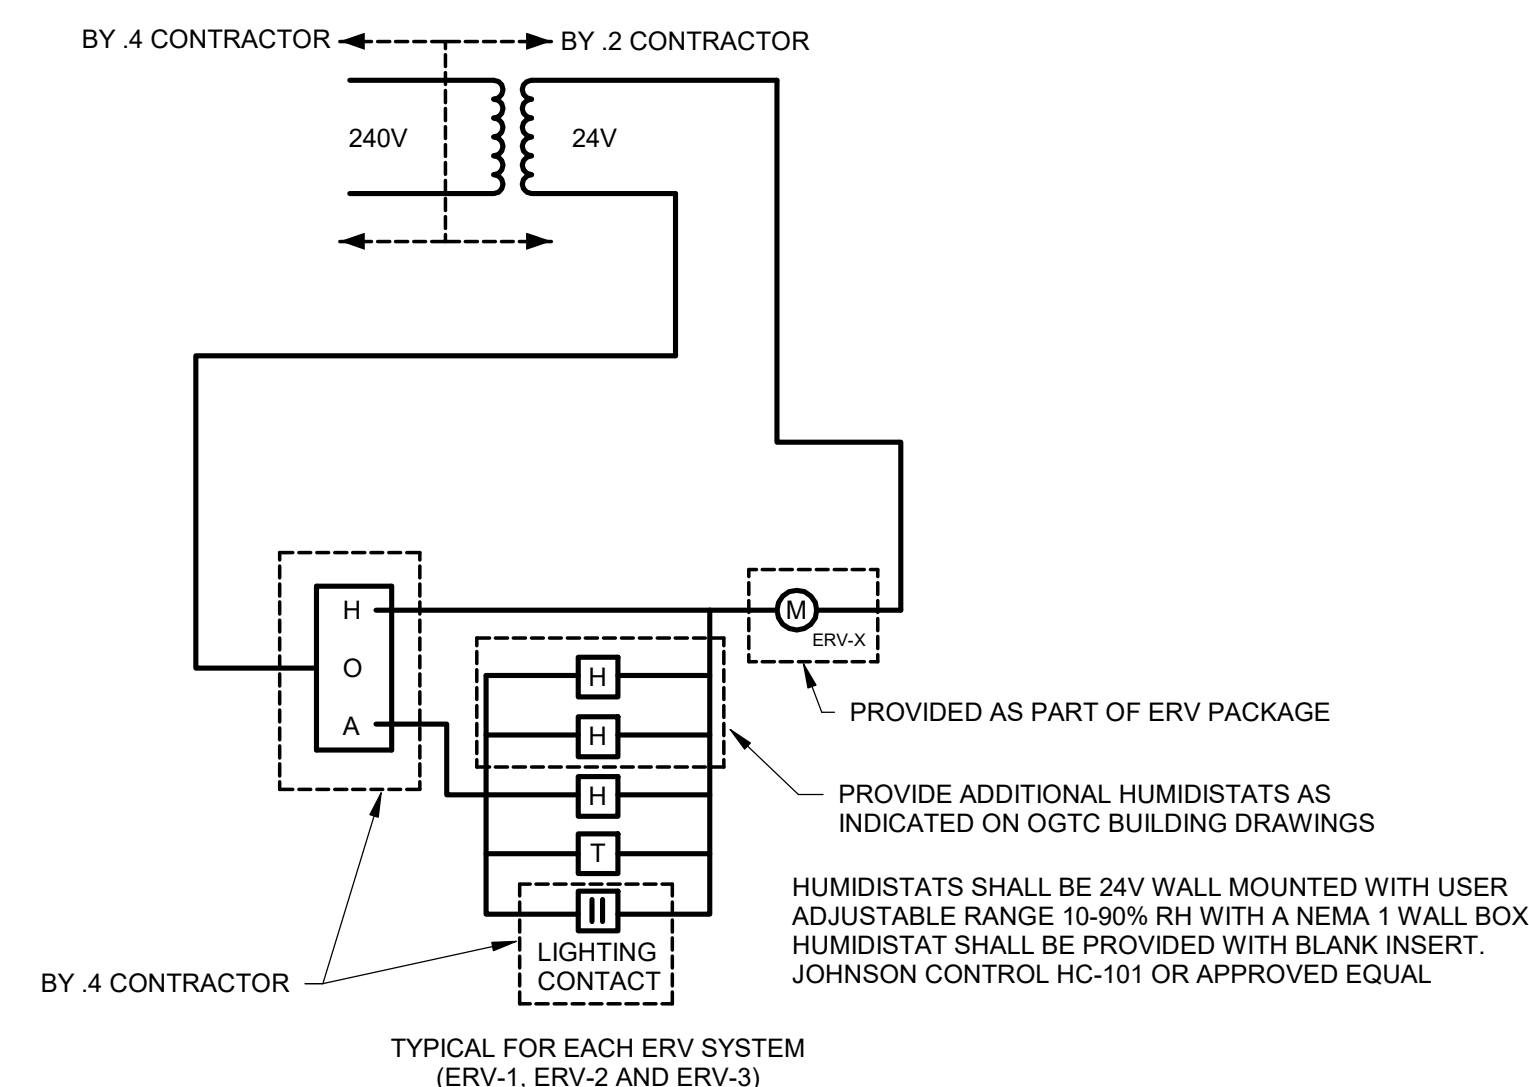

TYPICAL FOR EACH ERV SYSTEM (ERV-1, ERV-2 AND ERV-3)

4 ERV CONTROL DIAGRAM

NOT TO SCALE

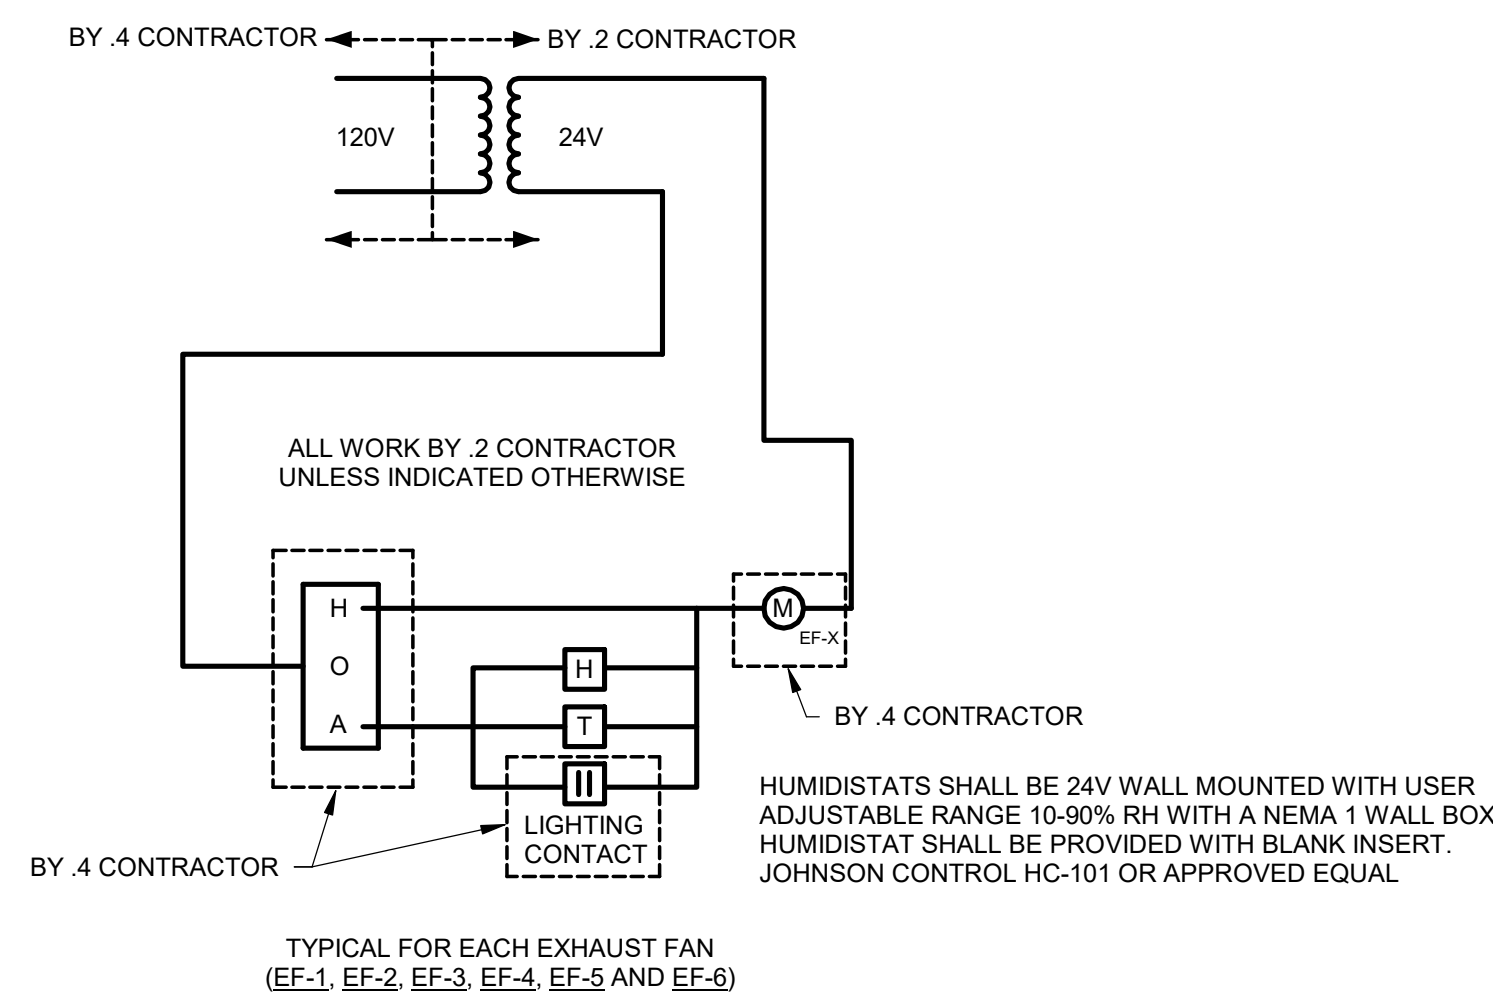


TYPICAL FOR EACH EXHAUST FAN (EF-1, EF-2, EF-3, EF-4, EF-5 AND EF-6)

5 EF CONTROL DIAGRAM

SCALE: 12" = 1'-0"

CONSTRUCTION DOCUMENTS

RECORD REVISIONS

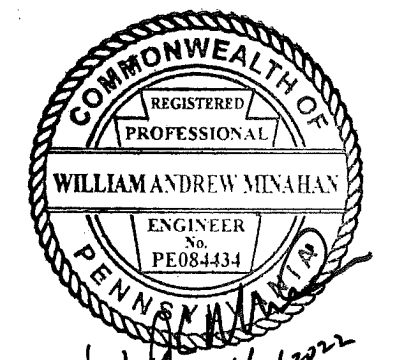

SIGNATURE DATE

SMP ARCHITECTS
1600 WALNUT STREET, SECOND FLOOR
PHILADELPHIA, PENNSYLVANIA

COMMONWEALTH OF PENNSYLVANIA
DEPARTMENT OF GENERAL SERVICES
HARRISBURG, PENNSYLVANIA

D.G.S. PROJECT No. C-114-0006 PHASE 1

HICKORY RUN STATE PARK
LATRINE IMPROVEMENTS

DEPT of CONSERVATION AND NATURAL RESOURCES
WHITE HAVEN, CARBON COUNTY, PA

MECHANICAL DETAILS

VERIFY SCALE

BAR IS ONE (1) INCH LONG
ON ORIGINAL DRAWING: 0 1
IF BAR IS NOT ONE (1) INCH LONG, ADJUST SCALE ACCORDINGLY

CONTRACTOR SHALL FIELD VERIFY ALL DIMENSIONS. VARIANCE FROM CONTRACT DOCUMENTS NOT PERMITTED WITHOUT PROFESSIONAL & BUREAU OF CONSTRUCTION APPROVAL.	DRAWN BY W MINAHAN	DATE 06/17/2022	DRAWING No. M-10
	CHECKED BY T HOVAN	SCALE AS NOTED	127 OF 144

PLUMBING LEGEND

SYMBOL	DESCRIPTION	SYMBOL	DESCRIPTION
○	WATER RISER (SIZE 5")	▬	ACCESS/PANEL BOX 18x4
○	SANITARY/WASTE OR VENT STACK (SIZE 6")	⊕	PILOT OPERATED VALVE
⌋	AUTOMATIC AIR VENT	×	PIPE ANCHOR
⊠	BACK FLOW PREVENTER	⊖	PIPE BOTTOM CONNECTION
⌋	BALANCING VALVE	⊖	PIPE DOWN
⌋	BALL VALVE LEVER	▬	PIPE GUIDE
⌋	CHECK VALVE	⊕	PRESSURE GAUGE
⊙	CIRCULATING PUMP	⊙	PRESSURE REDUCING VALVE
I	CLEANOUT IN RISER	⊠	PRESSURE SWITCH
○	CLEANOUT EXTENDED UP TO FLOOR/GRADE	⌋	RELIEF VALVE
⌋	COMBINATION HOSE BIBB	△	SHOWER HEAD
▷	CONCENTRIC REDUCER	⌋	STRAINER
⌋	DIAPHRAGM VALVE	⌋	TEMPERATURE GAUGE
⌋	DOUBLE CHECK VALVE	⌋	TEMPERATURE SWITCH
⌋	ECCENTRIC REDUCER	⊠	TRAP PRIMER
⊖	CAP OR PLUG	⊕	UNION
∞	EXPOSED MIXING VALVE	⌋ HB	HOSE BIBB
⌋	FILTER	⌋ WH	WALL HYDRANT
⊠	FLEX CONNECTION	⊕	NEW CONNECTION TO EXISTING
⊠	FLOOR DRAIN W/ OUT TRAP	⊕	INDICATES NOTE LOCATED ELSEWHERE ON DRAWING AND NOTE NUMBER
⊠	FLOOR DRAIN CORNER CONNECTION	⊕	SQUARE FOOT
⊠	FLOOR DRAIN SIDE CONNECTION	⊕	DETAIL/PLAN REFERENCE SYMBOL INDICATES DETAIL/PLAN NUMBER
▶	FLOW DIRECTION ARROW	⊕	INDICATES DRAWING No. FOR WHICH THE DETAIL/PLAN IS LOCATED.
⊖	FUNNEL DRAIN	BLW	BELOW
⌋	GAS COCK VALVE	FLR	FLOOR
⊕	GAS PRESSURE REGULATOR	ABV	ABOVE
⌋	GATE VALVE	CLG	CEILING
⌋	MOTORIZED VALVE		
⌋	GATE VALVE OS & Y		
⌋	PRESSURE REGULATOR VALVE		
⊠	SOLENOID VALVE		
⌋	HAMMER ARRESTER		
⊕	METER		

PLUMBING PIPING LEGEND


SYMBOL	DESCRIPTION
— SW —	SANITARY WASTE
- - - SV - - -	SANITARY VENT
— CW —	DOMESTIC COLD WATER
— HW —	DOMESTIC HOT WATER
— HWR —	DOMESTIC HOT WATER RETURN
— G —	LIQUID PROPANE GAS

PLUMBING GENERAL NOTES:

- THE DRAWINGS ARE DIAGRAMMATIC AND SHOW ONLY THE GENERAL ARRANGEMENTS OF PIPING AND EQUIPMENT. ALL OFFSETS, FITTINGS, AND ACCESSORIES ARE NOT SHOWN, WHICH MAY BE REQUIRED TO AVOID STRUCTURAL FEATURES.
- DO NOT SCALE DRAWINGS - ALL DIMENSIONS AND CONDITIONS SHALL BE CHECKED AND VERIFIED BY THE CONTRACTOR AT THE SITE. NOTIFY PROFESSIONAL OF ANY DEVIATIONS FROM THE DRAWINGS.
- REPORT ANY DISCREPANCIES FOUND IN THE DRAWINGS AND/OR IN THE SPECIFICATIONS DURING THE BIDDING PROCESS FOR CLARIFICATION BY THE PROFESSIONAL.
- ALL WORK THAT IS TO BE PERFORMED UNDER AND IN CONNECTION WITH THESE DRAWINGS AND SPECIFICATIONS SHALL BE IN COMPLIANCE WITH ALL PERTINENT CODES, RULES, ORDINANCES, AND REGULATIONS OF THE LOCAL GOVERNING AUTHORITIES, STATE GOVERNING AUTHORITIES AND NATIONAL GOVERNING AUTHORITIES.
- ALL WORK THAT IS TO BE PERFORMED UNDER AND IN CONNECTION WITH THESE DRAWINGS AND SPECIFICATIONS SHALL BE IN STRICT COMPLIANCE WITH THE LATEST OSHA SAFETY AND HEALTH STANDARDS.
- THE .3 CONTRACTOR SHALL BE RESPONSIBLE FOR COORDINATION WITH THE .1 CONTRACTOR AND UTILITY AUTHORITIES FOR INSTALLATION REQUIREMENTS, REGULATIONS, FEES, PERMITS AND APPROVALS AS NECESSARY TO COMPLETE THE UTILITY INSTALLATION.
- THE CONTRACTOR SHALL FURNISH LAYOUT DRAWINGS OF ANY RELOCATED PIPING, EQUIPMENT, ETC., FOR APPROVAL PRIOR TO RELOCATION OF ITEM.
- ALL PIPE PENETRATIONS THROUGH CHASE, WALLS OR FLOORS WHICH ARE FIRE-RATED, SHALL BE PROPERLY SEALED TO MAINTAIN FIRE PROTECTION. CONTRACTOR SHALL SUBMIT PROPOSED UL LISTED SYSTEM FOR APPROVAL.
- ALL WORK TO BE LOCATED AND COORDINATED WITH ARCHITECTURAL DRAWINGS, SPECIFICATIONS AND OTHER CONTRACTORS.
- ALL WORK IN FINISHED AREAS SHALL BE CONCEALED ABOVE CEILINGS, BELOW FLOORS AND IN WALLS.
- THE REMOVAL AND CLEANUP OF ALL DEBRIS ASSOCIATED WITH WORK THAT IS TO BE PERFORMED BY THE .3 CONTRACTOR SHALL BE THE RESPONSIBILITY OF THE PLUMBING CONTRACTOR.
- THE CONTRACTOR SHALL COORDINATE THE LOCATION OF PLUMBING PIPING AND EQUIPMENT WITH ALL HVAC PIPING, DUCTWORK, HVAC EQUIPMENT, ELECTRICAL CONDUIT AND ELECTRICAL EQUIPMENT THAT IS TO BE INSTALLED BY OTHER CONTRACTORS.
- WHERE THE SPACE ABOVE CEILINGS IN THE BUILDING IS DESIGNATED AS A RETURN AIR PLENUM, ALL EQUIPMENT, PIPING VALVES, FITTINGS, ETC IN THIS SPACE SHALL BE RATED AND APPROVED FOR THIS APPLICATION.
- THE .3 CONTRACTOR SHALL LOCATE UNDERGROUND PIPING WITHIN LIMITS OF THE STRUCTURE IN COORDINATION WITH THE GENERAL CONTRACTOR, TO ASSURE NO FOOTING WILL BE UNDERMINED BY TRENCHING. ANY PIPING TRENCH SHALL BE LOCATED SO THE TRENCH EDGE IS NOT CLOSER TO ANY STRUCTURAL FOOTING THAN 1 1/2 TIMES THE VERTICAL DISTANCE FROM TRENCH BOTTOM TO FOOTING BOTTOM. IN ANY EVENT THIS CONDITION IS NOT MET, IT SHALL BE THE RESPONSIBILITY OF THE CONTRACTOR INSTALLING THE PIPING TO FILL THE TRENCH WITH LEAN CONCRETE. AFTER PIPING IS INSTALLED, TO AN ELEVATION WHERE THE SURFACE OF THE CONCRETE SHALL BE NOT CLOSER TO ANY FOOTING THAN TWICE THE VERTICAL DISTANCE BETWEEN FOOTING BOTTOM AND THE CLOSEST EDGES OF THE CONCRETE POURED IN THE TRENCH.
- WHERE EXCAVATIONS FOR PIPING EXTEND UNDER AND PERPENDICULAR TO A WALL FOOTING, THE CONTRACTOR INSTALLING THE PIPING SHALL FILL THE TRENCH WITH CONCRETE SOLIDLY TO BOTTOM OF FOOTING FOR A TRENCH LENGTH OF 3'-0" BEYOND EACH WALL FACE.
- ALL WATER LINES IN EXTERIOR WALLS SHALL BE INSULATED AND LOCATED WITHIN THE INSULATION ENVELOPE OF THE BUILDINGS EXTERIOR WALL.
- INSTALL WALL HYDRANTS AT A MINIMUM OF 2'-0" ABOVE FINISHED GRADE, UNLESS OTHERWISE INDICATED.
- SET ALL FLOOR AND FUNNEL DRAINS OVER P-TRAPS, UNLESS SPECIFIED OTHERWISE.
- PROVIDE SHUT-OFF COCK AT EACH CONNECTION TO GAS EQUIPMENT.
- PROVIDE DIRT LEG AT BOTTOM OF ALL VERTICAL RISERS AND DROPS IN GAS LINES.
- THE .3 CONTRACTOR SHALL REFER TO APPLICABLE CODES FOR ACCEPTABLE DRAINAGE SYSTEM FITTINGS.
- DIELECTRIC UNIONS AND FLANGES SHALL BE USED ON ALL CONNECTIONS BETWEEN DISSIMILAR METALS.
- ALL HORIZONTAL PIPING ABOVE CEILING, AT CEILING OR BELOW FLOOR SHALL BE INSTALLED (AS HIGH AS POSSIBLE) TIGHT TO UNDERSIDE OF SLAB/STRUCTURE WITH SPACE FOR INSULATION AND HANGERS AS REQUIRED, UNLESS LINES ARE RUN BELOW SLAB ON GRADE.
- MEANS OF ACCESS SHALL BE PROVIDED TO CONCEALED TRAPS, VALVES, CLEANOUTS, DRAIN POINTS OR SIMILAR ITEMS. CONTRACTORS SHALL COORDINATE THE LOCATIONS AND QUANTITIES OF ALL ACCESS PANELS DURING BIDDING PHASE. ACCESS PANELS WILL BE FURNISHED AND INSTALLED BY OTHERS.
- PROVIDE CLEANOUTS IN ALL GRAVITY DRAINAGE PIPING SYSTEMS AT ENDS OF RUNS, AT CHANGES IN DIRECTION, AT BASE OF STACKS AND AT 50 FOOT INTERVALS IN HORIZONTAL PIPING RUNS.
- EXTEND ALL CLEANOUTS ON GRAVITY DRAINAGE PIPING SYSTEMS INSTALLED BELOW SLAB ON GRADE TO FINISHED FLOOR LEVEL.
- ALL INTERIOR, HORIZONTAL SANITARY SEWER PIPING SYSTEMS, 4" AND LARGER, SHALL BE SLOPED AT A MINIMUM OF 1/8" PER FOOT, UNLESS NOTED OTHERWISE. ALL INTERIOR, HORIZONTAL SANITARY SEWER PIPING SYSTEMS, 3" AND SMALLER, SHALL BE SLOPED AT A MINIMUM OF 1/4" PER FOOT, UNLESS NOTED OTHERWISE.

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D.G.S. PROJECT No.
C-114-0006 PHASE 1

HICKORY RUN STATE PARK
LATRINE IMPROVEMENTS

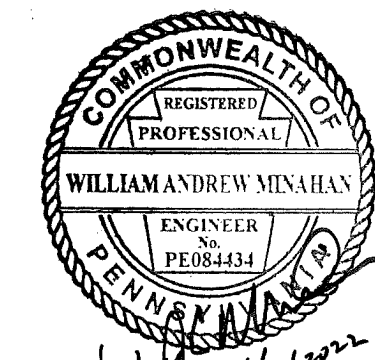DEPT of CONSERVATION AND NATURAL RESOURCES
WHITE HAVEN, CARBON COUNTY, PA

SYMBOLS, ABBREVIATIONS AND GENERAL NOTES


VERIFY SCALE

BAR IS ONE (1) INCH LONG
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0 ██████████ 1
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CHECKED BY W MINAHAN	SCALE AS NOTED	129 OF 144	


PLUMBING KEYNOTES

- 1 FOR CONTINUATION OF PIPING - REFER TO SITE UTILITY PLAN
- 2 REFER TO SITE UTILITY PLAN FOR LP GAS STORAGE TANK LOCATION. ALL LP GAS PIPING, TANK AND ASSOCIATED EQUIPMENT BY .3 CONTRACTOR. REFER TO LP GAS STORAGE TANK DETAIL ON DRAWING P-6.
- 3 PROVIDE 3/4" MAKE-UP WATER WITH BALL VALVE, STRAINER AND RPZ BACKFLOW PREVENTER TO HB-2.
- 4 PROVIDE 1" COLD WATER PIPING DOWN IN CHASE. RUN 1" COLD WATER PIPING HEADER BELOW COUNTER ABOVE FLOOD RIM OF HIGHEST MOUNTED FIXTURE. PROVIDE 1/2" COLD WATER PIPING TO (L-1) LAVATORY.
- 5 PROVIDE 1" HOT WATER PIPING DOWN IN CHASE. RUN 1" HOT WATER PIPING HEADER BELOW COUNTER ABOVE FLOOD RIM OF HIGHEST MOUNTED FIXTURE. PROVIDE 1/2" HOT WATER PIPING TO (L-1) LAVATORY AND 3/4" HOT WATER PIPING TO (HB-1) HOSE BIBB. CONTINUE HEADER TO HOT WATER RETURN.
- 6 PROVIDE 3/4" HOT WATER RETURN UP IN WALL/CHASE.
- 7 PROVIDE 2" COLD WATER PIPING DOWN IN CHASE. RUN A 2" COLD WATER HEADER ABOVE THE FLOOD RIM OF HIGHEST MOUNTED FIXTURE. PROVIDE 1" COLD WATER TO (W-1 & W-2) WATER CLOSET. PROVIDE WATER HAMMER ARRESTER SIZE "C" ON HEADER.
- 8 PROVIDE 1 1/2" COLD WATER PIPING DOWN IN CHASE. RUN A 1 1/2" COLD WATER HEADER ABOVE THE FLOOD RIM OF HIGHEST MOUNTED FIXTURE. PROVIDE 3/4" COLD WATER TO (U-1 & U-2) URINAL. PROVIDE WATER HAMMER ARRESTER SIZE "B" ON HEADER.
- 9 DOMESTIC WATER HEATER EXHAUST. .3 CONTRACTOR TO COORDINATE LOCATION WITH .1 CONTRACTOR. REFER TO DOMESTIC WATER HEATER DETAIL ON DRAWING P-6.
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- 11 PROVIDE GAS COCK SHUT-OFF AND SECONDARY STAGE REGULATOR ALONG WALL IN VERTICAL. 11" W.C. OUTLET PRESSURE. 0.5 PSIG PRESSURE DROP. FOR MORE INFORMATION REFER TO SPECIFICATIONS.
- 12 PROVIDE VENT HEADER IN CHASE. RUN HEADER ABOVE FLOOD RIM OF THE HIGHEST MOUNTED FIXTURE.
- 13 PROVIDE TOP CONNECT VENT. PROVIDE VENT PIPING BELOW SLAB ON GRADE SLOPING VENT PIPING UPWARDS AT 1/8" PER FOOT TO WALL.

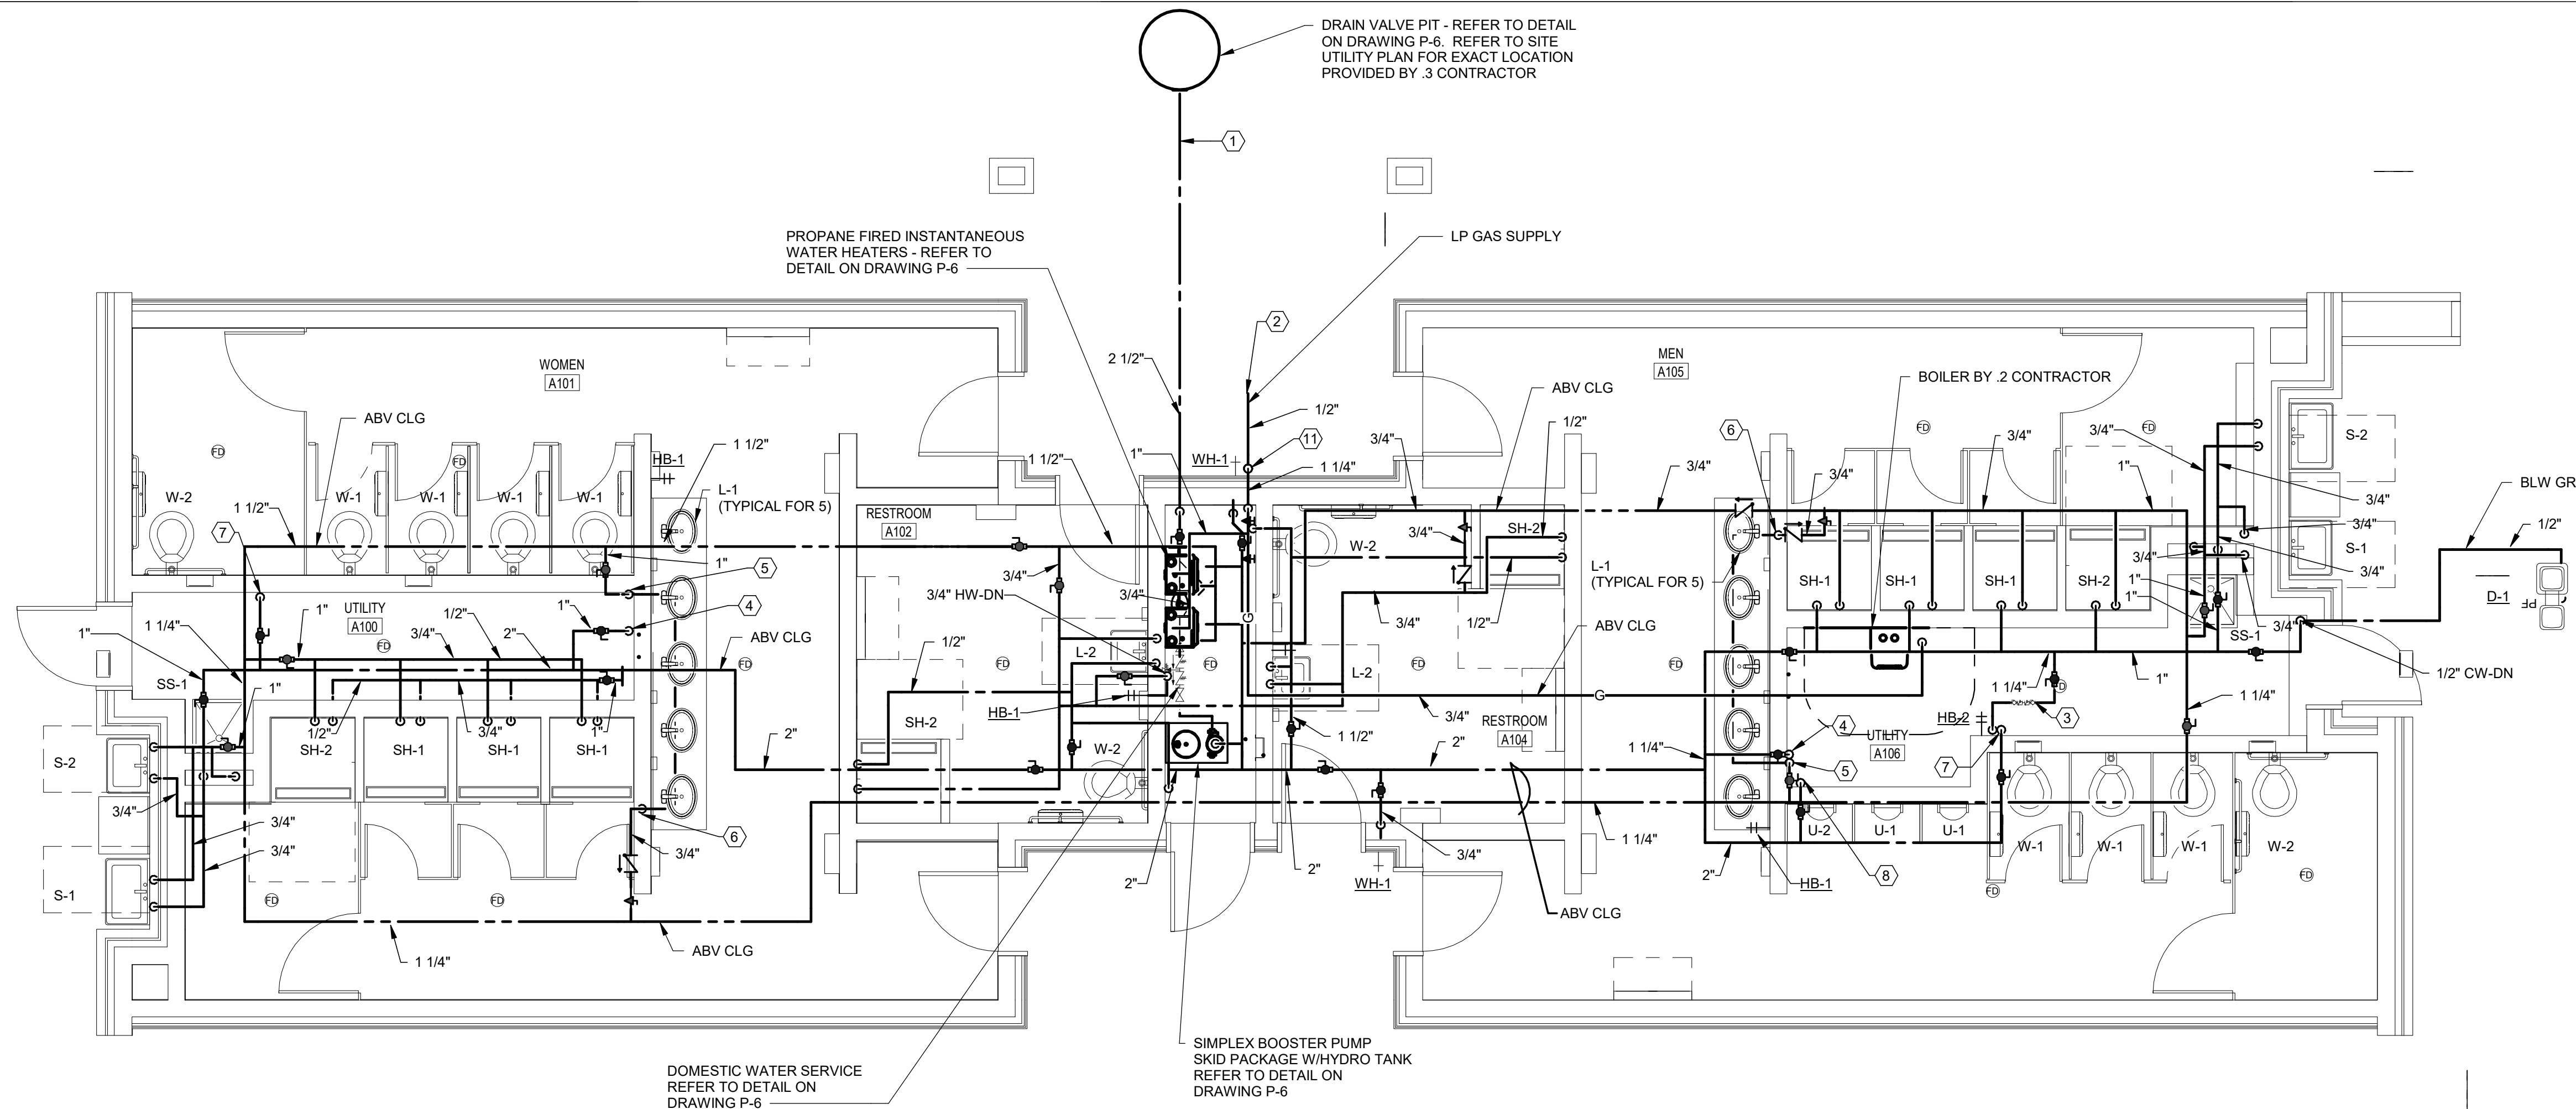

- NOTES:**
1. BUILDING TO BE DRAINED DOWN FOR WINTER. SLOPE ALL DOMESTIC WATER PIPING TOWARD FIXTURES AND DRAIN DOWN VALVE. PROVIDE HOSE END DRAIN VALVE AT LOW POINTS FOR WINTER DRAIN DOWN.
 2. VALVES TO BE LOCATED IN OR NEAR CHASES. IF VALVES ARE NOT LOCATED IN CHASE, THEY SHOULD BE LOCATED AS CLOSE AS POSSIBLE TO CHASE FOR ACCESS. LOCATIONS SHOWN ARE FOR DIAGRAMMATIC PURPOSES. VALVES THAT CANNOT BE LOCATED IN OR NEAR CHASE WILL REQUIRE MEANS OF ACCESS.
 3. WATER PIPING TO BE ZONED. UNISEX RESTROOMS A102 & A104 AND UTILITY CHASE BETWEEN TO BE OPENED 365 DAYS. WOMENS A101 AND MENS A105 TO BE OPENED SEASONAL.


1 LOOP-C - DOMESTIC WATER AND LP GAS - PLUMBING
SCALE: 1/4" = 1'-0"

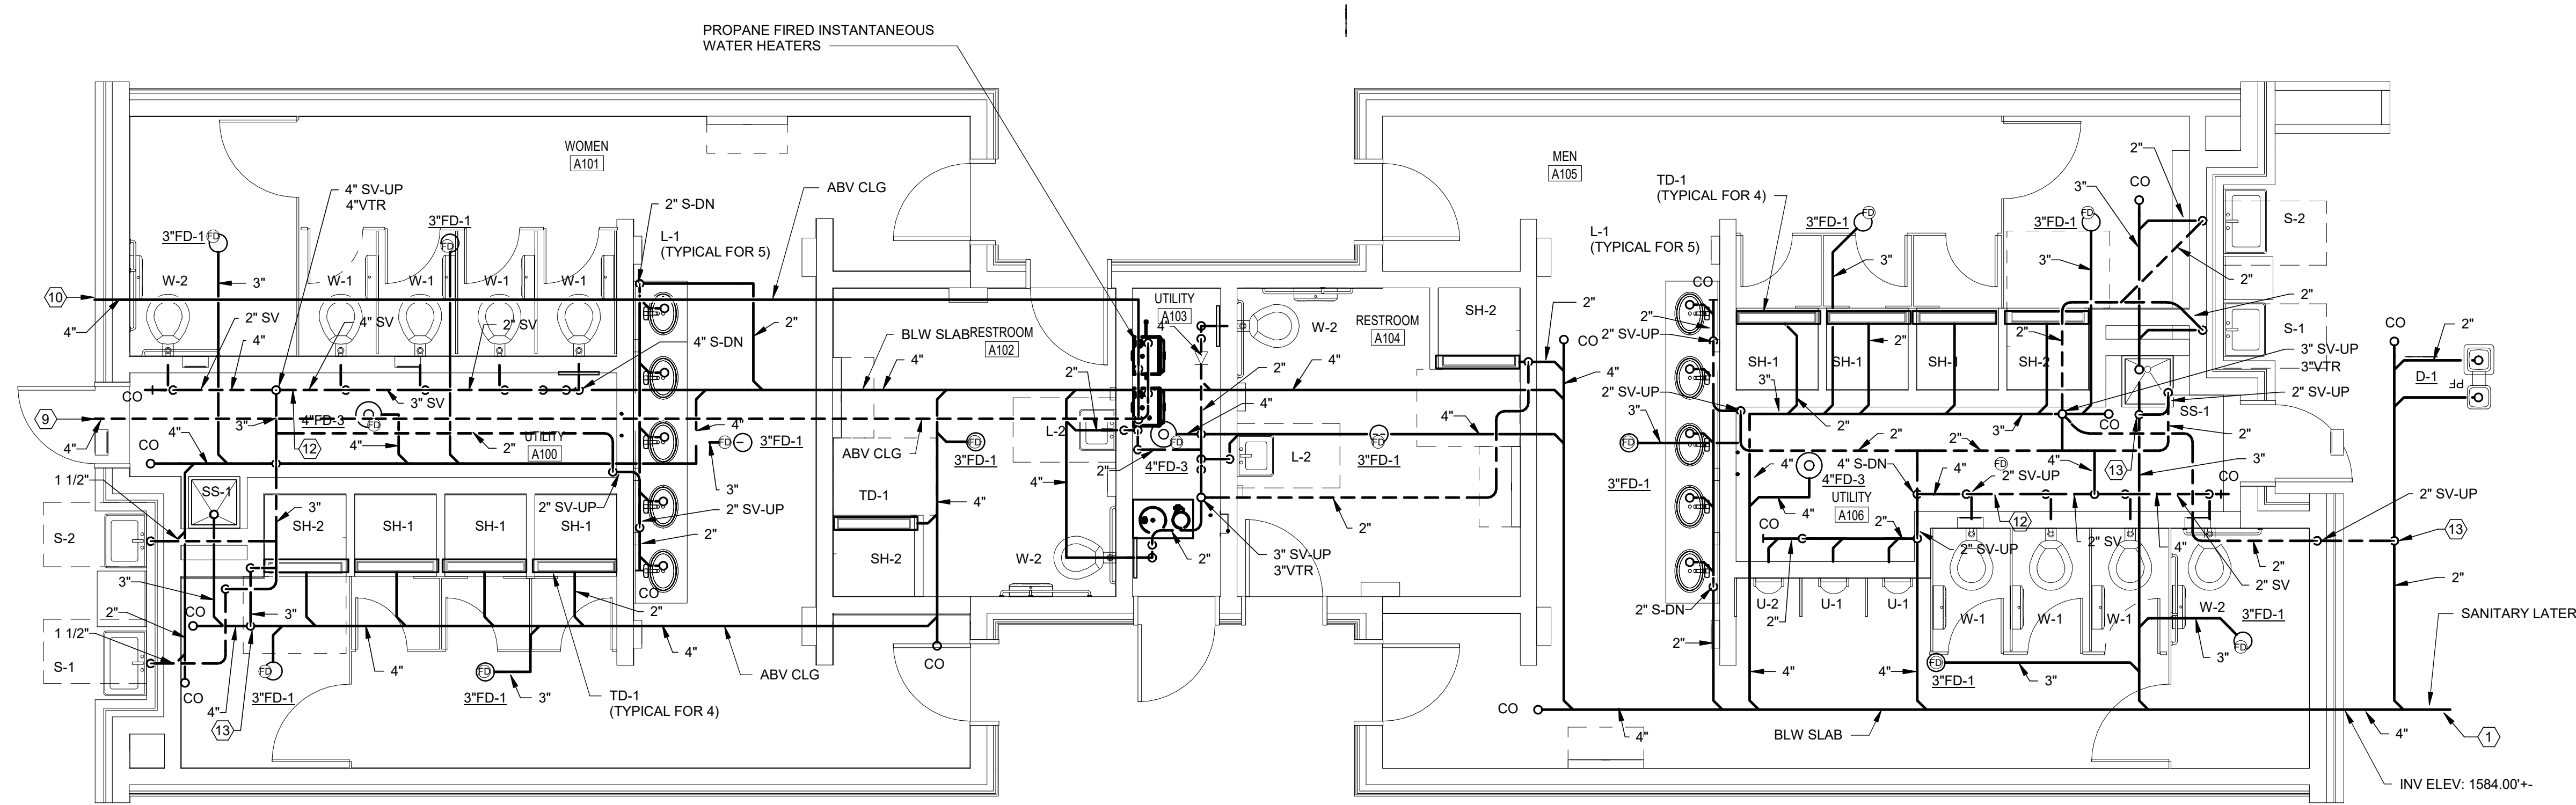

2 LOOP-C - SANITARY AND VENT - PLUMBING
SCALE: 1/4" = 1'-0"

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D.G.S. PROJECT No. C-114-0006 PHASE 1

HICKORY RUN STATE PARK
LATRINE IMPROVEMENTS
DEPT of CONSERVATION AND NATURAL RESOURCES
WHITE HAVEN, CARBON COUNTY, PA

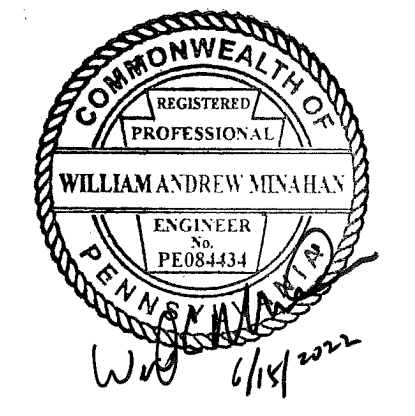LOOP - C FLOOR PLAN - PLUMBING

VERIFY SCALE

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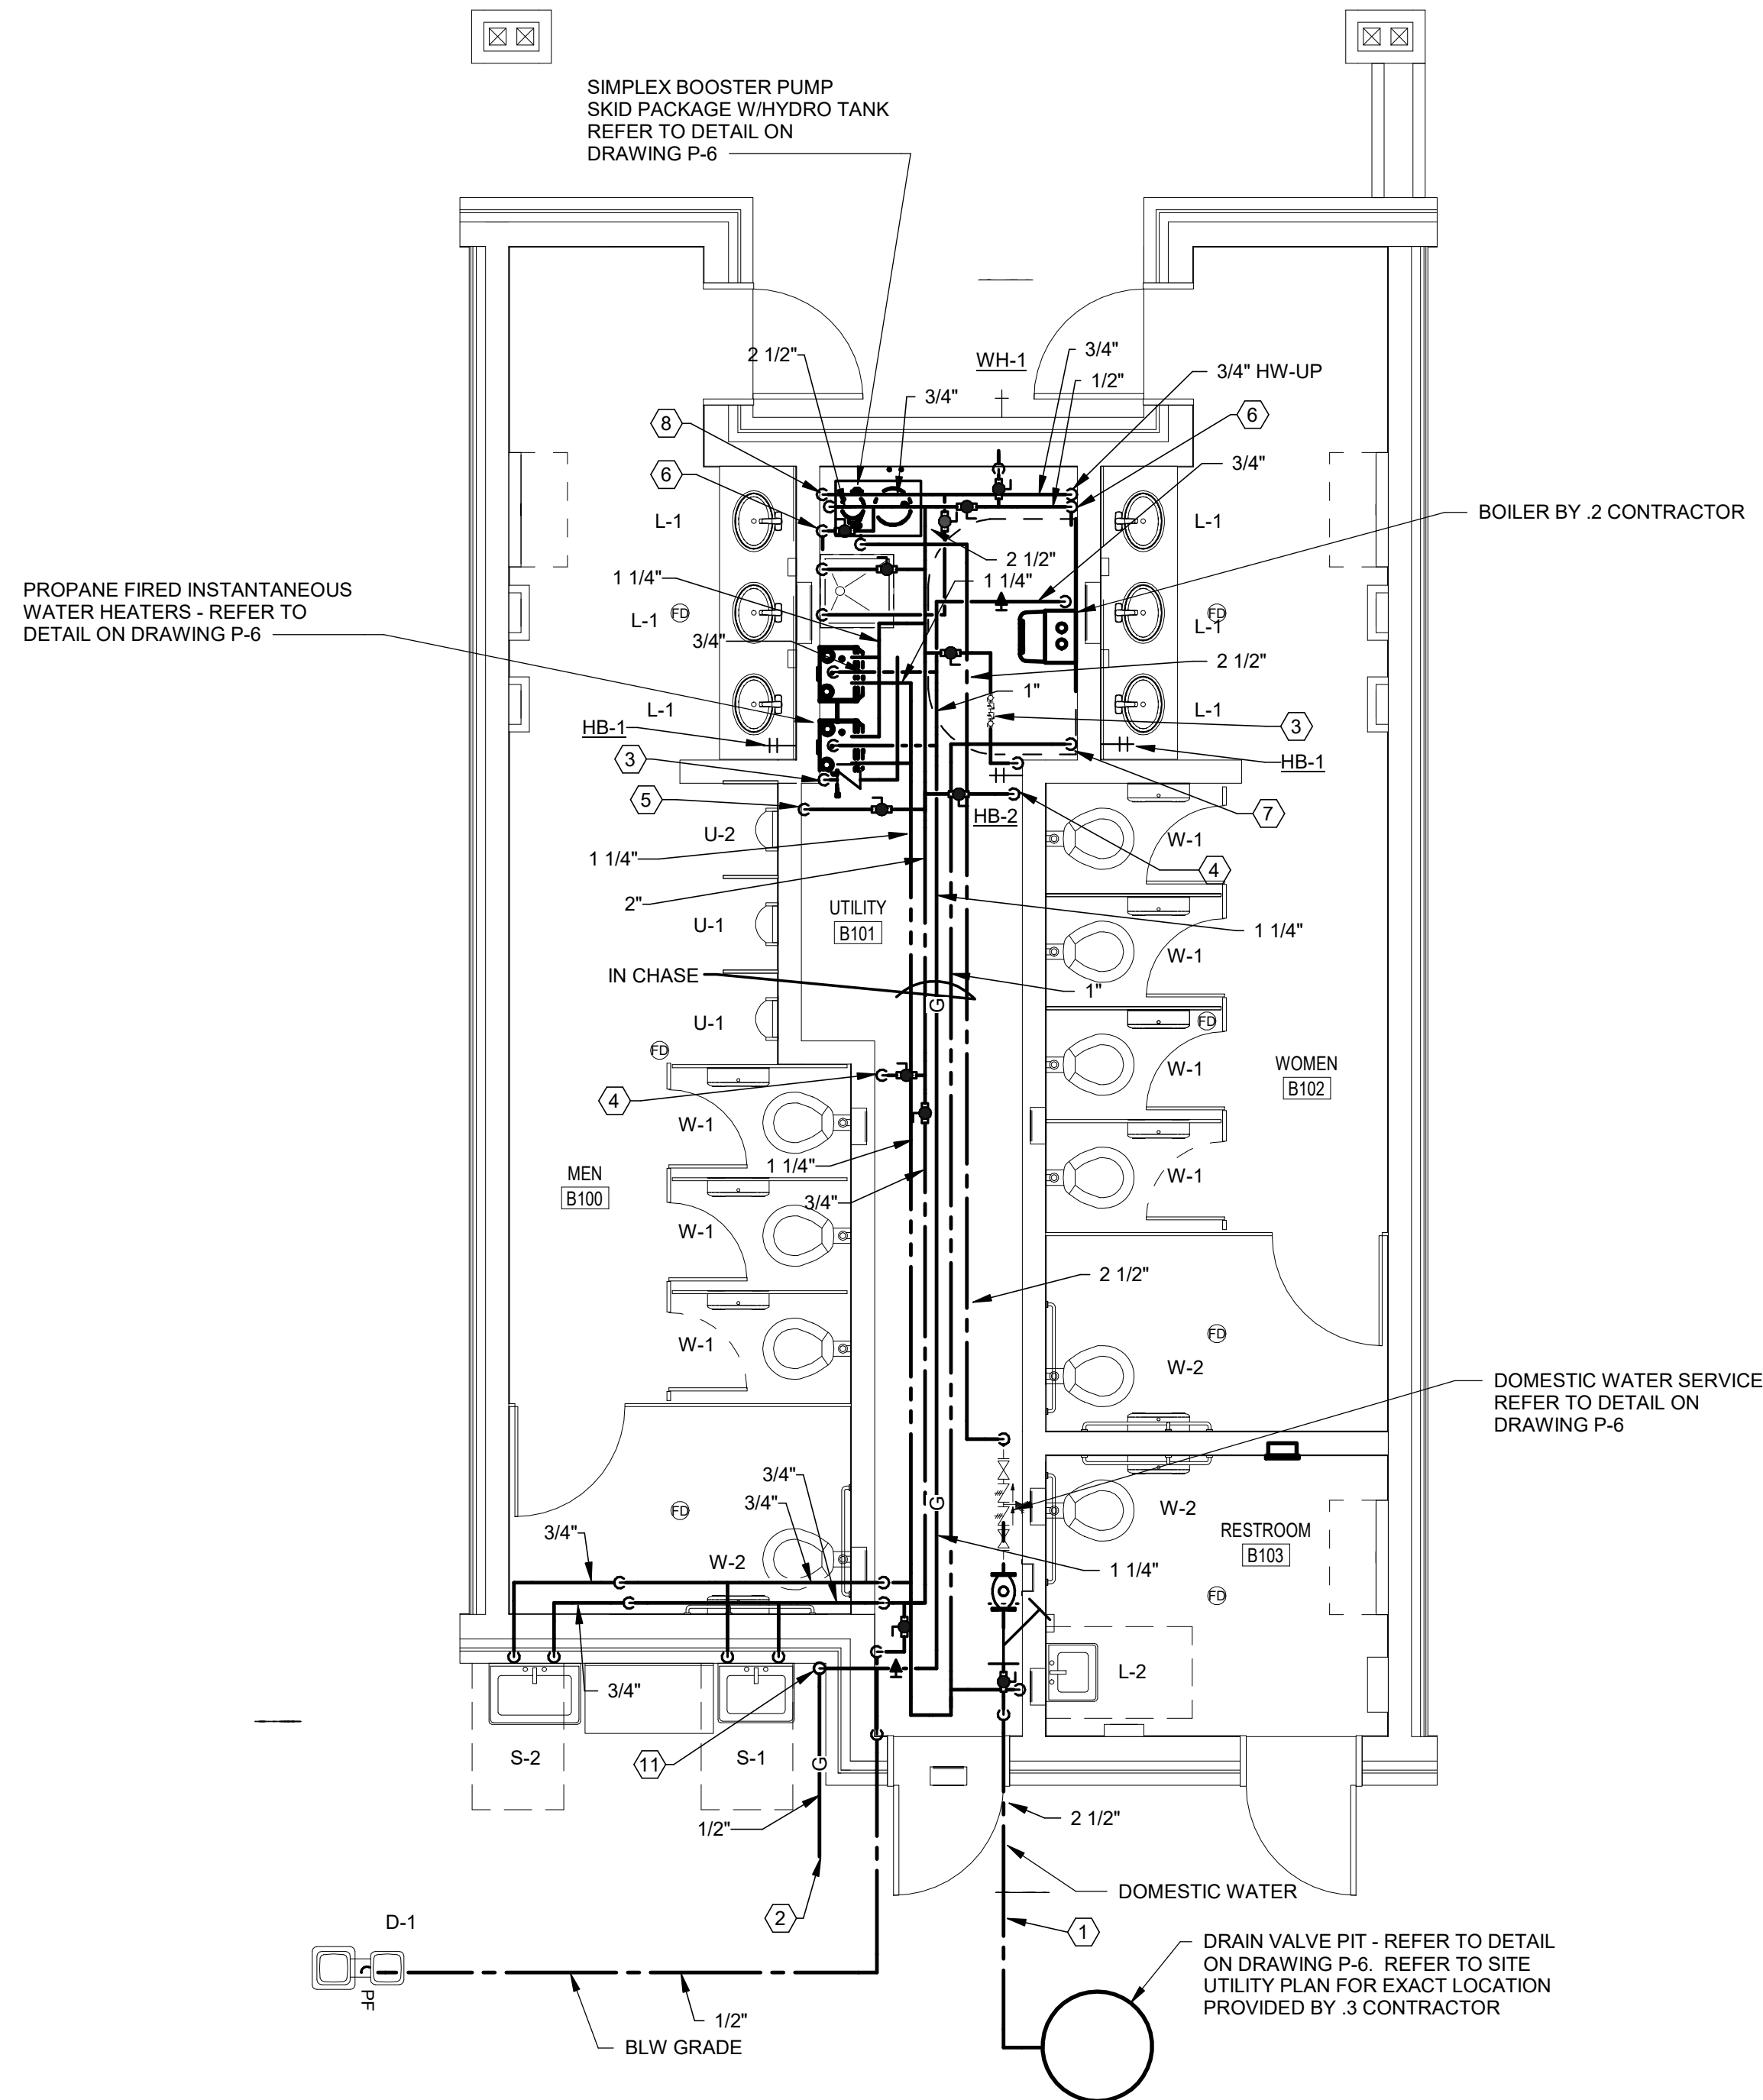
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	CHECKED BY W MINAHAN	SCALE AS NOTED	130 OF 144


PLUMBING KEYNOTES

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- 3 PROVIDE 3/4" HOT WATER RETURN UP IN WALL/CHASE.
- 4 PROVIDE 2" COLD WATER PIPING DOWN IN CHASE. RUN A 2" COLD WATER HEADER ABOVE THE FLOOD RIM OF HIGHEST MOUNTED FIXTURE. PROVIDE 1" COLD WATER TO (W-1 & W-2) WATER CLOSET. PROVIDE WATER HAMMER ARRESTER SIZE "C" ON HEADER.
- 5 PROVIDE 1 1/2" COLD WATER PIPING DOWN IN CHASE. RUN A 1 1/2" COLD WATER HEADER ABOVE THE FLOOD RIM OF HIGHEST MOUNTED FIXTURE. PROVIDE 3/4" COLD WATER TO (U-1 & U-2) URINAL. PROVIDE WATER HAMMER ARRESTER SIZE "B" ON HEADER.
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- 13 PROVIDE TOP CONNECT VENT. PROVIDE VENT PIPING BELOW SLAB ON GRADE SLOPING VENT PIPING UPWARDS AT 1/8" PER FOOT TO WALL.

NOTE:
BUILDING TO BE DRAINED DOWN FOR WINTER. SLOPE ALL DOMESTIC WATER PIPING TOWARD FIXTURES AND DRAIN DOWN VALVE. PROVIDE HOSE END DRAIN VALVE AT LOW POINTS FOR WINTER DRAIN DOWN.




1 OGTC - DOMESTIC WATER AND LP GAS - PLUMBING
SCALE: 1/4" = 1'-0"

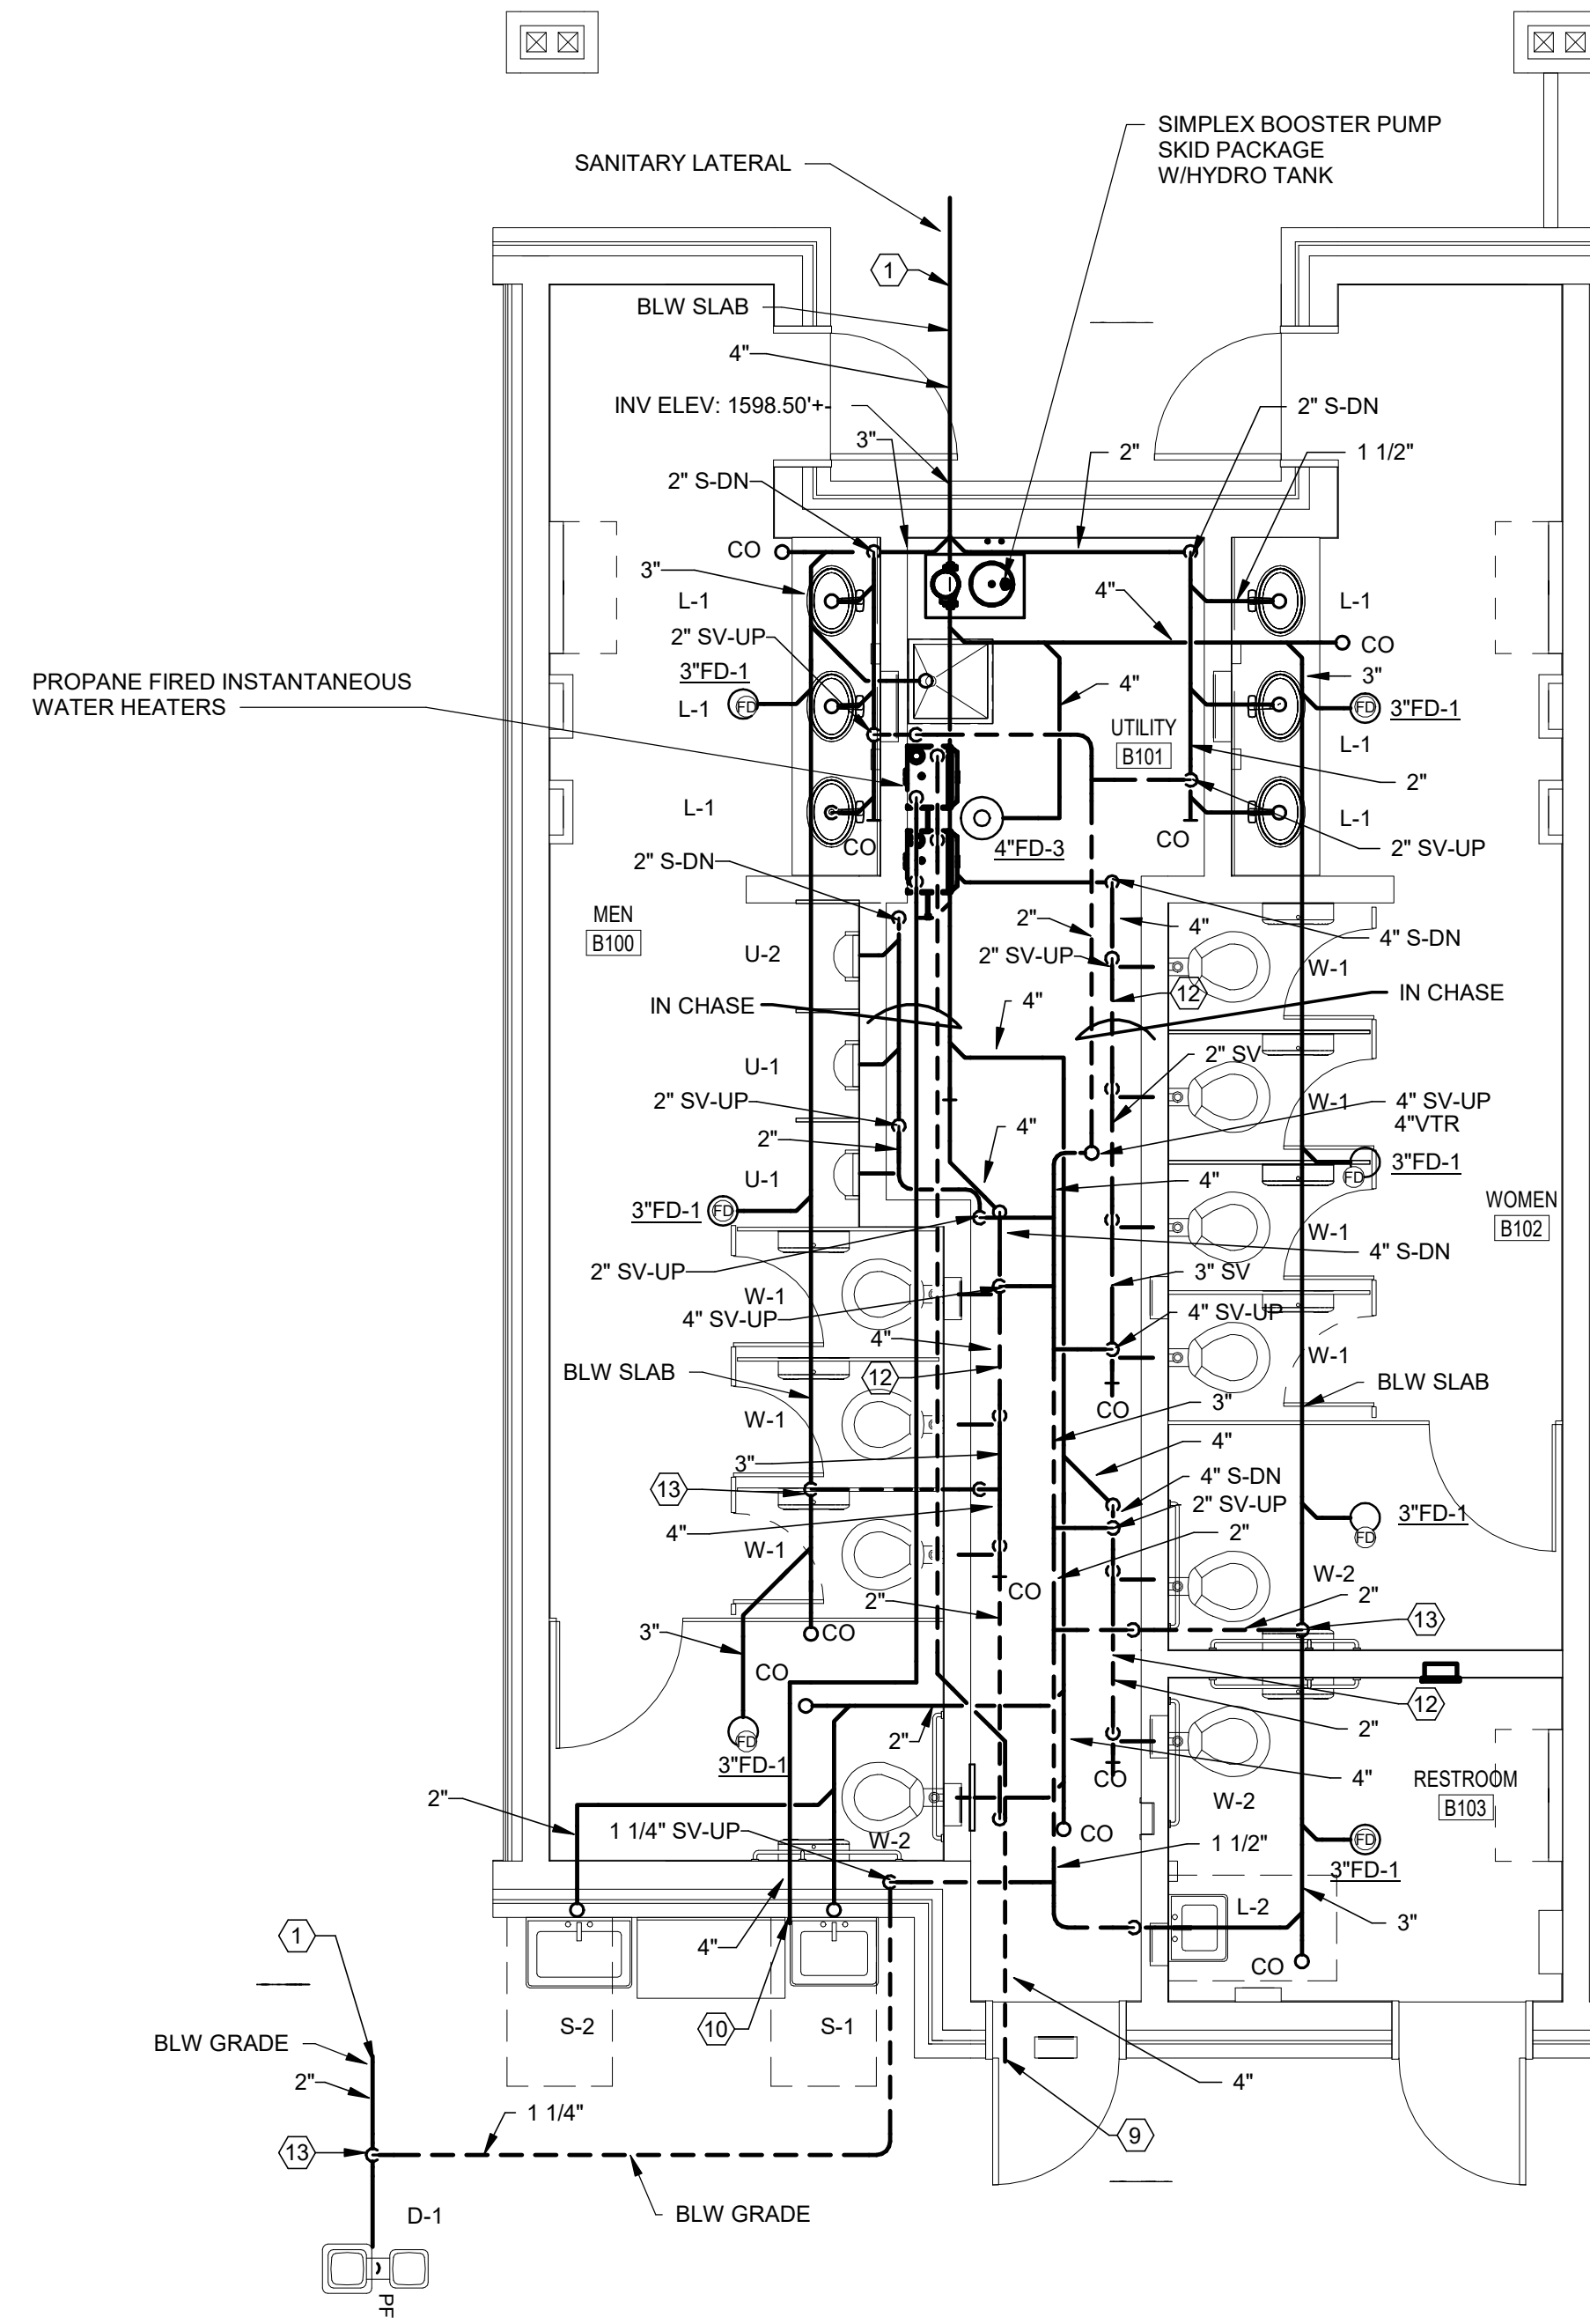

2 OGTC - SANITARY AND VENT - PLUMBING
SCALE: 1/4" = 1'-0"

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COMMONWEALTH OF PENNSYLVANIA
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D.G.S. PROJECT No.
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HICKORY RUN STATE PARK
LATRINE IMPROVEMENTS

DEPT of CONSERVATION AND NATURAL RESOURCES
WHITE HAVEN, CARBON COUNTY, PA

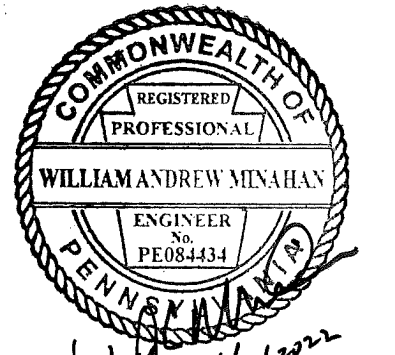OGTC FLOOR PLAN - PLUMBING

VERIFY SCALE

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0 1

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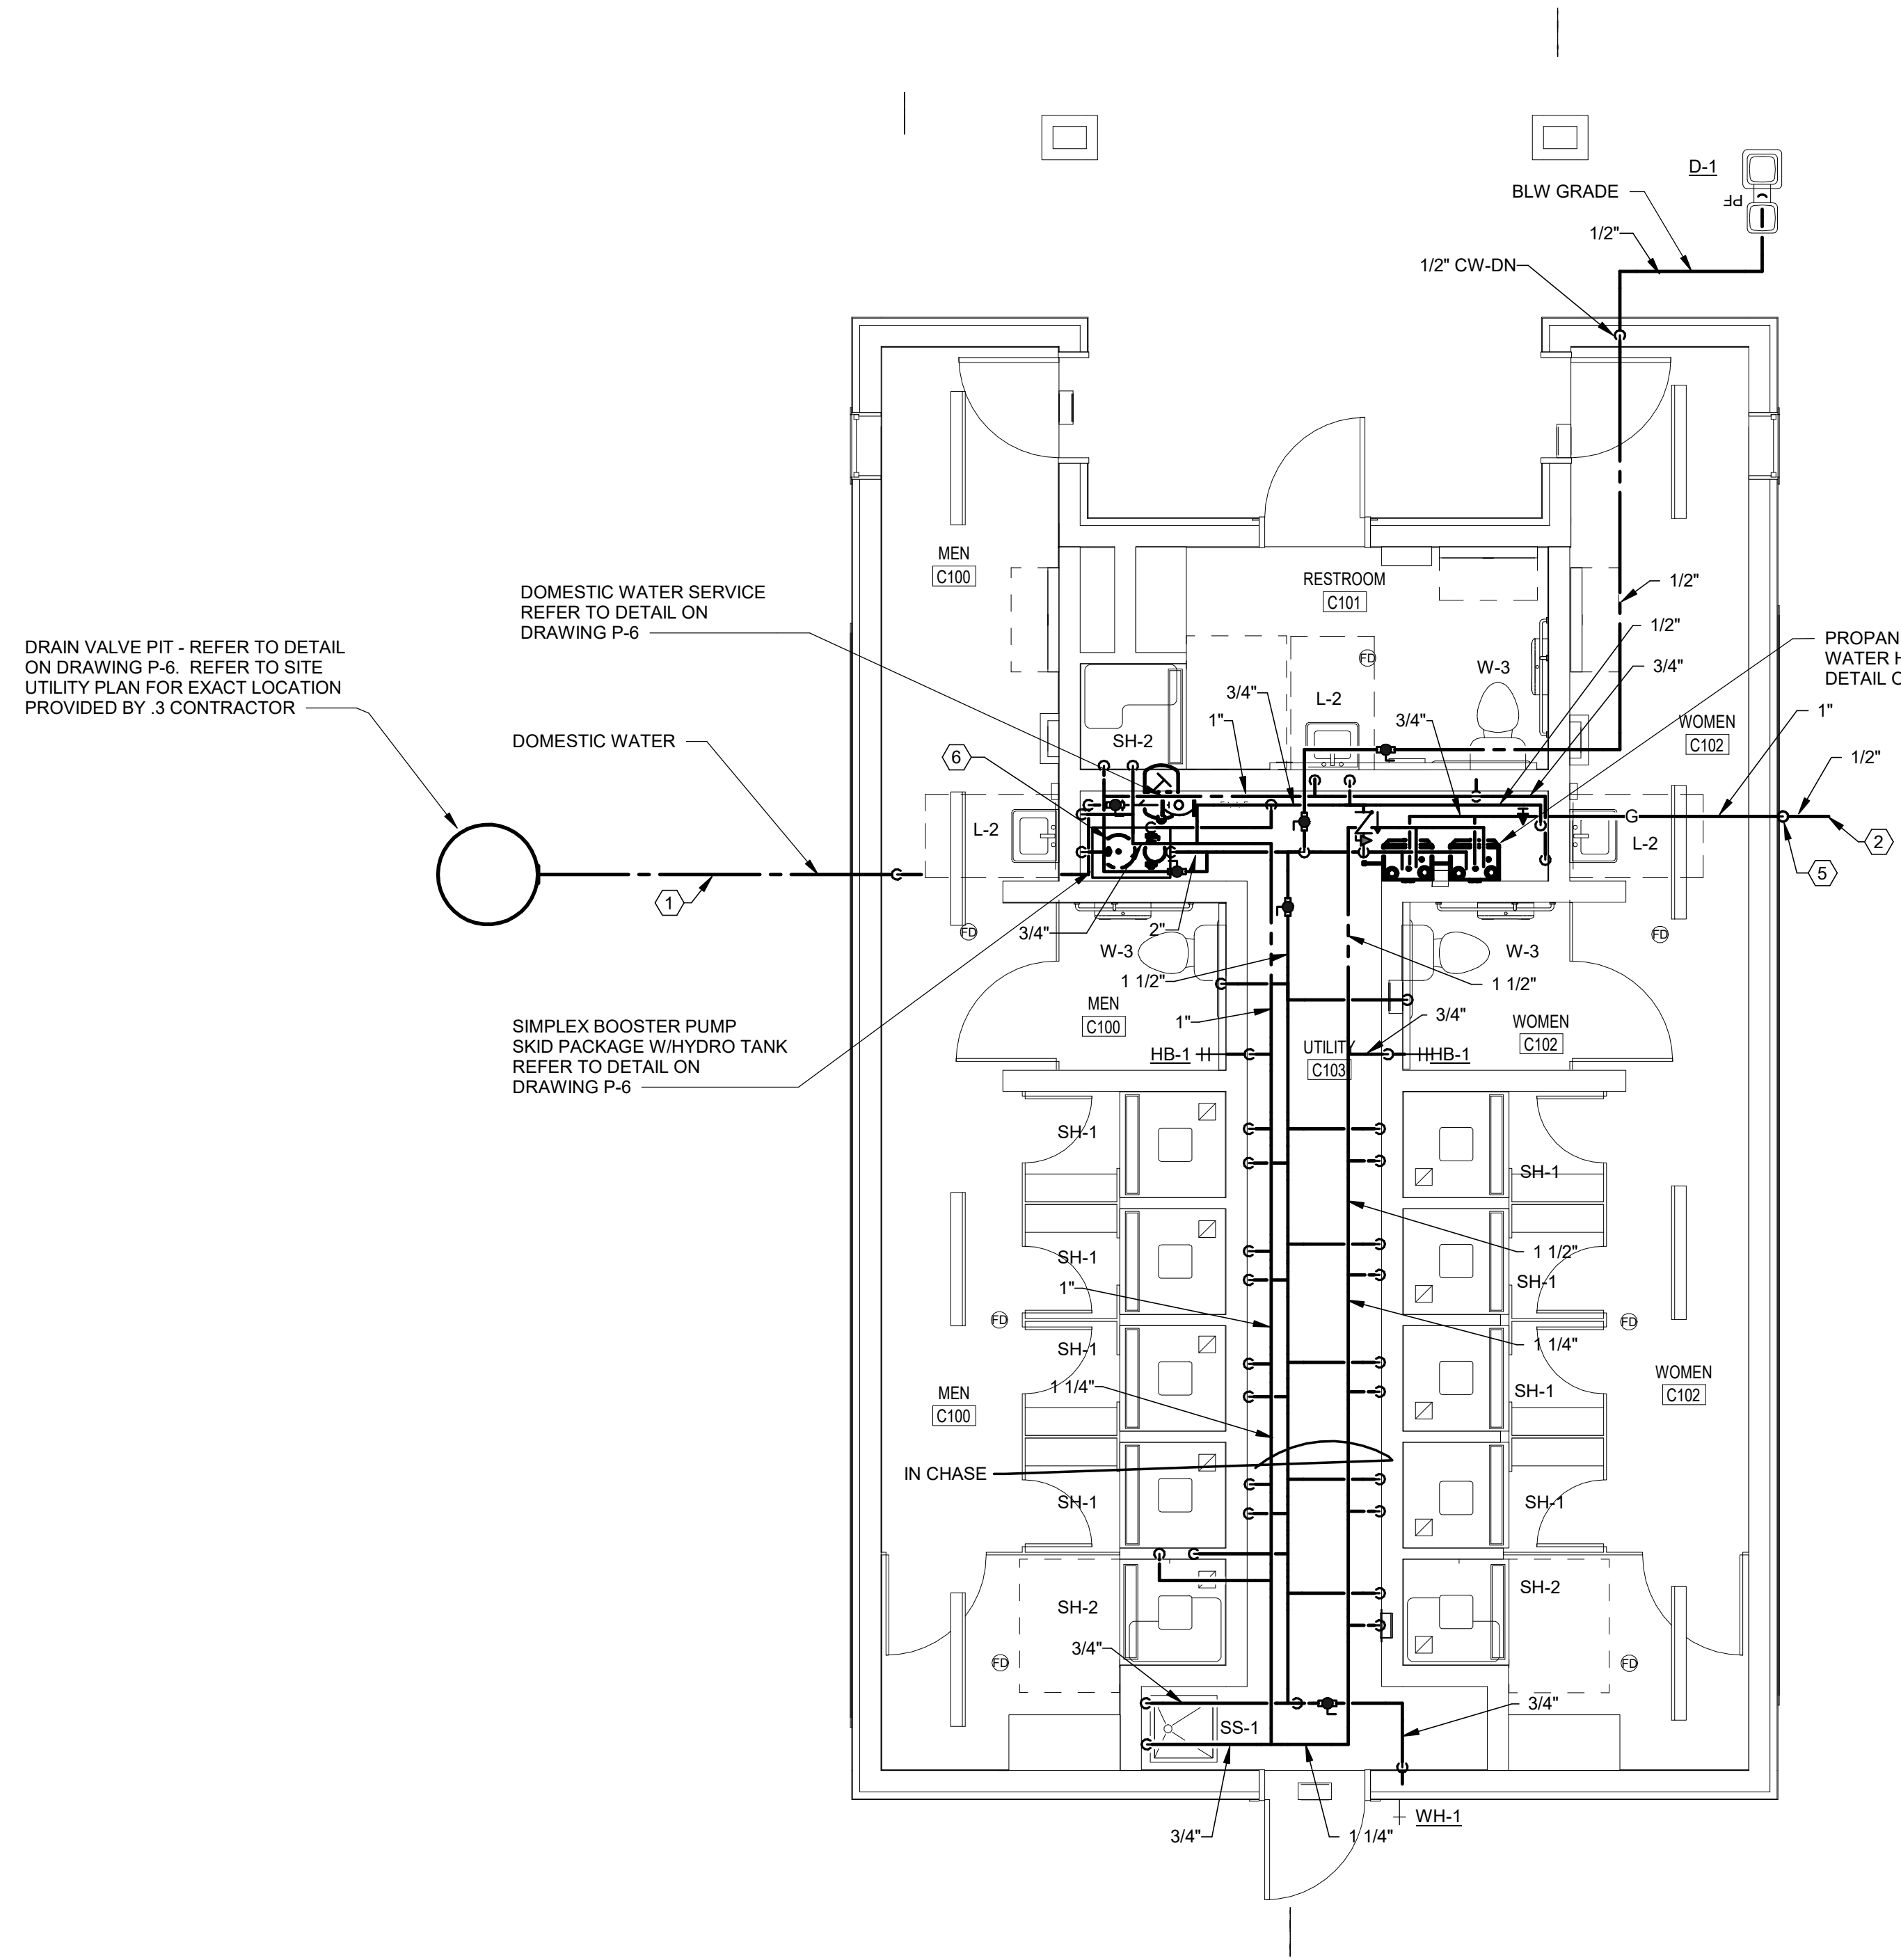
DRAWN BY R POPCHAK	DATE 06/17/2022	DRAWING No. P-3
CHECKED BY W MINAHAN	SCALE AS NOTED	

ALL WORK ON THIS SHEET IS BASE BID #3


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- 6 DURING CONSTRUCTION A WATER FLOW TEST SHOULD BE PERFORMED TO DETERMINE IF A BOOSTER PUMP IS NEEDED, OR NEEDS TO BE REVISED.
- 7 PROVIDE TOP CONNECT VENT. PROVIDE VENT PIPING BELOW SLAB ON GRADE SLOPING VENT PIPING UPWARDS AT 1/8" PER FOOT TO WALL.




1 OGC - DADDY ALLEN - DOMESTIC WATER AND LP GAS - PLUMBING
 SCALE: 1/4" = 1'-0"



2 OGC - DADDY ALLEN - SANITARY AND VENT - PLUMBING
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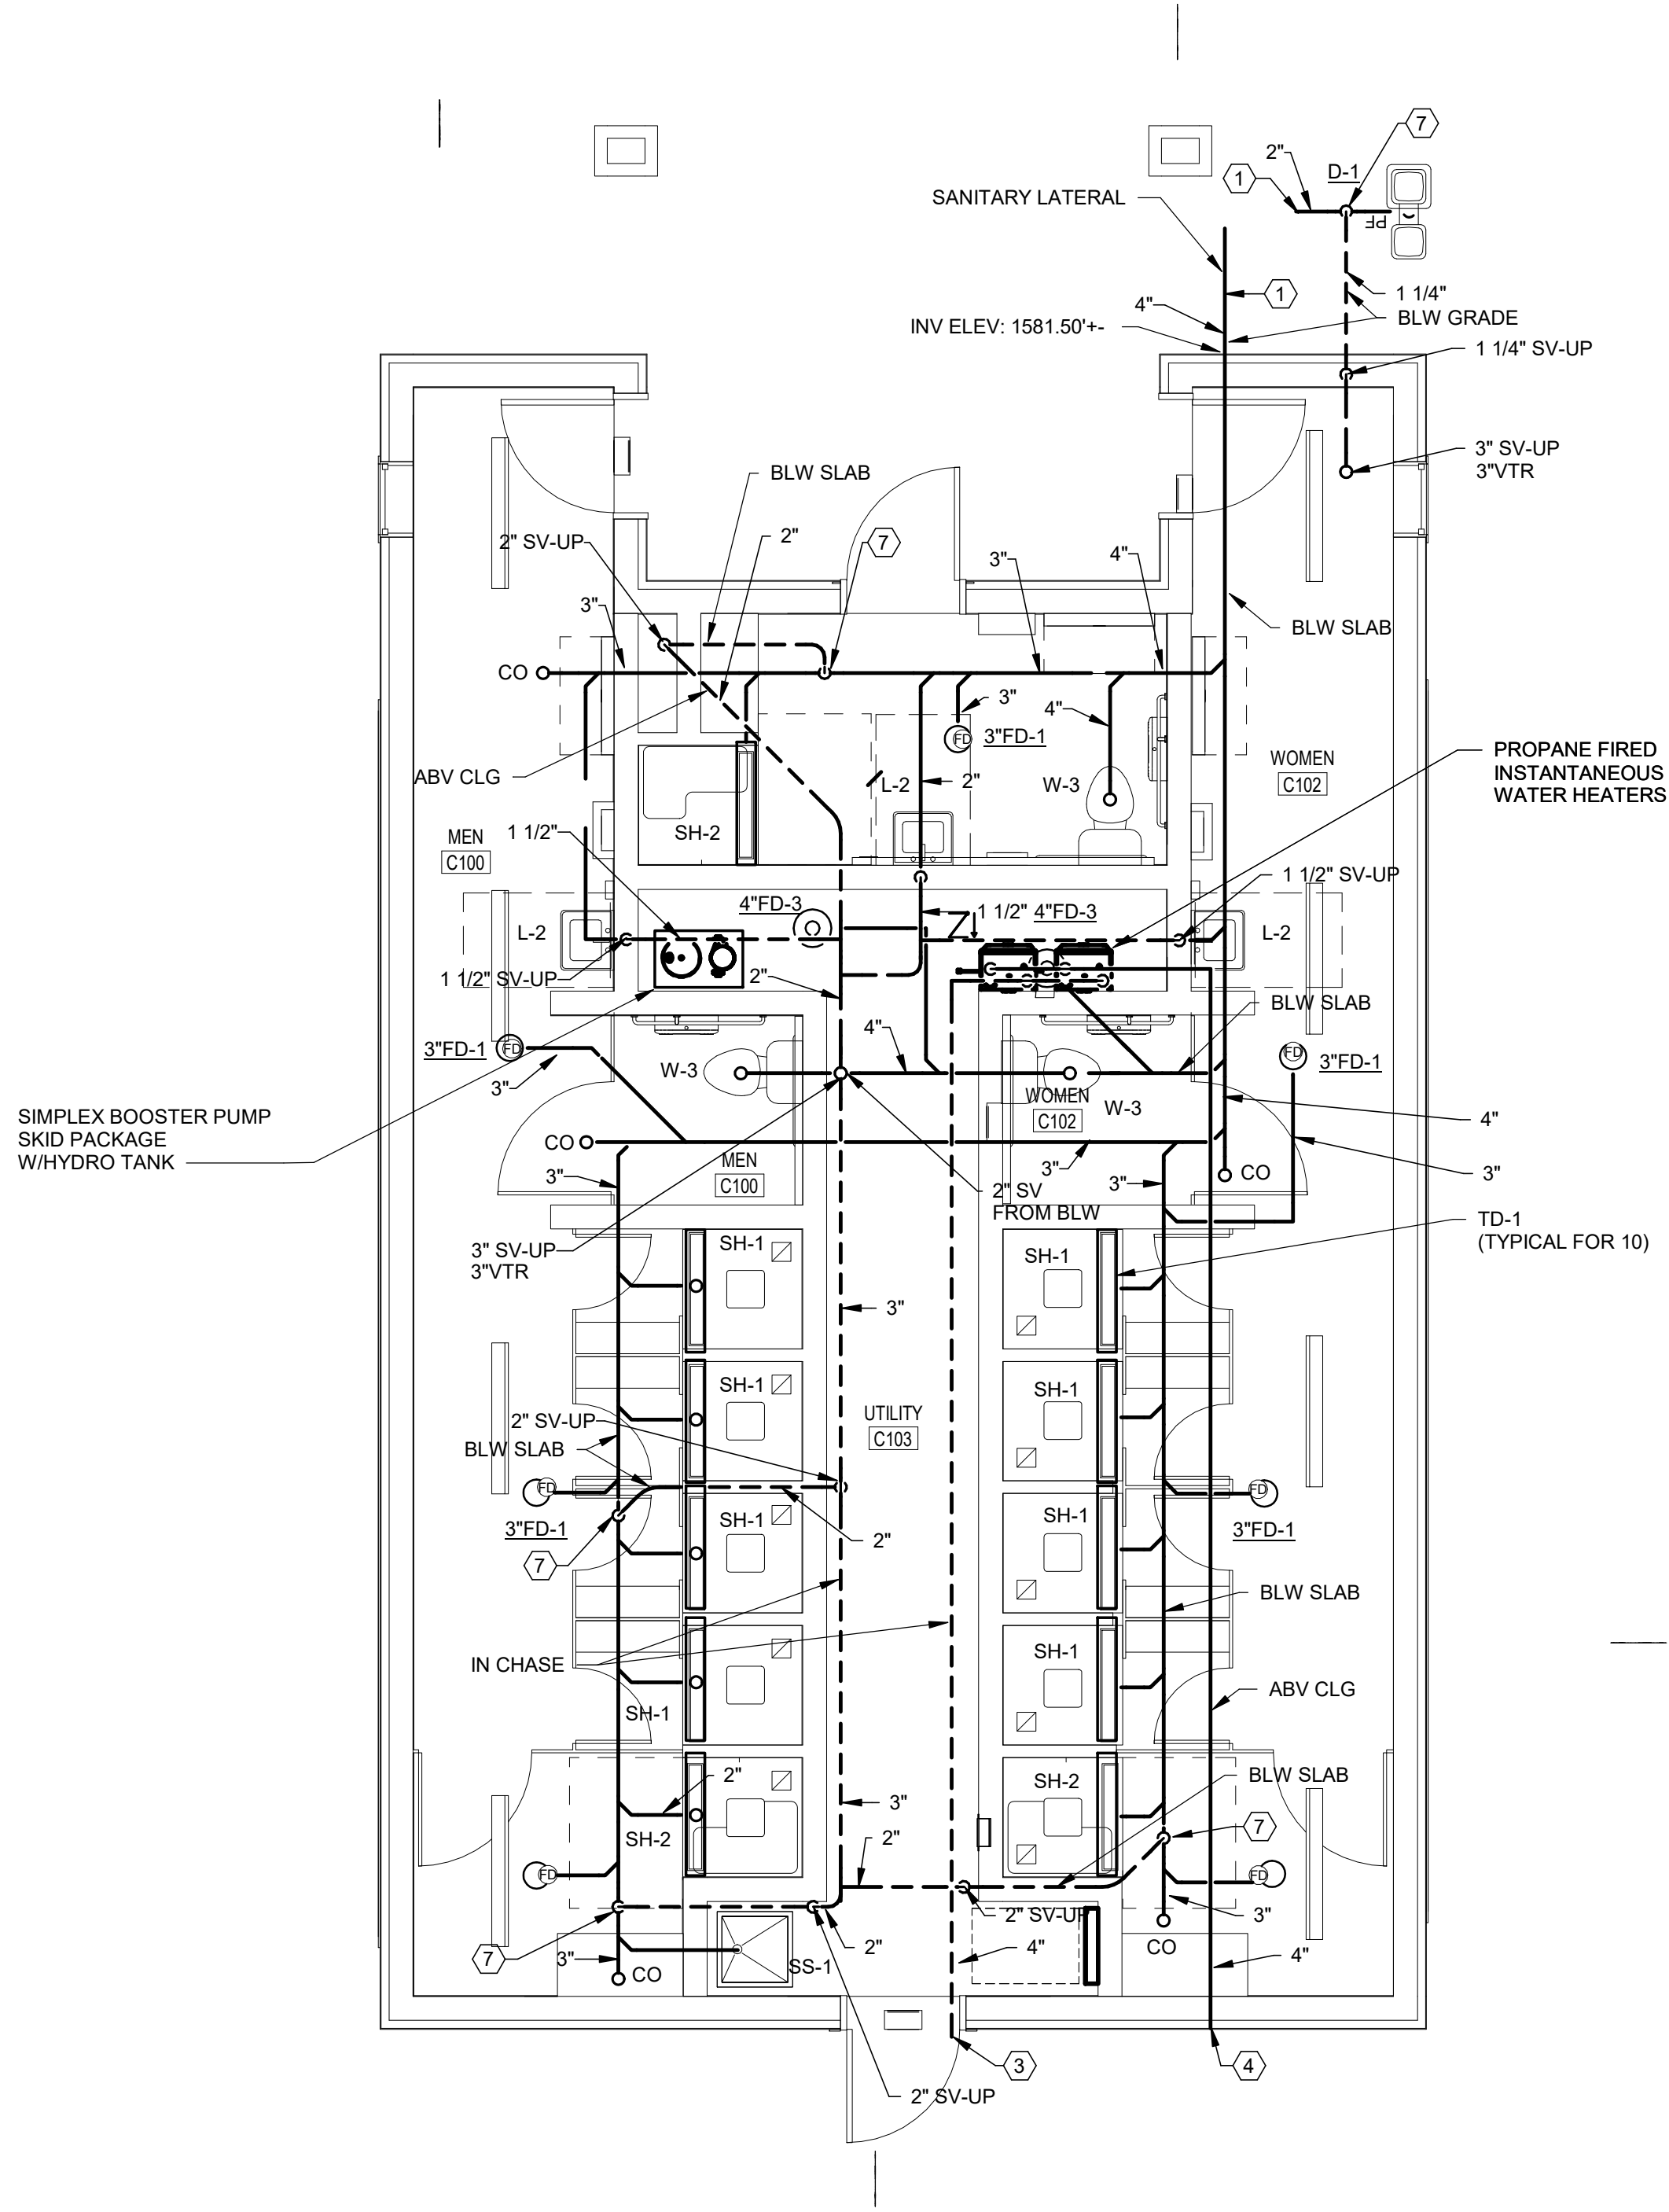
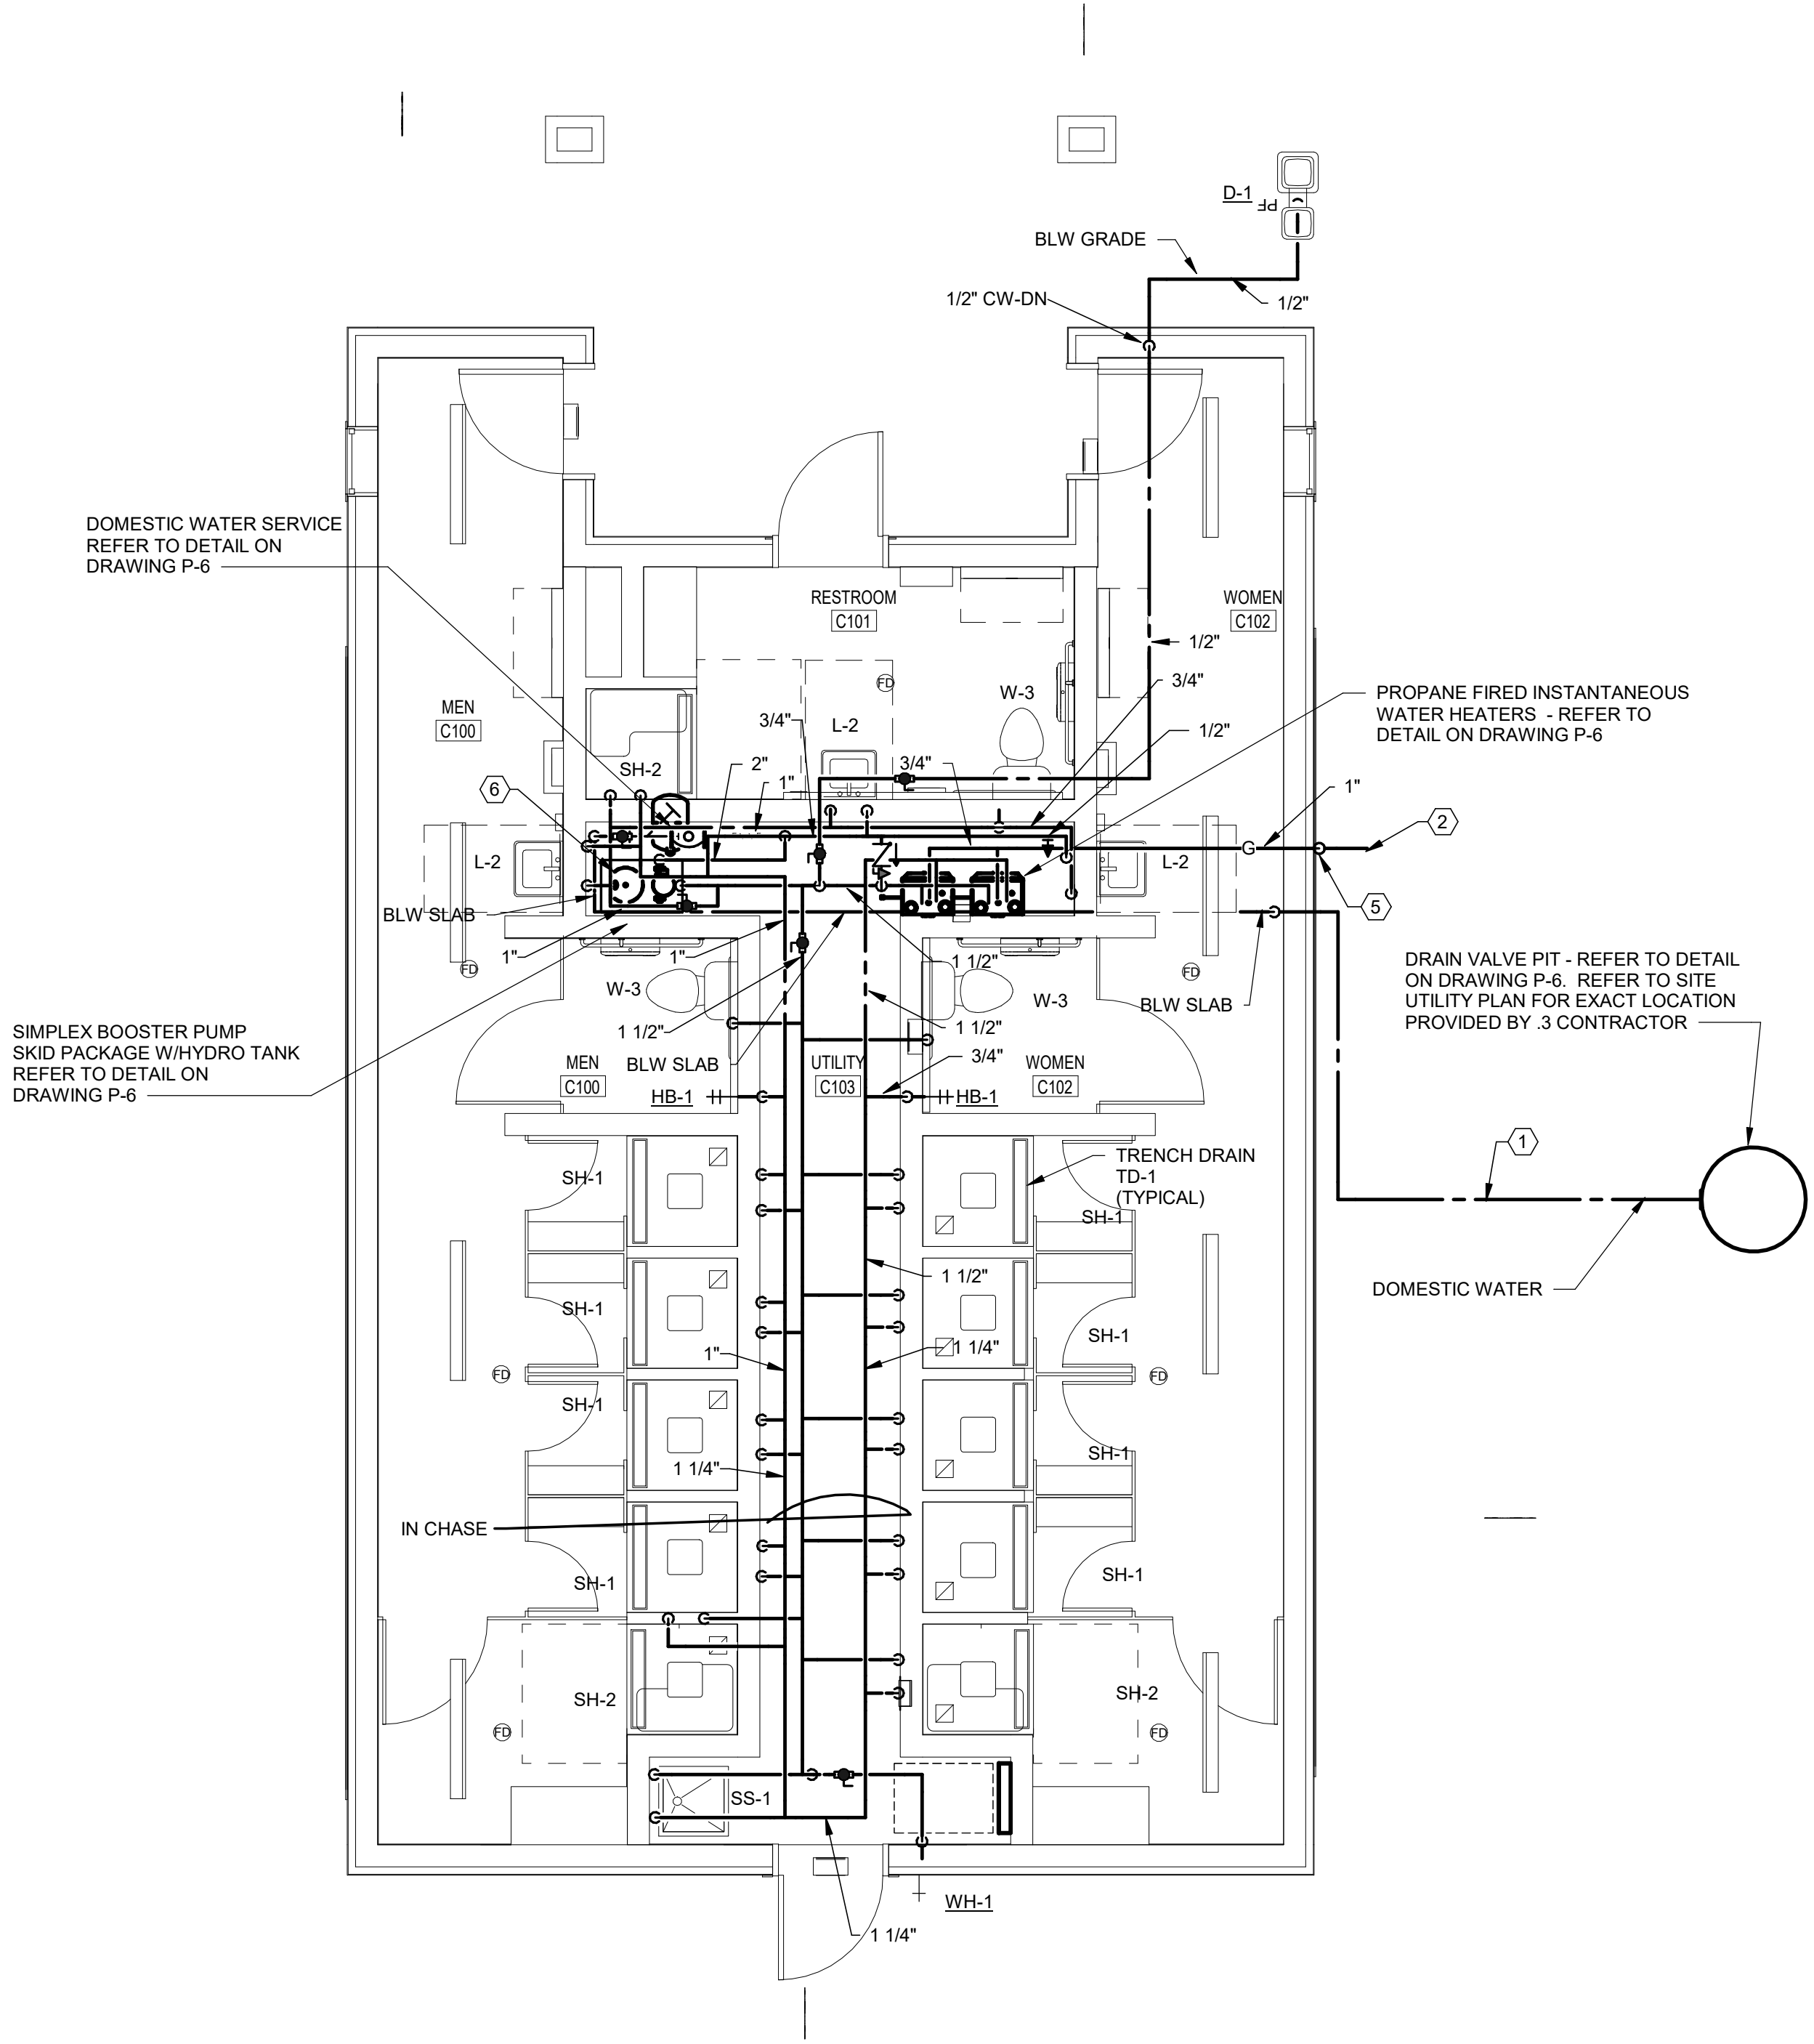
CONSTRUCTION DOCUMENTS	
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SIGNATURE _____ DATE _____	
SMP ARCHITECTS 1600 WALNUT STREET, SECOND FLOOR PHILADELPHIA, PENNSYLVANIA	
COMMONWEALTH OF PENNSYLVANIA DEPARTMENT OF GENERAL SERVICES HARRISBURG, PENNSYLVANIA	
D.G.S. PROJECT No.	
C-114-0006 PHASE 1	
HICKORY RUN STATE PARK LATRINE IMPROVEMENTS DEPT of CONSERVATION AND NATURAL RESOURCES WHITE HAVEN, CARBON COUNTY, PA CAMP DADDY ALLEN FLOOR PLAN - PLUMBING	
CONTRACTOR SHALL FIELD VERIFY ALL DIMENSIONS. VARIANCE FROM CONTRACT DOCUMENTS NOT PERMITTED WITHOUT PROFESSIONAL & BUREAU OF CONSTRUCTION APPROVAL.	DRAWN BY R POPCHAK
CHECKED BY W MINAHAN	DATE 06/17/2022
	DRAWING No. P-4
	SCALE AS NOTED

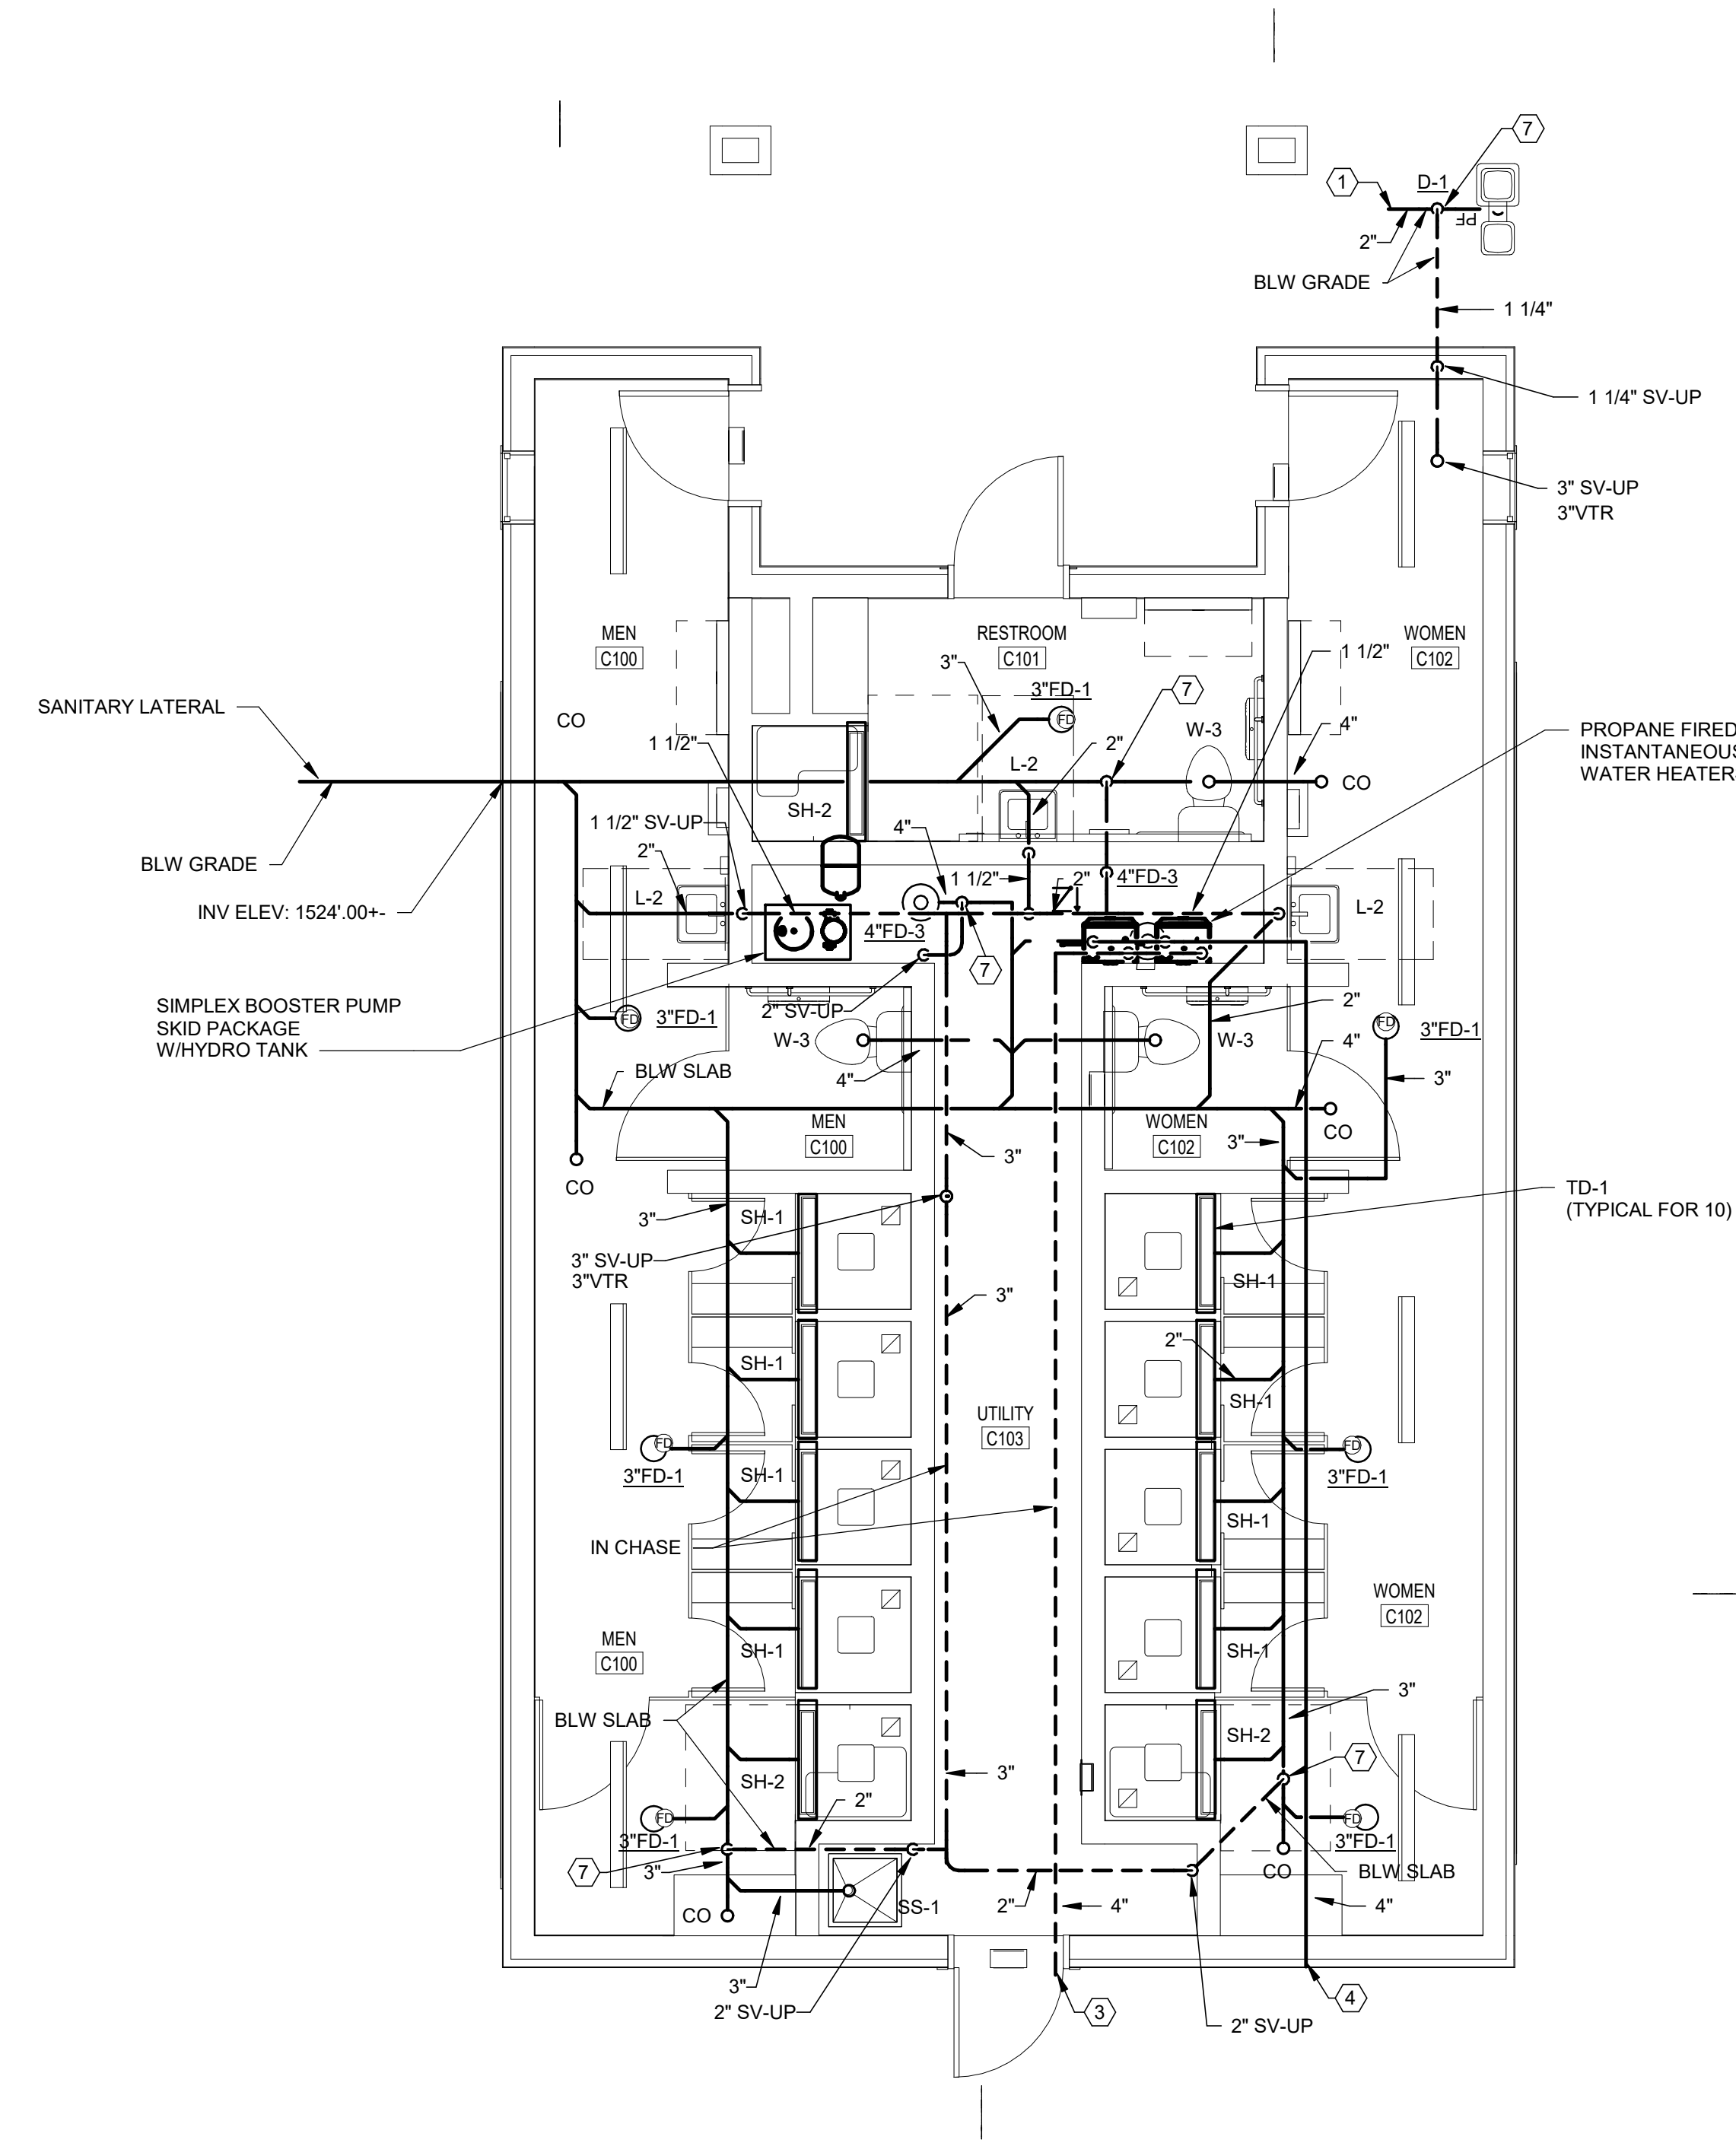ALL WORK ON THIS SHEET IS BASE BID #2

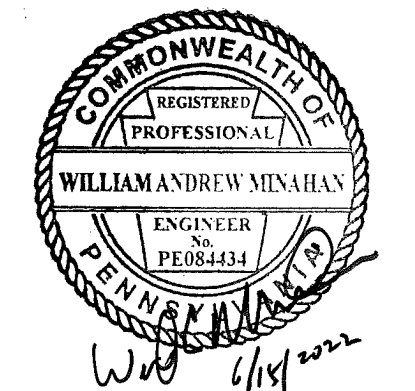NOTE:
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- 2 REFER TO SITE UTILITY PLAN FOR LP GAS STORAGE TANK LOCATION. ALL LP GAS PIPING, TANK AND ASSOCIATED EQUIPMENT BY .3 CONTRACTOR. REFER TO LP GAS STORAGE TANK DETAIL ON DRAWING P-6
- 3 DOMESTIC WATER HEATER EXHAUST. .3 CONTRACTOR TO COORDINATE LOCATION WITH .1 CONTRACTOR. REFER TO DOMESTIC WATER HEATER DETAIL ON DRAWING P-6.
- 4 DOMESTIC WATER HEATER INTAKE. .3 CONTRACTOR TO COORDINATE LOCATION WITH .1 CONTRACTOR. REFER TO DOMESTIC WATER HEATER DETAIL ON DRAWING P-6.
- 5 PROVIDE GAS COCK SHUT-OFF AND SECONDARY STAGE REGULATOR ALONG WALL IN VERTICAL. 11" W.C. OUTLET PRESSURE. 0.5 PSIG PRESSURE DROP. FOR MORE INFORMATION REFER TO SPECIFICATIONS.
- 6 DURING CONSTRUCTION A WATER FLOW TEST SHOULD BE PERFORMED TO DETERMINE IF A BOOSTER PUMP IS NEEDED, OR NEEDS TO BE REVISED.
- 7 PROVIDE TOP CONNECT VENT. PROVIDE VENT PIPING BELOW SLAB ON GRADE SLOPING VENT PIPING UPWARDS AT 1/8" PER FOOT TO WALL.




1 OGC - SHEHAQUA - DOMESTIC WATER AND LP GAS - PLUMBING
SCALE: 1/4" = 1'-0"

2 OGC - SHEHAQUA - SANITARY AND VENT - PLUMBING
SCALE: 1/4" = 1'-0"

CONSTRUCTION DOCUMENTS

RECORD REVISIONS

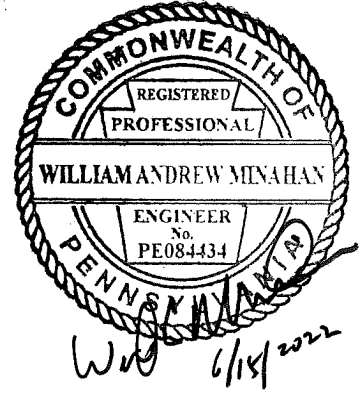

SIGNATURE DATE

SMP ARCHITECTS
1600 WALNUT STREET, SECOND FLOOR
PHILADELPHIA, PENNSYLVANIA

COMMONWEALTH OF PENNSYLVANIA
DEPARTMENT OF GENERAL SERVICES
HARRISBURG, PENNSYLVANIA

D.G.S. PROJECT No. C-114-0006 PHASE 1


HICKORY RUN STATE PARK
LATRINE IMPROVEMENTS
DEPT of CONSERVATION AND NATURAL RESOURCES
WHITE HAVEN, CARBON COUNTY, PA

CAMP SHEHAQUA FLOOR PLAN - PLUMBING


VERIFY SCALE

BAR IS ONE (1) INCH LONG
ON ORIGINAL DRAWING: 0 1
IF BAR IS NOT ONE (1) INCH LONG, ADJUST SCALE ACCORDINGLY


CONTRACTOR SHALL FIELD VERIFY ALL DIMENSIONS. VARIANCE FROM CONTRACT DOCUMENTS NOT PERMITTED WITHOUT PROFESSIONAL & BUREAU OF CONSTRUCTION APPROVAL.	DRAWN BY R POPCHAK	DATE 06/17/2022	DRAWING No. P-5
	CHECKED BY W MINAHAN	SCALE AS NOTED	

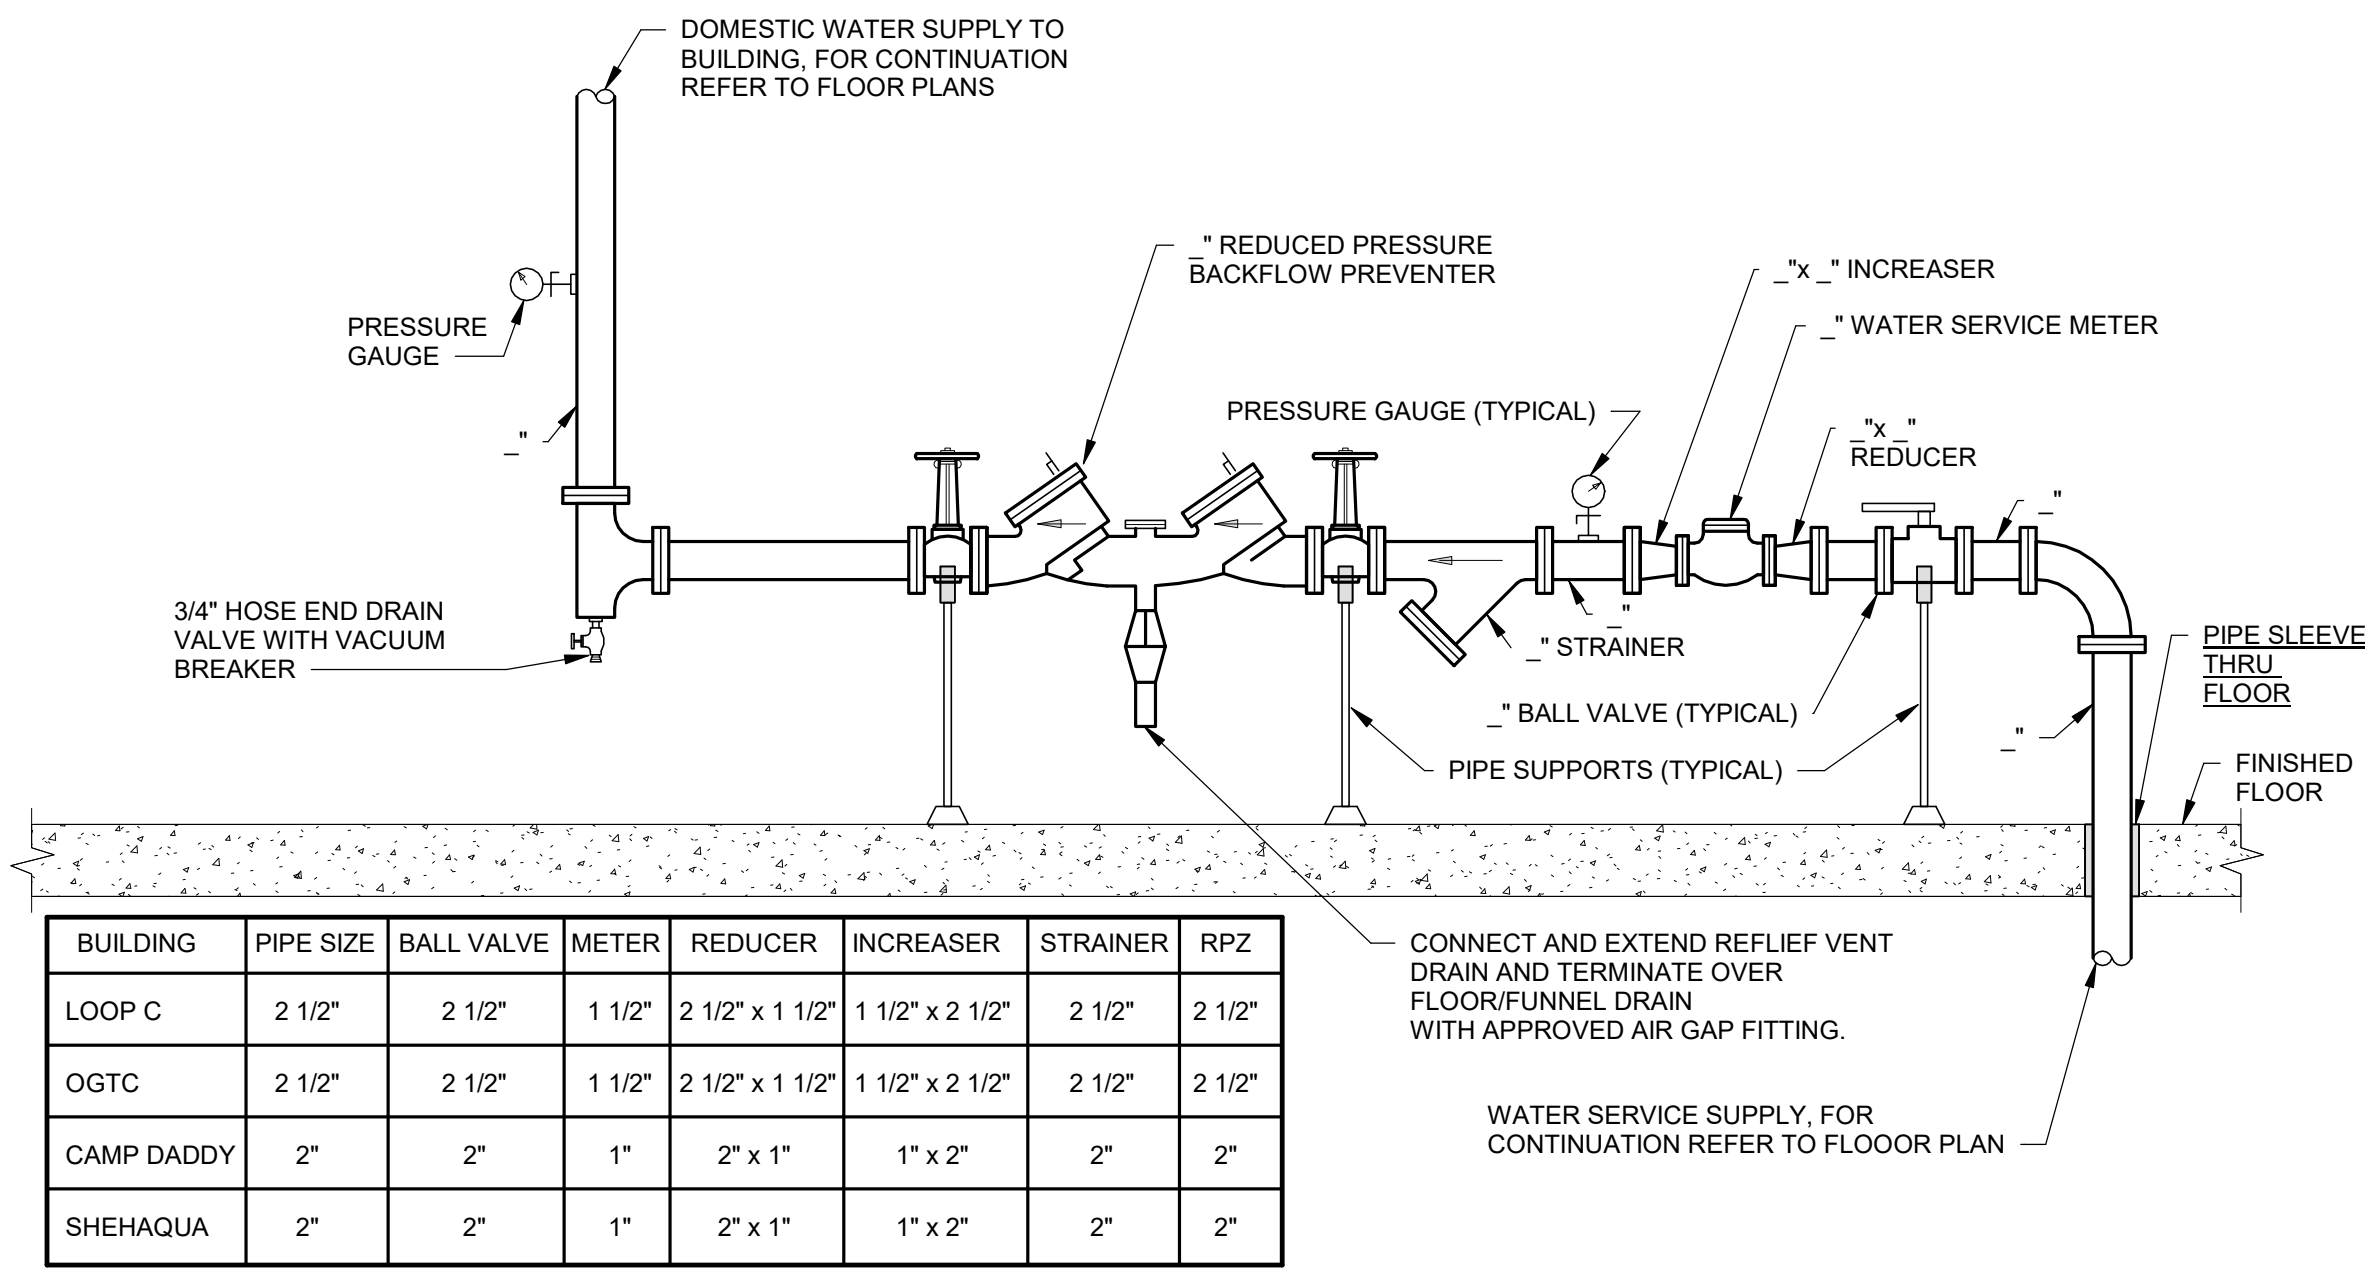


1 TYPICAL DOMESTIC WATER SERVICE DIAGRAM
SCALE: 1/8" = 1'-0"

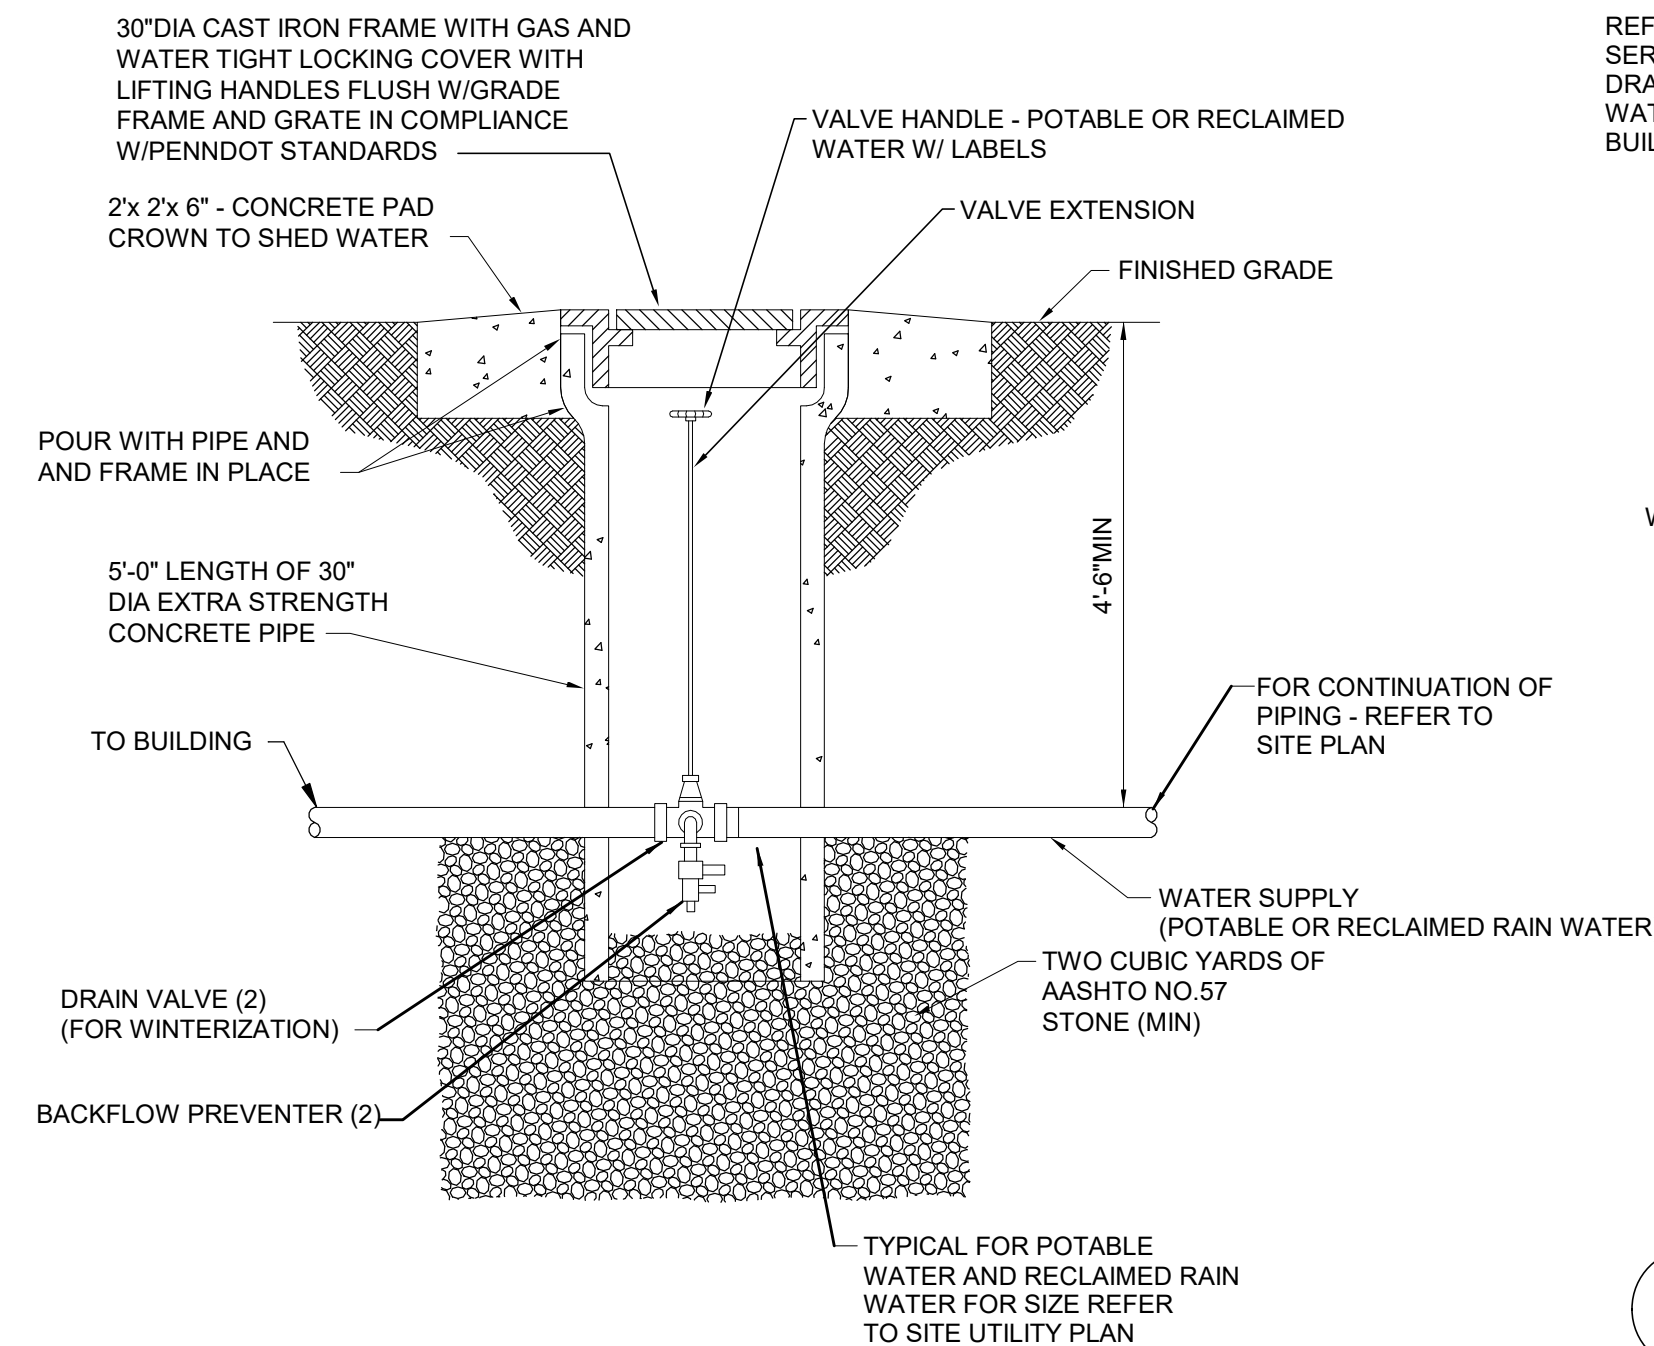


2 WATER SUPPLY DRAIN VALVE AND VALVE PIT DETAIL
SCALE: 1/8" = 1'-0"

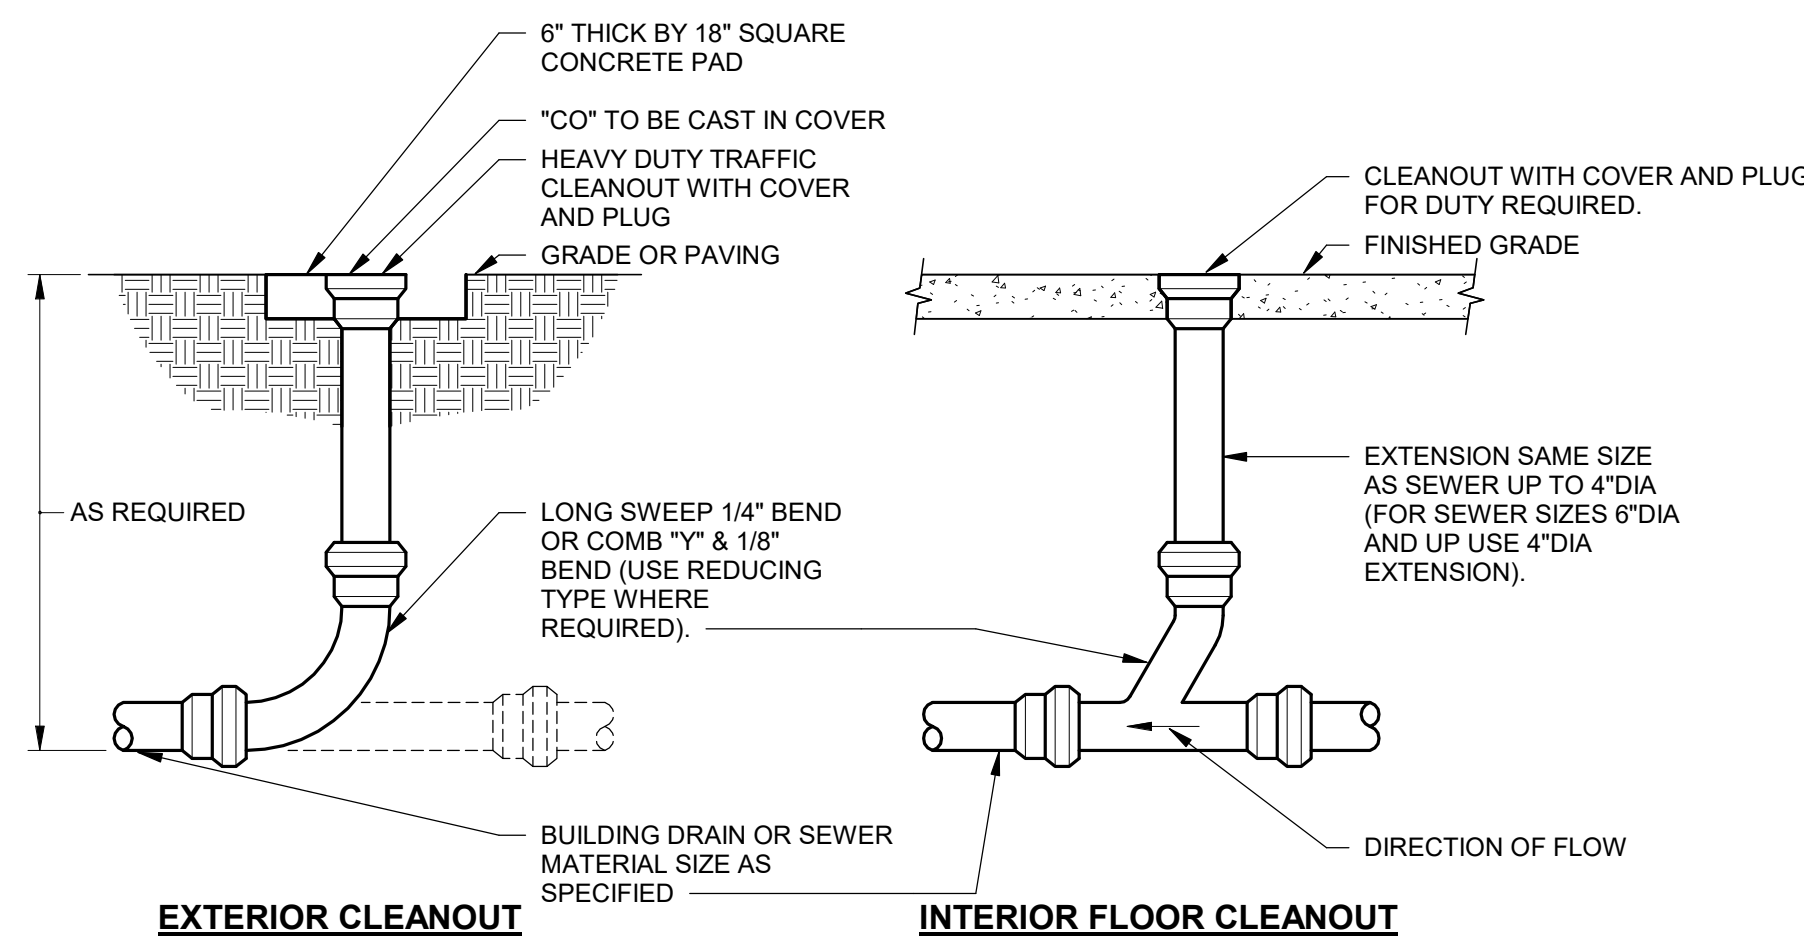


5 DETAIL OF CLEANOUTS
SCALE: 1/8" = 1'-0"

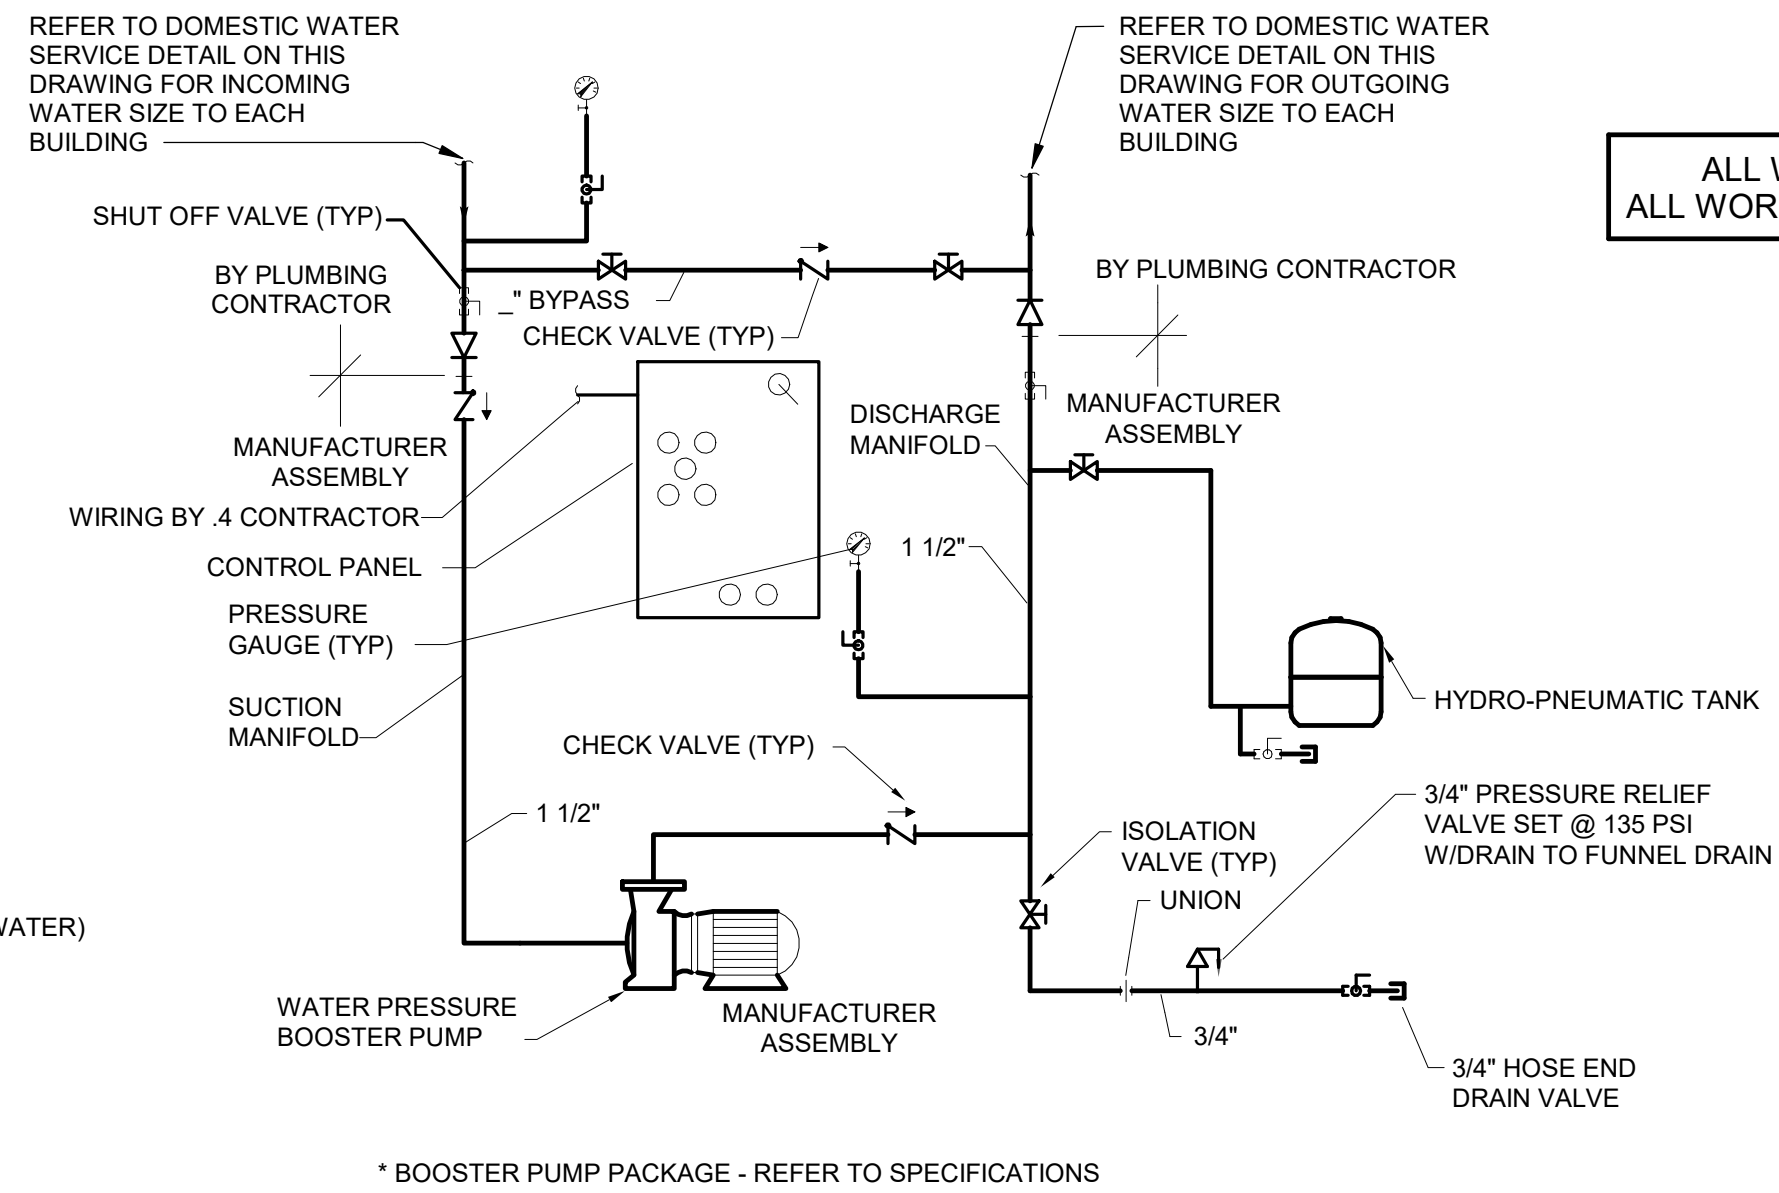


3 SIMPLEX DOMESTIC WATER BOOSTER PUMP SCHEMATIC DETAIL
SCALE: 1/8" = 1'-0"

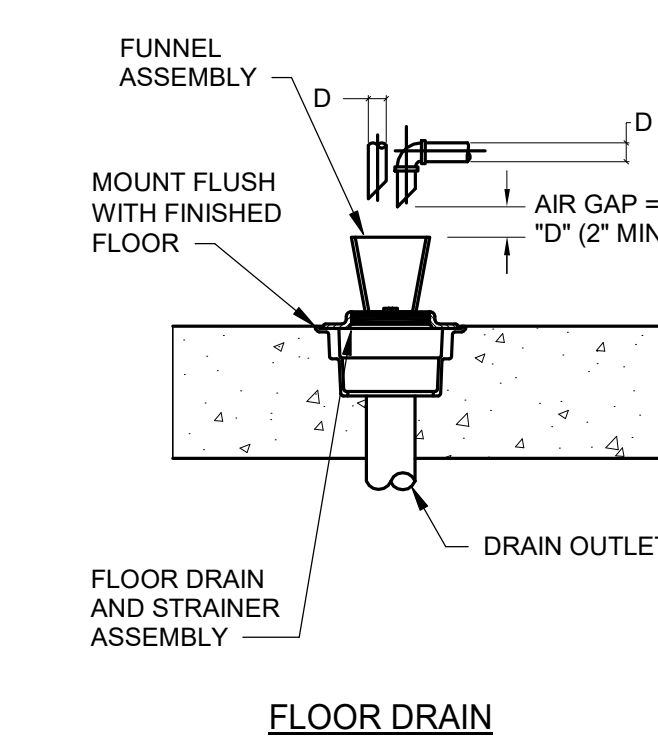


6 FLOOR DRAIN DETAIL
SCALE: 1/8" = 1'-0"

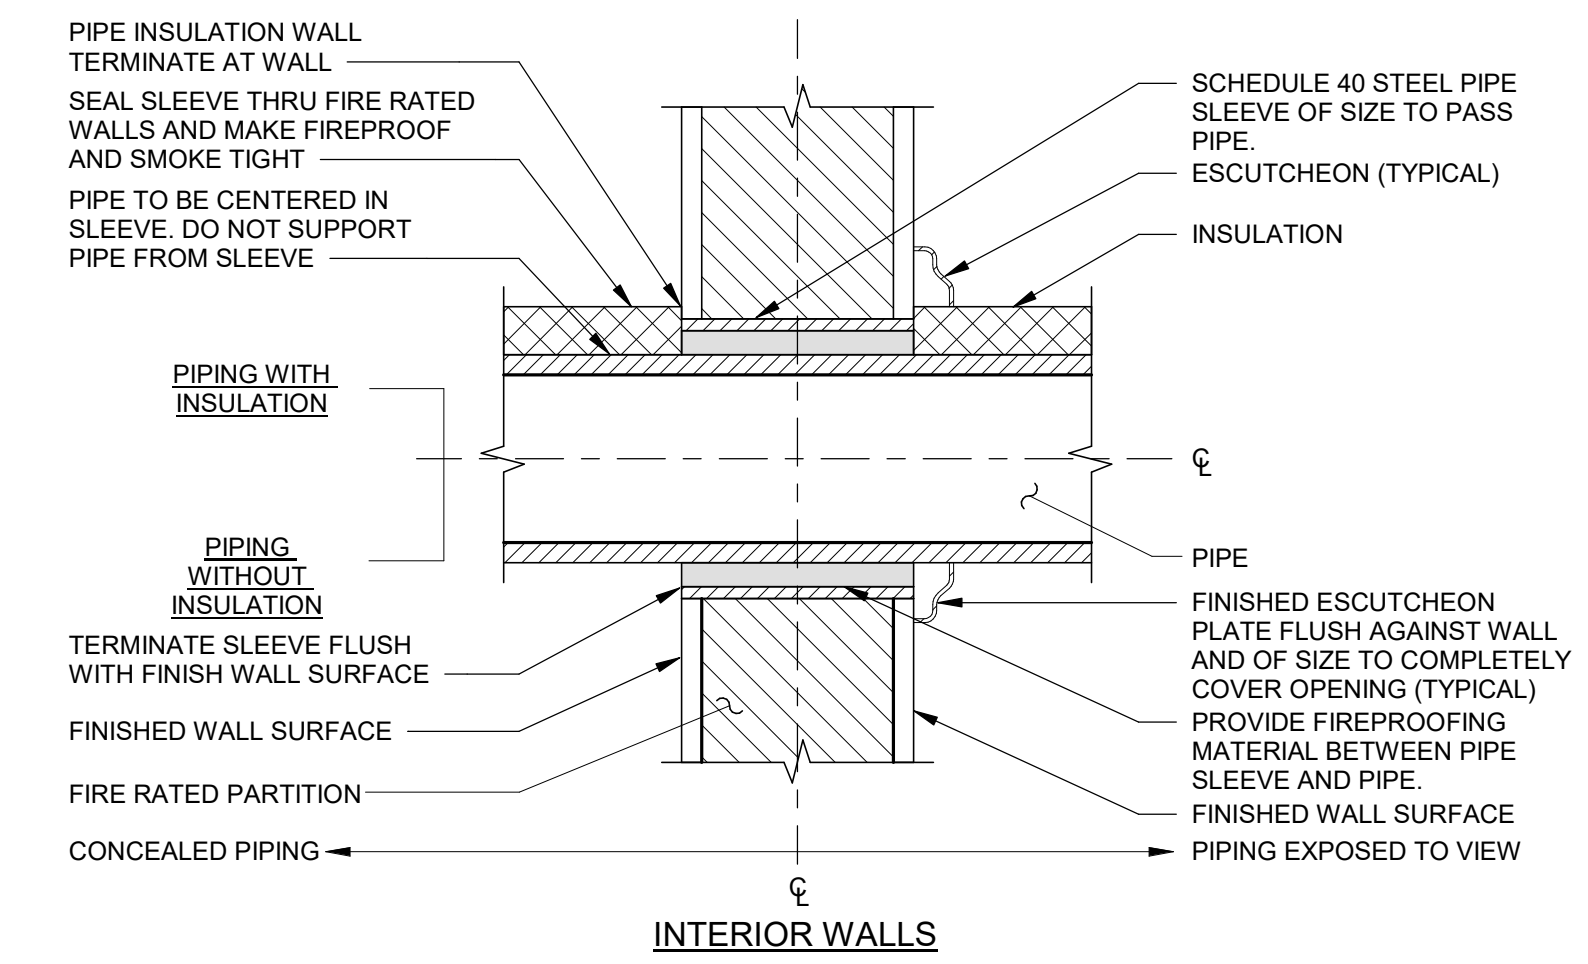


7 PIPE SLEEVE THRU WALL DETAIL
SCALE: 1/8" = 1'-0"

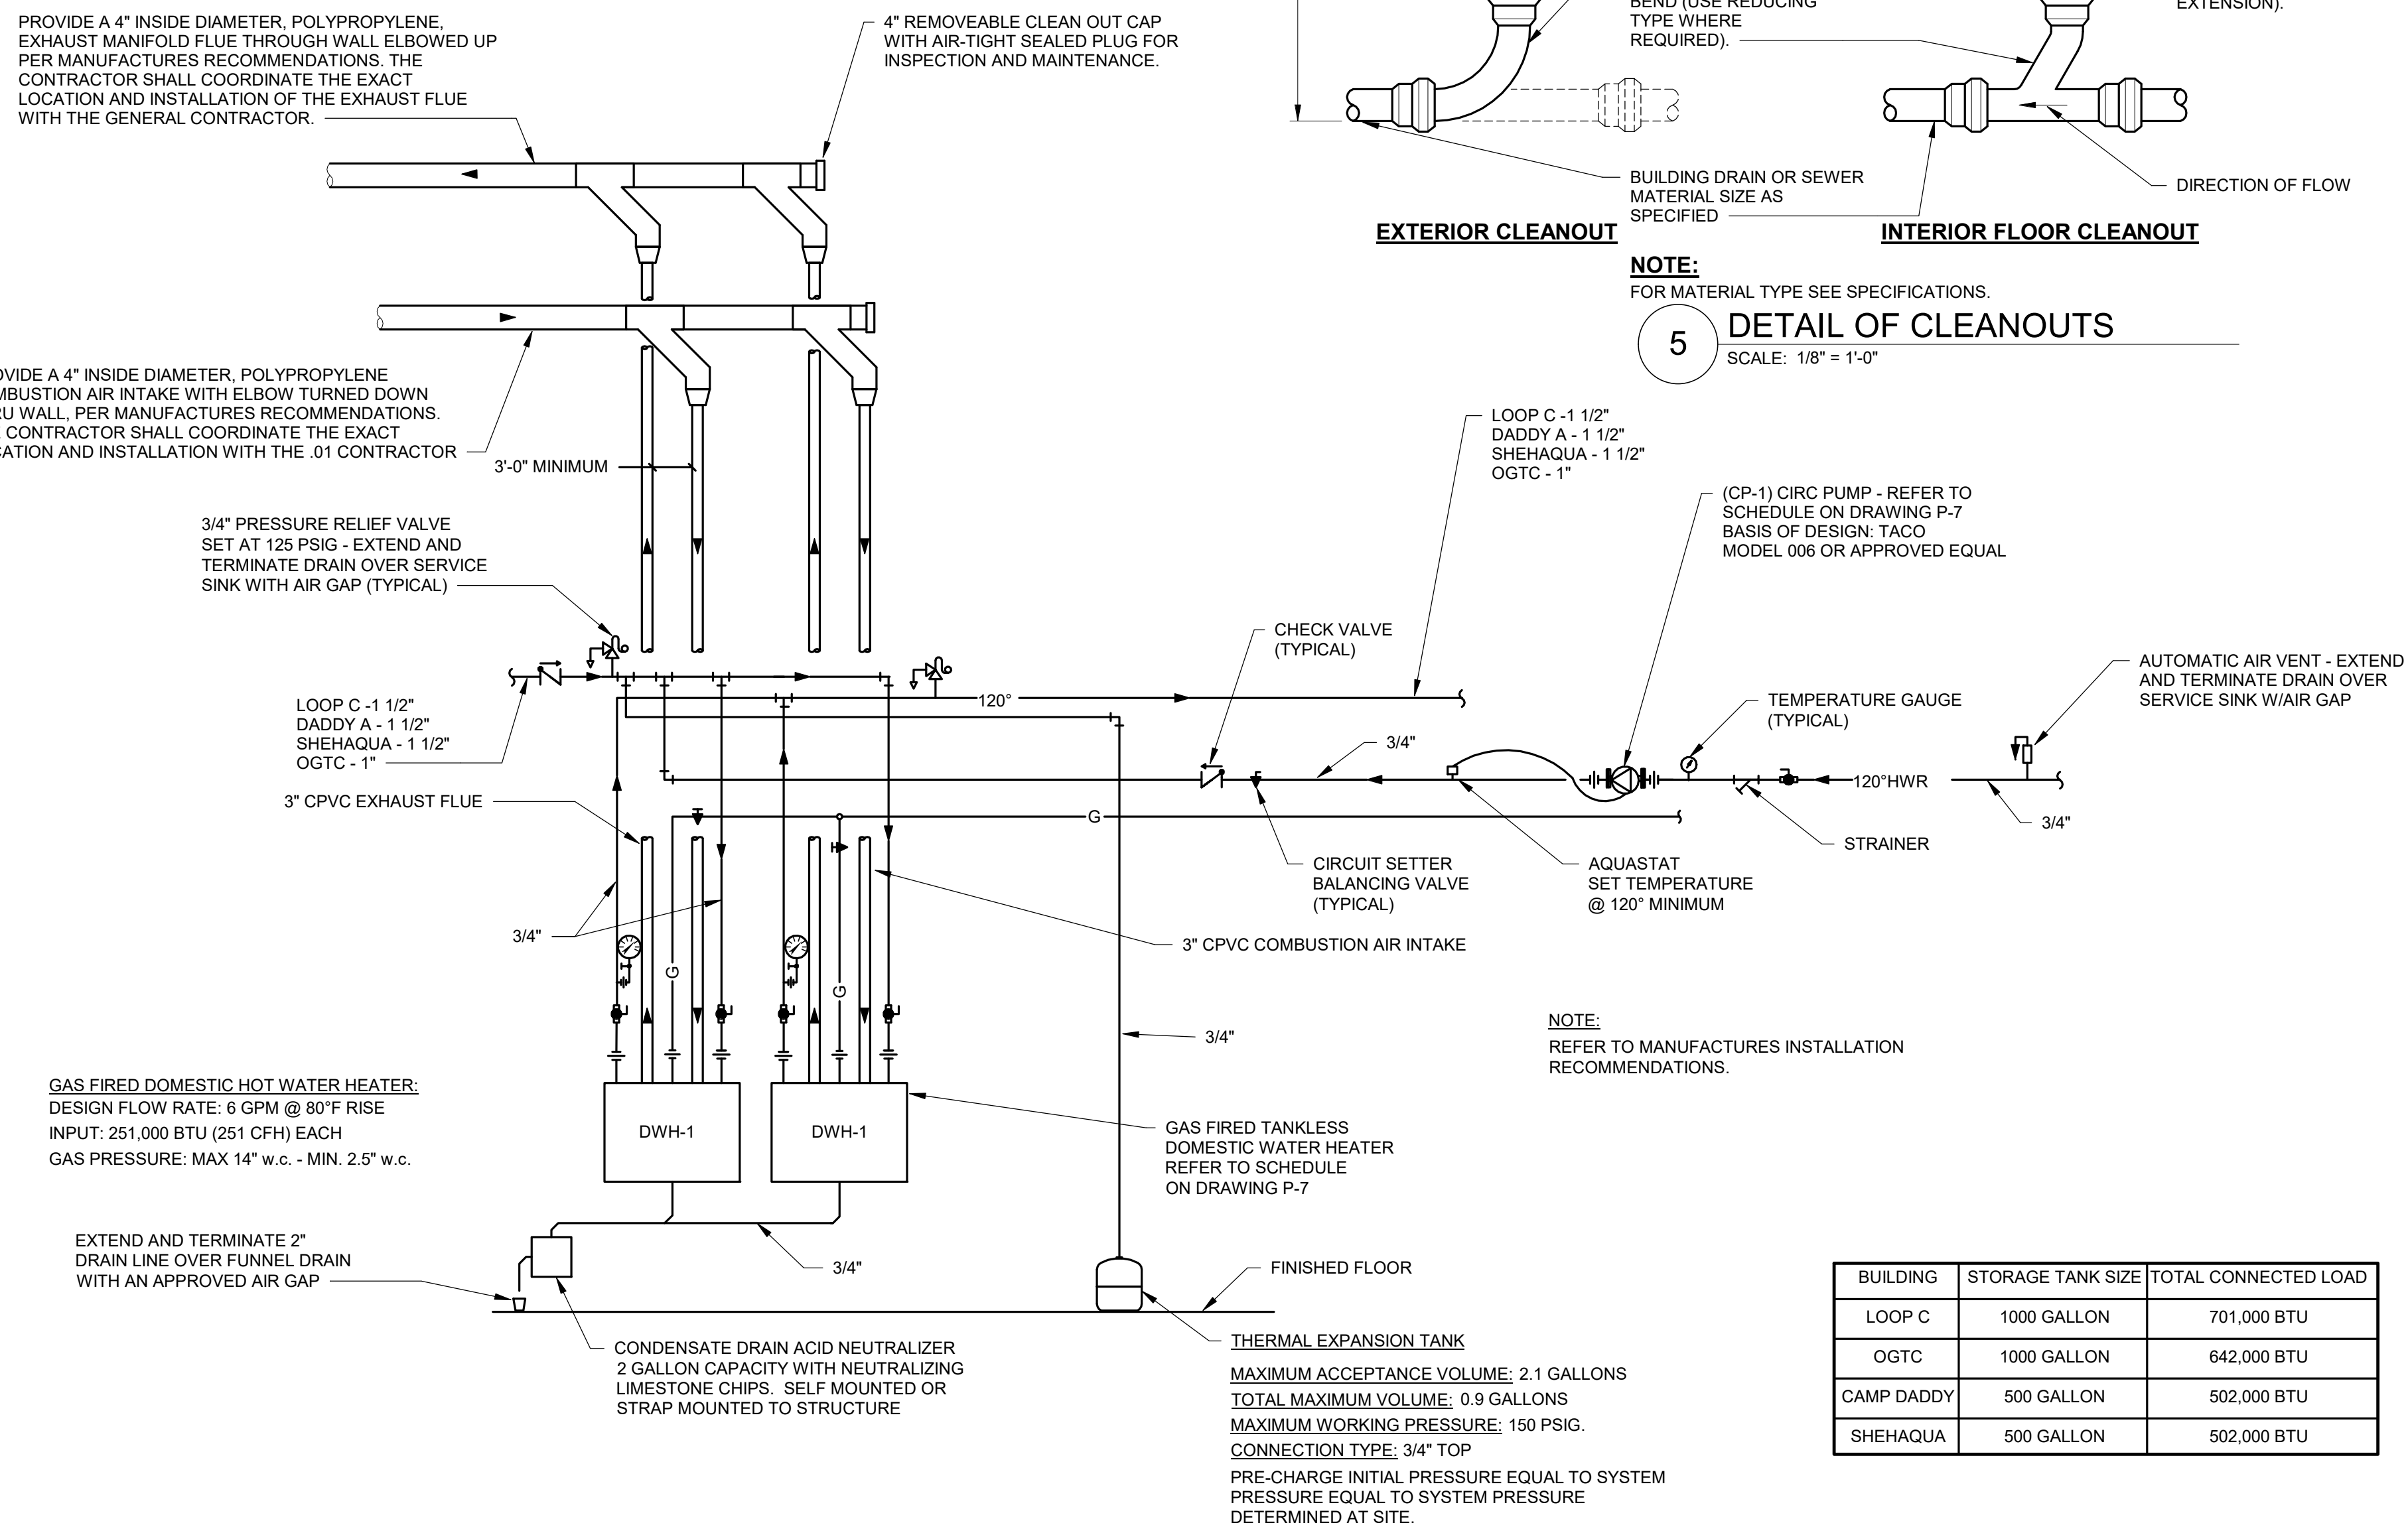

4 INSTANTANEOUS DOMESTIC WATER HEATER SCHEMATIC (WALL)
SCALE: 1/8" = 1'-0"

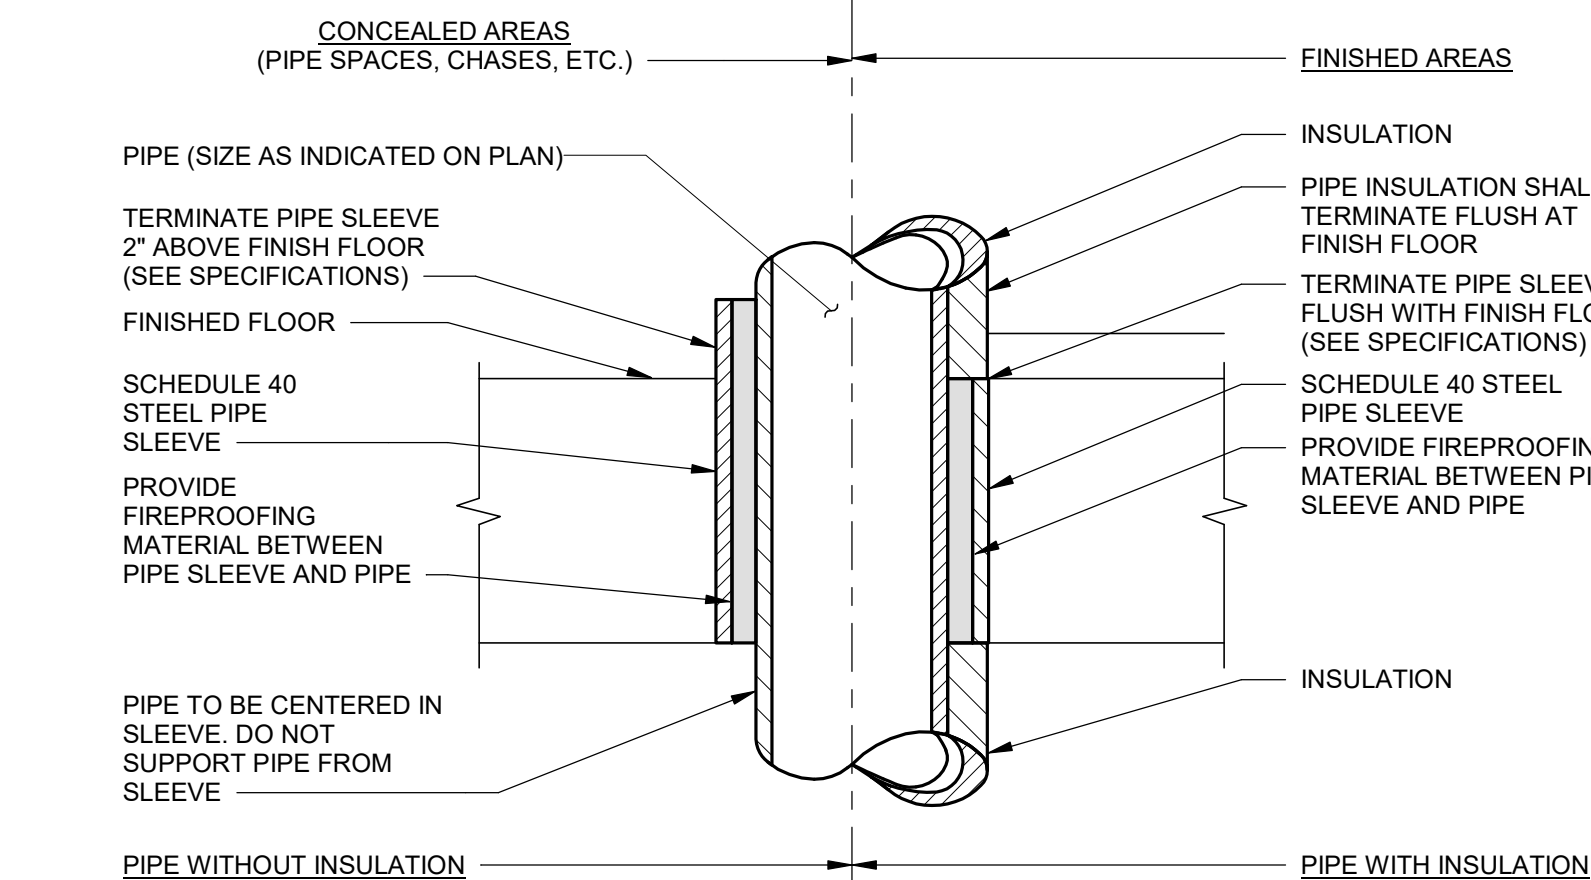

8 PIPE SLEEVE THRU FLOOR DETAIL
SCALE: 1/8" = 1'-0"

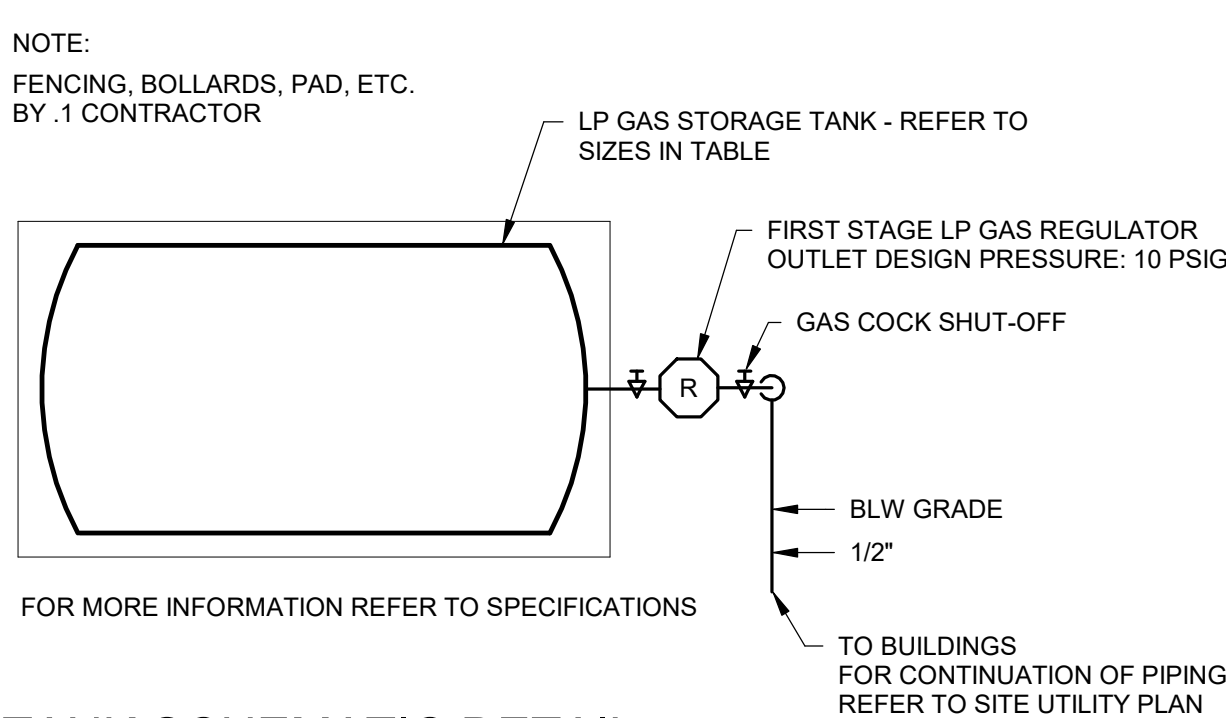

9 LP GAS STORAGE TANK SCHEMATIC DETAIL
SCALE: 1/8" = 1'-0"


BUILDING	STORAGE TANK SIZE	TOTAL CONNECTED LOAD
LOOP C	1000 GALLON	701,000 BTU
OGTC	1000 GALLON	642,000 BTU
CAMP DADDY	500 GALLON	502,000 BTU
SHEHAQUA	500 GALLON	502,000 BTU

MAXIMUM ACCEPTANCE VOLUME: 2.1 GALLONS
TOTAL MAXIMUM VOLUME: 0.9 GALLONS
MAXIMUM WORKING PRESSURE: 150 PSIG.
CONNECTION TYPE: 3/4" TOP
PRE-CHARGE INITIAL PRESSURE EQUAL TO SYSTEM
PRESSURE EQUAL TO SYSTEM PRESSURE
DETERMINED AT SITE.

ALL WORK ASSOCIATED WITH SHEHAQUA IS BASE BID #2
ALL WORK ASSOCIATED WITH CAMP DADDY ALLEN IS BASE BID #3

CONSTRUCTION DOCUMENTS

RECORD REVISIONS

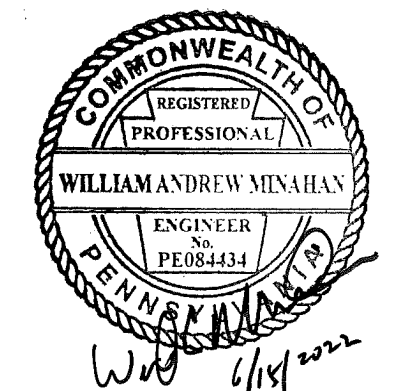

SIGNATURE DATE

SMP ARCHITECTS
1600 WALNUT STREET, SECOND FLOOR
PHILADELPHIA, PENNSYLVANIA

COMMONWEALTH OF PENNSYLVANIA
DEPARTMENT OF GENERAL SERVICES
HARRISBURG, PENNSYLVANIA


D.G.S. PROJECT No.
C-114-0006 PHASE 1
HICKORY RUN STATE PARK
LATRINE IMPROVEMENTS
DEPT OF CONSERVATION AND NATURAL RESOURCES
WHITE HAVEN, CARBON COUNTY, PA

VERIFY SCALE
BAR IS ONE (1) INCH LONG
ON ORIGINAL DRAWING: 0 1
IF BAR IS NOT ONE (1) INCH LONG, ADJUST SCALE ACCORDINGLY

CONTRACTOR SHALL FIELD VERIFY ALL DIMENSIONS. VARIANCE FROM CONTRACT DOCUMENTS NOT PERMITTED WITHOUT PROFESSIONAL & BUREAU OF CONSTRUCTION APPROVAL.

DETAILS - PLUMBING


DRAWN BY R POPCHAK	DATE 06/17/2022	DRAWING No. P-6
CHECKED BY W MINAHAN	SCALE AS NOTED	134 OF 144

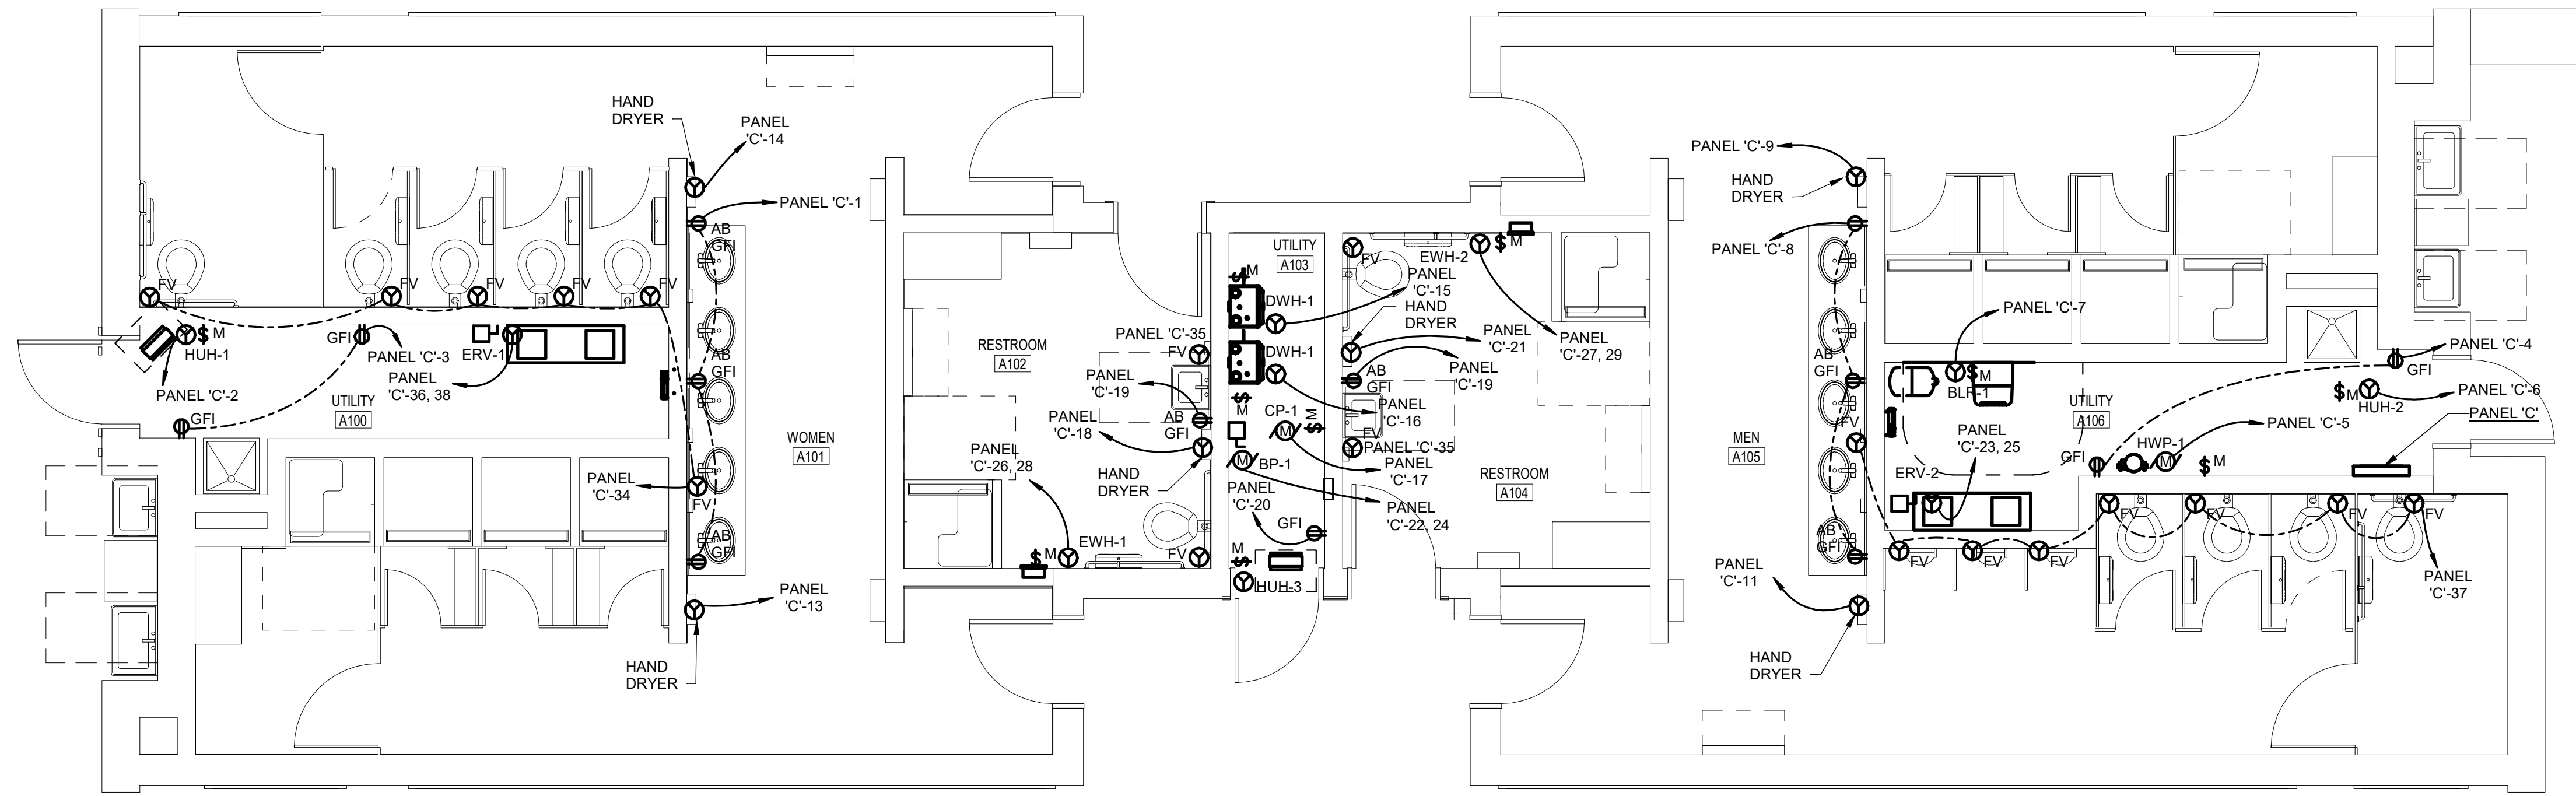

GENERAL ELECTRICAL NOTES:

- CONNECT BATTERY OPERATED EMERGENCY LIGHTING UNITS TYPE 'EM' AND ALL BATTERY OPERATED EXIST SIGNS TYPE 'EX1' TO LIGHTING CIRCUIT SERVING THE AREA. THIS CONNECTION SHALL BE AHEAD OF THE SWITCH LEG AND SHALL NOT BE SWITCHED IN ANY MANNER.


2 LOOP-C - POWER
SCALE: 1/4" = 1'-0"

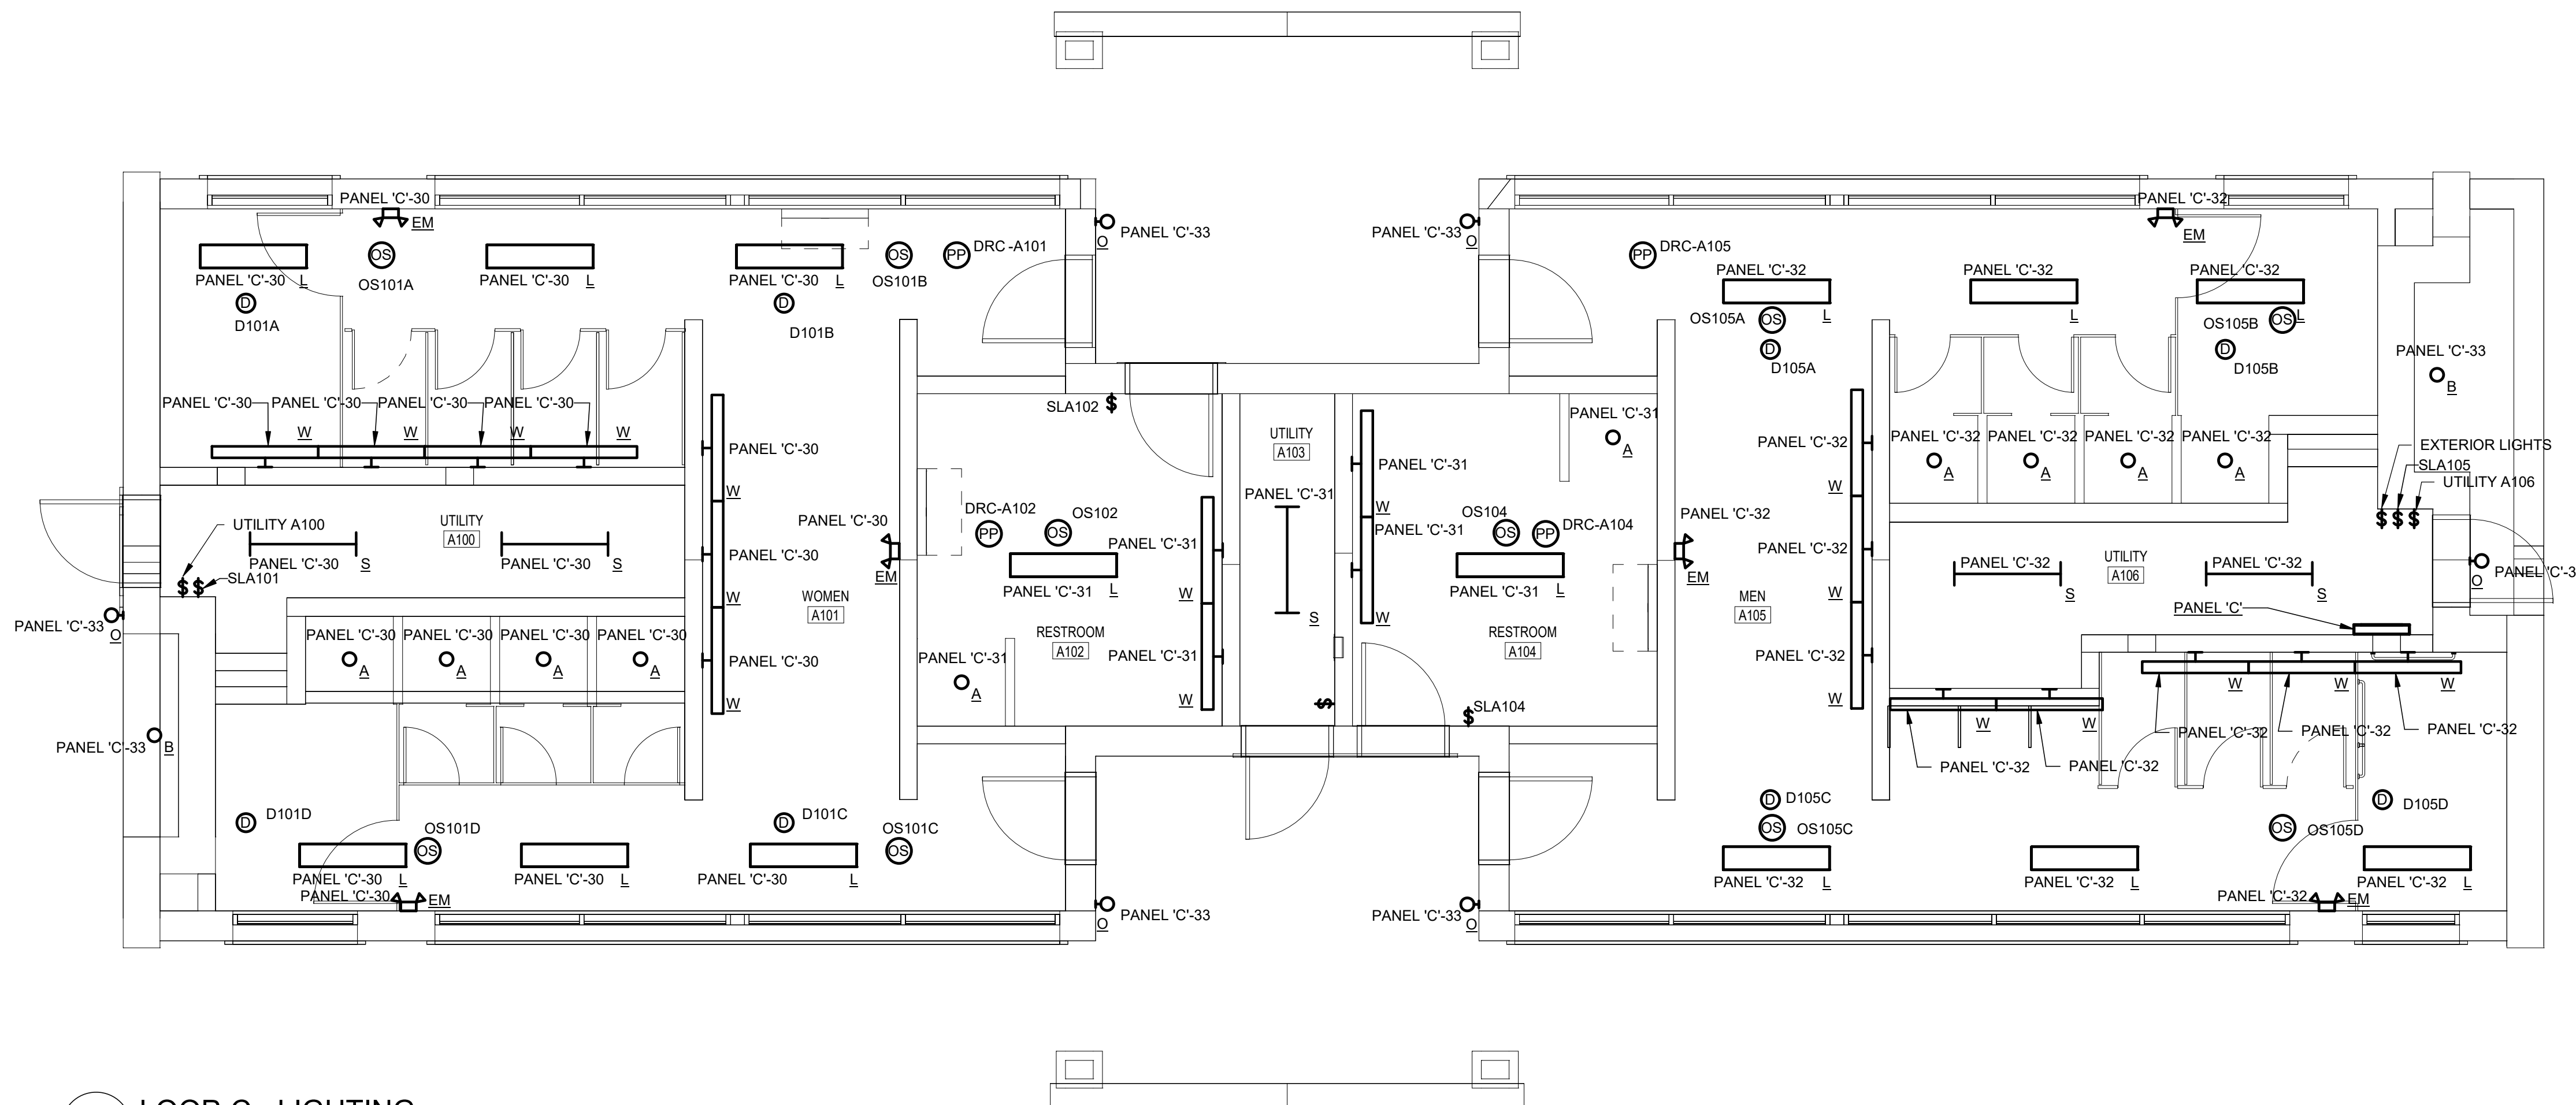

1 LOOP-C - LIGHTING
SCALE: 1/4" = 1'-0"

CONSTRUCTION DOCUMENTS

RECORD REVISIONS

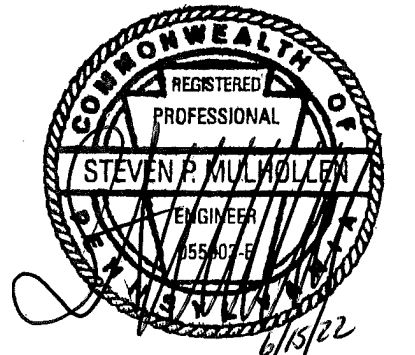

SIGNATURE DATE

SMP ARCHITECTS
1600 WALNUT STREET, SECOND FLOOR
PHILADELPHIA, PENNSYLVANIA

COMMONWEALTH OF PENNSYLVANIA
DEPARTMENT OF GENERAL SERVICES
HARRISBURG, PENNSYLVANIA

D.G.S. PROJECT No.
C-114-0006 PHASE 1

HICKORY RUN STATE PARK
LATRINE IMPROVEMENTS

DEPT of CONSERVATION AND NATURAL RESOURCES
WHITE HAVEN, CARBON COUNTY, PA

LOOP - C FLOOR PLAN - ELECTRICAL

VERIFY SCALE

BAR IS ONE (1) INCH LONG
ON ORIGINAL DRAWING: 0 1
IF BAR IS NOT ONE (1) INCH LONG, ADJUST SCALE ACCORDINGLY


CONTRACTOR SHALL FIELD VERIFY ALL DIMENSIONS. VARIANCE FROM CONTRACT DOCUMENTS NOT PERMITTED WITHOUT PROFESSIONAL & BUREAU OF CONSTRUCTION APPROVAL.

DRAWN BY G. GALLINA	DATE 06/17/2022
CHECKED BY S. MULHOLLEN	SCALE AS NOTED


DRAWING No.
E-2
137 OF 144

GENERAL ELECTRICAL NOTES:

- CONNECT BATTERY OPERATED EMERGENCY LIGHTING UNITS TYPE 'EM' AND ALL BATTERY OPERATED EXIST SIGNS TYPE 'EX1' TO LIGHTING CIRCUIT SERVING THE AREA. THIS CONNECTION SHALL BE AHEAD OF THE SWITCH LEG AND SHALL NOT BE SWITCHED IN ANY MANNER.

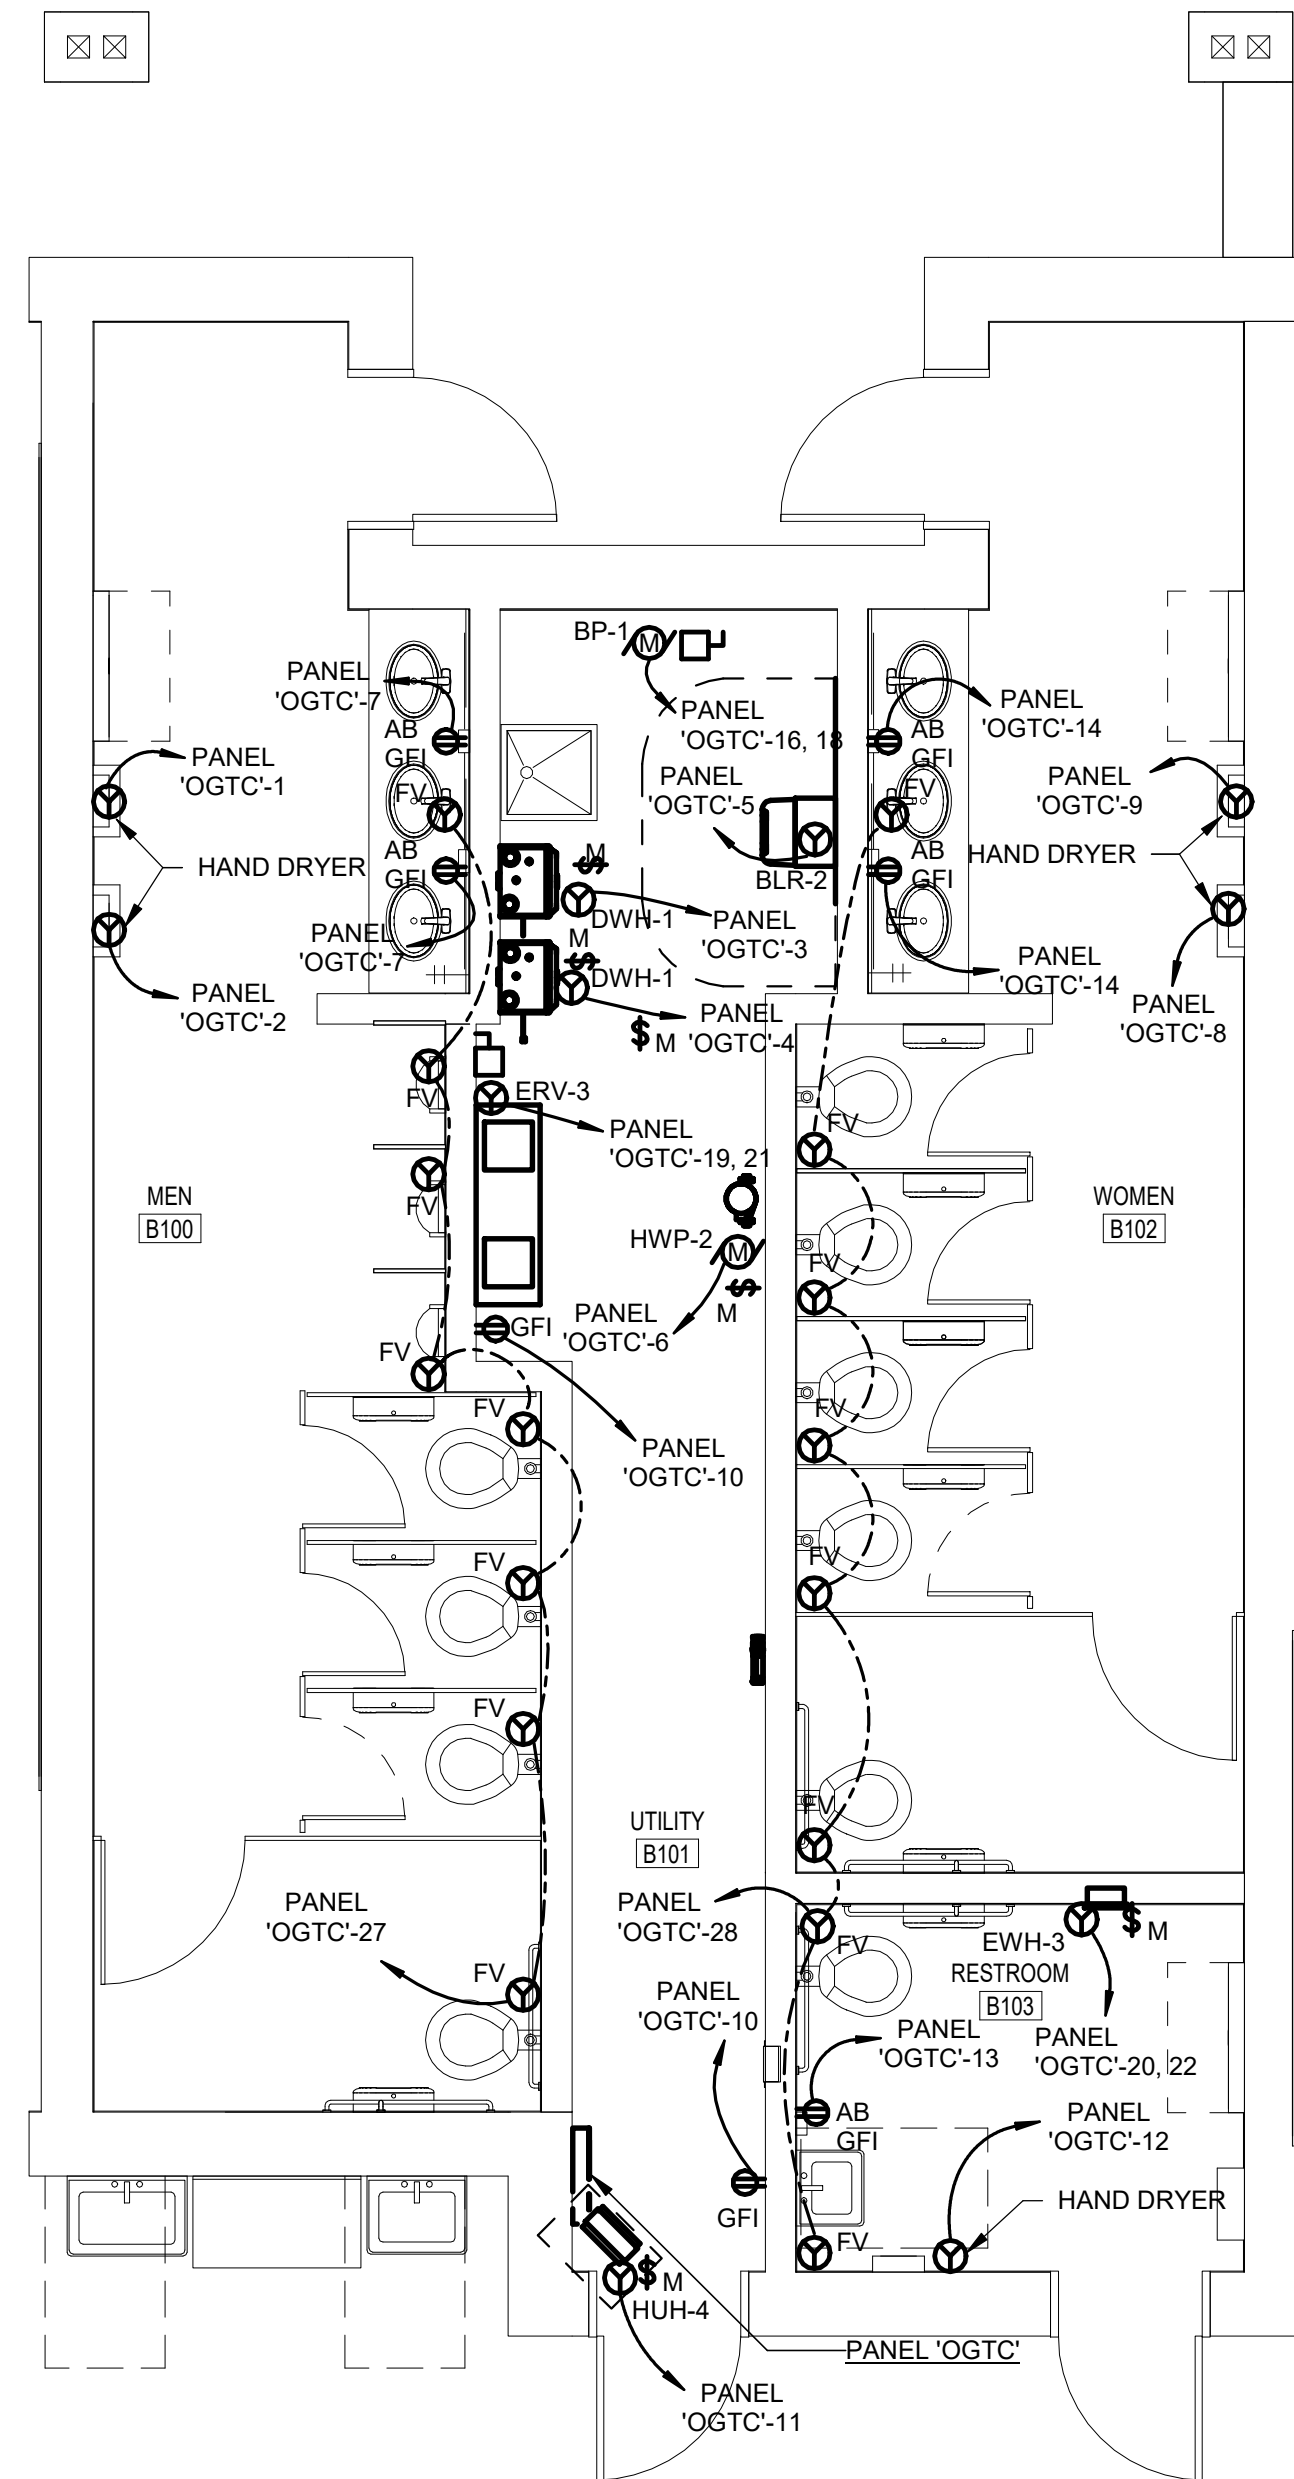

1 OGTC - POWER
SCALE: 1/4" = 1'-0"

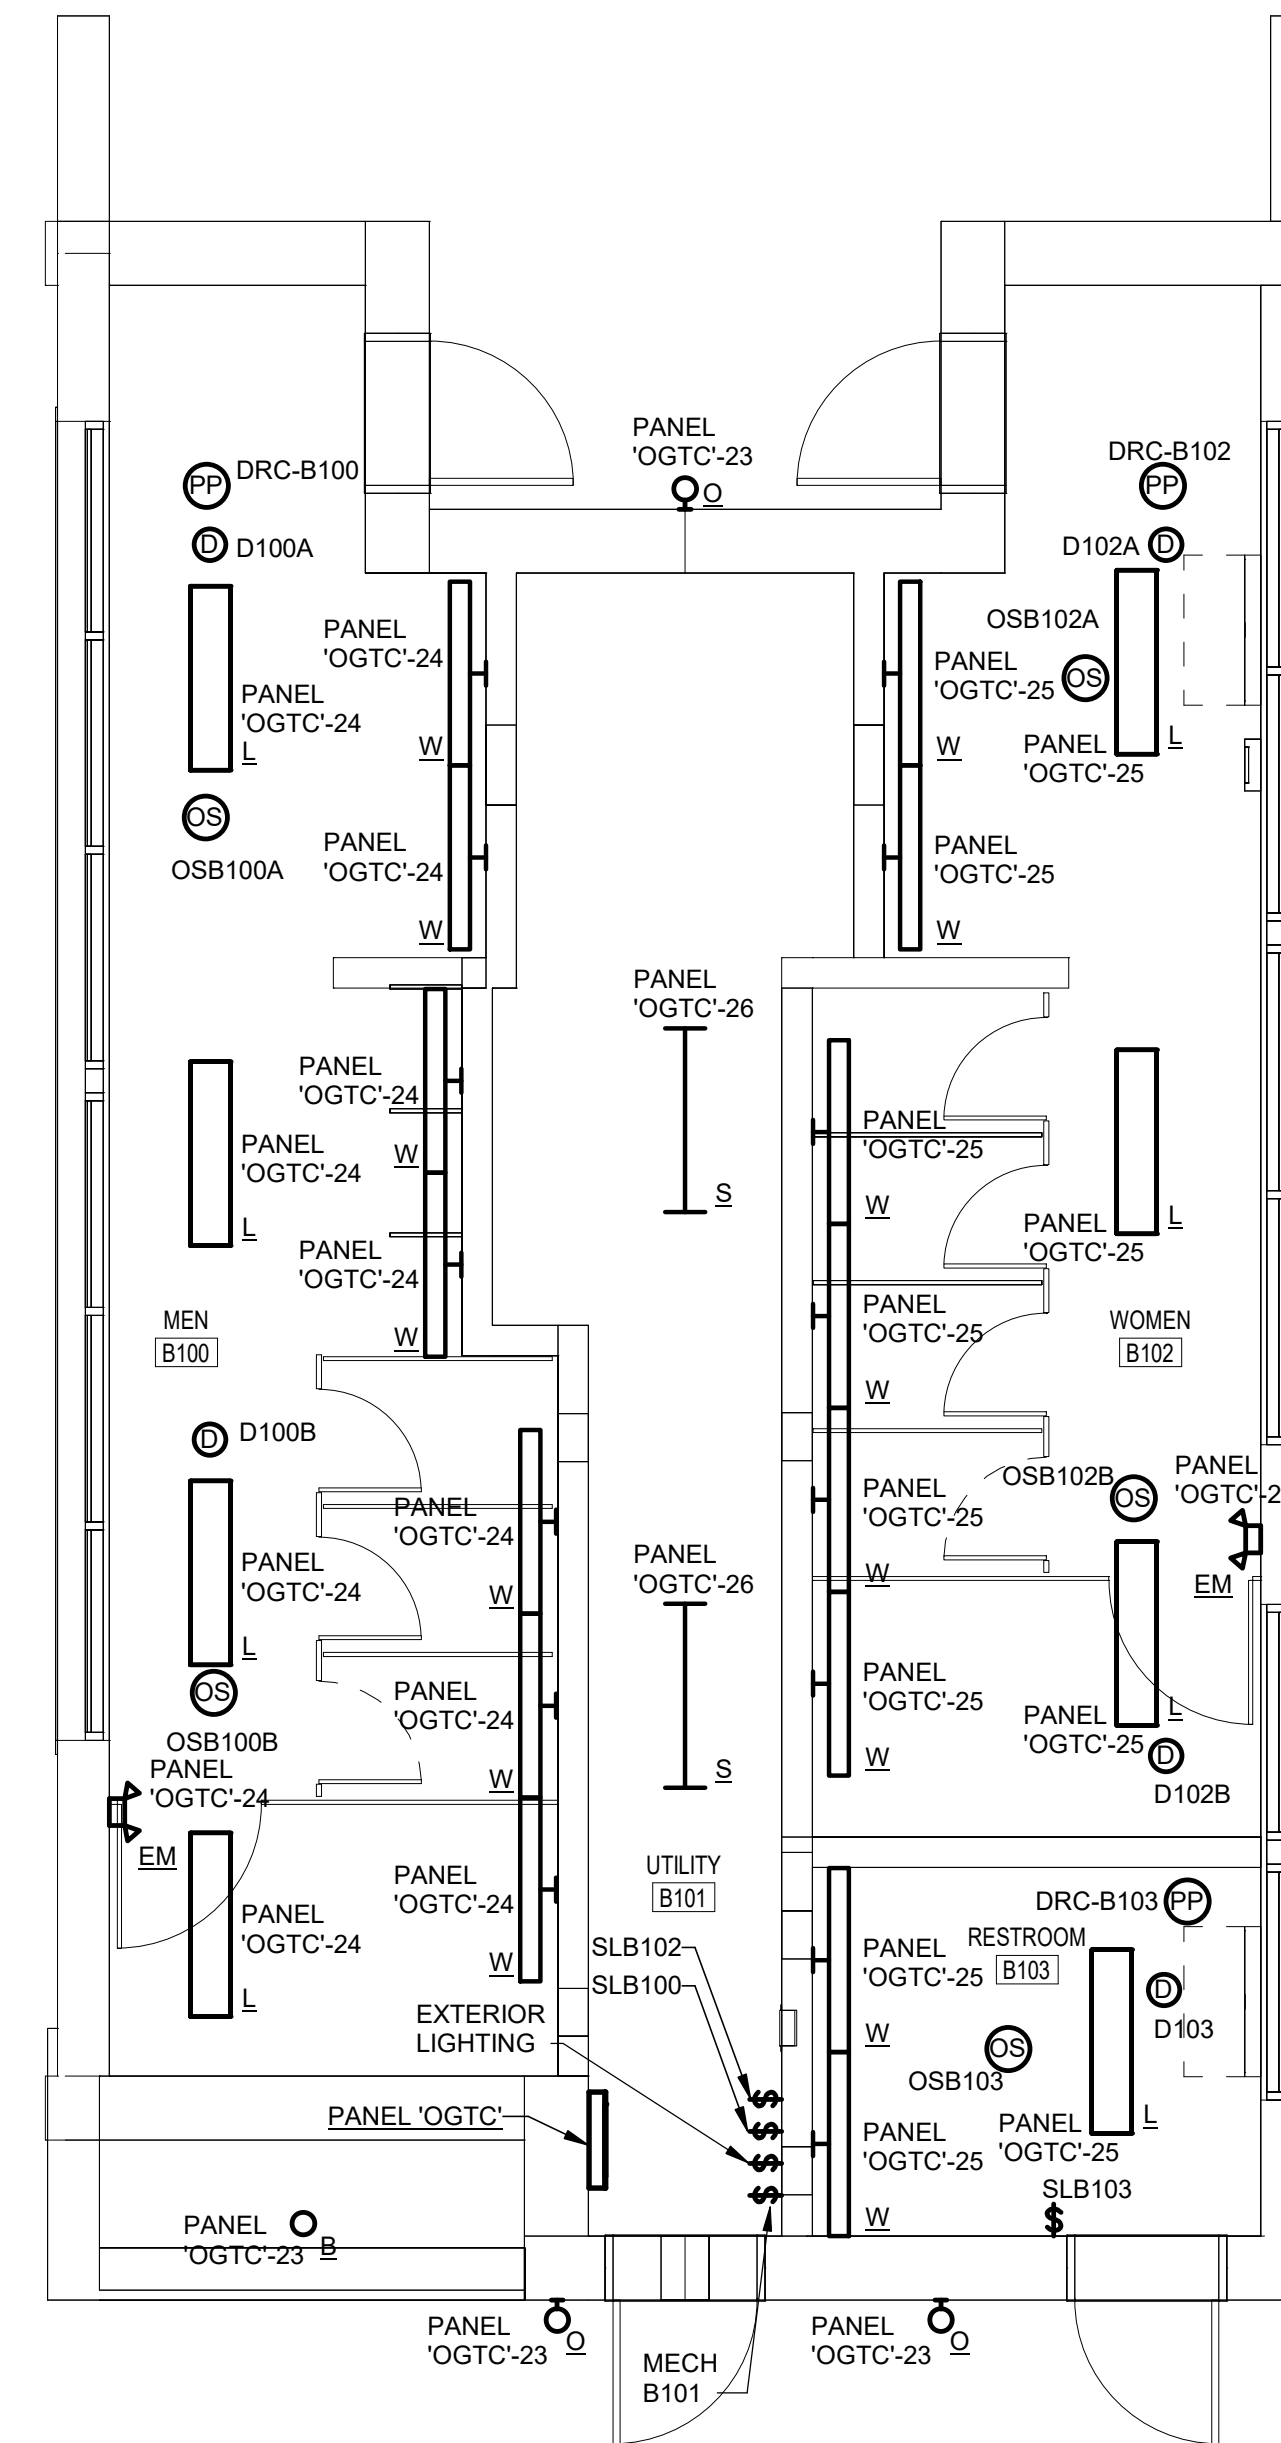

2 OGTC - LIGHTING
SCALE: 1/4" = 1'-0"

CONSTRUCTION DOCUMENTS

RECORD REVISIONS



SIGNATURE DATE

SMP ARCHITECTS
1600 WALNUT STREET, SECOND FLOOR
PHILADELPHIA, PENNSYLVANIA

COMMONWEALTH OF PENNSYLVANIA
DEPARTMENT OF GENERAL SERVICES
HARRISBURG, PENNSYLVANIA

D.G.S. PROJECT No.
C-114-0006 PHASE 1

HICKORY RUN STATE PARK
LATRINE IMPROVEMENTS

DEPT of CONSERVATION AND NATURAL RESOURCES
WHITE HAVEN, CARBON COUNTY, PA

OGTC FLOOR PLAN - ELECTRICAL

VERIFY SCALE


BAR IS ONE (1) INCH LONG
ON ORIGINAL DRAWING: 0 1
IF BAR IS NOT ONE (1) INCH LONG, ADJUST SCALE ACCORDINGLY

CONTRACTOR SHALL FIELD VERIFY ALL DIMENSIONS. VARIANCE FROM CONTRACT DOCUMENTS NOT PERMITTED WITHOUT PROFESSIONAL & BUREAU OF CONSTRUCTION APPROVAL.


DRAWN BY G. GALLINA	DATE 06/17/2022	DRAWING No. E-3
CHECKED BY S. MULHOLLEN	SCALE AS NOTED	

ALL WORK ON THIS SHEET IS BASE BID #3

- GENERAL ELECTRICAL NOTES:**
- CONNECT BATTERY OPERATED EMERGENCY LIGHTING UNITS TYPE 'EM' AND ALL BATTERY OPERATED EXIST SIGNS TYPE 'EX1' TO LIGHTING CIRCUIT SERVING THE AREA. THIS CONNECTION SHALL BE AHEAD OF THE SWITCH LEG AND SHALL NOT BE SWITCHED IN ANY MANNER.

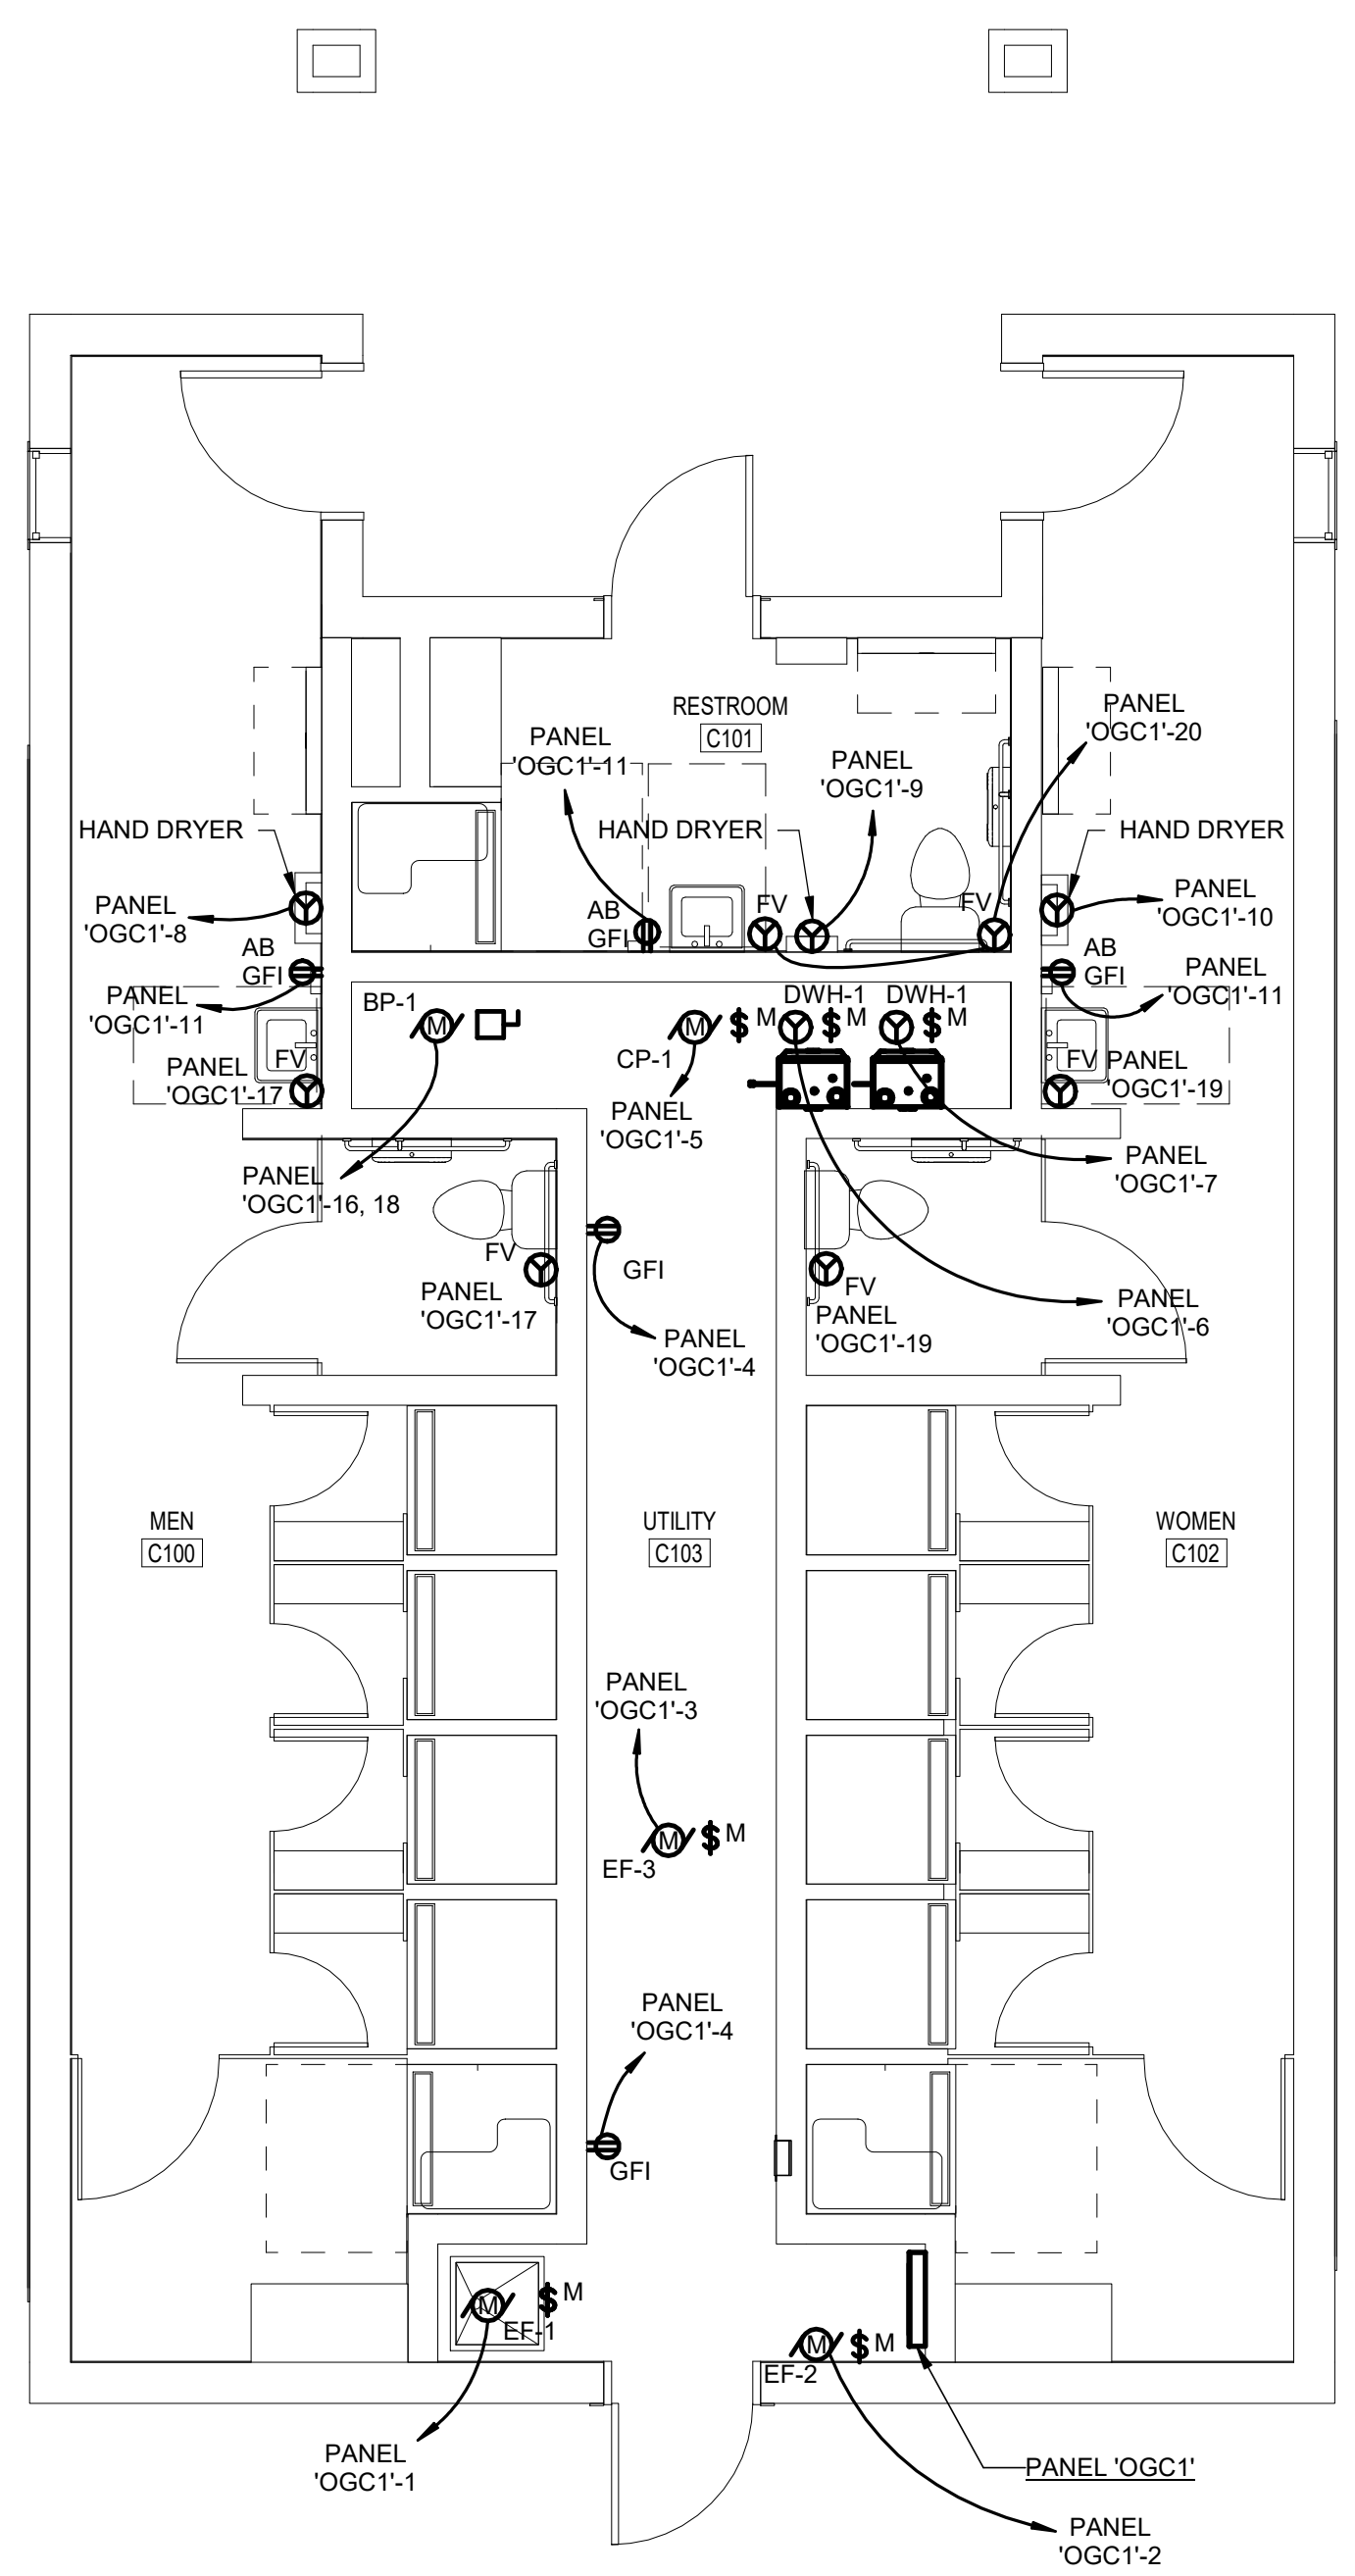

1 OGC - DADDY ALLEN - POWER
SCALE: 1/4" = 1'-0"

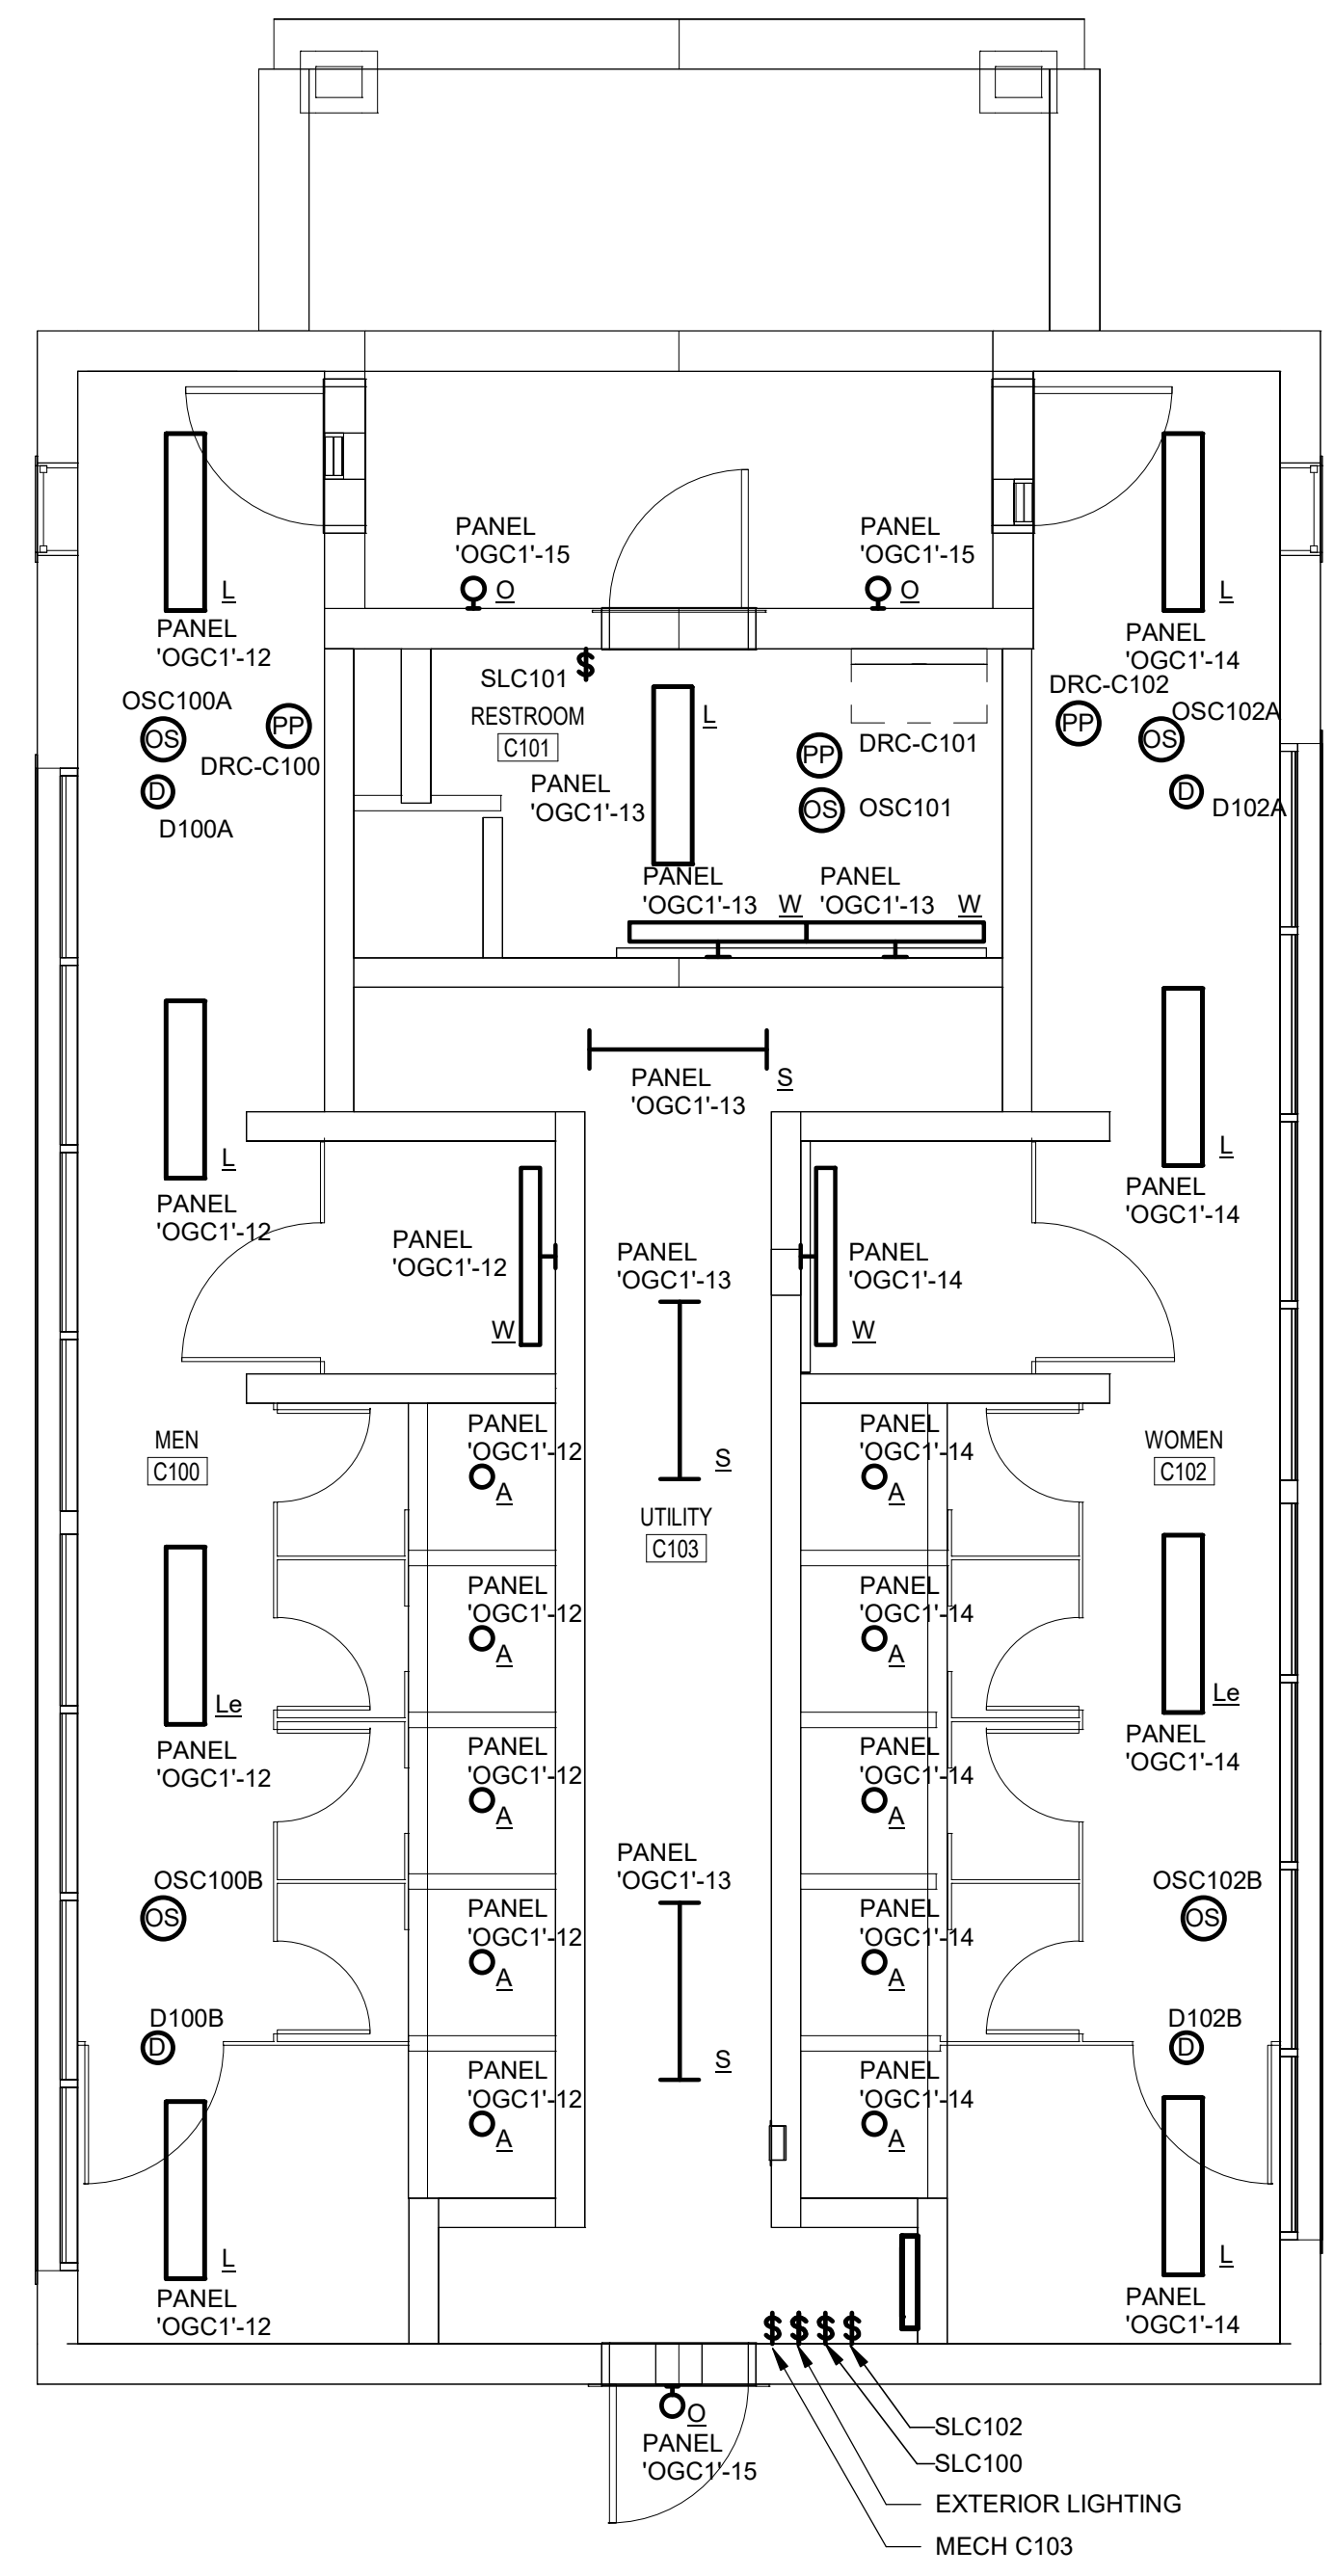

2 OGC - DADDY ALLEN - LIGHTING
SCALE: 1/4" = 1'-0"

CONSTRUCTION DOCUMENTS

RECORD REVISIONS



SIGNATURE DATE

SMP ARCHITECTS
1600 WALNUT STREET, SECOND FLOOR
PHILADELPHIA, PENNSYLVANIA

COMMONWEALTH OF PENNSYLVANIA
DEPARTMENT OF GENERAL SERVICES
HARRISBURG, PENNSYLVANIA

D.G.S. PROJECT No.
C-114-0006 PHASE 1

HICKORY RUN STATE PARK
LATRINE IMPROVEMENTS
DEPT of CONSERVATION AND NATURAL RESOURCES
WHITE HAVEN, CARBON COUNTY, PA
CAMP DADDY ALLEN FLOOR PLAN - ELECTRICAL

VERIFY SCALE
BAR IS ONE (1) INCH LONG
ON ORIGINAL DRAWING: 0 1
IF BAR IS NOT ONE (1) INCH LONG, ADJUST SCALE ACCORDINGLY
CONTRACTOR SHALL FIELD VERIFY ALL DIMENSIONS. VARIANCE FROM CONTRACT DOCUMENTS NOT PERMITTED WITHOUT PROFESSIONAL & BUREAU OF CONSTRUCTION APPROVAL.

DRAWN BY G. GALLINA	DATE 06/17/2022	DRAWING No. E-4
CHECKED BY S. MULHOLLEN	SCALE AS NOTED	

ALL WORK ASSOCIATED WITH SHEHAQUA IS BASE BID #2
ALL WORK ASSOCIATED WITH CAMP DADDY ALLEN IS BASE BID #3

PANEL PANEL 'C'									
LOCATION: UTILITY A106			VOLTAGE: 120/240 Single			A.I.C. RATING:			
SUPPLY FROM:			PHASES: 1			MAINS TYPE: MCB			
MOUNTING: SURFACE			WIRES: 3			MAINS RATING: 200 A			
ENCLOSURE: NEMA 1						MCB RATING: 200 A			
SERVICE ENTRANCE RATED									
CKT	CIRCUIT DESCRIPTION	TRIP	POLES	A	B	POLES	TRIP	CIRCUIT DESCRIPTION	CKT
1	RECEPTACLE	20 A	1	540	180		1	HUH-1	2
3	RECEPTACLE	20 A	1		360	360	1	RECEPTACLE	4
5	HWP-1	20 A	1	1656			1	HUH-2	6
7	BLR-1	20 A	1		480	540	1	RECEPTACLE	8
9	HAND DRYER	20 A	1	1000	0		1	SPARE	10
11	HAND DRYER	20 A	1		1000	0	1	SPARE	12
13	HAND DRYER	20 A	1	1000	1000		1	HAND DRYER	14
15	DWH-1	20 A	1		180	180	1	DWH-1	16
17	CP-1	20 A	1	250	1000		1	HAND DRYER	18
19	RECEPTACLE	20 A	1		0	0	1	RECEPTACLE	20
21	HAND DRYER	20 A	1	1000	1425		1	RECEPTACLE	22
23		25 A	2		2100	1425	2	BP-1	24
25	ERV-2			2100	1000				26
27		20 A	2		1000	1000	2	EW-1	28
29	EW-2			1000	581		1	LIGHTING	30
31	LIGHTING	20 A	1		271	609	1	LIGHTING	32
33	LIGHTING	20 A	1	306	150		1	AUTOMATIC FLUSH VALVE	34
35	AUTOMATIC FLUSH VALVE	20 A	1		100	2100	2	ERV-1	36
37	AUTOMATIC FLUSH VALVE	20 A	1	200	2100		1	SPARE	38
39	SPARE	20 A	1		0	0	1	SPARE	40
41	SPARE	20 A	1	0	0		1	SPARE	42
TOTAL LOAD:				17528 VA		11705 VA			
TOTAL AMPS:				146 A		98 A			

PANEL PANEL 'OGC1'									
LOCATION: UTILITY C103			VOLTAGE: 120/240 Single			A.I.C. RATING:			
SUPPLY FROM:			PHASES: 1			MAINS TYPE: MCB			
MOUNTING: SURFACE			WIRES: 3			MAINS RATING: 200 A			
ENCLOSURE: NEMA 1						MCB RATING: 200 A			
SERVICE ENTRANCE RATED									
CKT	CIRCUIT DESCRIPTION	TRIP	POLES	A	B	POLES	TRIP	CIRCUIT DESCRIPTION	CKT
1	EF-1	20 A	1	180	180		1	EF-2	2
3	EF-3	20 A	1		180	360	1	RECEPTACLE	4
5	CP-1	20 A	1	180	180		1	DWH-1	6
7	DWH-1	20 A	1		180	1000	1	HAND DRYER	8
9	HAND DRYER	20 A	1	1000	1000		1	HAND DRYER	10
11	RECEPTACLE	20 A	1		540	258	1	LIGHTING	12
13	LIGHTING	20 A	1	169	258		1	LIGHTING	14
15	LIGHTING	20 A	1		138	1425	2	BP-1	16
17	AUTOMATIC FLUSH VALVE	20 A	1	50	1425		1	SPARE	18
19	AUTOMATIC FLUSH VALVE	20 A	1		50	50	1	AUTOMATIC FLUSH VALVE	20
21	SPARE	20 A	1	0	0		1	SPARE	22
23	SPARE	20 A	1		0	0	1	SPARE	24
25	SPARE	20 A	1	0	0		1	SPARE	26
27	SPARE	20 A	1		0	0	1	SPARE	28
29	SPARE	20 A	1	0	0		1	SPARE	30
31	SPARE	20 A	1		0	0	1	SPARE	32
33	SPARE	20 A	1	0	0		1	SPARE	34
35	SPARE	20 A	1		0	0	1	SPARE	36
37	SPARE	20 A	1	0	0		1	SPARE	38
39	SPARE	20 A	1		0	0	1	SPARE	40
41	SPARE	20 A	1	0	0		1	SPARE	42
TOTAL LOAD:				4622 VA		4181 VA			
TOTAL AMPS:				39 A		35 A			

PANEL PANEL 'OGTC'									
LOCATION: UTILITY B101			VOLTAGE: 120/240 Single			A.I.C. RATING:			
SUPPLY FROM:			PHASES: 1			MAINS TYPE: MCB			
MOUNTING: SURFACE			WIRES: 3			MAINS RATING: 200 A			
ENCLOSURE: NEMA 1						MCB RATING: 200 A			
SERVICE ENTRANCE RATED									
CKT	CIRCUIT DESCRIPTION	TRIP	POLES	A	B	POLES	TRIP	CIRCUIT DESCRIPTION	CKT
1	HAND DRYER	20 A	1	1000	1000		1	HAND DRYER	2
3	DWH-1	20 A	1		180	180	1	DWH-1	4
5	BLR-2	20 A	1	180	480		1	HWP-2	6
7	RECEPTACLE	20 A	1		360	1000	1	HAND DRYER	8
9	HAND DRYER	20 A	1	1000	360		1	RECEPTACLE	10
11	HUH-4	20 A	1		180	1000	1	HAND DRYER	12
13	RECEPTACLE	20 A	1	180	360		1	RECEPTACLE	14
15	SPARE	20 A	1		0	1425	2	BP-1	16
17	SPARE	20 A	1	0	1425		1	SPARE	18
19		25 A	2		2100	1000	2	EW-3	20
21	ERV-3			2100	1000				22
23	LIGHTING	20 A	1		153	339	1	LIGHTING	24
25	LIGHTING	20 A	1	378	46		1	LIGHTING	26
27	AUTOMATIC FLUSH VALVE	20 A	1		200	200	1	AUTOMATIC FLUSH VALVE	28
29	SPARE	20 A	1	0	0		1	SPARE	30
31	SPARE	20 A	1		0	0	1	SPARE	32
33	SPARE	20 A	1	0	0		1	SPARE	34
35	SPARE	20 A	1		0	0	1	SPARE	36
37	SPARE	20 A	1	0	0		1	SPARE	38
39	SPARE	20 A	1		0	0	1	SPARE	40
41	SPARE	20 A	1	0	0		1	SPARE	42
TOTAL LOAD:				9509 VA		8317 VA			
TOTAL AMPS:				79 A		69 A			

PANEL PANEL 'OGC2'									
LOCATION: UTILITY C103			VOLTAGE: 120/240 Single			A.I.C. RATING:			
SUPPLY FROM:			PHASES: 1			MAINS TYPE: MCB			
MOUNTING: SURFACE			WIRES: 3			MAINS RATING: 200 A			
ENCLOSURE: NEMA 1						MCB RATING: 200 A			
SERVICE ENTRANCE RATED									
CKT	CIRCUIT DESCRIPTION	TRIP	POLES	A	B	POLES	TRIP	CIRCUIT DESCRIPTION	CKT
1	EF-4	20 A	1	180	180		1	EF-5	2
3	EF-6	20 A	1		180	360	1	RECEPTACLE	4
5	CP-1	20 A	1	180	180		1	DWH-1	6
7	DWH-1	20 A	1		180	1000	1	HAND DRYER	8
9	HAND DRYER	20 A	1	1000	1000		1	HAND DRYER	10
11	RECEPTACLE	20 A	1		540	258	1	LIGHTING	12
13	LIGHTING	20 A	1	158	258		1	LIGHTING	14
15	LIGHTING	20 A	1		138	1425	2	BP-1	16
17	AUTOMATIC FLUSH VALVE	20 A	1	50	1425		1	SPARE	18
19	AUTOMATIC FLUSH VALVE	20 A	1		50	50	1	AUTOMATIC FLUSH VALVE	20
21	SPARE	20 A	1	0	0		1	SPARE	22
23	SPARE	20 A	1		0	0	1	SPARE	24
25	SPARE	20 A	1	0	0		1	SPARE	26
27	SPARE	20 A	1		0	0	1	SPARE	28
29	SPARE	20 A	1	0	0		1	SPARE	30
31	SPARE	20 A	1		0	0	1	SPARE	32
33	SPARE	20 A	1	0	0		1	SPARE	34
35	SPARE	20 A	1		0	0	1	SPARE	36
37	SPARE	20 A	1	0	0		1	SPARE	38
39	SPARE	20 A	1		0	0	1	SPARE	40
41	SPARE	20 A	1	0	0		1	SPARE	42
TOTAL LOAD:				4611 VA		4181 VA			
TOTAL AMPS:				38 A		35 A			

CONSTRUCTION DOCUMENTS

RECORD REVISIONS



SIGNATURE DATE

SMP ARCHITECTS
1600 WALNUT STREET, SECOND FLOOR
PHILADELPHIA, PENNSYLVANIA

COMMONWEALTH OF PENNSYLVANIA
DEPARTMENT OF GENERAL SERVICES
HARRISBURG, PENNSYLVANIA

D.G.S. PROJECT No. C-114-0006 PHASE 1

HICKORY RUN STATE PARK
LATRINE IMPROVEMENTS

DEPT of CONSERVATION AND NATURAL RESOURCES
WHITE HAVEN, CARBON COUNTY, PA

ELECTRICAL SCHEDULES

VERIFY SCALE

BAR IS ONE (1) INCH LONG
ON ORIGINAL DRAWING: 1

IF BAR IS NOT ONE (1) INCH LONG, ADJUST SCALE ACCORDINGLY

CONTRACTOR SHALL FIELD VERIFY ALL DIMENSIONS. VARIANCE FROM CONTRACT DOCUMENTS NOT PERMITTED WITHOUT PROFESSIONAL & BUREAU OF CONSTRUCTION APPROVAL.

DRAWN BY: G. GALLINA
DATE: 06/17/2022
CHECKED BY: S. MULHOLLEN
SCALE: AS NOTED

DRAWING No. E-7
142 OF 144

DIGITAL ROOM CONTROLLER SCHEDULE						
DRC NUMBER	RELAYS	PANELBOARD	CIRCUIT #	AREA CONTROLLED	CONTROL	NOTES
LOOP C						
DRC-A101	1	C	30	WOMENS A101	LVS.OS.D	
DRC-A102	1	C	31	RESTROOM A102	LVS.OS	
DRC-A104	1	C	31	RESTROOM A104	LVS.OS	
DRC-A105	1	C	32	MENS A105	LVS.OS.D	
OGTC						
DRC-B100	1	OGTC	24	MEN B100	LVS.OS.D	
DRC-B102	1	OGTC	25	WOMEN B102	LVS.OS.D	
DRC-B103	1	OGTC	25	RESTROOM B103	LVS.OS.D	
CAMP DADDY ALLEN						
DRC-C100	1	OGC1	12	MENS C100	LVS.OS.D	
DRC-C101	1	OGC1	13	RESTROOM C101	LVS.OS	
DRC-C102	1	OGC1	14	WOMEN C102	LVS.OS.D	
CAMP SHEHAQUA						
DRC-D100	1	OGC2	12	MENS C100	LVS.OS.D	
DRC-D101	1	OGC2	13	RESTROOM C101	LVS.OS	
DRC-D102	1	OGC2	14	WOMEN C102	LVS.OS.D	
CONTROL PANEL NOTES: TC = TIME CLOCK, PC = PHOTOELECTRIC CELL, OS = OCCUPANCY SENSOR, LVS = LOW VOLTAGE SWITCH, D = DAYLIGHT SENSOR, PL = PLUG LOAD CONTROLLER						

ALL WORK ASSOCIATED WITH SHEHAQUA IS BASE BID #2
ALL WORK ASSOCIATED WITH CAMP DADDY ALLEN IS BASE BID #3


LIGHTING FIXTURE SCHEDULE									
TYPE	DESCRIPTION	LAMPS	VOLTAGE	BALLAST	MOUNTING	MANUFACTURER OR APPROVED EQUAL	CATALOG NUMBER OR APPROVED EQUAL	INPUT WATTS	COMMENTS
A	SURFACE MOUNTED SHOWER FIXTURE	-	120 V	-	SURFACE MOUNT	KENALL LUMINAIRE LED FAIL SAFE	MS11FL-PP-MW-20L35-DV SWP1212 MIN10 25W 35K MVOLT OP WHT G12-LD4-20-35-UNV-EDC1	24 W	
B	6" RECESSED CAN LIGHT RATED FOR EXTERIOR USE	-	120 V	-	RECESSED	KENALL GOTHAM FAIL SAFE	HADL6-X-12L-35K8-M-CS-G EY06SH 35/15 DFF SMO MVOLT EZ10 FLDBX-10-D010-FEU6B-1/2-80-35-F6L8XV-1-H	15 W	
EM	EMERGENCY BATTERY PACK	-	120 V	-	SURFACE MOUNT	KENALL ISOLITE BARRON	METELHC-24N-2-6 SLDT HZN NC 6V22W MBC L67 SD TP CP-EMW-25-LED	7 W	
L	LINEAR LED FIXTURE	-	120 V	-	SURFACE MOUNT	AXIS STARTEK COOPER	TB4SLED10008035SOXWUNVDP BEAMD 4' 1000 SD 35K PW SM U S124DS-C-1020D-8-35-1-U-DD-F-W	33 W	
Le	LINEAR LED FIXTURE	-	120 V	-	SURFACE MOUNT	AXIS STARTEK	BEAMD 4' 1000 SD 35K PW SM U EMB10	33 W	LOWER CASE e INDICATES FIXTURES WITH INTEGRAL EMERGENCY BATTERY PACKS.
O	WALL SCONCE	-	120 V	-	SURFACE MOUNT	GARDCO LITHONIA LEGION	101L-16L-1000-WW-G1-UNV-PBC-F1-OPTIONS WEDGE2 LED P5 30K 80CRI VW MVOLT SRM PE DDBXD 9120G2 045L 50 UNV BZ PC-BT-UNV	46 W	CONTROLLED VIA PHOTO CELL & MOTION CONTROLLED DIMMING TO 50%
S	LED STRIP LIGHT	-	120 V	-	SURFACE MOUNT	NEW STAR FAIL SAFE	MLHA5-48SP-MWPP45T-27/65K8-ATWVDV-DL V1CAN L2 27K/65K 1C RWIC UN WH DM1 TUNABLE WHITE HVSL2-4-LD4-HI-35-UNV-0-EDC1	23 W	
W	DIRECT INDIRECT WALL MOUNT FIXTURE	-	120 V	-	SURFACE MOUNT	AXIS STARTEK COOPER	TB2W0ILED4008035SOSWUNVDP1 SLIMDI 4' 400 SD CL 35K PW WM U S122DIW-485D-435V-8-35-X-U-DD-F-W	28 W	

NOTES:
1. THE CONTRACTOR IS RESPONSIBLE FOR COORDINATING ALL LIGHT FIXTURE COMPONENTS TO INSURE ALL NECESSARY PARTS ARE PROVIDED FOR A COMPLETE INSTALLATION.
2. REFER TO ARCHITECTURAL DRAWING FOR FIXTURE MOUNTING LOCATIONS.

MECHANICAL CONNECTIONS SCHEDULE																
MARK	LOAD				VOLTAGE	PHASE	WIRE SIZE	CONDUIT SIZE	VFD			SAFETY SWITCH		STARTER		COMMENTS
	KW	HP	MCA	MOP					ENCLOSURE	BY-PASS	ENCLOSURE	SIZE	NEMA/HP SIZE	ENCLOSURE		
BLR-1	0.50 kW	0	5	20	120 V	1	2#12 & 1#12 GRD	3/4"				MMS	20A			PROVIDED WITH LOCKABLE DISCONNECT SWITCH
BLR-2	0.50 kW	0	5	20	120 V	1	2#12 & 1#12 GRD	3/4"				MMS	20A			PROVIDED WITH LOCKABLE DISCONNECT SWITCH
BP-1	0.00 kW	2	12	30	240 V	1	2#10 & 1#10 GRD	3/4"				NEMA 1	30A			
BP-1	0.00 kW	2	12	30	240 V	1	2#10 & 1#10 GRD	3/4"				NEMA 1	30A			
BP-1	0.00 kW	2	12	30	240 V	1	2#10 & 1#10 GRD	3/4"				NEMA 1	30A			
BP-1	0.00 kW	2	12	30	240 V	1	2#10 & 1#10 GRD	3/4"				NEMA 1	30A			
CP-1	0.00 kW	1/25	2	20	120 V	1	2#12 & 1#12 GRD	3/4"				MMS	20A			
CP-1	0.00 kW	1/25	2	20	120 V	1	2#12 & 1#12 GRD	3/4"				MMS	20A			
CP-1	0.00 kW	1/25	2	20	120 V	1	2#12 & 1#12 GRD	3/4"				MMS	20A			
DWH-1	0.50 kW	0	0	0	120 V	1	2#12 & 1#12 GRD	3/4"				MMS	20A			
DWH-1	0.50 kW	0	0	0	120 V	1	2#12 & 1#12 GRD	3/4"				MMS	20A			
DWH-1	0.50 kW	0	0	0	120 V	1	2#12 & 1#12 GRD	3/4"				MMS	20A			
DWH-1	0.50 kW	0	0	0	120 V	1	2#12 & 1#12 GRD	3/4"				MMS	20A			
EF-1	0.00 kW	1/10	2.2	20	120 V	1	2#12 & 1#12 GRD	3/4"				MMS	20A			W/ HOA
EF-2	0.00 kW	1/10	2.2	20	120 V	1	2#12 & 1#12 GRD	3/4"				MMS	20A			W/ HOA
EF-3	0.00 kW	1/10	2.2	20	120 V	1	2#12 & 1#12 GRD	3/4"				MMS	20A			W/ HOA
EF-4	0.00 kW	1/10	2.2	20	120 V	1	2#12 & 1#12 GRD	3/4"				MMS	20A			W/ HOA
EF-5	0.00 kW	1/10	2.2	20	120 V	1	2#12 & 1#12 GRD	3/4"				MMS	20A			W/ HOA
EF-6	0.00 kW	1/10	2.2	20	120 V	1	2#12 & 1#12 GRD	3/4"				MMS	20A			W/ HOA
ERV-1	4.50 kW	-	0	0	240 V	1	2#10 & 1#10 GRD	3/4"				NEMA 1	30A			W/ HOA
ERV-2	4.50 kW	-	0	0	240 V	1	2#10 & 1#10 GRD	3/4"				NEMA 1	30A			W/ HOA
ERV-3	4.50 kW	-	0	0	240 V	1	2#10 & 1#10 GRD	3/4"				NEMA 1	30A			W/ HOA
EWH-1	2.00 kW	1/4	0	0	240 V	1	2#12 & 1#12 GRD	3/4"				NEMA 1	30A			
EWH-2	2.00 kW	1/4	0	0	240 V	1	2#12 & 1#12 GRD	3/4"				NEMA 1	30A			
EWH-3	2.00 kW	1/4	0	0	240 V	1	2#12 & 1#12 GRD	3/4"				NEMA 1	30A			
HUH-1	0.50 kW	1/10	0	0	120 V	1	2#12 & 1#12 GRD	3/4"				MMS	20A			
HUH-2	0.50 kW	1/10	0	0	120 V	1	2#12 & 1#12 GRD	3/4"				MMS	20A			
HUH-3	0.50 kW	1/10	0	0	120 V	1	2#12 & 1#12 GRD	3/4"				MMS	20A			
HUH-4	0.50 kW	1/10	0	0	120 V	1	2#12 & 1#12 GRD	3/4"				MMS	20A			
HWP-1	0.00 kW	3/4	13	20	120 V	1	2#12 & 1#12 GRD	3/4"				MMS	20A			
HWP-2	0.00 kW	1/2	9.8	20	120 V	1	2#12 & 1#12 GRD	3/4"				MMS	20A			

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SIGNATURE DATE

SMP ARCHITECTS
1600 WALNUT STREET, SECOND FLOOR
PHILADELPHIA, PENNSYLVANIA

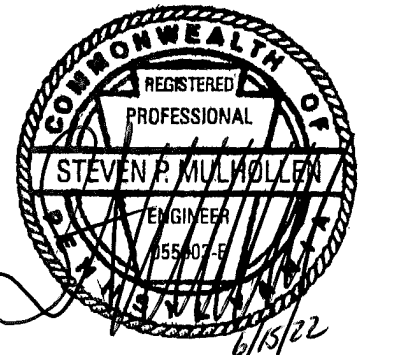COMMONWEALTH OF PENNSYLVANIA
DEPARTMENT OF GENERAL SERVICES
HARRISBURG, PENNSYLVANIA

D.G.S. PROJECT No. C-114-0006 PHASE 1

HICKORY RUN STATE PARK
LATRINE IMPROVEMENTS
DEPT of CONSERVATION AND NATURAL RESOURCES
WHITE HAVEN, CARBON COUNTY, PA

ELECTRICAL SCHEDULES

VERIFY SCALE

BAR IS ONE (1) INCH LONG
ON ORIGINAL DRAWING: 0 1
IF BAR IS NOT ONE (1) INCH LONG, ADJUST SCALE ACCORDINGLY

CONTRACTOR SHALL FIELD VERIFY ALL DIMENSIONS. VARIANCE FROM CONTRACT DOCUMENTS NOT PERMITTED WITHOUT PROFESSIONAL & BUREAU OF CONSTRUCTION APPROVAL.	DRAWN BY G. GALLINA	DATE 06/17/2022	DRAWING No. E-8
CHECKED BY S. MULHOLLEN	SCALE AS NOTED	143 OF 144	

ALL WORK ASSOCIATED WITH SHEHAQUA IS BASE BID #2
 ALL WORK ASSOCIATED WITH CAMP DADDY ALLEN IS BASE BID #3

LOW VOLTAGE CONTROL STATION SCHEDULE				
CONTROL STATION NUMBER	DESCRIPTION	BUTTON NUMBER	RELAY PANEL / ZONES	NOTES
LOOP C				
SLA101	WALL STATION	1	ON	CONTROLS A101 (LOCATED IN UTILITY ROOM)
		2	OFF	
SLA102	WALL STATION	1	ON	CONTROLS A102
		2	OFF	
SLA104	WALL STATION	1	ON	CONTROLS A104
		2	OFF	
SLA105	WALL STATION	1	ON	CONTROLS A105 (LOCATED IN UTILITY ROOM)
		2	OFF	
OS101A	OCCUPANCY/DUAL	-	DRC A101	MANUAL ON/AUTO OFF (PROVIDED WITH HVAC CONTACT)
OS101B	OCCUPANCY/DUAL	-	DRC A101	MANUAL ON/AUTO OFF (PROVIDED WITH HVAC CONTACT)
OS101C	OCCUPANCY/DUAL	-	DRC A101	MANUAL ON/AUTO OFF (PROVIDED WITH HVAC CONTACT)
OS101D	OCCUPANCY/DUAL	-	DRC A101	MANUAL ON/AUTO OFF (PROVIDED WITH HVAC CONTACT)
OS102	OCCUPANCY/DUAL	-	DRC A102	MANUAL ON/AUTO OFF (PROVIDED WITH HVAC CONTACT)
OS104	OCCUPANCY/DUAL	-	DRC A104	MANUAL ON/AUTO OFF (PROVIDED WITH HVAC CONTACT)
OS105A	OCCUPANCY/DUAL	-	DRC A105	MANUAL ON/AUTO OFF (PROVIDED WITH HVAC CONTACT)
OS105B	OCCUPANCY/DUAL	-	DRC A105	MANUAL ON/AUTO OFF (PROVIDED WITH HVAC CONTACT)
OS105C	OCCUPANCY/DUAL	-	DRC A105	MANUAL ON/AUTO OFF (PROVIDED WITH HVAC CONTACT)
OS105D	OCCUPANCY/DUAL	-	DRC A105	MANUAL ON/AUTO OFF (PROVIDED WITH HVAC CONTACT)
D101A	DAYLIGHT SENSOR	-	DRC A101	DIMMING
D101B	DAYLIGHT SENSOR	-	DRC A101	DIMMING
D101C	DAYLIGHT SENSOR	-	DRC A101	DIMMING
D101D	DAYLIGHT SENSOR	-	DRC A101	DIMMING
D105A	DAYLIGHT SENSOR	-	DRC A105	DIMMING
D105B	DAYLIGHT SENSOR	-	DRC A105	DIMMING
D105C	DAYLIGHT SENSOR	-	DRC A105	DIMMING
D105D	DAYLIGHT SENSOR	-	DRC A105	DIMMING
OGTC				
SLB100	WALL STATION	1	ON	CONTROLS B100 (LOCATED IN UTILITY ROOM)
		2	OFF	
SLB102	WALL STATION	1	ON	CONTROLS B102 (LOCATED IN UTILITY ROOM)
		2	OFF	
SLB103	WALL STATION	1	ON	CONTROLS B103
		2	OFF	
OSB100A	OCCUPANCY/DUAL	-	DRC B100	MANUAL ON/AUTO OFF (PROVIDED WITH HVAC CONTACT)
OSB100B	OCCUPANCY/DUAL	-	DRC B100	MANUAL ON/AUTO OFF (PROVIDED WITH HVAC CONTACT)
OSB102A	OCCUPANCY/DUAL	-	DRC B102	MANUAL ON/AUTO OFF (PROVIDED WITH HVAC CONTACT)
OSB102B	OCCUPANCY/DUAL	-	DRC B102	MANUAL ON/AUTO OFF (PROVIDED WITH HVAC CONTACT)
OSB103	OCCUPANCY/DUAL	-	DRC B103	MANUAL ON/AUTO OFF (PROVIDED WITH HVAC CONTACT)
D100A	DAYLIGHT SENSOR	-	DRC B100	DIMMING
D100B	DAYLIGHT SENSOR	-	DRC B100	DIMMING
D102A	DAYLIGHT SENSOR	-	DRC B102	DIMMING
D102B	DAYLIGHT SENSOR	-	DRC B102	DIMMING
D103	DAYLIGHT SENSOR	-	DRC B103	DIMMING
CAMP DADDY ALLEN				
SLC100	WALL STATION	1	ON	CONTROLS C100 (LOCATED IN UTILITY ROOM)
		2	OFF	
SLC101	WALL STATION	1	ON	CONTROLS C101
		2	OFF	
SLC102	WALL STATION	1	ON	CONTROLS C102 (LOCATED IN UTILITY ROOM)
		2	OFF	
OSC100A	OCCUPANCY/DUAL	-	DRC C100	MANUAL ON/AUTO OFF (PROVIDED WITH HVAC CONTACT)
OSC100B	OCCUPANCY/DUAL	-	DRC C100	MANUAL ON/AUTO OFF (PROVIDED WITH HVAC CONTACT)
OSC101	OCCUPANCY/DUAL	-	DRC C101	MANUAL ON/AUTO OFF (PROVIDED WITH HVAC CONTACT)
OSC102A	OCCUPANCY/DUAL	-	DRC C102	MANUAL ON/AUTO OFF (PROVIDED WITH HVAC CONTACT)
OSC102B	OCCUPANCY/DUAL	-	DRC C102	MANUAL ON/AUTO OFF (PROVIDED WITH HVAC CONTACT)
D100A	DAYLIGHT SENSOR	-	DRC C100	DIMMING
D100B	DAYLIGHT SENSOR	-	DRC C100	DIMMING
D101	DAYLIGHT SENSOR	-	DRC C101	DIMMING
D102A	DAYLIGHT SENSOR	-	DRC C102	DIMMING
D102B	DAYLIGHT SENSOR	-	DRC C102	DIMMING
CAMP SHEHAQUA				
SLD100	WALL STATION	1	ON	CONTROLS C100 (LOCATED IN UTILITY ROOM)
		2	OFF	
SLD101	WALL STATION	1	ON	CONTROLS C101
		2	OFF	
SLD102	WALL STATION	1	ON	CONTROLS C102 (LOCATED IN UTILITY ROOM)
		2	OFF	
OSD100A	OCCUPANCY/DUAL	-	DRC D100	MANUAL ON/AUTO OFF (PROVIDED WITH HVAC CONTACT)
OSD100B	OCCUPANCY/DUAL	-	DRC D100	MANUAL ON/AUTO OFF (PROVIDED WITH HVAC CONTACT)
OSD101	OCCUPANCY/DUAL	-	DRC D101	MANUAL ON/AUTO OFF (PROVIDED WITH HVAC CONTACT)
OSD102A	OCCUPANCY/DUAL	-	DRC D102	MANUAL ON/AUTO OFF (PROVIDED WITH HVAC CONTACT)
OSD102B	OCCUPANCY/DUAL	-	DRC D102	MANUAL ON/AUTO OFF (PROVIDED WITH HVAC CONTACT)
D100A	DAYLIGHT SENSOR	-	DRC D100	DIMMING
D100B	DAYLIGHT SENSOR	-	DRC D100	DIMMING
D101	DAYLIGHT SENSOR	-	DRC D101	DIMMING
D102A	DAYLIGHT SENSOR	-	DRC D102	DIMMING
D102B	DAYLIGHT SENSOR	-	DRC D102	DIMMING

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SIGNATURE DATE

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COMMONWEALTH OF PENNSYLVANIA
 DEPARTMENT OF GENERAL SERVICES
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LATRINE IMPROVEMENTS

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	CHECKED BY S. MULHOLLEN	SCALE AS NOTED	