REPAIRS TO BUILDING 67 DEFENSE DISTRIBUTION CENTER SUSQUEHANNA NEW CUMBERLAND, PA 17070

PROJECT DESCRIPTION: SCOPE OF WORK

- 1. THE WORK SHOWN ON THESE DRAWINGS CONSISTS OF THE FOLLOWING ITEMS, BUT IS NOT INTENDED TO BE LIMITED TO THESE ITEMS ALONE:
- 1.1. OFFICE AND BREAK ROOM REMOVE ASBESTOS CONTAINING FLOOR TILE (ACT) INCLUDING WALL BASE AS INDICATED. PROVIDE FLOOR TILE AND WALL BASE AS INDICATED. REMOVE AND REPLACE EXISTING ACOUSTICAL SUSPENDED CEILING, BATT INSULATION, LIGHTING AND HVAC COMPONENTS AS INDICATED. PROVIDE FLOOR AND WALL CABINETS AND COUNTERTOP AS INDICATED. REMOVE, SALVAGE AND RELOCATE WATER FOUNTAIN AS INDICATED. REMOVE AND REPLACE EXISTING EXTERIOR DOORS, FRAMES AND HARDWARE AS INDICATED. REMOVE EXISTING INTERIOR DOOR AS INDICATED. PREPARE AND PAINT WALLS AS INDICATED. PROVIDE ELECTRICAL AND HVAC REPAIRS AND REPLACEMENTS AS REQUIRED.
- 1.2. JANITOR'S CLOSET AND HALLWAY REMOVE ASBESTOS FLOOR TILE INCLUDING WALL BASE AS INDICATED. PROVIDE FLOOR TILE AND WALL BASE AS INDICATED. REMOVE AND REPLACE EXISTING LIGHTING AND HVAC COMPONENTS AS INDICATED. PREPARE AND PAINT WALLS AND CEILINGS AS INDICATED. REMOVE EXISTING HOT WATER HEATER AND REPLACE IN MECHANICAL ROOM AS INDICATED. PROVIDE ELECTRICAL AND HVAC REPAIRS AND REPLACEMENTS AS REQUIRED.
- 1.3. MEN'S AND WOMEN'S RESTROOM REMOVE AND REPLACE PLUMBING FIXTURES AS INDICATED. REMOVE AND REPLACE TOILET PARTITIONS AS INDICATED. PATCH AND CLEAN FLOORS AND WALLS. PATCH AND PAINT CEILINGS AS INDICATED. PROVIDE ELECTRICAL AND HVAC REPAIRS AND REPLACEMENTS AS REQUIRED.
- 1.4. FURNITURE REMOVE EXISTING FURNITURE AS INDICATED. PROVIDE FOUR WORK STATIONS AND OTHER FURNITURE AS INDICATED. PROVIDE ELECTRICAL WORK ASSOCIATED WITH FURNITURE AS INDICATED. PROVIDE COMMUNICATION CABLING AS INDICATED.
- 2. THE ABOVE SUMMARY OF WORK IS FOR THE PURPOSE OF GENERAL INFORMATION AND IS NOT INTENDED TO INCLUDE AND DESCRIBE EVERY FEATURE OR ITEM OR TO DEFINE THE SCOPE OF WORK. REFER TO THE CONTRACT DOCUMENTS WHICH INCLUDE ALL THE REQUIREMENTS FOR THE PROJECT TO BE CONSIDERED COMPLETE AND USEABLE. THE PROJECT MUST BE ACCEPTED AND APPROVED BY THE GOVERNMENT TO BE CONSIDERED COMPLETE AND USEABLE.


SPECIAL CLAUSES (SC): SUPPLEMENTAL REQUIREMENTS


- SC-1 PROTECTION OF GOVERNMENT PERSONNEL SHALL INCLUDE THE FOLLOWING:
 - A. WITHIN ALL AREAS LOCATED OUTSIDE ACTIVE CONSTRUCTION PHASE AREAS, FIRE ALARMS, FIRE EXTINGUISHERS, ELECTRICAL PANELS, EXIT WAYS AND MEANS OF EGRESS, INCLUDING AISLES WHICH LEAD TO EXITS. SHALL BE KEPT OPEN TO BUILDING OCCUPANTS AT ALL TIMES.
 - B. THE CONTRACTOR SHALL ESTABLISH A SAFETY ZONE AT INTERIOR AND EXTERIOR LOCATIONS AS DIRECTED BY THE COR. THE SPECIFIED LOCATIONS SHALL BE CLEARLY MARKED WITH SIGNS, CAUTION TAPE, SAFETY FENCE, BARRICADES, ETC. AS REQUIRED. IN AREAS CORDONED OFF ALONG THEIR PERIMETER USING YELLOW CAUTION TAPE, THE TAPE SHALL BE MOUNTED AT STANDARD HANDRAIL HEIGHT. LOCATIONS INCLUDE BUT ARE NOT LIMITED TO THE FOLLOWING; MATERIAL OFFLOADING AREA(S), STAGING AREA(S) AND ALL ACTIVE CONSTRUCTION AREAS. PARTICULAR ATTENTION SHALL BE GIVEN TO THOSE AREAS INVOLVING EXCAVATIONS AND OVERHEAD STRUCTURAL WORK.
 - C. PROTECTION FROM CONSTRUCTION MATERIAL EMISSIONS, AS RECOMMENDED ON THE PRODUCT MATERIAL SAFETY DATA SHEETS. PROTECTION TO INCLUDE THE FOLLOWING:
 - 1. THE PROVISION OF ADEQUATE VENTILATION OF THE INTERIOR PART OF THE SITE TO THE
 - D. PROTECTION FROM DUST GENERATED BY CONSTRUCTION. THE CONTRACTOR SHALL MAKE EVERY EFFORT TO CONTAIN DUST AND DEBRIS.
 - E. DAILY INSPECTION OF THESE PROVISIONS TO ENSURE COMPLIANCE WITH REQUIREMENTS.
 - F. ADJACENT AND ADJOINING HALLWAYS, STREETS, FIRE LANES, AND LOADING DOCK APPROACHES SHALL REMAIN OPEN AT ALL TIMES.
 - G. ASBESTOS MANAGEMENT PLAN WAS REVIEWED, AND BREAK ROOM VCT MATERIALS ARE IDENTIFIED AS ASBESTOS CONTAINING MATERIAL (ACM). REMOVAL AND DISPOSAL REQUIRES AN ASBESTOS CONTRACTOR TO CONDUCT THAT WORK IAW STATE AND FEDERAL REGULATIONS. PROVIDE APPLICABLE PLAN AS PER FEDERAL REGULATIONS.
- SC-2 INTERIOR STORAGE SPACE IS LIMITED TO THE AREA WITHIN THE SPACES TO BE REPAIRED.
- SC-3 THE LIMIT OF WORK FOR INTERIOR WORK IS THE AREA WITHIN THE SPACES TO BE REPAIRED.
- SC-4 AVAILABILITY OF WORK AREA IS AS FOLLOWS:
- A. BLDG 67 IN ITS ENTIRETY.
- SC-5 SEE SPECIFICATION SECTION 011400-WORK RESTRICTIONS FOR "HOURS OF WORK".
- SC-6
 THE CONTRACTOR SHALL TAKE ALL NECESSARY PRECAUTIONS TO AVOID DAMAGE TO THE EXISTING FACILITY, EQUIPMENT AND FURNISHINGS. DAMAGED ITEMS SHALL BE REPAIRED OR REPLACED AS APPROVED BY THE CONTRACTING OFFICER AT NO ADDITIONAL COST TO THE GOVERNMENT. THE CONTRACTOR SHALL CAREFULLY COORDINATE THE WORK OF THIS CONTRACT WITH ALL OTHER WORK BEING CONDUCTED BY OTHER CONTRACTORS OR GOVERNMENT FORCES.
- SC-7 THE CONTRACTOR SHALL PROVIDE DAILY CLEANUP OF THE PROJECT AREA INCLUDING BUT NOT LIMITED TO REMOVAL OF DEBRIS FROM THE EXTERIOR OF THE BUILDING. ALL CONSTRUCTION DEBRIS SHALL BE DEPOSITED IN THE DUMPSTERS. CONTRACTOR IS RESPONSIBLE TO PROVIDE DUMPSTERS AND TIPPING FEES.
- SC-8 ALL HOT WORK CONDUCTED ON SITE REQUIRES A HOT WORK PERMIT ISSUED BY THE DDSP FIRE DEPARTMENT BEFORE WORK STARTS. HOT WORK PERMITS ARE ISSUED ON A DAILY BASIS AND ARE ONLY VALID FOR THEIR DATE OF ISSUE. THERE ARE NO LONG-TERM HOT WORK PERMITS.

SAFETY AND HEALTH REQUIREMENTS

- 1. ALL CONSTRUCTION PRACTICES SHALL BE IN ACCORDANCE WITH CURRENT OCCUPATIONAL SAFETY AND HEALTH ACT (OSHA) REGULATIONS, 29 CODE OF FEDERAL REGULATIONS (CFR) 1910/1926.
- 2. ALL THOSE PERFORMING ROOF WORK SHALL BE TRAINED AND REQUIRED TO USE A PERSONAL FALL ARREST SYSTEM AS REQUIRED BY OSHA REGULATIONS.
- 3. ALL THOSE ENGAGED IN LEADING EDGE WORK SHALL COMPLY WITH 29 CFR 1926 SUBPART M, 1926.501 AND EM 385-1-1 (CURRENT VERSION). THE REGULATION THAT IS MORE STRINGENT SHALL BE FOLLOWED.
- 4. THE CONTRACTOR SHALL ENSURE THAT ALL EMPLOYEES ARE AWARE OF THE HAZARDS OF WORKING ON A ROOF AND ARE CAPABLE OF PROTECTING THEMSELVES FROM POTENTIAL FALLING HAZARDS.
- 5. THERE ARE EXISTING OVERHEAD CABLE UTILITIES OVER THE WORKSITE.


		INDEX OF DRAWINGS
SHEET	DRAWING NO.	DESCRIPTION
1	G-001	LOCATION PLAN, INDEX OF DRAWINGS AND GENERAL NOTES
2	A-001	ARCHITECTURAL ABBREVIATIONS AND SYMBOLS
3	A-101	FLOOR DEMOLITION PLAN
4	A-102	REFLECTED CEILING DEMOLITION PLAN
5	A-103	FLOOR PLAN
6	A-104	REFLECTED CEILING PLAN
7	A-201	ELEVATIONS
8	A-601	DOOR AND FINISH SCHEDULE
9	I-101	FURNITURE DEMOLITION PLAN
10	I-102	FURNITURE PLAN AND SCHEDULE
11	PM001	PLUMBING AND MECHANICAL ABBREVIATIONS AND SYMBOLS
12	P-101	PLUMBING PLAN — DEMOLITION
13	P-102	PLUMBING PLAN
14	P-601	PLUMBING SCHEDULES
15	M-101	MECHANICAL PLAN - DEMOLITION
16	M-102	MECHANICAL PLAN
17	E-001	ELECTRICAL NOTES, LEGEND AND SCHEDULES
18	E-101	ELECTRICAL DEMOLITION PLAN
19	E-102	LIGHTING DEMOLITION PLAN
20	E-103	ELECTRICAL PLAN
21	E-104	LIGHTING PLAN
22	F-101	EXISTING FIRE ALARM PLAN

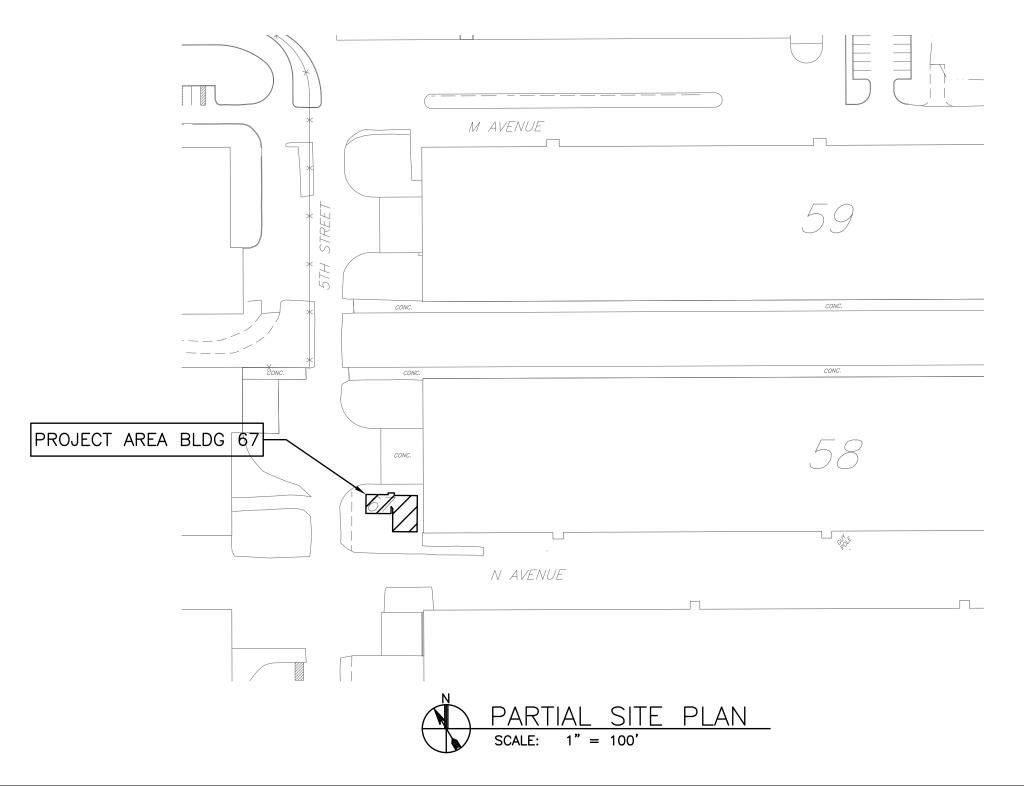

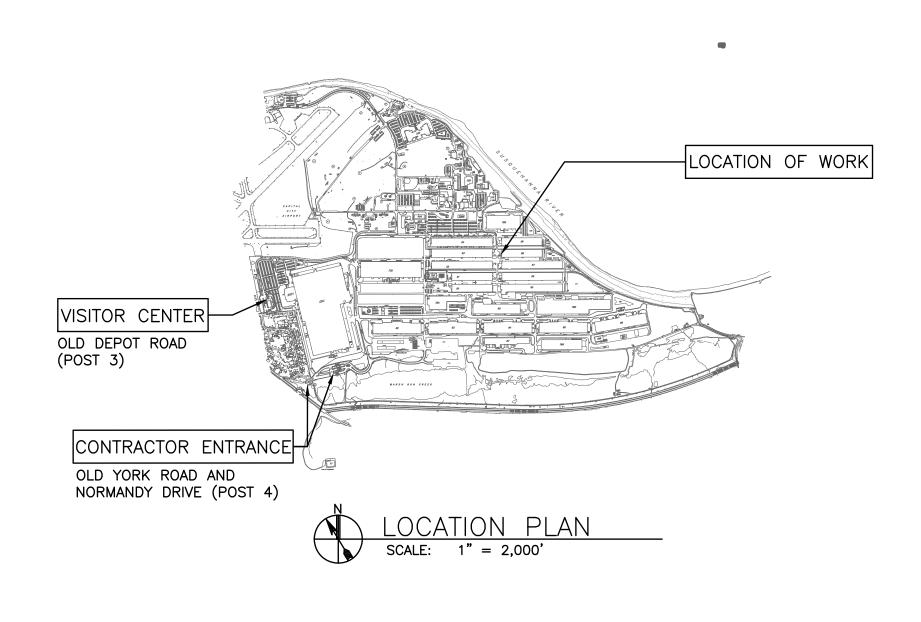

		NO.		REV	ISION	DATE		
APPROV	/ED BY]	DEFENSE LOGISTICS AGENCY					
CONSTRUCTION REPRESENTATIVE	SECURITY	DLA INSTALLATION MANAGEMENT AT SUSQUEHANNA INSTALLATION MANAGEMENT DIVISION NEW CUMBERLAND, PA 17070-5002						
€ ENVIRONMENTAL	SAFETY AND HEALTH	REPAIRS TO BUILDING 67						
FIRE PROTECTION	COMMUNICATIONS	LOCATION	PLAN, INI	DEX OF DI	RAWINGS AND GE	ENERAL NOTES		
INDUSTRIAL HYGIENIST	LUSER	DESIGNE BP		СНЕ	PROJECT NO. 4232			
FACILITY MAINTENANCE (MEO)		DRAWI BP		CIVIL ARCHITECTURAL MECHANICAL	N/A HERGENROTHER SHARLOG	DRAWING NO. G-001 SHEET		
SHAUN T. MEGONNELL	CHIEF, ENGINEERING DIVISION	SCAL AS SH		ELECTRICAL ENERGY	OLSON SPIGELMYER	1 of 22 DATE OCT 2023		



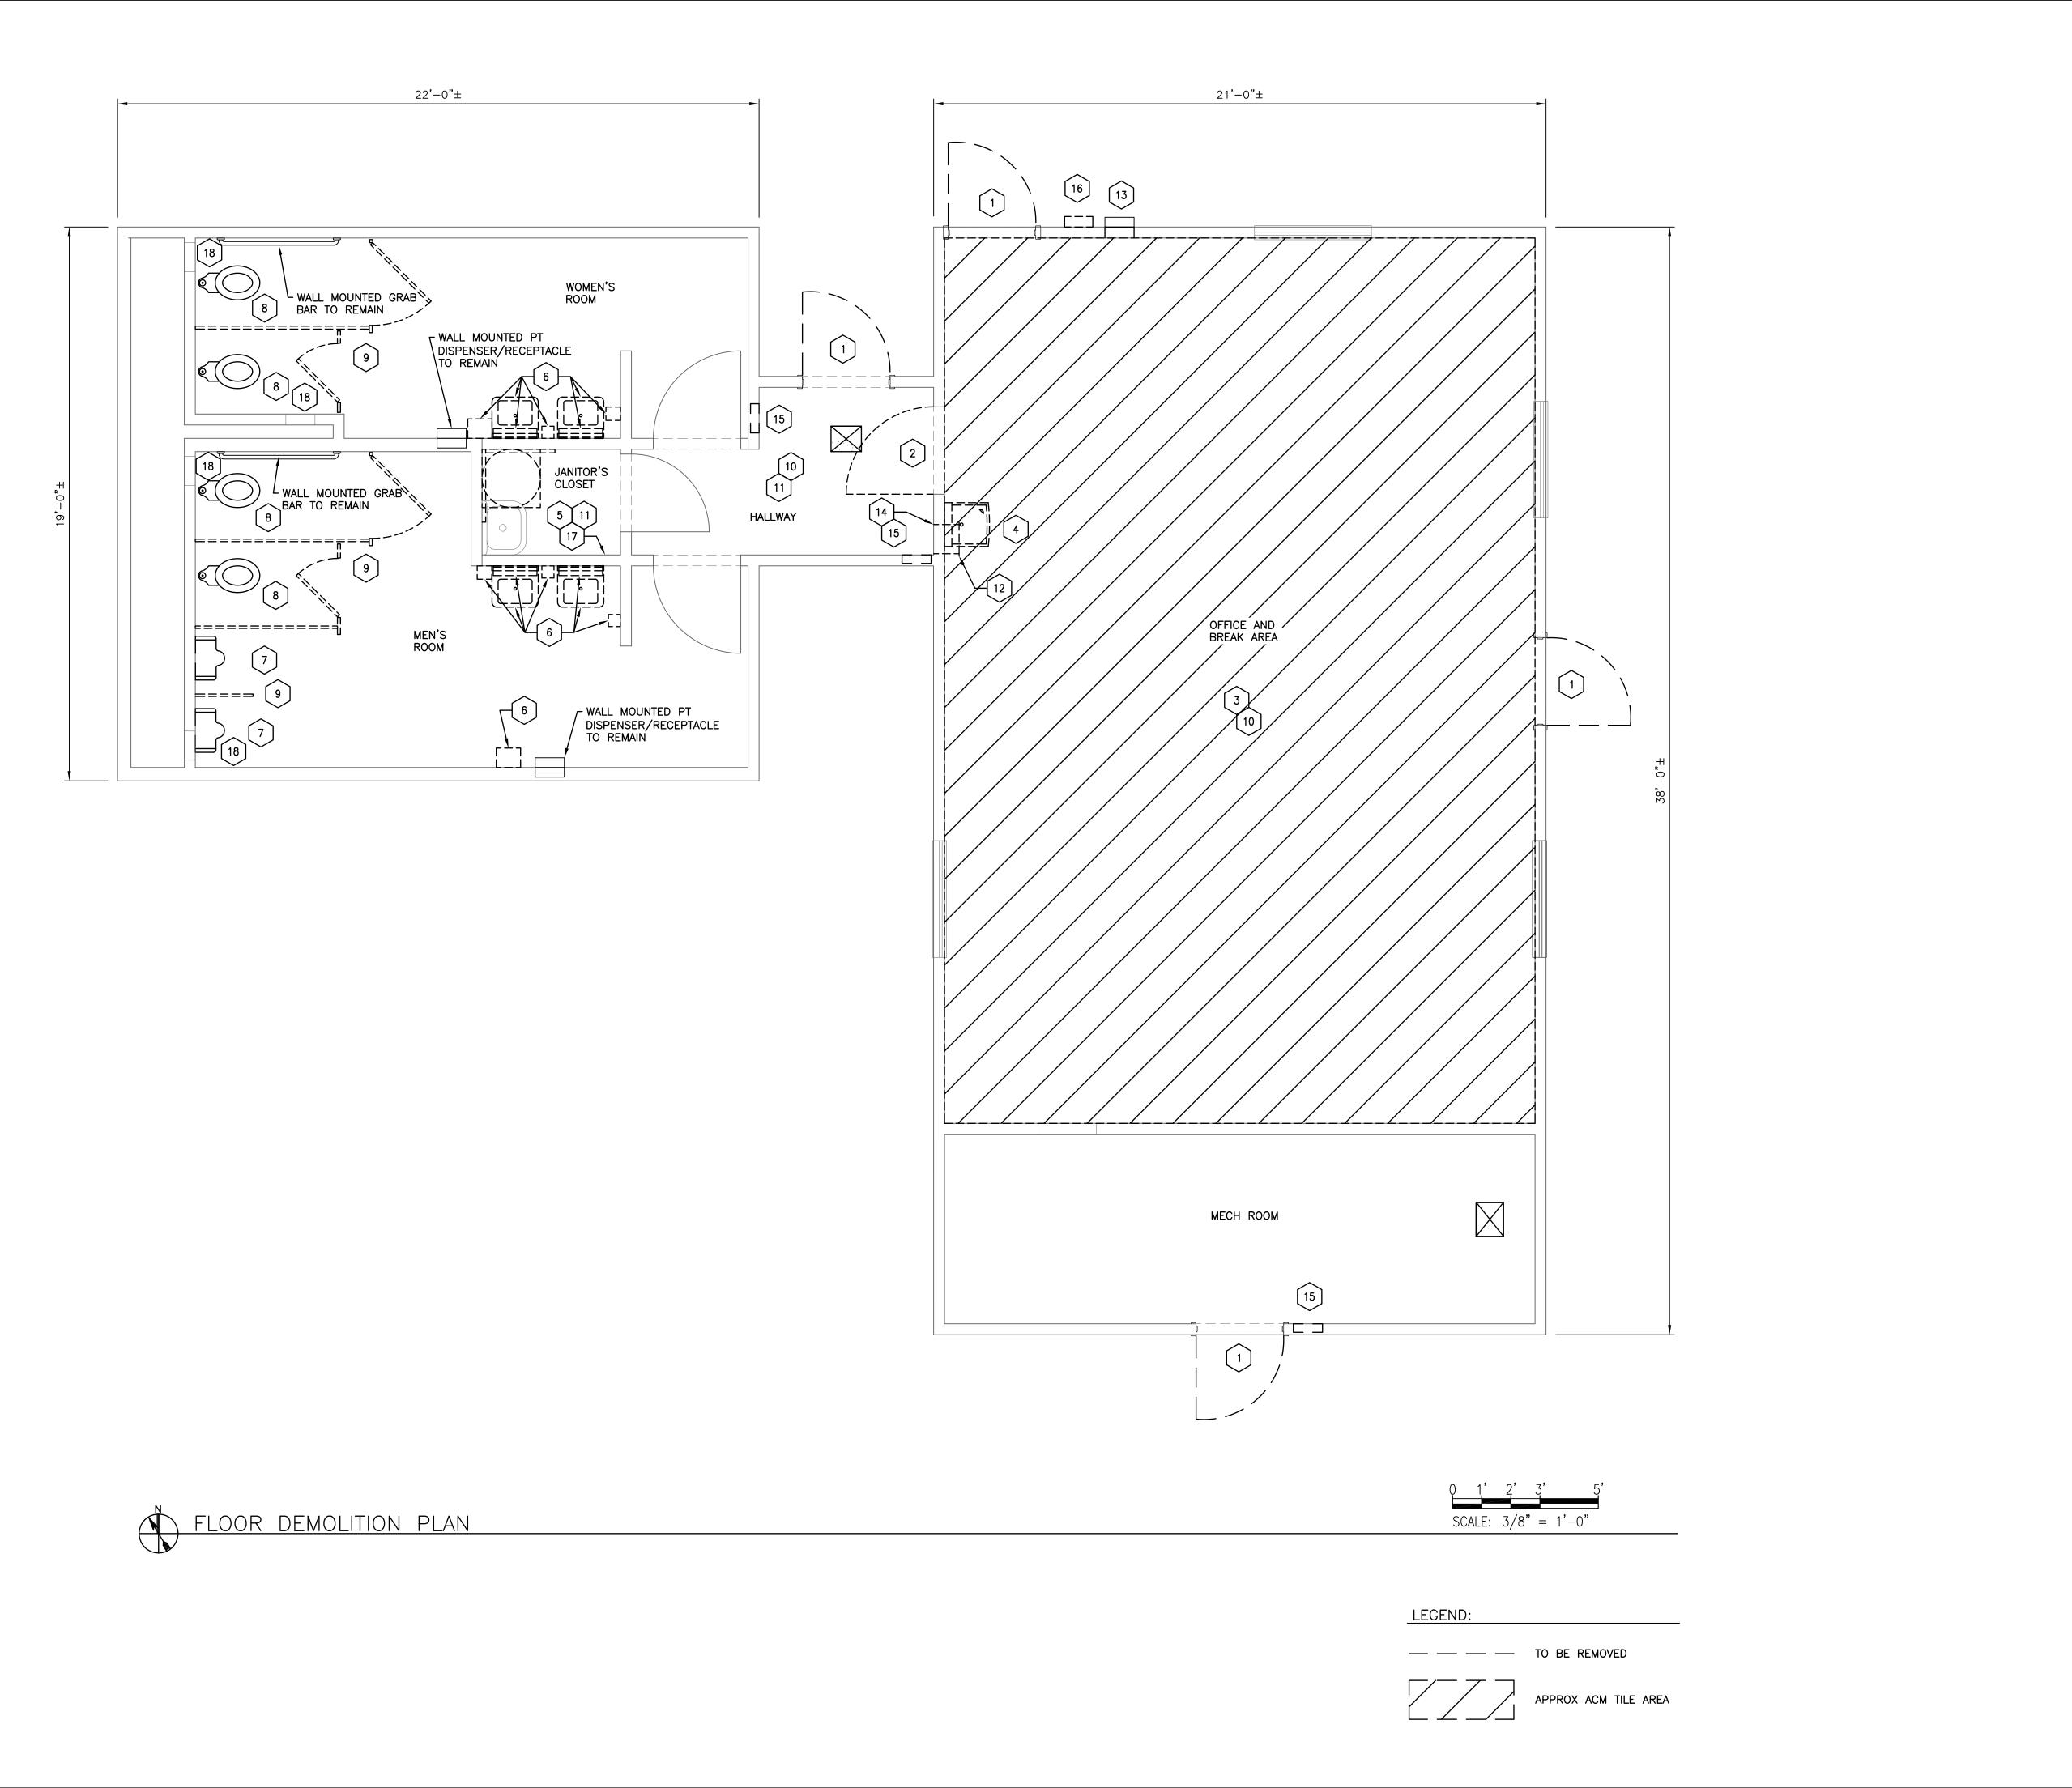

GENERAL NOTES

- 1. THE WORD "REMOVE" IS DEFINED AS "DISCONNECT, REMOVE AND DISPOSE OF OFF THE INSTALLATION".
- 2. PLANS CREATED FROM EXISTING RECORD DRAWINGS AND FIELD VERIFICATION. CONTRACTOR SHALL VERIFY EXISTING CONDITIONS ARE CORRECT AND REPORT MAJOR DISCREPANCIES TO THE COR FOR DIRECTION. WITH THAT STATED THE PLANS ARE NOT MEANT TO REPRESENT AN EXACT MATCH OF FIELD CONDITIONS AND CONTRACTOR SHALL EXPECT MINOR ADJUSTMENTS MAY BE REQUIRED TO COMPLETE THE DEMOLITION AS PART OF THE PROJECT.
- 3. DISPOSE OF ALL DEBRIS CREATED BY THIS PROJECT PER ALL FEDERAL, STATE AND LOCAL CODE/REGULATIONS.
- 4. BREAK ROOM EXISTING FLOOR TILES ARE IDENTIFIED AS ASBESTOS CONTAINING MATERIAL (ACM). FLOOR TILE REMOVAL AND DISPOSAL REQUIRES AN ASBESTOS CONTRACTOR TO CONDUCT THAT WORK IAW STATE AND FEDERAL REGULATIONS. PROVIDE APPLICABLE PLAN AS PER FEDERAL REGULATIONS.
- 5. NOTIFY THE COR AND REMEDIATE ALL OTHER UNEXPECTED HAZARDS IAW THE CONTRACT AND ALL APPLICABLE FEDERAL AND STATE REGULATIONS.
- 6. COORDINATE ALL DEMOLITION ACTIVITIES WITH ALL OTHER DISCIPLINES.

DEMOLITION REFERENCE KEYNOTES

- 1 REMOVE DOOR AND FRAME.
- 2 REMOVE DOOR.
- 3 REMOVE ASBESTOS CONTAINING FLOOR TILE.
- 4 REMOVE AND SALVAGE WATER FOUNTAIN FOR REUSE. SEE PLBG DWGS
- REMOVE WATER HEATER AND SUSPENSION SHELF SYSTEM. SEE PLBG DWGS
- REMOVE RESTROOM SINKS, MIRRORS, TOWEL DISPENSERS AND SOAP DISPENSERS FROM WALLS.
- 7 REMOVE URINALS.
- 8 REMOVE TOILETS.
- REMOVE TOILET PARTITIONS AND GRAB BARS AND TOILET PAPER DISPENSERS ATTACHED TO TOILET PARTITIONS.
- 10 FOR CEILING AREA DEMOLITION, SEE DWG A-102.
- 11 REMOVE VCT
- 12 REMOVE AIR TRANSFER LOUVER IN WALL, SEE MECH DWGS
- [13] REMOVE EXHAUST FAN, OUTSIDE COVER TO REMAIN, SEE MECH DWGS
- REMOVE WALL GYP BD FOR PLBG INSTALL. EXTENT DETERMINED BY CONTRACTOR. SEE PLBG DWGS
- 15) REMOVE ELEC PANELBOARD, SEE ELEC DWGS
- REMOVE EXTERIOR MOUNTED MAILBOX AND PATCH MOUNT HOLES WITH SEALANT
- REMOVE FRP PNL AND GYP BD. EXTENT DETERMINED BY CONTRACTOR. SEE PLBG DWGS FOR SANITARY CONNECTION DETAILS
- 18 REMOVE AND/OR REPLACE GRILLS. SEE PLBG DWGS

EXISTING CONSTRUCTION

SUBFLOOR - CONCRETE SLAB

REST ROOM FINISH FLOORING - CERAMIC TILE INSTALLED ON SLAB

HALLWAY AND JANITOR'S CLOSET FINISH FLOORING - VCT ON SLAB

BREAK ROOM/OFFICE FINISH FLOORING — ASBESTOS CONTAINING VCT ON SLAB

BREAK ROOM/AREA INTERIOR WALL FINISH — PAINTED ½" GWB ON 2 X 4

STUDS @ 16" OC

REST ROOM WALL FINISH — CERAMIC TILE COVERED %" GWB ON 2 X 4 STUDS @ 16" OC.

HALLWAY WALL FINISH - %" GWB ON 2 X 4 STUDS @ 16" OC.

CEILING - SUSPENDED ACOUSTICAL CEILING TILES AND GRID AND PAINTED

CEILING FRAMING - PRE-FAB WOOD TRUSSES

GYPSUM BOARD


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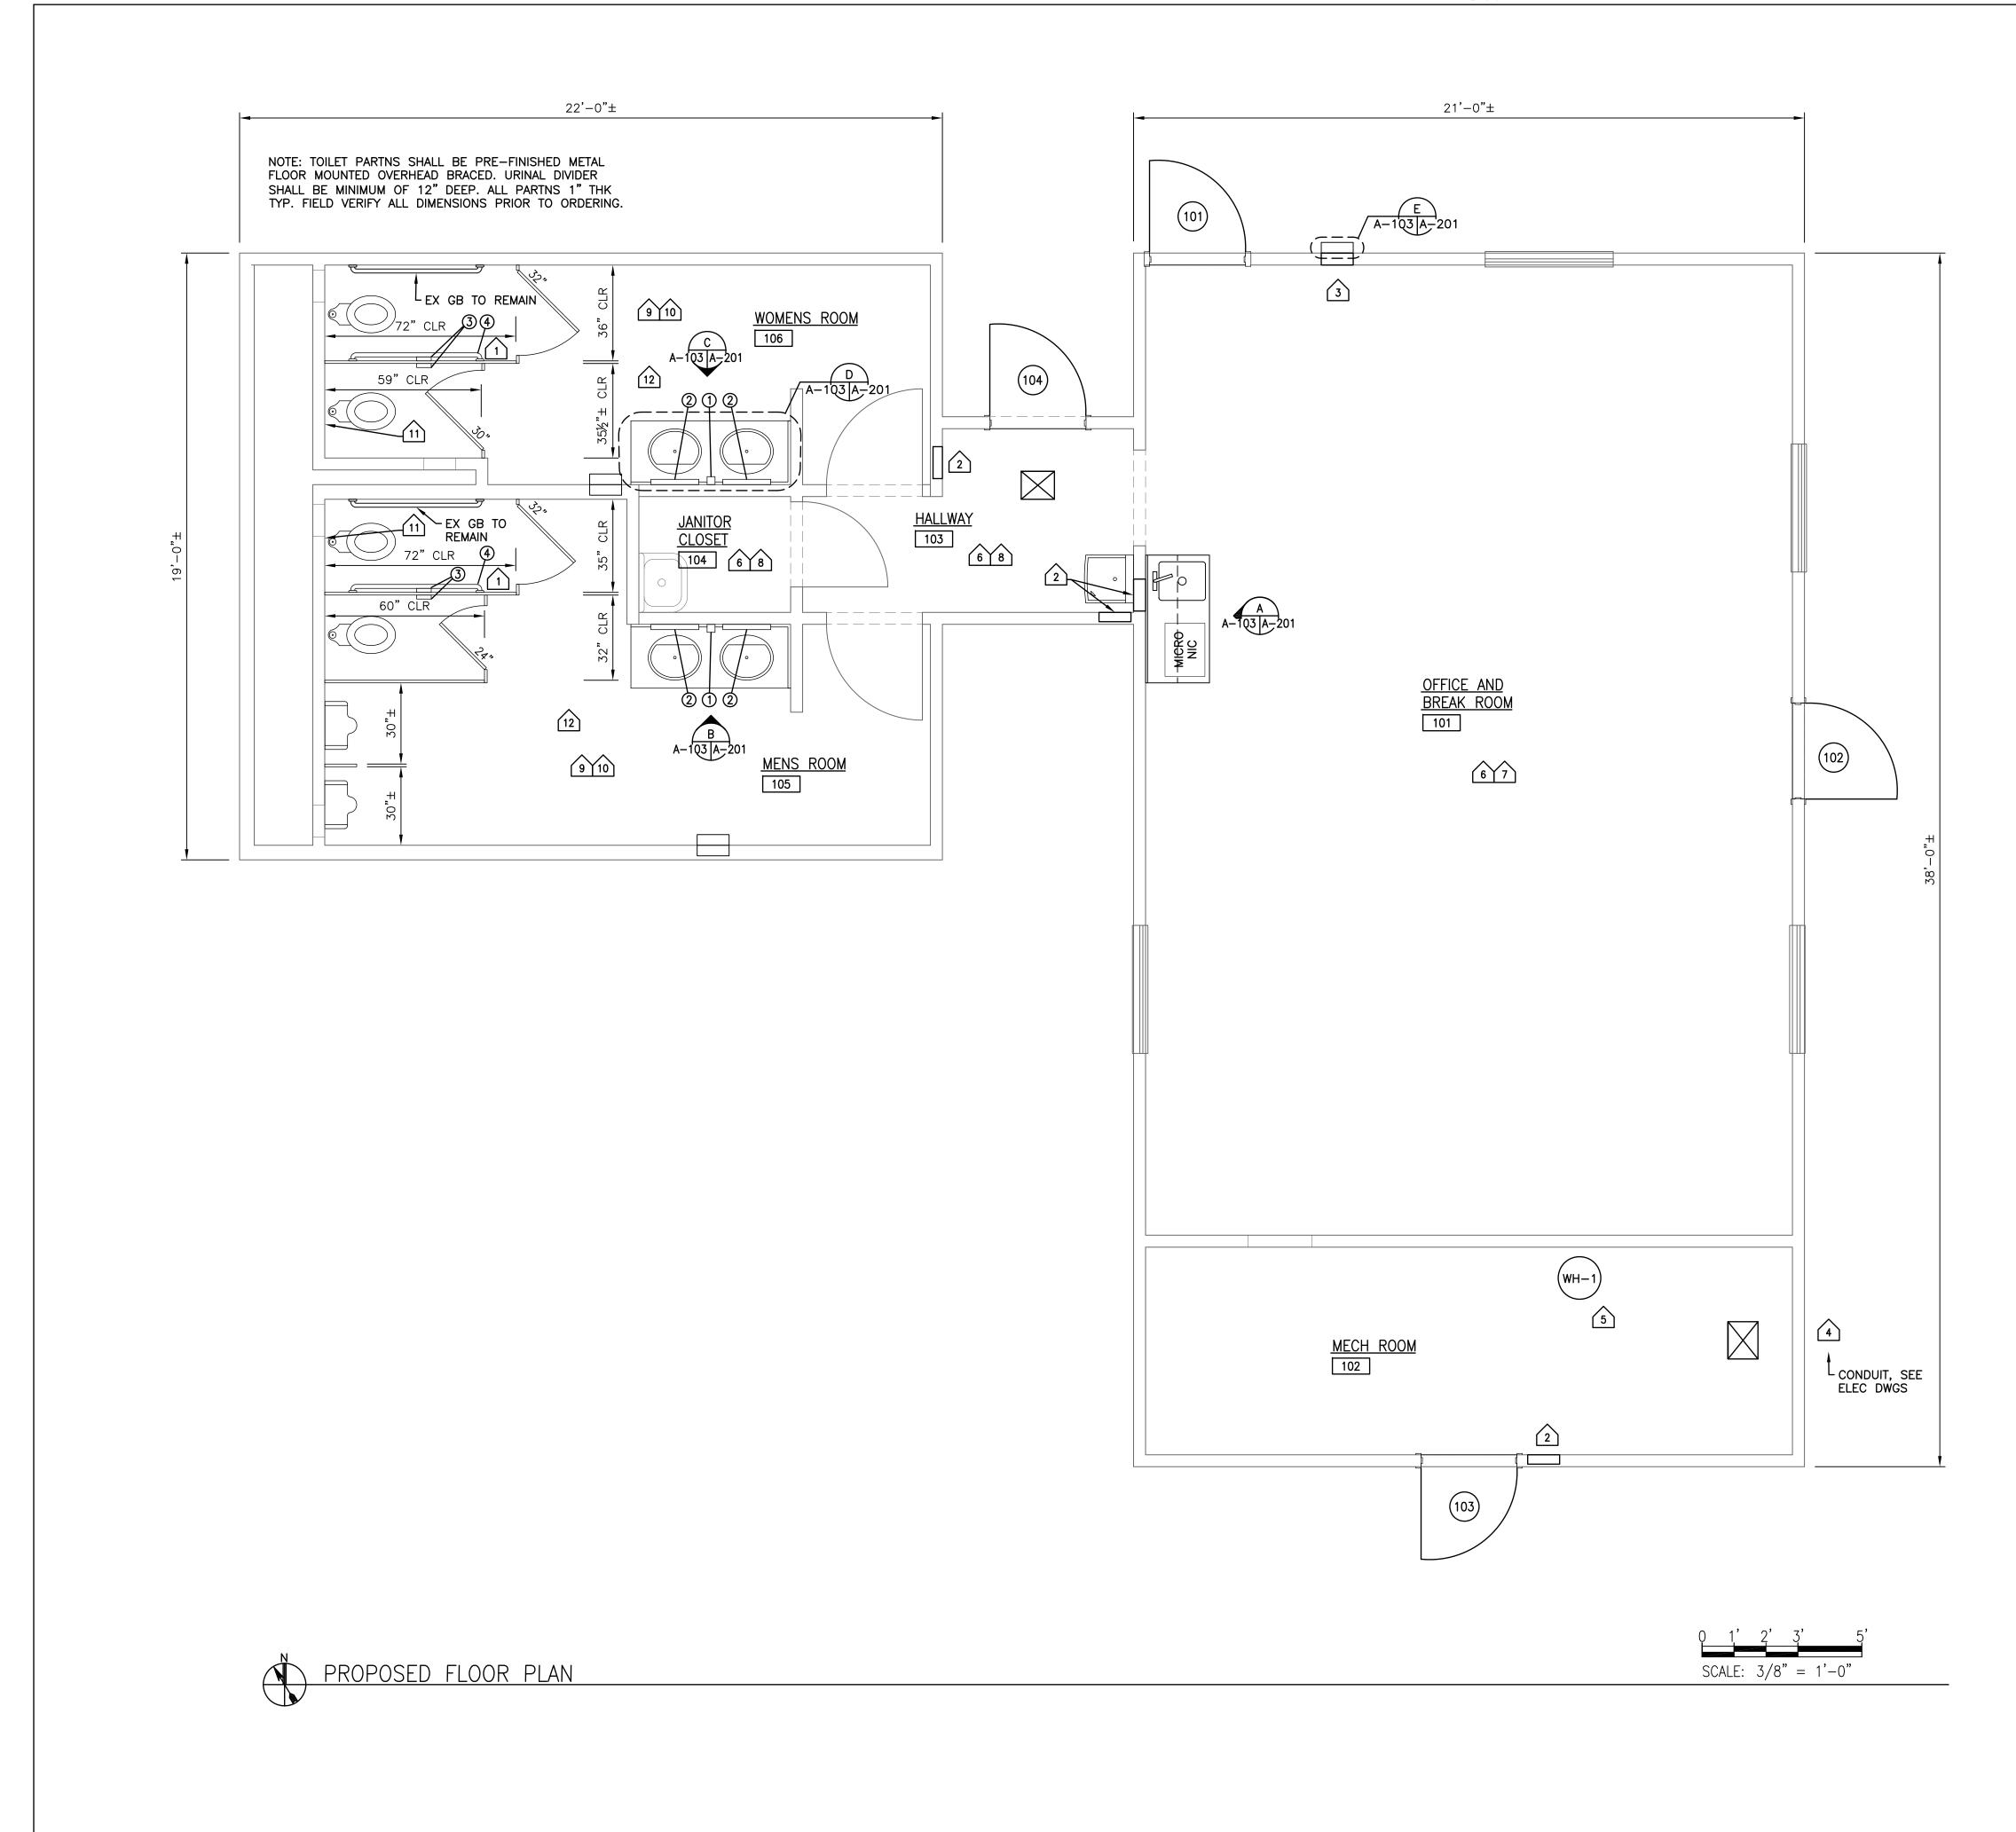
DEFENSE LOGISTICS AGENCY
DLA INSTALLATION MANAGEMENT AT SUSQUEHANNA
INSTALLATION MANAGEMENT DIVISION
NEW CUMBERLAND, PA 17070-5002

REPAIRS TO BUILDING 67

FLOOR DEMOLITION PLAN

DESIGNED BY: BPK	CHE	CKED BY:	PROJECT NO. 4232			
DRAWN BY:	CIVIL ARCHITECTURAL	N/A HERGENROTHER	DRAWING NO. A-101			
BPK	MECHANICAL	SHARLOG	SHEET 3 OF 22			
scale: AS SHOWN	ELECTRICAL ENERGY	OLSON SPIGELMYER	OCT 2023			



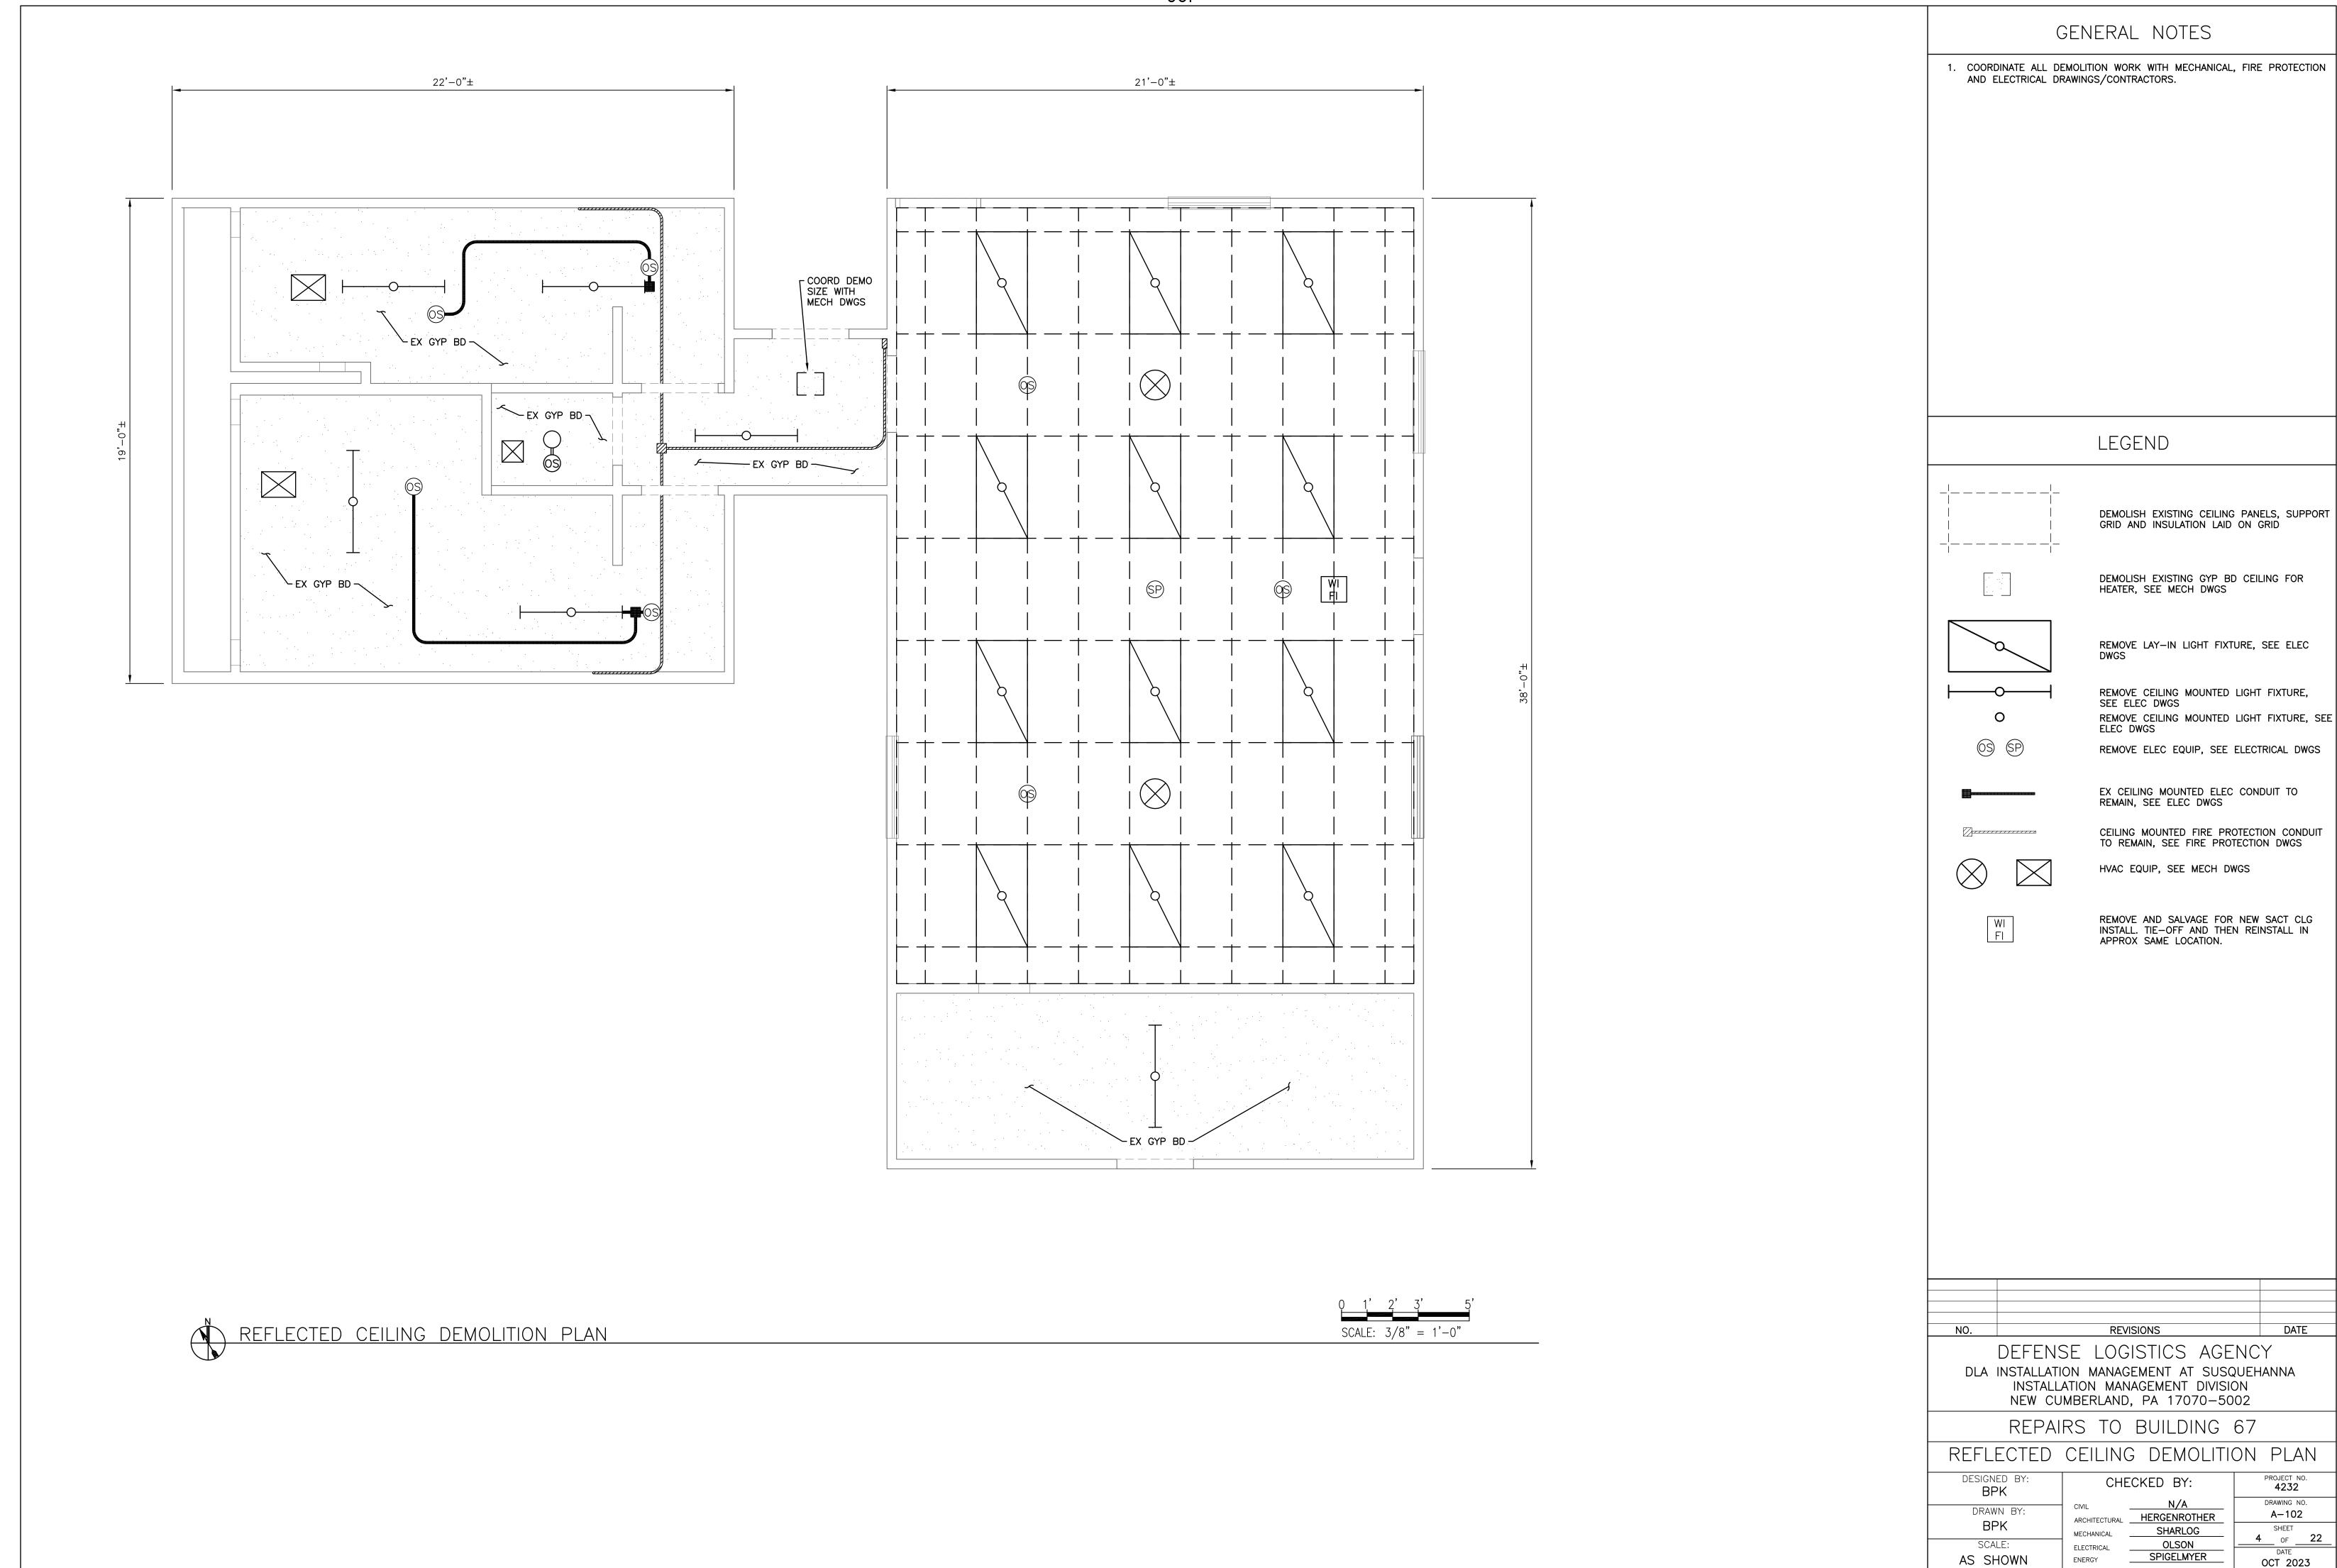

GENERAL NOTES

- 1. PLANS CREATED FROM EXISTING RECORD DRAWINGS AND FIELD VERIFICATION. CONTRACTOR SHALL VERIFY EXISTING CONDITIONS ARE CORRECT AND REPORT MAJOR DISCREPANCIES TO THE COR FOR DIRECTION. THE PLANS ARE NOT MEANT TO REPRESENT AN EXACT MATCH OF FIELD CONDITIONS AND CONTRACTOR SHALL EXPECT MINOR ADJUSTMENTS MAY BE REQUIRED TO COMPLETE THE PROJECT.
- 2. PROVIDE FLOOR MOUNTED OVERHEAD BRACED TOILET PARTITIONS
- 3. SEE DWG A-601 FOR TOILET ACCESSORY MOUNTING HEIGHTS AND TOILET ACCESSORY BASIS OF DESIGN.
- 4. NEW VENT PIPE(S) PENETRATE EX ROOF (SEE MECH DWGS). FLASH EX SHINGLES WATER-TIGHT USING PIPE FLASHING BOOT.

KEYNOTE REFERENCES

- MOUNT NEW GRAB BARS TO TOILET PARTN AT SAME HT AND DISTANCE FROM BACK WALL AS EX WALL MOUNTED GRAB BAR.
- FILL ALL VOIDS WITH R13 BLANKET INSUL, GYP BD THKNS TO MATCH EX ADJACENT GYP BD. PATCH, TAPE AND FINISH PAINT TO MATCH.
- FILL VOID WITH R13 BLANKET INSUL, GYP BD THKNS TO MATCH EX
 ADJACENT GYP BD. PATCH, TAPE AND FINISH PAINT WHERE
 APPLICABLE. SEE DETAIL "E" FOR EXTERIOR FABRICATION
- SEAL NEW 1½" CONDUIT PENETRATION WITH SEALANT. SEE ELEC DWGS FOR DETAILS.
- 5 NEW WATER HEATER INSTALL. SEE PLBG DWGS FOR DETAILS.
- 6 INSTALL VCT AND WALL BASE.
- PATCH, TAPE AND FINISH HOLES AND DEFICIENCIES IN ALL WALLS.
- PATCH, TAPE AND FINISH ALL HOLES IN CEILING AND ALL WALLS. INSTALL RFP PANEL WALL COVERING TO MATCH EX.
- 9 PATCH, TAPE AND FINISH ALL HOLES IN CEILING.
- PATCH ALL HOLES IN CERAMIC TILES ON WALLS AND FLOORS WITH GROUT TO MATCH EX.
- PREPARE METAL SURFACE ACCESS PANELS PER SPEC 099000 AND PAINT TO MATCH EX CERAMIC WALL TILE COLOR.
- 12 STEAM CLEAN CERAMIC WALLS AND FLOORS.


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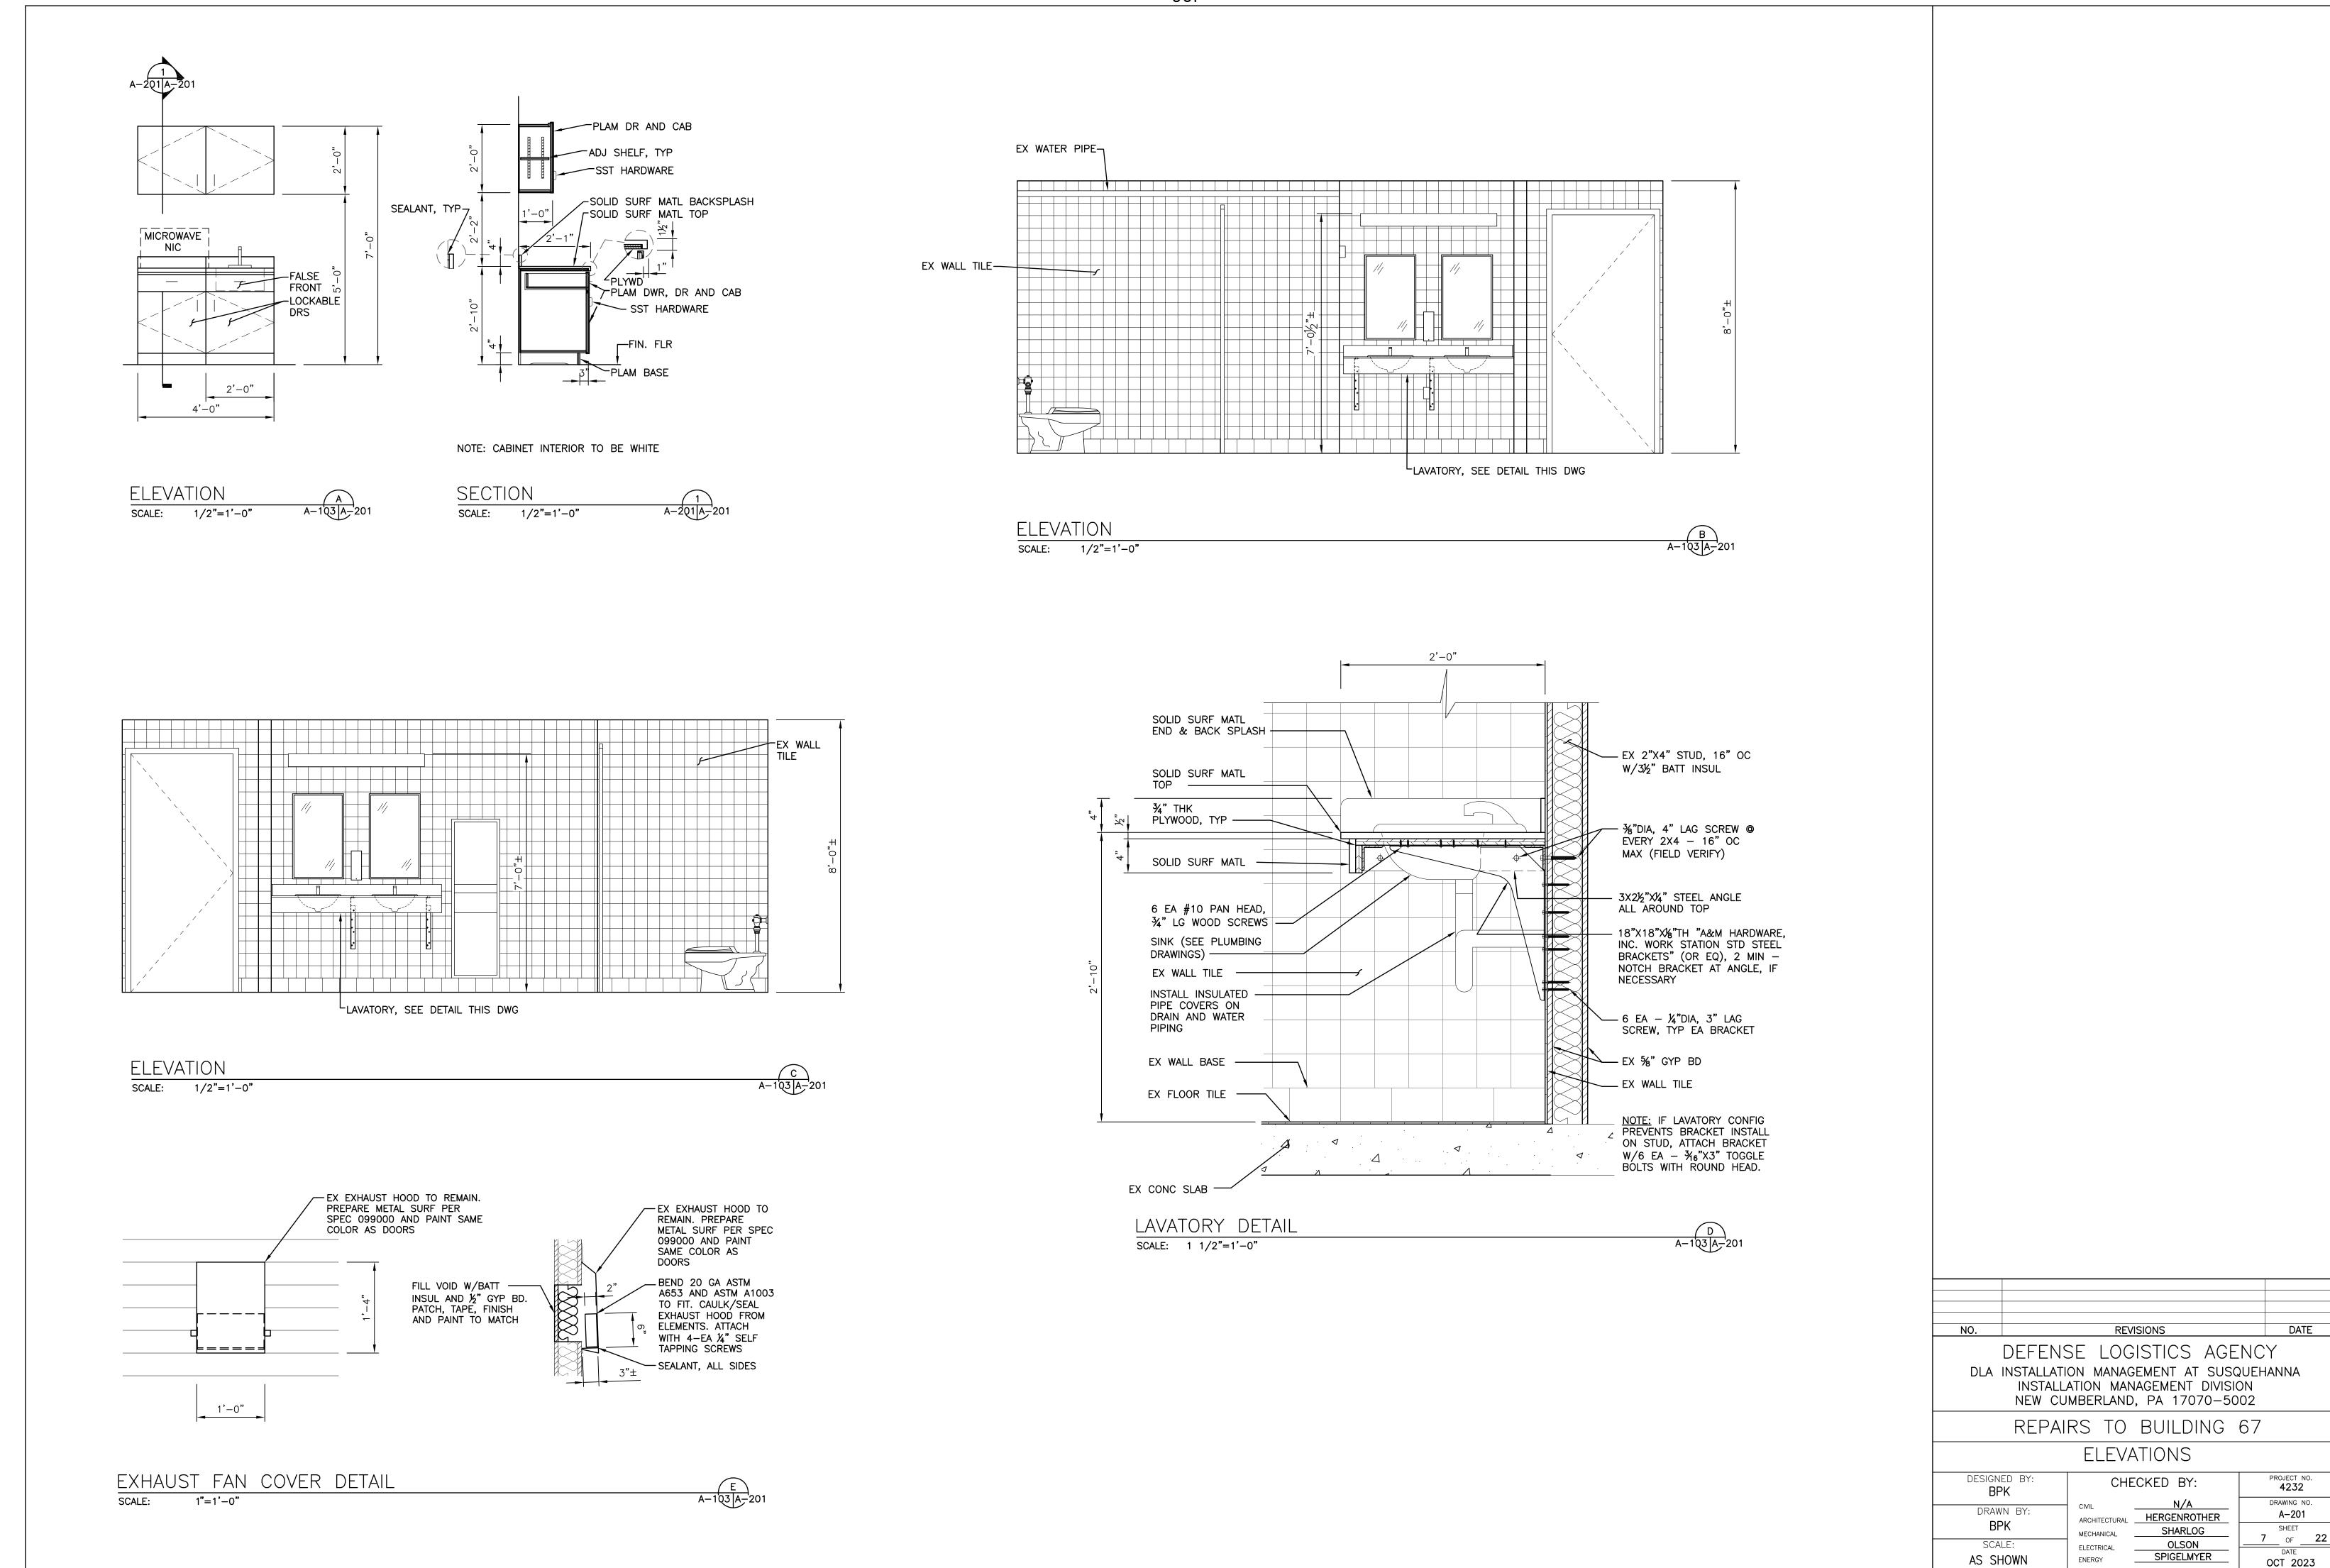
DEFENSE LOGISTICS AGENCY
DLA INSTALLATION MANAGEMENT AT SUSQUEHANNA
INSTALLATION MANAGEMENT DIVISION
NEW CUMBERLAND, PA 17070-5002

REPAIRS TO BUILDING 67

FLOOR PLAN

DESIGNED BY: BPK	СНЕ	CKED BY:	PROJECT NO. 4232		
	CIVIL	N/A	DRAWING NO.		
DRAWN BY:	ARCHITECTURAL	HERGENROTHER	A-103		
BPK	MECHANICAL	SHARLOG	SHEET 22		
SCALE:	ELECTRICAL	OLSON	5 of22		
AS SHOWN	ENERGY	SPIGELMYER	OCT 2023		




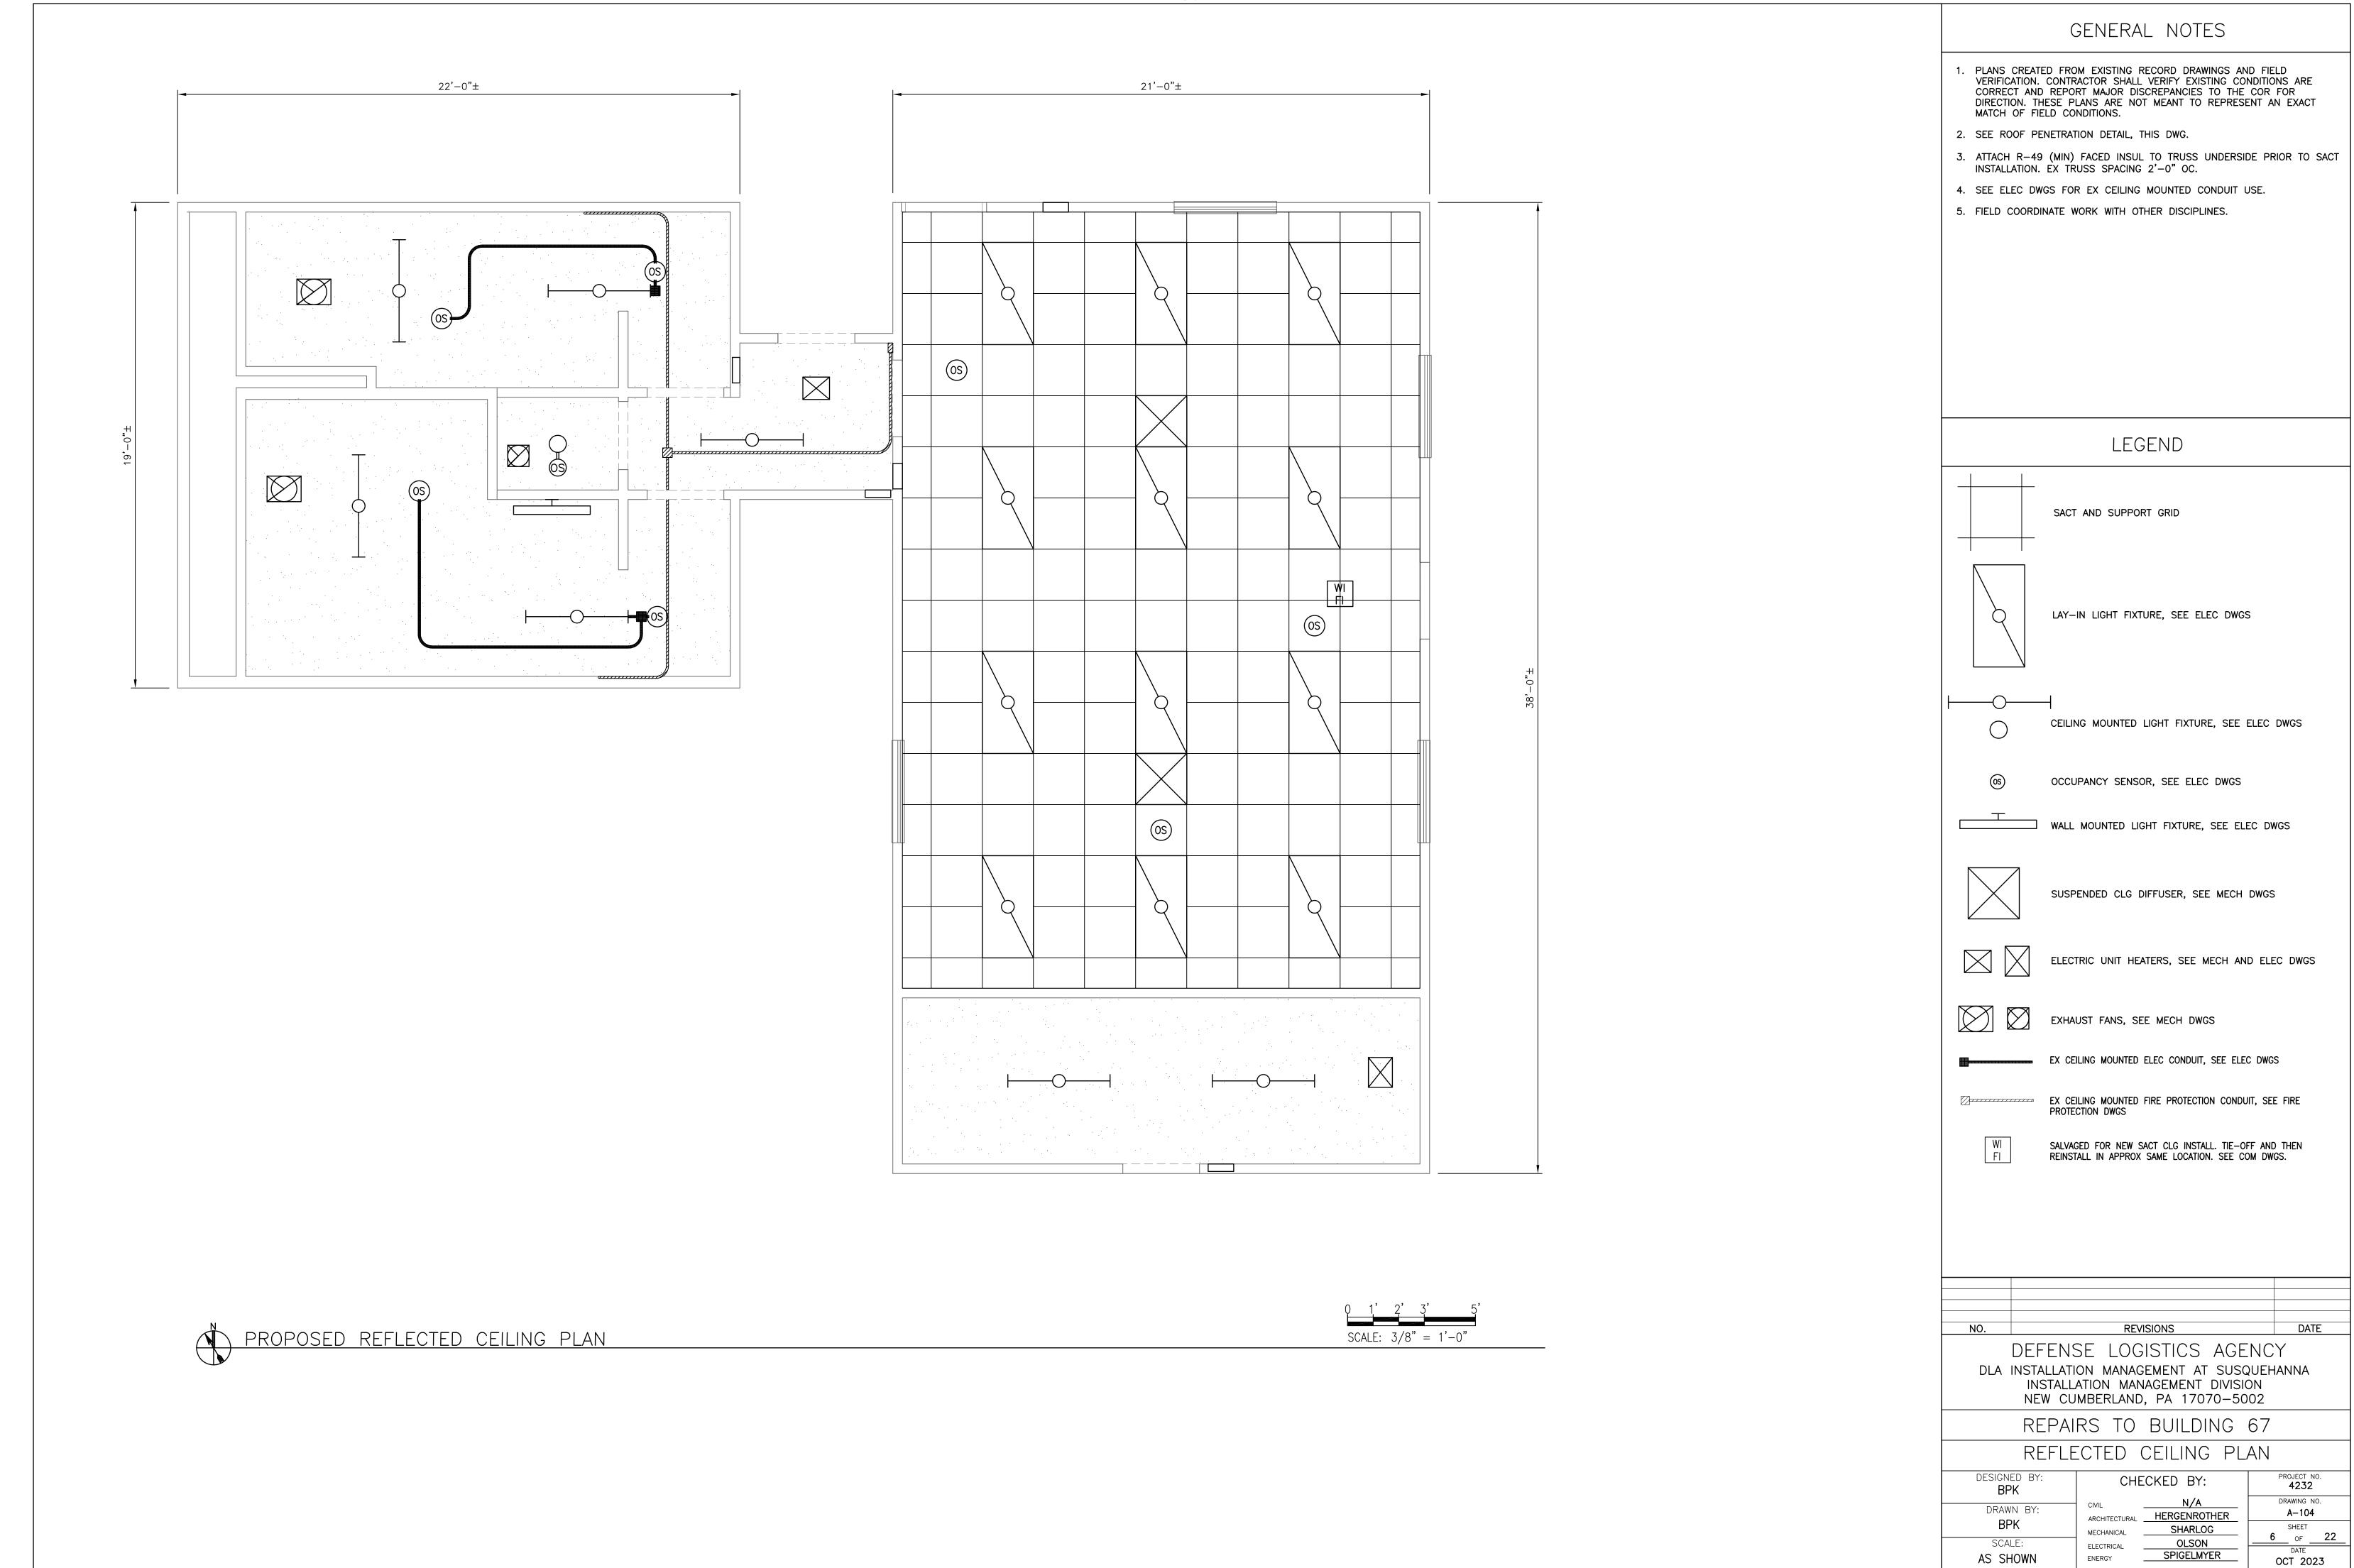

	DOOR SCHEDULE											
NO		DOOR			FRAME			JAMB	CILL	LABEL	HDWR	REMARKS
NO.	SIZE	MATERIAL	TYPE	GLASS	MATERIAL	TYPE	HEAD	JAMB	SILL	LABEL	SET	REMARNS
101	3'-0"X7'-0"	STL	N	G1	STL	A	1	3	5		1	1, 2, 3
102	3'-0"X7'-0"	STL	N	G1	STL	A	1	3	5		1	1, 2, 3
103	3'-0"X7'-0"	STL	F		STL	Α	1	3	5		1	1, 2
104	3'-0"X6'-8"	STL	N	G1	STL	В	2	4	5		1	1, 2, 3
REMARKS												
1	FIELD VERIFY DO	OR SIZE NOTE	D VERSE	ES EXISTING	WALL OPENIN	AND ADJU	JST DOOR S	IZE ACCOR	DINGLY.			
2	INSULATED DOOF	R AND FRAME.										
3	INSULATED GLAZ	ING G1 SEE G	LAZING N	NOTE THIS	DRAWING							


FINISH SCHEDULE


				I													
		בו ה	FLOOR		_	WALLS								CELLING			REMARKS
ROOM NO.	ROOM NAME	FLOO	Ν	BASI	_	NORTH		EAST		SOUTH		WEST		CEILING			REMARKS
		MATERIAL	FINISH	MATERIAL	FINISH	MATERIAL	FINISH	MATERIAL	FINISH	MATERIAL	FINISH	MATERIAL	FINISH	MATERIAL	FINISH	HEIGHT	
101	OFFICE AND BREAK ROOM	EX CONC	VCT	EX GYP BD	RUBBER	EX PNT GYP BD	PNT 1	EX PNT GYP BD	PNT 1	EX PNT GYP BD	PNT 1	EX PNT GYP BD	PNT 1	OPN TRUSS	SACT	8'-0"	PROVIDE VCT, COVE BASE AND SACT. PATCH, TAPE, FINISH AND PNT ALL WALLS.
102	MECHANICAL ROOM	EX CONC	E.T.R.	EX GYP BD	E.T.R.	EX PNT GYP BD	E.T.R.	EX PNT GYP BD	E.T.R.	EX PNT GYP BD	E.T.R.	EX PNT GYP BD	E.T.R.	OPN TRUSS	E.T.R.	E.T.R.	PATCH, TAPE AND FINISH ALL GYP BD REPAIRS.
103	HALLWAY	EX CONC	VCT	EX GYP BD	RUBBER	EX PNT GYP BD	PNT 1	EX PNT GYP BD	PNT 1	EX PNT GYP BD	PNT 1	EX PNT GYP BD	PNT 1	OPN TRUSS	PNT 2	7'-6"	PROVIDE VCT, COVE BASE. PATCH, TAPE, FINISH AND PNT ALL WALLS AND CEILING.
104	JANITOR	EX CONC	VCT	EX GYP BD	RUBBER	EX PNT GYP BD/FRP PNL	PNT 1	EX PNT GYP BD	PNT 1	EX PNT GYP BD/FRP PNL	PNT 1/FRP PNL	EX PNT GYP BD/FRP PNL	PNT 1	EX. PNT GYP	PNT 2	8'-0"	PROVIDE VCT, COVE BASE. PATCH, TAPE, FINISH AND PNT GYP BD WALLS AND CEILING. FRP PNL ON SOUTH WALL
105	MEN'S ROOM	EX CONC	E.T.R.	EX CT	E.T.R.	EX CT	E.T.R.	EX CT	E.T.R.	EX CT	E.T.R.	EX CT	E.T.R.	EX. PNT GYP	PNT 2	8'-0"	PATCH, TAPE, FINISH AND PNT CEILING.
106	WOMEN'S ROOM	EX CONC	E.T.R.	EX CT	E.T.R.	EX CT	E.T.R.	EX CT	E.T.R.	EX CT	E.T.R.	EX CT	E.T.R.	EX. PNT GYP	PNT 2	8'-0"	PATCH, TAPE, FINISH AND PNT CEILING.

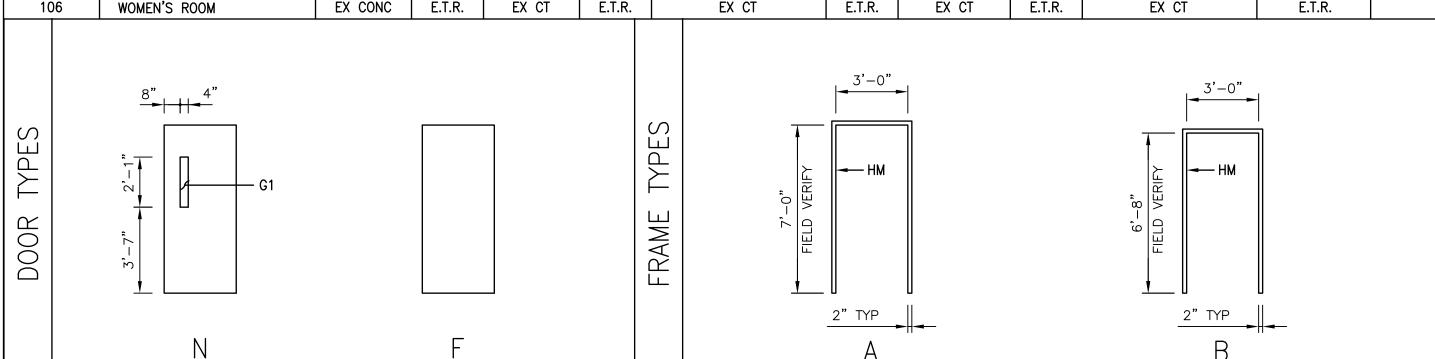

GLAZING NOTE:

- G1 TWO PANES OF GLASS SEPARATED BY DHYDRATED AIRSPACE FILLED WITH ARGON GAS AND HERMETICALLY SEALED, CONFORMING TO ASTM E2190. THICK TEMPERED (TINTED HEAT STRENGTHENED) GLASS (OUTTER PANE), $\frac{1}{2}$ " AIRSPACE, $\frac{1}{4}$ " TOTAL
- THICKNESS LAMINATED GLASS (INNER LITE), 3" TOTAL THICKNESS.

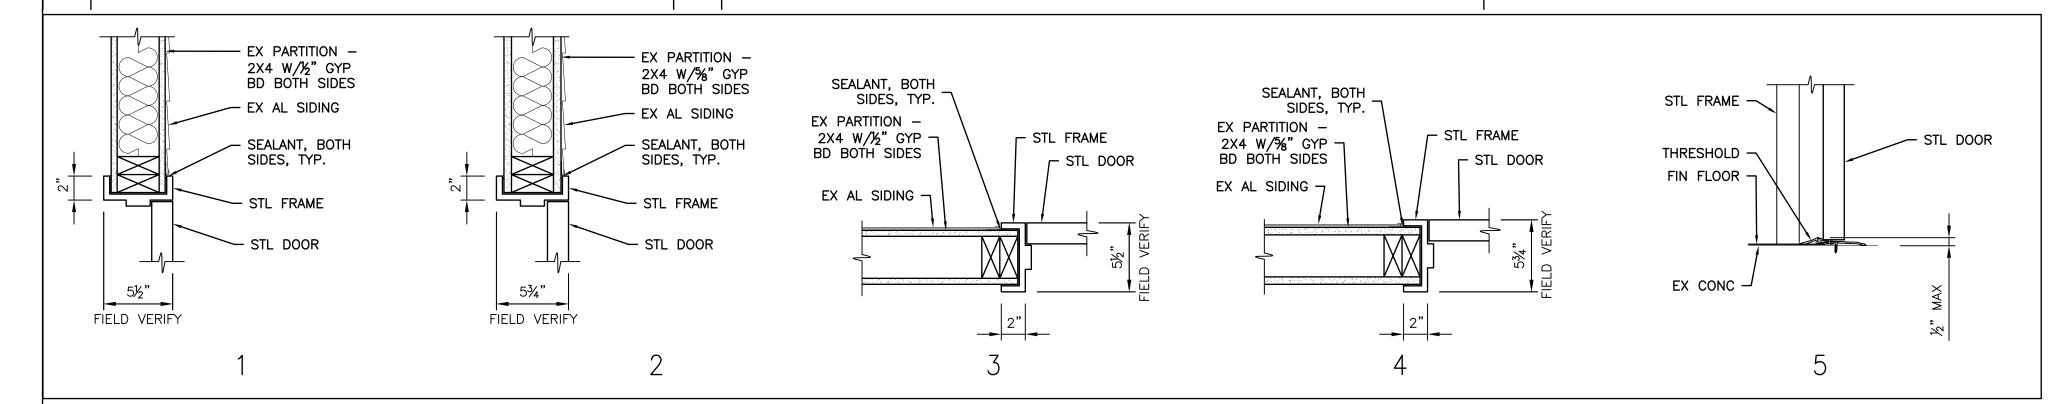

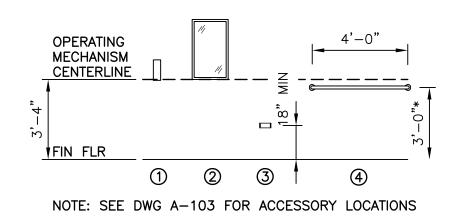

TOILET ACCESSORIES MOUNTING HEIGHTS SCALE: 1/4"=1'-0"

	TOILET ACCESSORIES SCHEDULE	
MARK	ITEM	BASIS OF DESIGN MODEL #
1	SURFACE MOUNTED AUTOMATIC LIQUID SOAP DISPENSER (SD)	GFE CONTRACTOR INSTALLED
2	FIXED TILT MIRROR 18X30 (TM)	BRADLEY 740-018300 OR EQ
3	SURFACE MOUNTED SINDLE ROLL TOILET TISSUE DISPENSER (TTD)	A5195 PER SPEC 102813
4	48" LG GRAB BAR	A5109 PER SPEC 102813
NOTES:		

1.	TOILET ACCESSORIES BASIS OF DESIGN MODEL NUMBERS TAKEN FROM SPEC 102813 OR "AMERICAN SPECIALTIES, INC" FOR ESTABLISHING
	QUALITY AND TYPE DESIRED.
2.	*DIMENSION SHOWN FOR TP GRAB BAR IS APPROX. MOUNT SAME HEIGHT AND DISTANCE FROM BACK WALL AS EX WALL-MOUNTED GRAB
	BAR TO REMAIN.


INTERIOR FINISH SCHEDULE											
INTERIOR FINISHES	MANUFACTURER	COLOR	PAINT SHEEN								
PNT 1	SHERWIN WILLIAMS OR EQ	TO BE SELECTED AND APPROVED BY THE GOVT	EGGSHELL								
PNT 2	SHERWIN WILLIAMS OR EQ	TO BE SELECTED AND APPROVED BY THE GOVT	EGGSHELL								
VCT	AHF FLOORING OR EQ	TO BE SELECTED AND APPROVED BY THE GOVT	N/A								
COVE BASE	JOHNSONITE OR EQ	TO BE SELECTED AND APPROVED BY THE GOVT	N/A								
DOOR FRAME PNT	SHERWIN WILLIAMS OR EQ	TO BE SELECTED AND APPROVED BY THE GOVT	SEMI-GLOSS								
DOOR PNT	SHERWIN WILLIAMS OR EQ	TO BE SELECTED AND APPROVED BY THE GOVT	SEMI-GLOSS								
TOILET PARTITIONS	ASI GLOBAL PARTITIONS OR EQ	TO BE SELECTED AND APPROVED BY THE GOVT	N/A								
PLAM CABINETS	FORMICA OR EQ	TO BE SELECTED AND APPROVED BY THE GOVT	N/A								
SOLID SURFACE MATERIAL	MEGANITE OR EQ	TO BE SELECTED AND APPROVED BY THE GOVT	N/A								
RESTROOM SOLID SURFACE MATERIAL	MEGANITE OR EQ	TO BE SELECTED AND APPROVED BY THE GOVT	N/A								
.090 FRP PNL	GLASLINER OR EQ	WHITE	N/A								
FRP PNL TRIM TO MATCH	GLASLINER OR EQ	WHITE	N/A								


GENERAL NOTES


. FINISH COLORS, TYPES, STYLES, ETC. TO BE SELECTED BY THE USER. ALL FINISH SAMPLES MUST BE SUBMITTED PRIOR TO SELECTION SO ALL FINISHES CAN BE COORDINATED AND SELECTED AT ONE TIME.


2. SEE INTERIOR FINISH SCHEDULE, THIS DWG, FOR FULL FINISH LIST.

1 0.	REVISIONS	DATE						
	DEFENSE LOGISTICS AGENCY NSTALLATION MANAGEMENT AT SUSQUEHANNA INSTALLATION MANAGEMENT DIVISION NEW CUMBERLAND, PA 17070-5002							
	REPAIRS TO BUILDING 67							
	OOR AND FINISH SCHEDUL	.E						

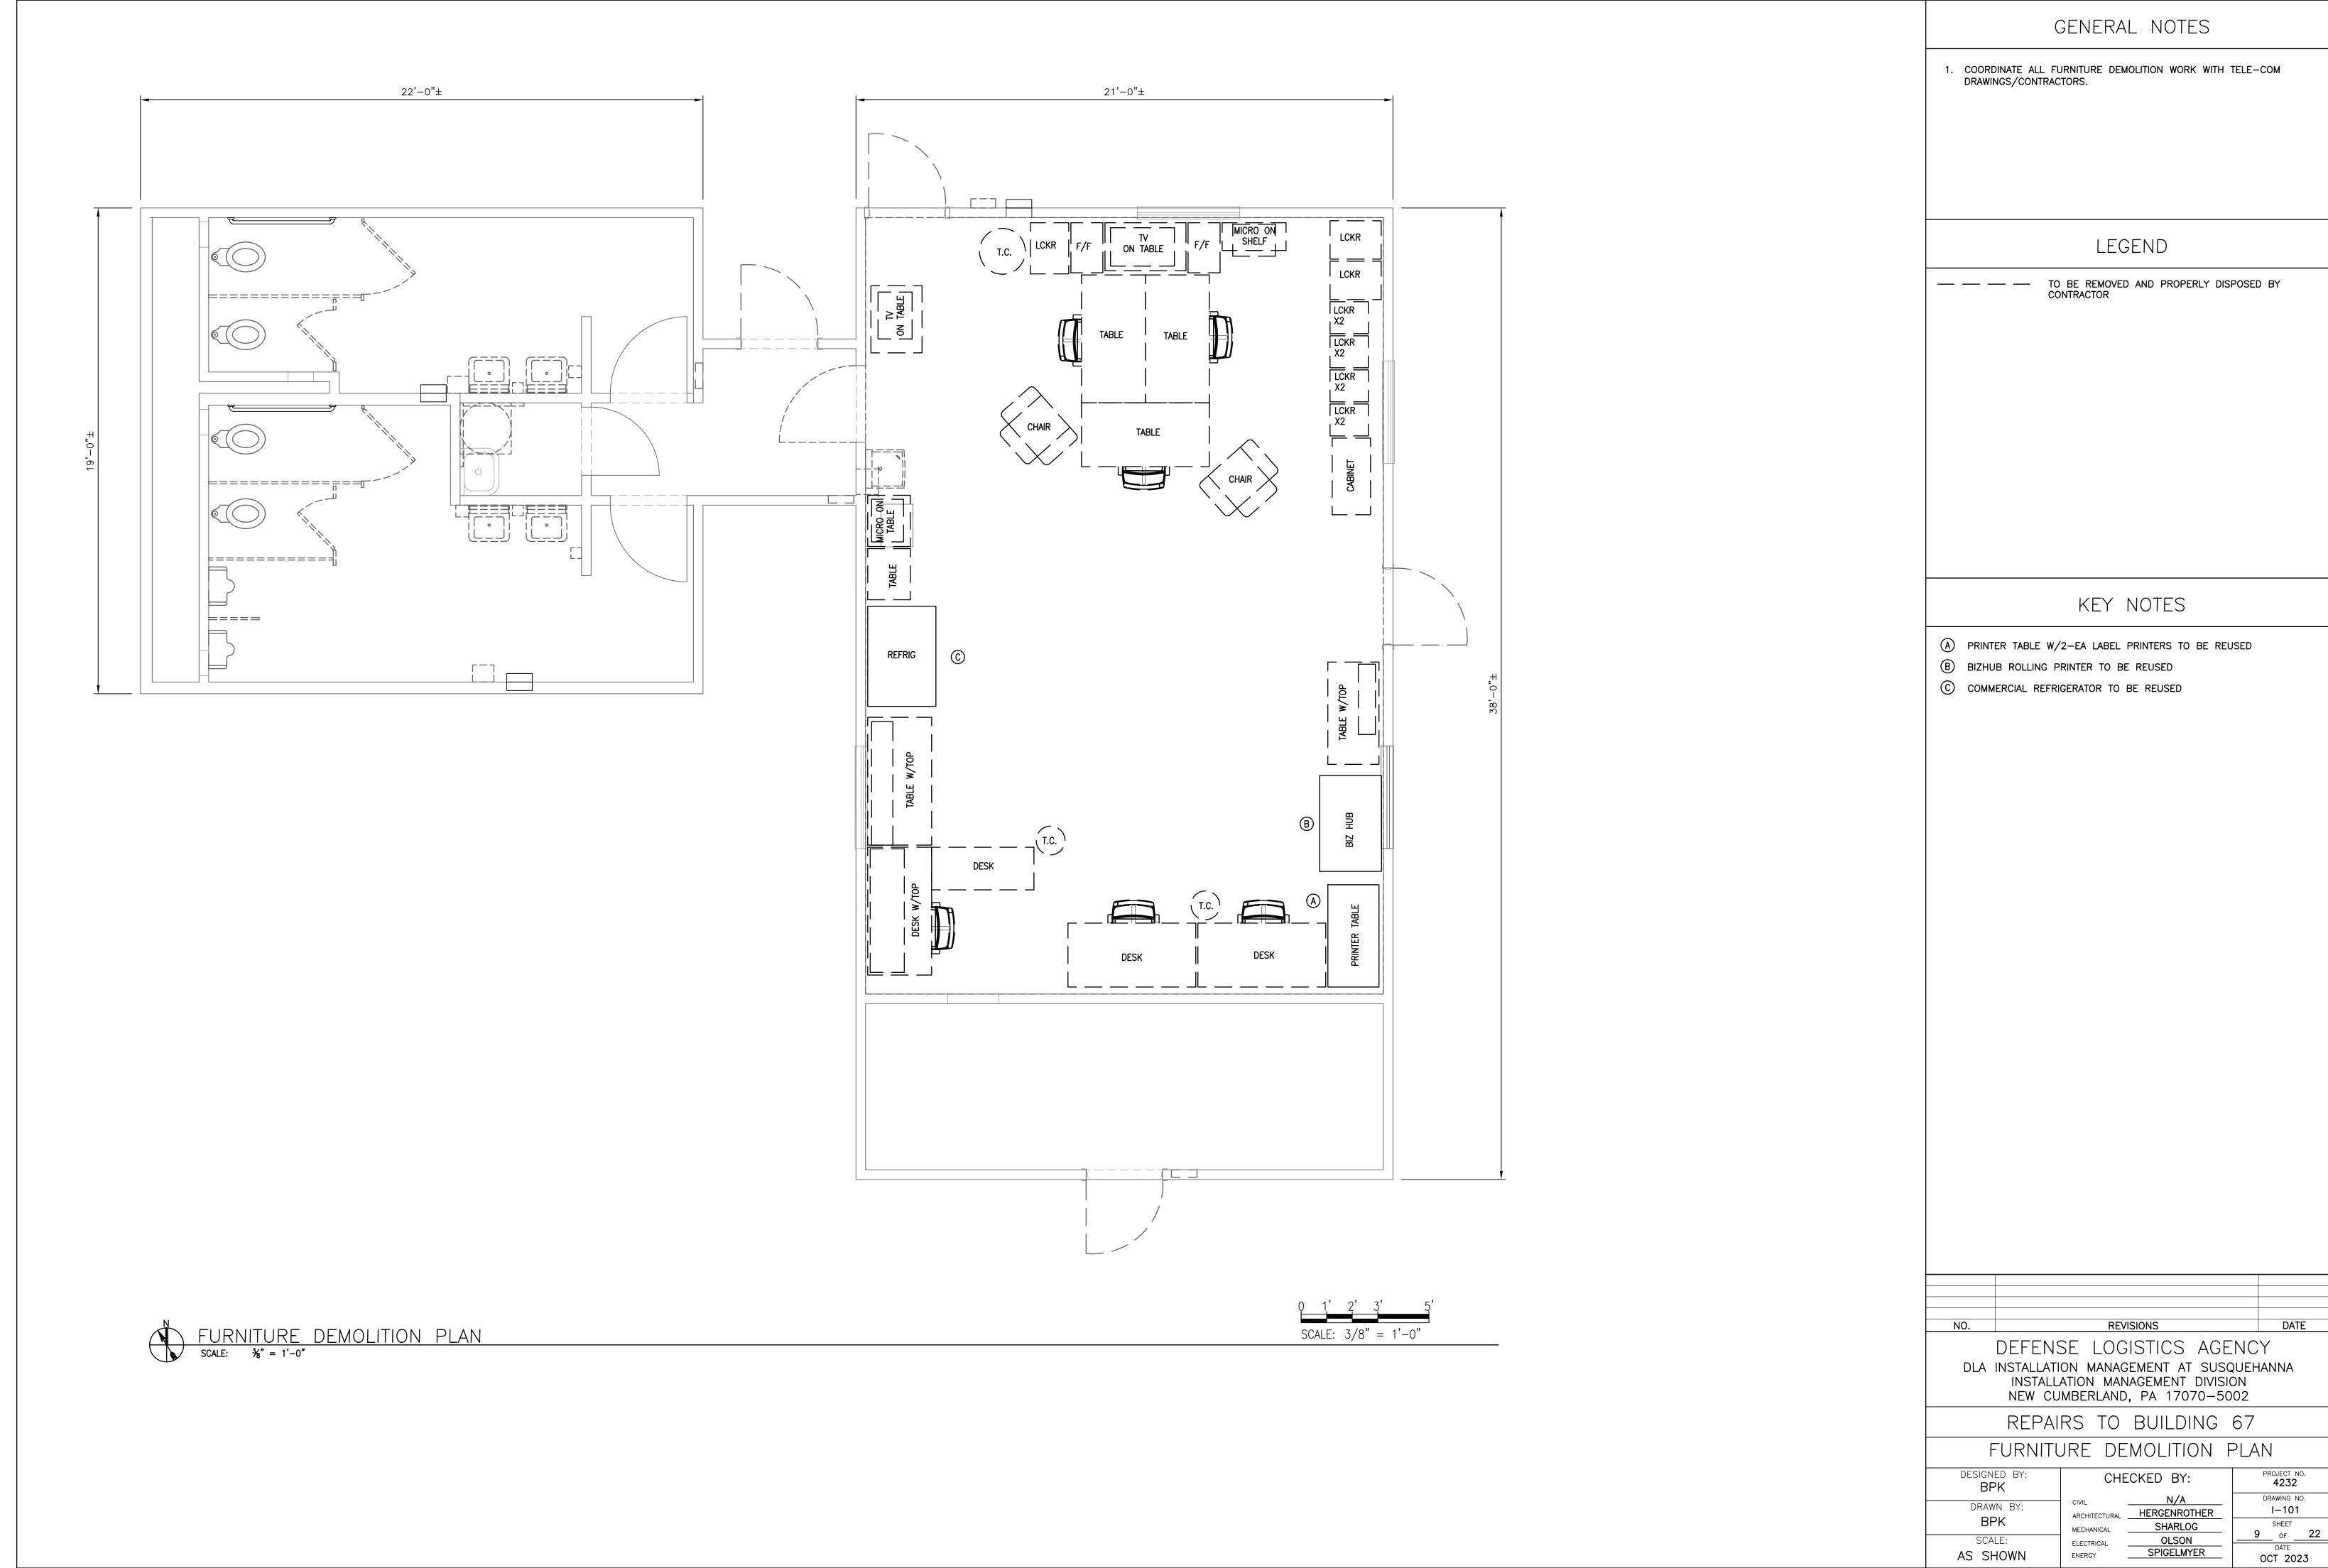

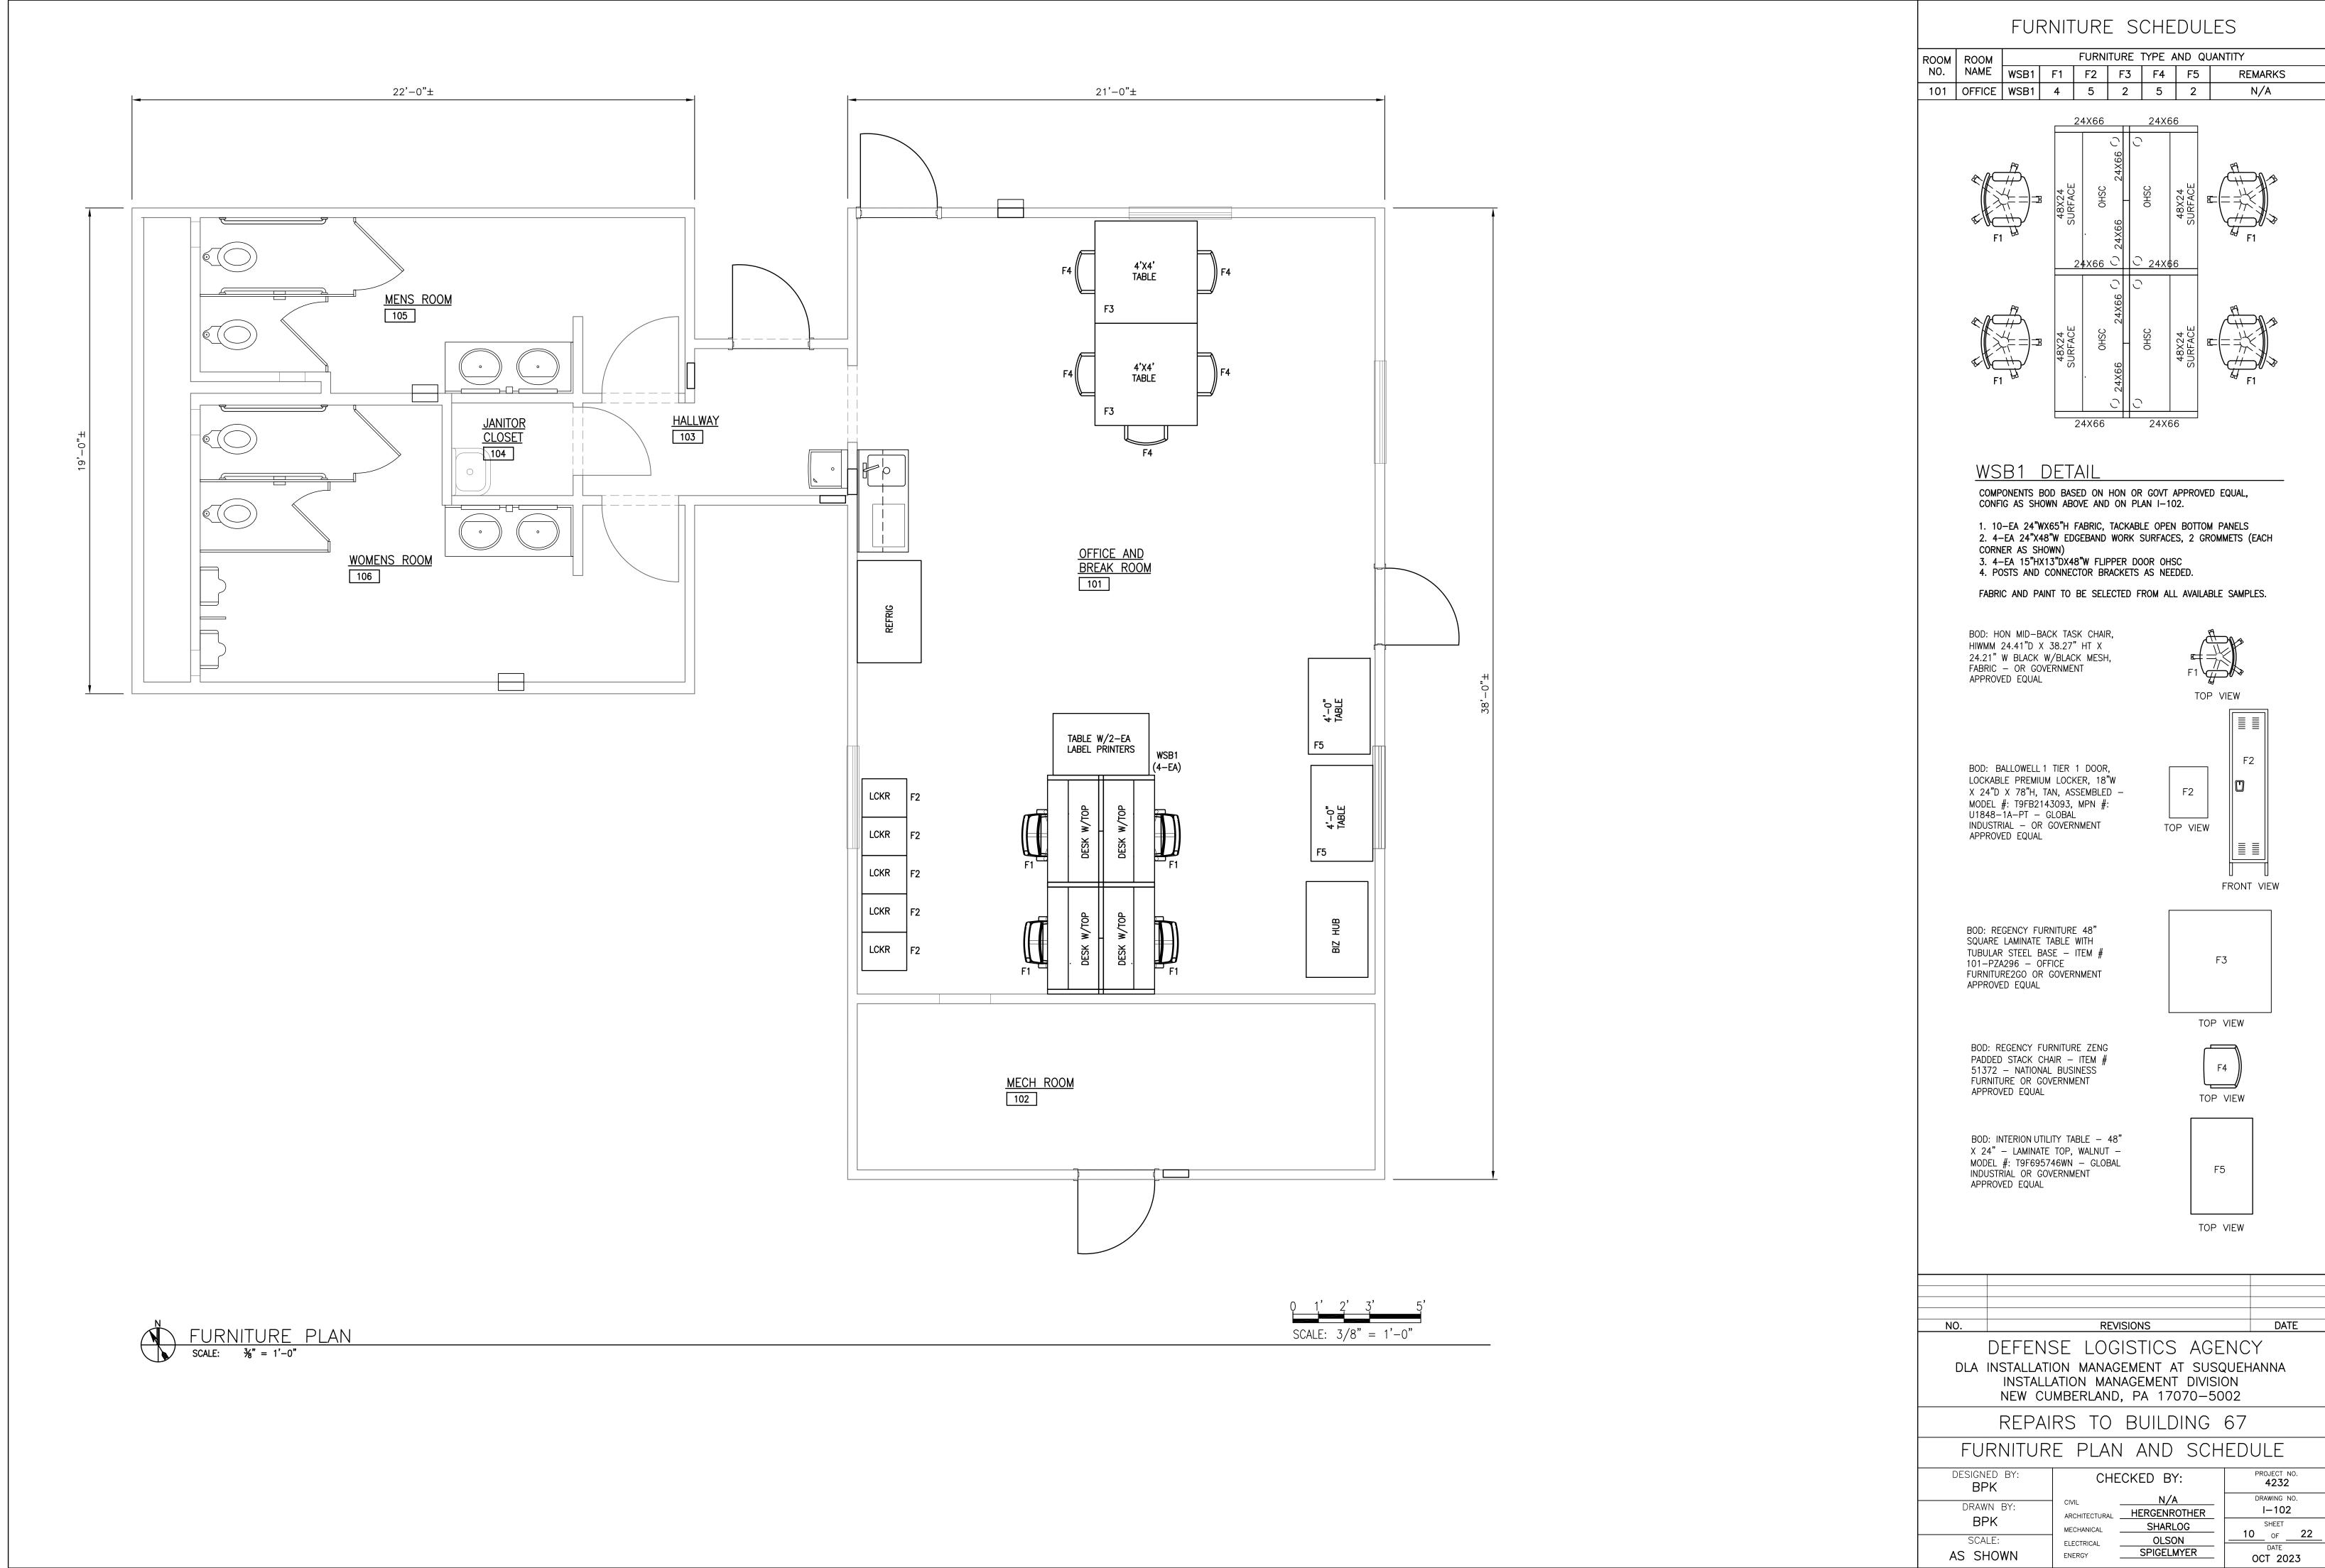

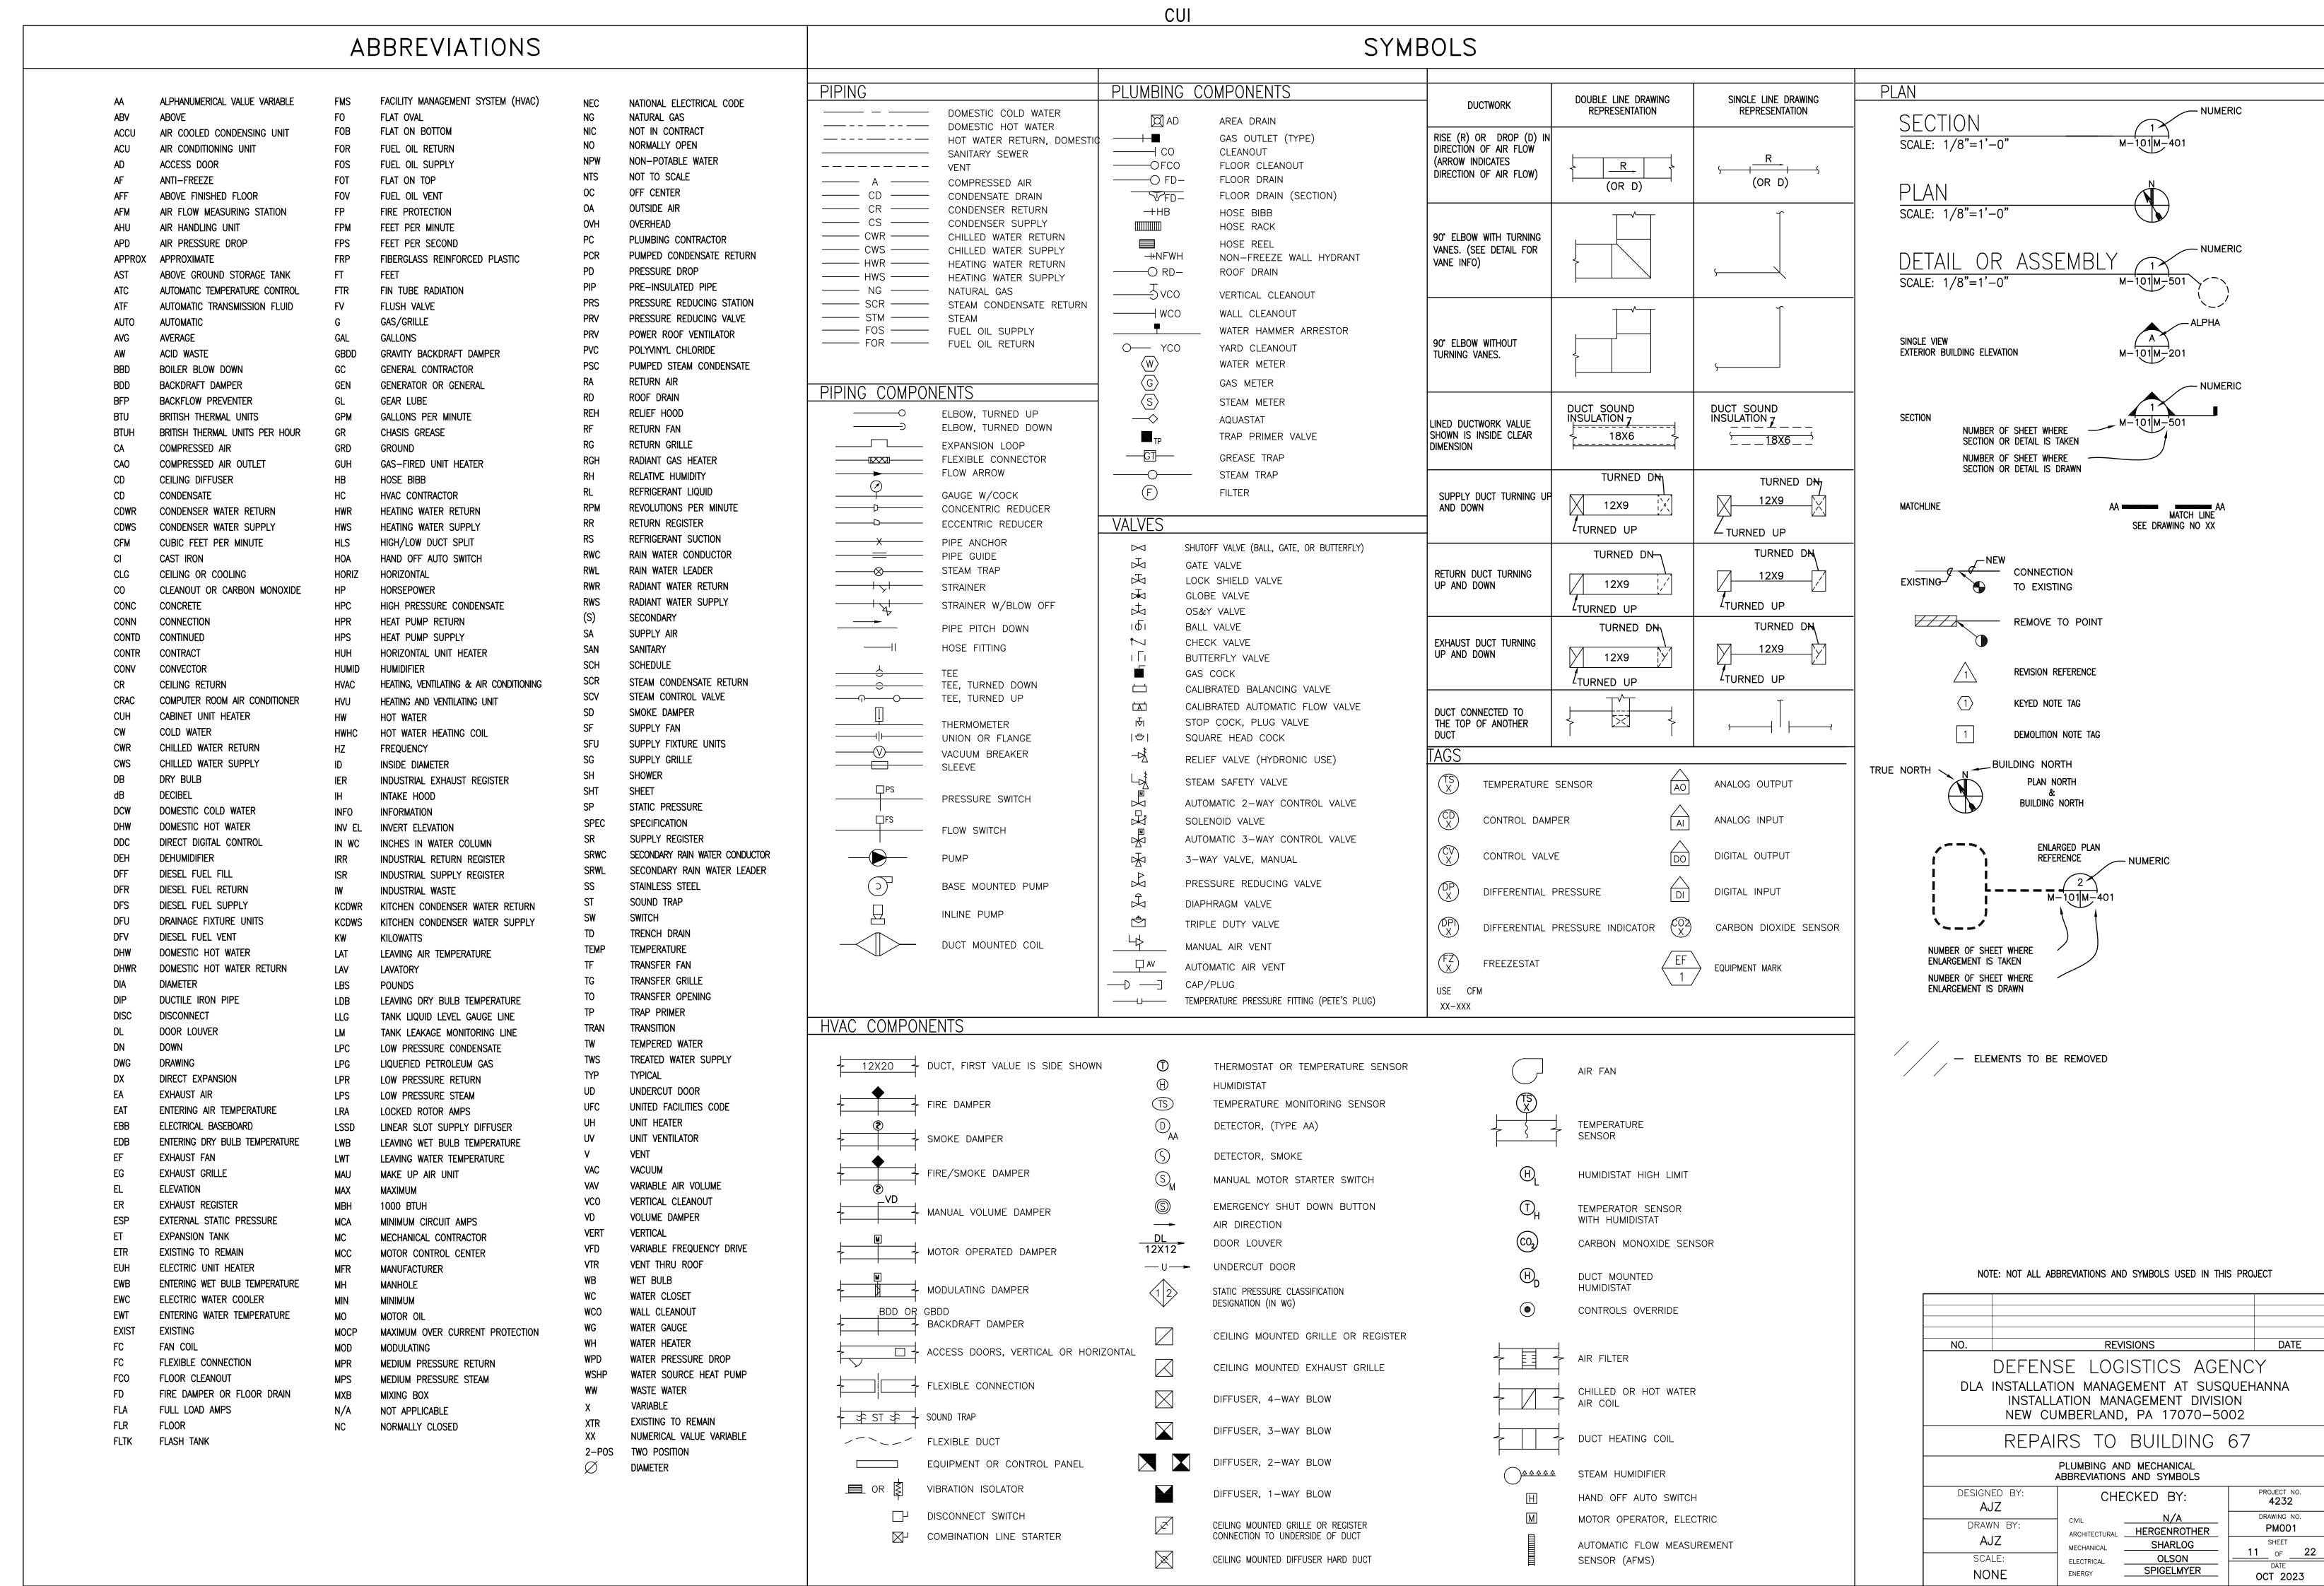

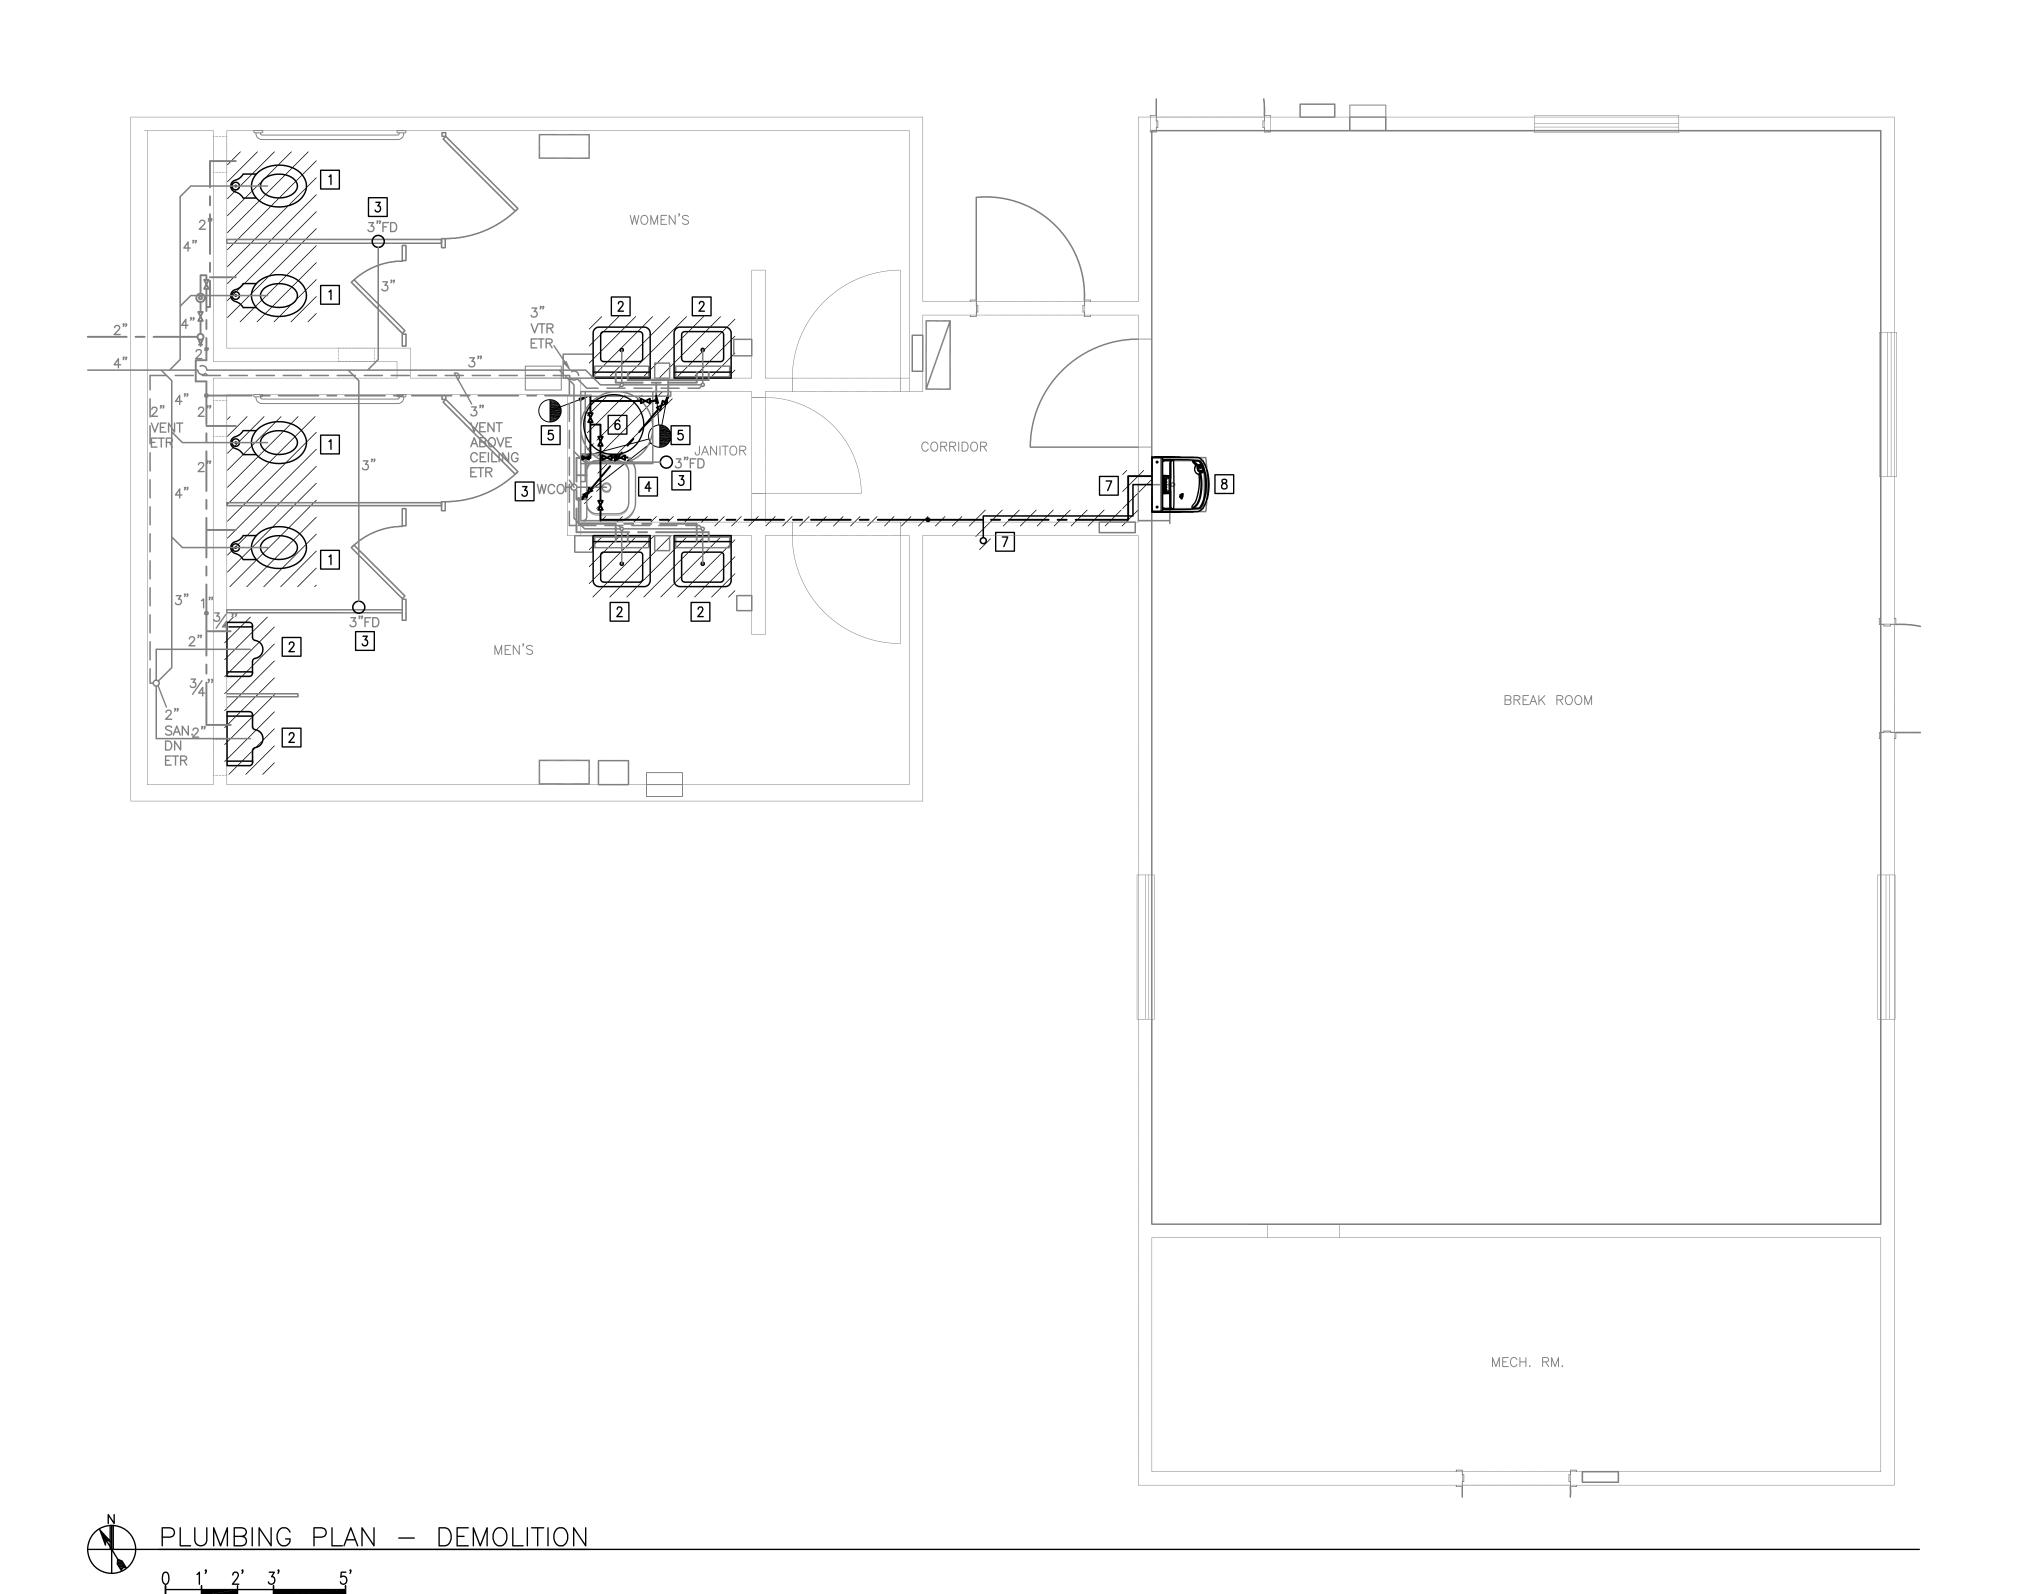

DEMOLITION KEY NOTES

- 1 USE CAUTION WHEN REMOVING. SANITARY TO BE REUSED.
- DISCONNECT DCW, DHW AND SANITARY PIPING. ACCOMMODATE FOR NEW PLAN. REFER TO ARCHITECTURAL DRAWINGS.
- 3 COMPLETELY CLEAN FLOOR DRAINS AND WALL CLEAN OUT.
- 4 COMPLETELY CLEAN UTILITY SINK.
- 5 DISCONNECTION POINT FOR DCW AND DHW PIPING.
- 6 DEMO DCW TO WATER HEATER. DEMO WATER HEATER, DCW, DHW AND ALL APPURTENANCES TO DISCONNECTION POINT KEYNOTE 5.
- 7 DEMO DCW FROM JANITOR'S CLOSET TO WATER COOLER IN BREAKROOM.
 DEMO SANITARY FROM WATER COOLER THRU WALL TO OUTSIDE. CUT
 AND CAP SANITARY ABOVE EXISTING CLEANOUT ON THE OUTSIDE OF BUILDING.
- 8 REMOVE WATER COOLER AND HOLD FOR REINSTALLATION.

GENERAL PLUMBING DEMOLITION NOTES

- THE LOCATIONS OF PLUMBING FIXTURES, PIPING, ETC. SHOWN ON THE DRAWING IS APPROXIMATE AND IS NOT INTENDED TO SHOW EXACT LOCATIONS. CHECK AND VERIFY ALL DIMENSIONS AND EXISTING CONDITIONS AT THE SITE.
- 2. REMOVE EXISTING FIXTURES AND PIPING ABOVE FLOOR AS NOTED ON DRAWINGS, INCLUDING ALL FITTINGS, VALVES, PIPE INSULATION, HANGERS,
- PATCH ALL OPENINGS IN WALLS AND FLOORS WHERE FIXTURES, PIPING AND ASSOCIATED COMPONENTS ARE REMOVED. PATCHING MUST BE SAME MATERIALS AS SURROUNDING CONSTRUCTION. 4. UNLESS NOTED OTHERWISE, MATERIALS AND FIXTURES REMOVED MUST
- BECOME THE PROPERTY OF THE CONTRACTOR AND MUST BE LEGALLY DISPOSED OF OFF THE SITE.
- 5. SEE ARCHITECTURAL DRAWINGS FOR EXTENT OF DEMOLITION OTHER THAN PLUMBING.

DATE NO. REVISIONS

DEFENSE LOGISTICS AGENCY DLA INSTALLATION MANAGEMENT AT SUSQUEHANNA INSTALLATION MANAGEMENT DIVISION NEW CUMBERLAND, PA 17070-5002

REPAIRS TO BUILDING 67

PLUMBING PLAN - DEMOLITION										
DESIGNED BY:	CHE	CKED BY:	PROJECT NO. 4232							
AJZ										
DRAWN BY:	CIVIL	N/A		RAWING N						
3	ARCHITECTURAL	<u>HERGENROTHER</u>		P-101						
AJZ	MECHANICAL	SHARLOG	12	SHEET	22					
SCALF:	FLECTRICAL	OLSON		_ ^{OF} _						

SPIGELMYER


OCT 2023

ELECTRICAL

ENERGY

SCALE:

AS NOTED

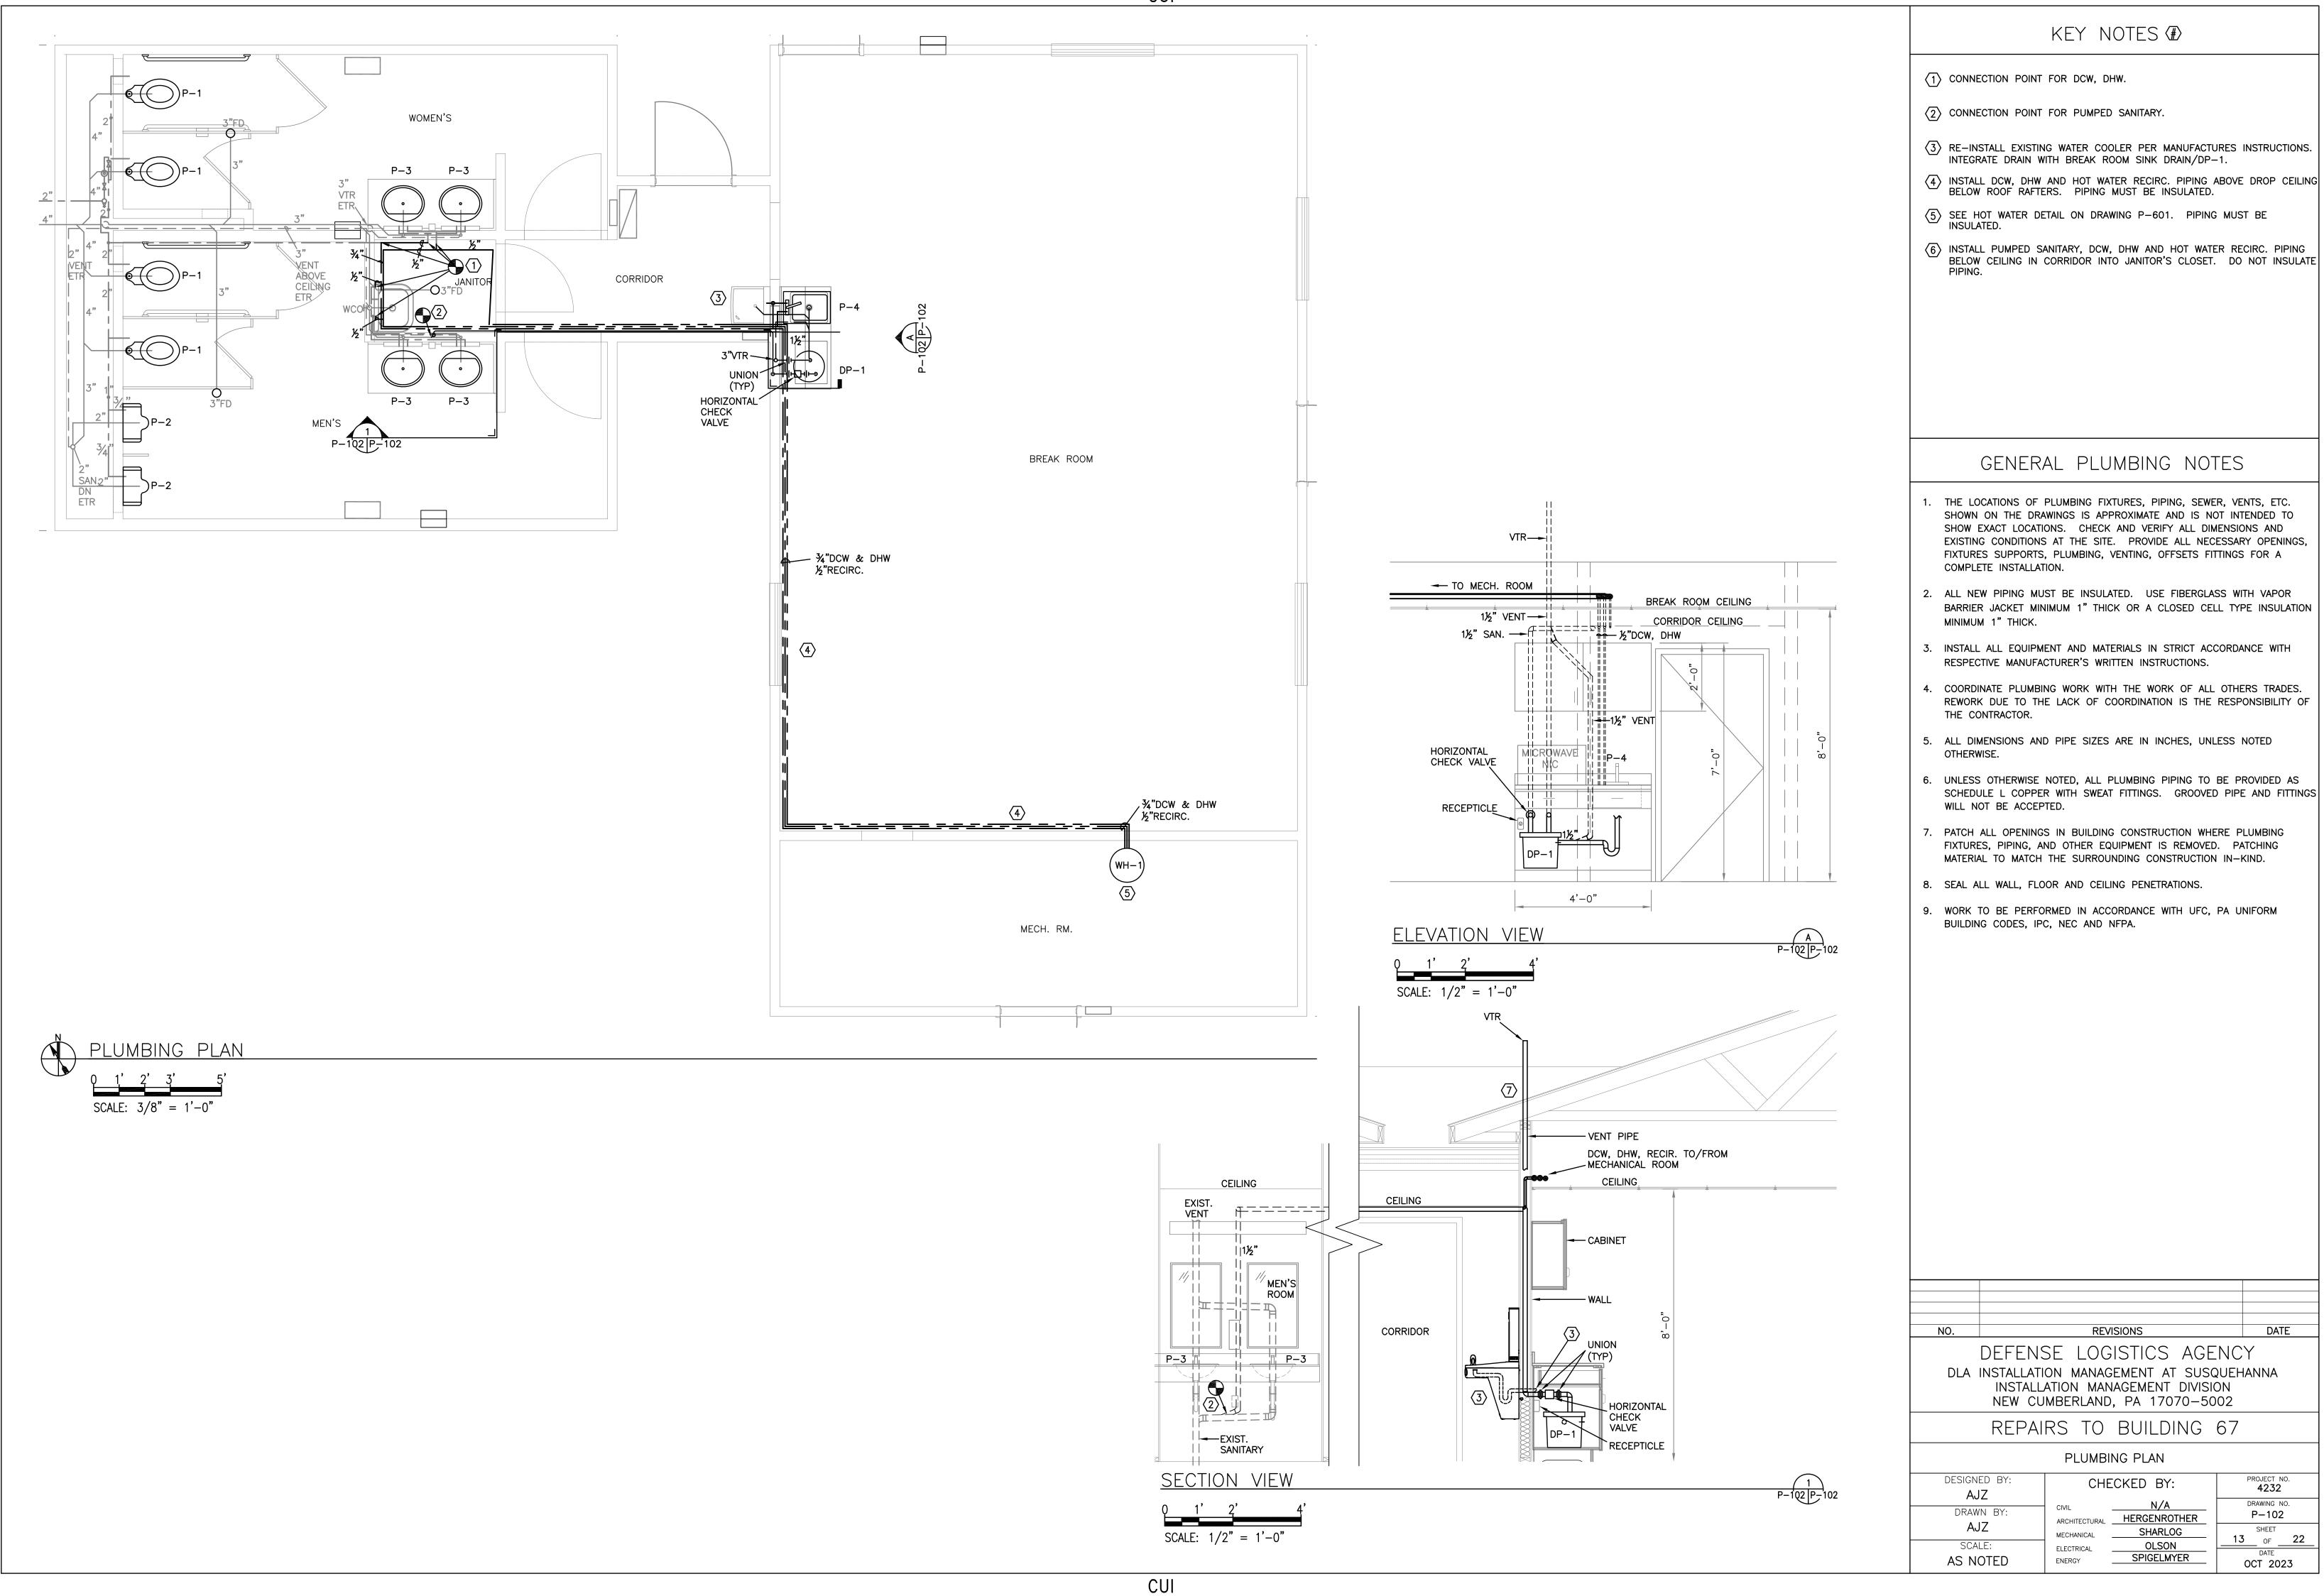

		WA	TER HEA	ΛΤΕΙ	R S	CHE	EDL	JLE		
SYMBOL	STORAGE (GALLONS)	RECOVERY (GPH) / FLOW RATE (GPM)	TEMPERATURE RISE (DEGREES)		LECTRIC			ELECTRIC INPUT	MANUFACTURER MODEL	REMARKS
	(OALLONO)	TEOW TO TE (OF IVI)	MOL (DEGINELO)	VOLTS	PHASE	HERTZ	AMPS	(KW)	WODEL	
WH-1	10	@120F = 10 GPH		208	1	60	14.4	6	EGSP10 208V	1, 2

1. BASIS OF DESIGN Rheem-Ruud

2. 21"D X 21.25" W X 18" H WATER HEATER STAND

			REC	IR	C P	UM	P S	CHI	EDULE		
SYMBOL	SERVICE	GPM	HEAD	HP	E	LECTRIC	CAL DATA	A	TYPE	MANUFACTURER	REMARKS
			(FT H₂O)		VOLTS	PHASE	HERTZ	FLA		MODEL	
RP-1	MECHANICAL ROOM	18	17	1/20	115	1	60	0.85	3-SPEED CARTRIDGE	0015-MSF3-IFC	1

1. BASIS OF DESIGN: TACO

			SU	MF	PL	JMP	SC	HE	DULE		
SYMBOL	SERVICE	GPM	HEAD	НР	E	LECTRIC	CAL DATA	4	TYPE	MANUFACTURER	REMARKS
			(FT H₂O)		VOLTS	PHASE	HERTZ	FLA		MODEL	
DP-1	BREAK ROOM	25	20	1/2	115	1	60	9.4	DRAIN PUMP SERIES	131	1

1. BASIS OF DESIGN: ZOELLER


	PLUM	BING	GΕ	QUI	PM	EN.	TSC	CHE	DUI	_E	
							ELEC	TRICAL I	DATA		
SYMBOL	EQUIPMENT	HW	CW	WASTE	VENT	KW/HP	VOLTS	PHASE	HERTZ	MANFACTURER	REMARKS
P-1	WATER CLOSET		1"	4"						KOHLER	2
P-2	URINAL		3/4"	2"						KOHLER	3
P-3	LAVATORY	1/2"	1/2"	1 1/2"						KOHLER	4
P-4	LAVATORY	1/2"	1/2"	1 1/2"	1 1/2"					ELKAY	5,6

1. AS INDICATED IN FIXTURE SCHEDULE


- 2. VITREOUS CHINA, HIGH EFFICIENCY, FLOOR MOUNTED BOTTOM OUTLET ELONGATED FRONT RIM WITH INTEGRAL BEDPAN LUGS AND 1-1/2" INLET SPUD TOILET SYSTEM K-96057. 1.28 GPF, 30-YEAR HYBRID ENERGY CELL POWERED, HIGH EFFICIENCY SENSOR FLUSHOMETER, K-10TH00N10. ELONGATED, STANDARD WHITE, OPEN FRONT TOILET SEAT LESS COVER WITH STAINLESS STEEL CHECK HINGE, K-4731-CA.
- 3. 24" MOUNTING HEIGHT, VITREOUS CHINA URINAL, 3/4" TOP SPUD K-4991-ET. 0.5 GPF, 30-YEAR HYBRID ENERGY CELL POWERED, SENSOR FULLSHOMETER K-101H00G20
- 4. HYBRID ENERGY CELL POWERED SENSOR FAUCET, K-7514. UNDERSIDE OF SINK IS FULLY PROTECTED BY HEAVY DUTY SOUND GUARD
- UNDERCOATING TO REDUCE CONDENSATION AND DAMPEN SOUND, AND UNDERSINK PIPING COVERS. THERMOSTATIC MIXING VALVE.
 5. CLASSIC STAINLESS STEEL 22"X15"X7.625" SINGLE BOWL DROP-IN SINK. LUSTROUS SATIN FINISH, MODEL #LR1522
- 6. ELKAY THREE HOLE DECK MOUNT KITCHEN FAUCET WITH LEVER HANDLE AND ESCUTCHEON CHROME. MODEL #LK1000CR

			EXPA	NSION	TANK	SCHEDUL	.E	
SYMBOL	LOCATION	TANK VOL (GAL.)	EXPAN. VOL (GAL.)	DIAM. (IN)	LENGTH (IN)	MANUFACTURER MODEL	APPROX. OPERATING W.T. (LBS)	REMARKS
ET-1	MECH. ROOM	2	0.45	8	14	ST-5C-DD	10	1

1. BASIS OF DESIGN: AMTROL

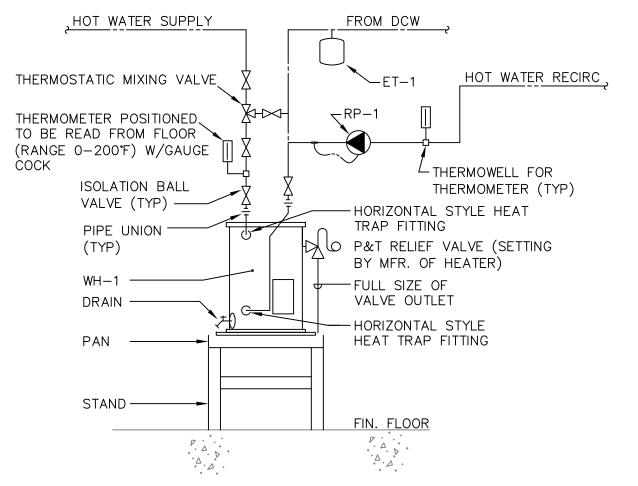

1 ELECTRIC WATER HEATER W/RECIR PUMP DETAIL P-601) scale: nts

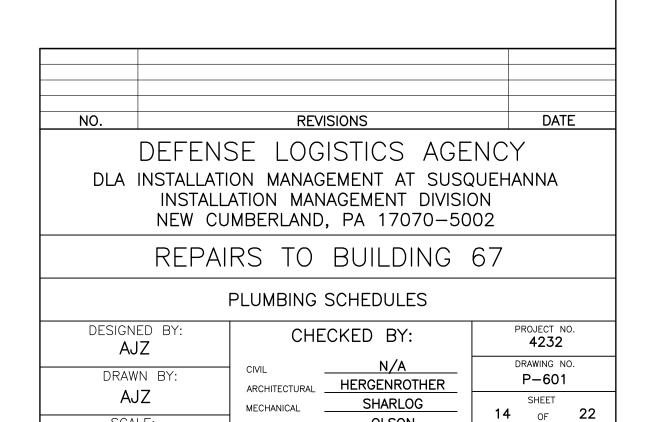

ELECTRICAL

ENERGY


OLSON

OCT 2023

SPIGELMYER

SCALE:

NONE

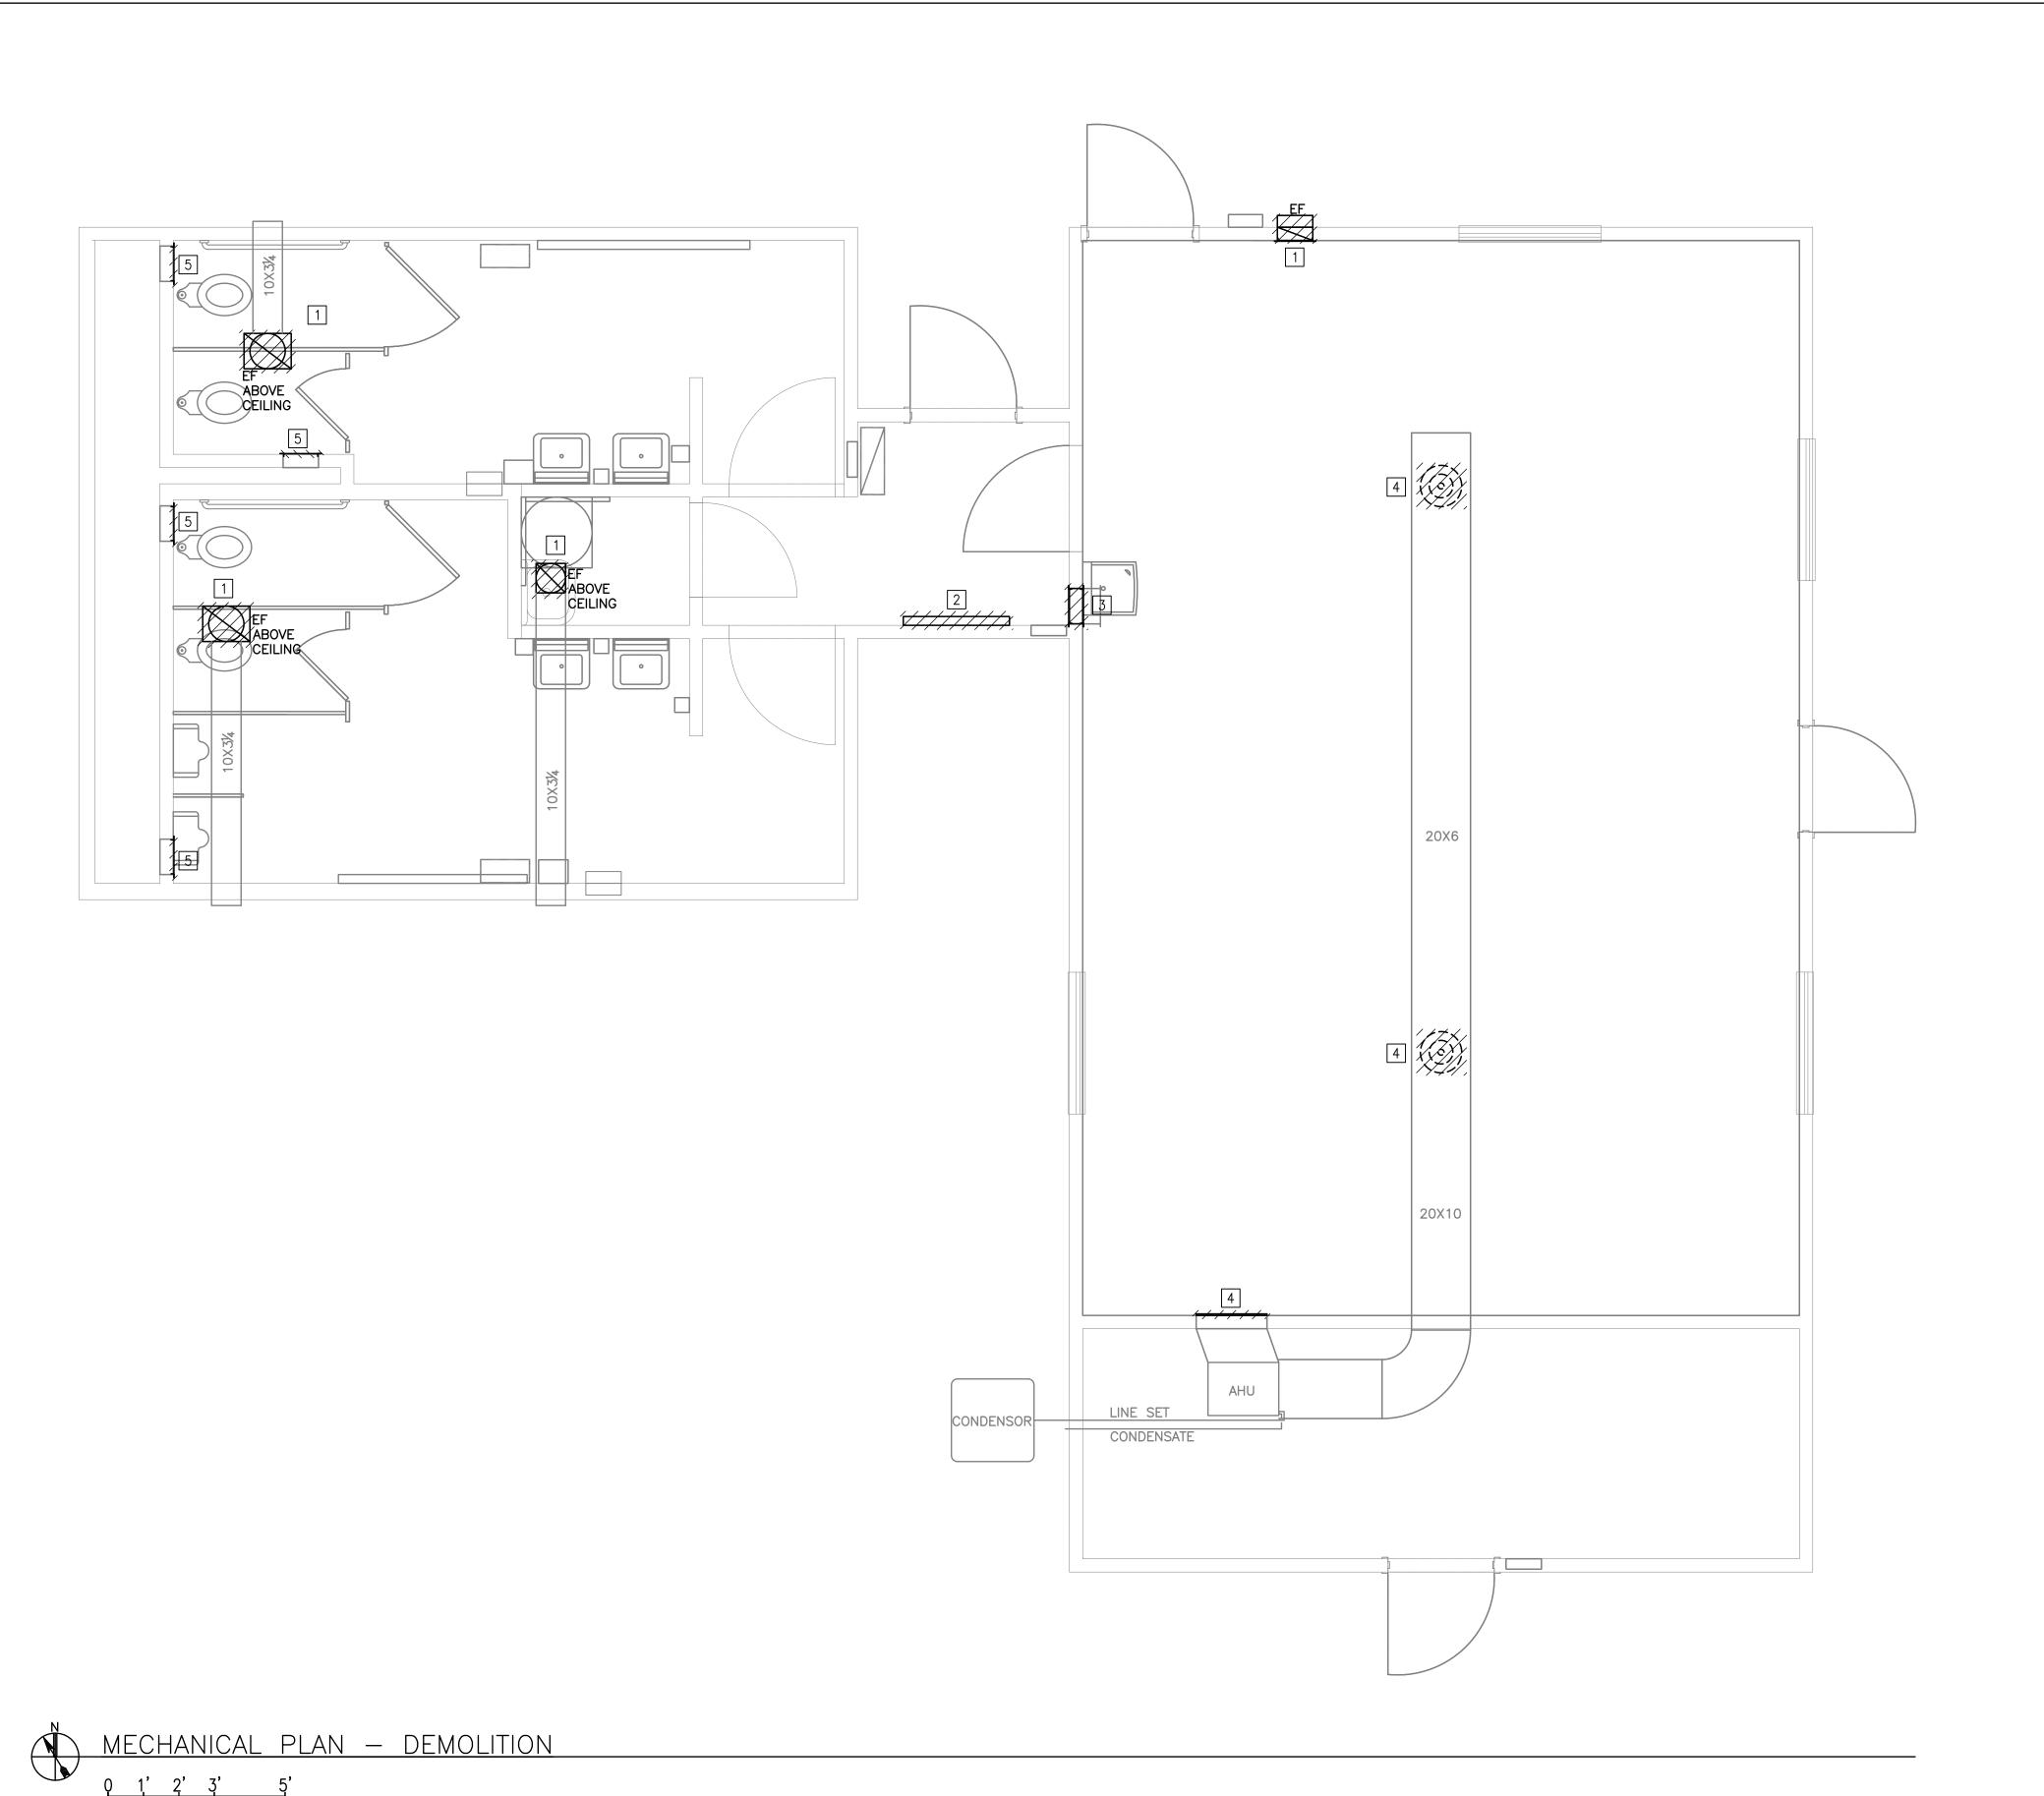

DEMOLITION KEY NOTES #

- DEMOLISH EXHAUST SYSTEM INCLUDING ALL DUCTWORK, GRILLE, FAN, WALL CAP WITH BACK DRAFT DAMPER, CONTROLS AND ALL APPURTENANCES.
- 2 DEMOLISH ELECTRIC HEATER.
- 3 DEMOLISH TRANSFER DUCT AND GRILLES.
- 4 DEMOLISH DIFFUSERS AND GRILLE.
- 5 DEMOLISH GRILLE.

HVAC DEMOLITION NOTES

- REMOVE AND DISPOSE OF HAZARDOUS MATERIALS ASSOCIATED WITH MECHANICAL EQUIPMENT IN ACCORDANCE WITH LOCAL, STATE AND FEDERAL REGULATIONS.
- 2. PROVIDE ALL CUTTING AND PATCHING NECESSARY WHERE EQUIPMENT IS REMOVED.
- UNLESS NOTED OTHERWISE, MATERIALS AND EQUIPMENT REMOVED SHALL BECOME THE PROPERTY OF THE CONTRACTOR AND SHALL BE LEGALLY DISPOSED OF OFF THE SITE.
- 4. DEMOLITION, CUTTING, AND PATCHING WHERE INDICATED ON THE DRAWINGS IS INTENDED ONLY AS A GUIDELINE FOR UNDERSTANDING THE SCOPE OF WORK AND TO BE USED ONLY FOR THAT PURPOSE.
- 5. ALL DIMENSIONS ARE FROM EXISTING DRAWINGS FOR QUANTITY TAKEOFFS ONLY, FIELD VERIFY ACTUAL DIMENSIONS.
- 6. PROVIDE TEMPORARY PROTECTION FOR SENSORS AS NECESSARY DURING REMOVAL AND REINSTALLATION OF EQUIPMENT.
- 7. PROVIDE TEMPORARY DUST PROTECTION FOR AREAS WHEN WORK IN ADJACENT SPACES IS BEING DONE.
- 8. CONTRACTOR TO PROTECT WALLS AND FLOOR DURING CONSTRUCTION.
 DAMAGED AREAS AS A RESULT OF CONTRACTOR'S WORK SHALL BE
 REPAIRED OR REPLACED AS DIRECTED BY THE COR AT THE CONTRACTOR'S
 EXPENSE
- 9. COORDINATE WITH ALL OTHER DISCIPLINES TO COMPLETE SCOPE AND CONSTRUCT A COMPLETE, FUNCTIONAL SYSTEM.


NO. REVISIONS DATE

DEFENSE LOGISTICS AGENCY
DLA INSTALLATION MANAGEMENT AT SUSQUEHANNA
INSTALLATION MANAGEMENT DIVISION
NEW CUMBERLAND, PA 17070-5002

REPAIRS TO BUILDING 67

MECHANICAL PLAN — DEMOLITION

DESIGNED BY: AJZ	CHE	CKED BY:	PROJECT NO. 4232
DRAWN BY: AJZ	CIVIL ARCHITECTURAL MECHANICAL	N/A HERGENROTHER SHARLOG	DRAWING NO. M-101 SHEET 15 OF 22
SCALE: AS NOTED	ELECTRICAL ENERGY	OLSON SPIGELMYER	OCT 2023

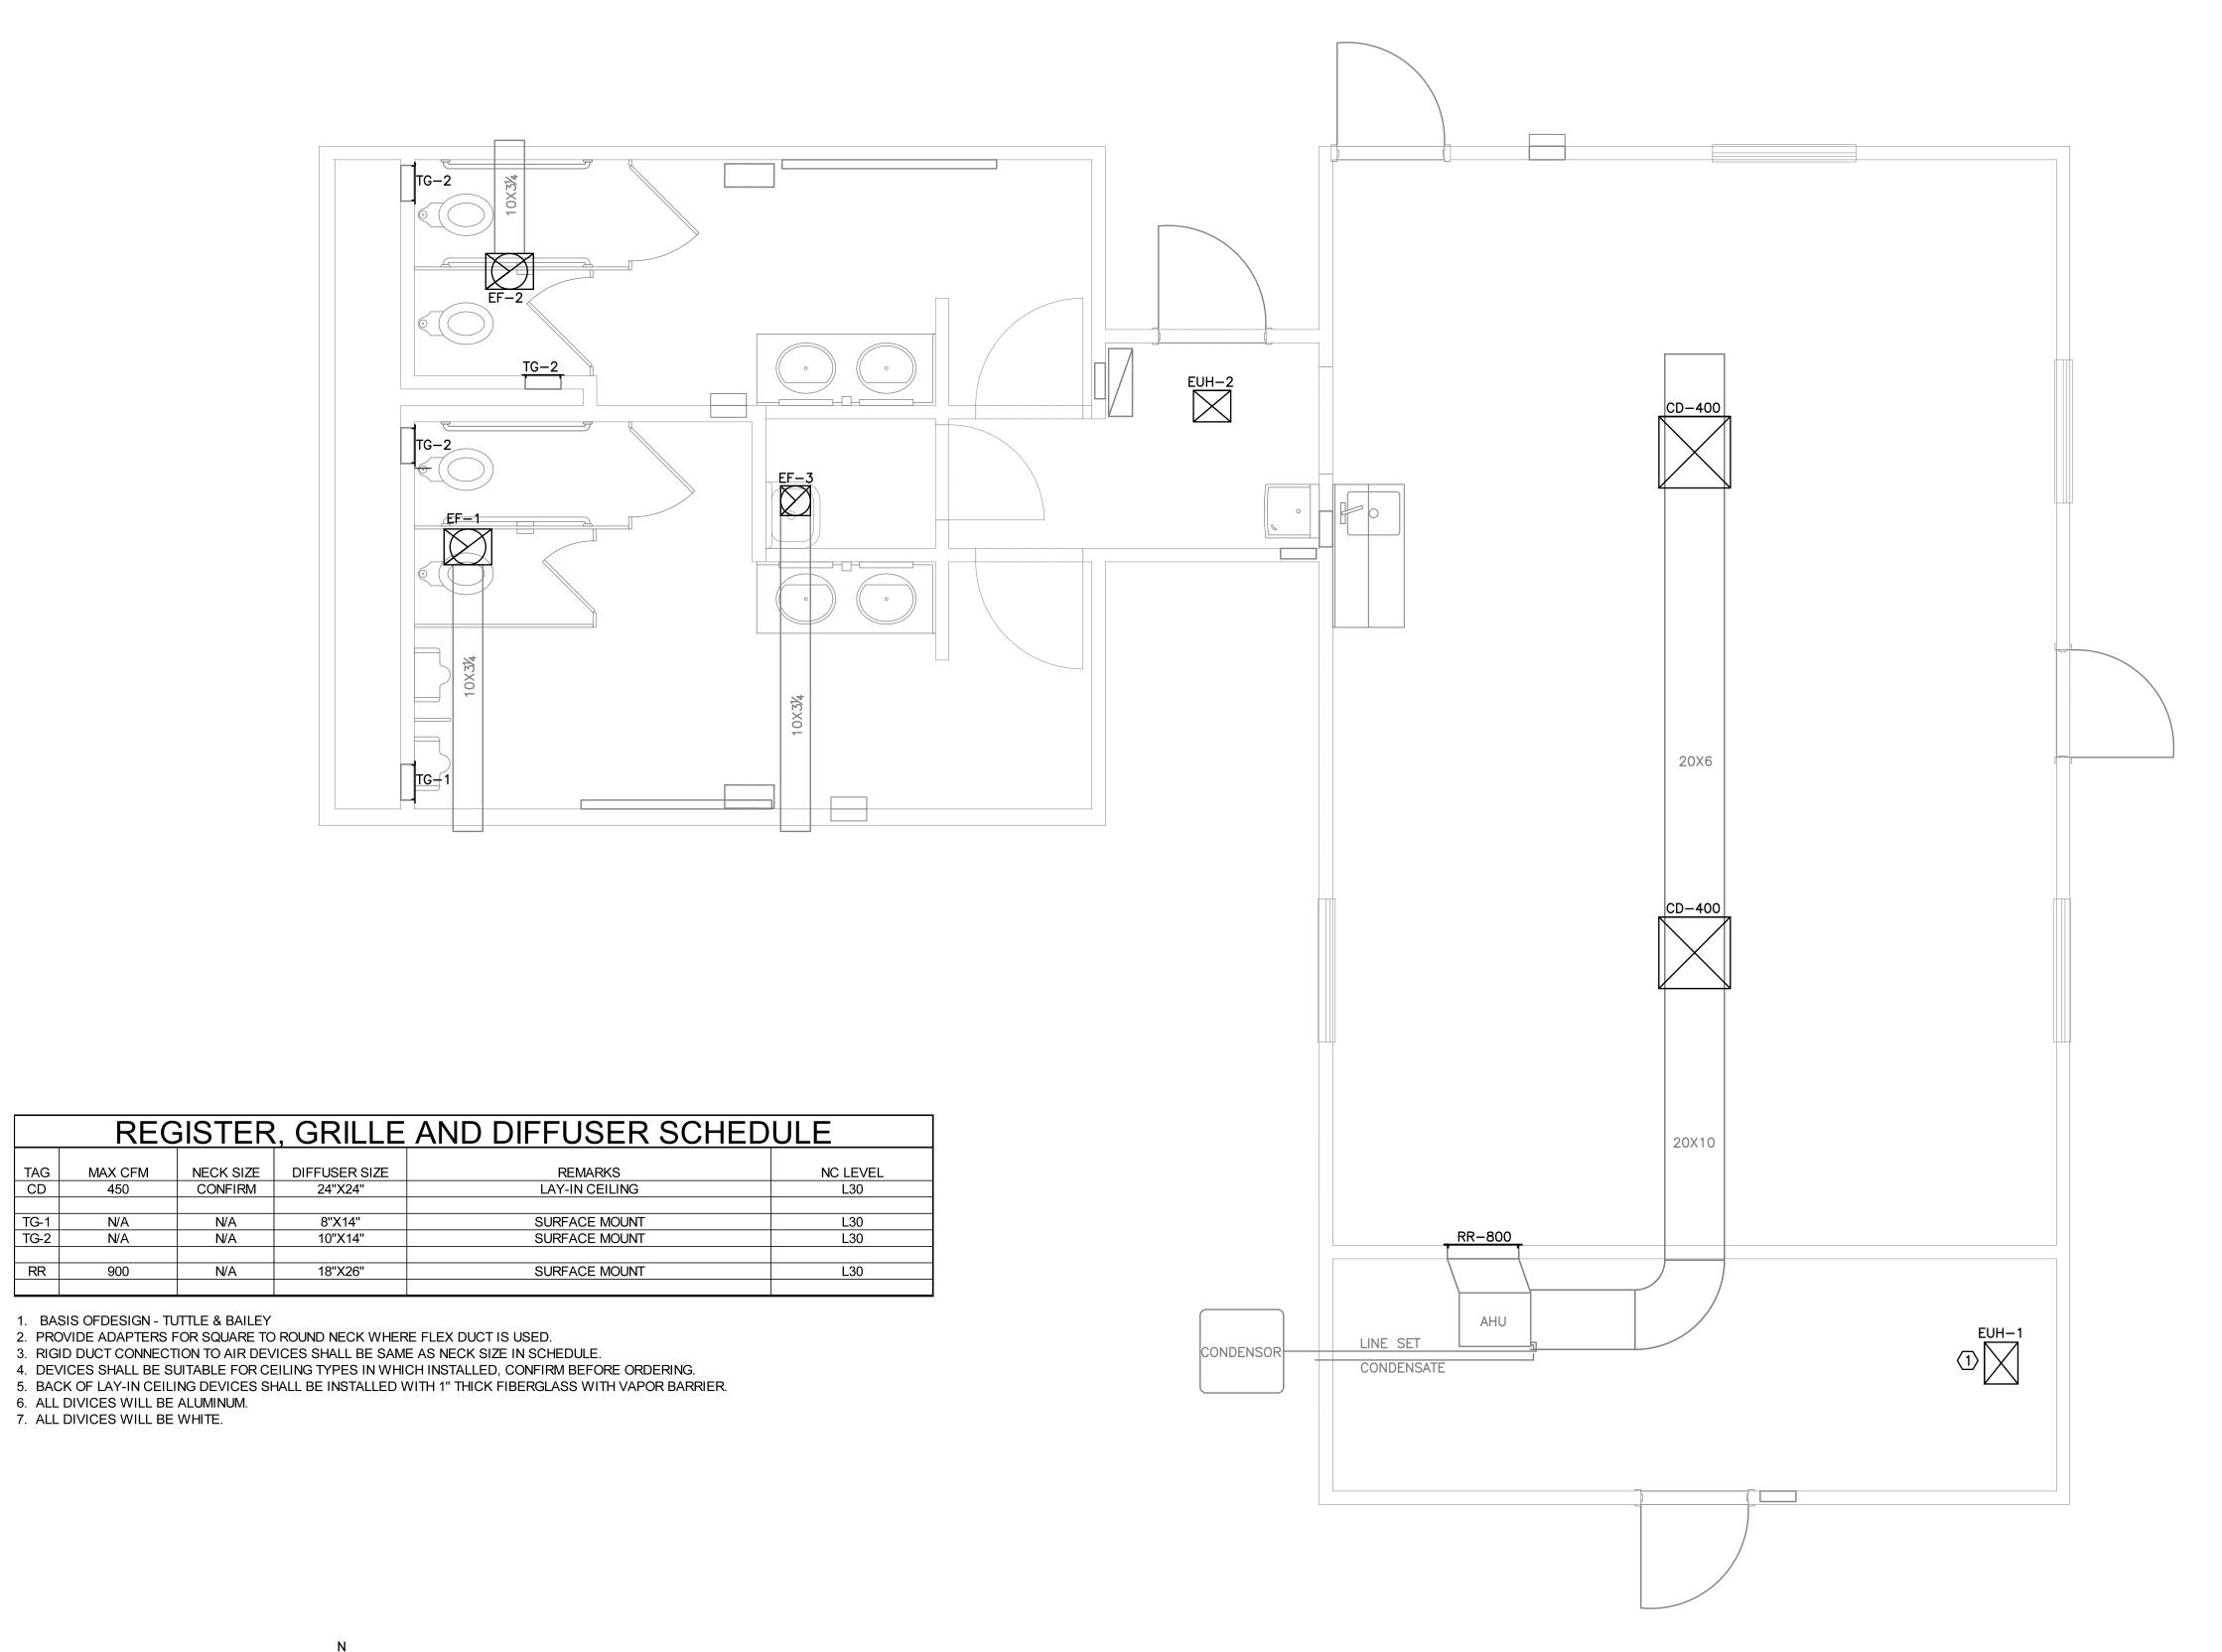

N	MECHANICAL PLAN	
	, Q 1, 2, 3, 5,	
	SCALE: $3/8" = 1'-0"$	

	ELE	CTRI	C UN	ITIV	HEA	TE	R S	CHE	DULE	
TAG	LOCATION	MIN. CKT		ELEC	TRICAL D	ATA		WEIGHT	MODEL NUMBER	NOTES
NUMBER	EOCATION	(AMPS)	VOLTS	HERTZ	KW	AMPS	(LBS)	IVIODEL NOIVIDEN	NOILS	
EUH-1	MECHANICAL ROOM	11.3	208	1	60	1.9	9	24	MW UH5004	1,2,3,5,6,7
EUH-2	CORRIDOR		208	1	60	1.5	7.2	10	QCH1202F	ALL

- 1. BASIS OF DESIGN: QMARK
- 2. PROVIDE UNIT WITH THERMAL CUTOUT, BI-METALLIC SNAP-ACTION TYPE, DESIGNED TO AUTOMATICALLY SHUT OFF AND REACTIVATE
- HEATER BASED ON TEMPERATURE LIMITS.
- 3. PROVIDE DISCONNECT SWITCH WITHIN HEATER ENCLOSURE.
- 4. PROVIDE UNIT HEATER ENCLOSURE HARDWARE NECESSARY TO FLUSH MOUNT UNIT HEATER IN CEILING.
- 5. EXPOSED FACE GRILLE WILL BE NORTHERN WHITE COLOR. 6. PROVIDE REMOTE MOUNTED THERMOSTAT WITH A SET POINT RANGE OF 45 TO 90 °F.
- 7. HEATER IS FACTORY WIRED FOR HIGHEST WATTAGE RATING. CONVERT UNIT TO SCHEDULED WATTAGE. CONSULT IOM FOR DETAILED INSTRUCTIONS.

				E	XHA	UST	FAN	SC	HEDULE				
				ELI	ECTRICAL	_ DATA			FAN PHYSI	CAL CHARACTI	ERISTICS		
		AIRFLOW	MAX.	MOTOR							FAN NOISE		
SYMBOL	LOCATION	(CFM)	INPUT WT	RPM	VOLTS	PHASE	HERTZ	FLA	GRILLE SIZE	UNIT WEIGHT	(SONES)	MODEL	REMARKS
EF-1	MEN'S	300	121	1,000	115	1	60	1.74	19.3 X 16.3	31	3.0	SP-A410	ALL
EF-2	WOMEN'S	150	54.2	1,400	115	1	60	0.45	14.8 X 13.2	17	5.4	SP-A190	ALL
EF-3	JANITOR	30	25.9	790	115	1	60	0.33	14.8 X 13.2	12	4.0	SP-A50	ALL
		_			NO	<u>DTES</u>					_	_	

- 1. BASIS OF DESIGN: GREENHECK
- 2. PROVIDE NON-FUSED DISCONNECT SWITCH FOR FAN
- 3. PROVIDE BACKDRAFT DAMPER
- 4. PROVIDE POTENTIOMETER MOUNTED ON MOTOR FOR SPEED ADJUSTMENT DURING BALANCING
- 5. INTERLOCK FAN WITH LIGHTING CONTROLS

KFY	NOTES	$\langle \overline{t}$
1 / 🗀 1	1101L3	VII

7'6" TO BOTTOM OF HEATER MINIMUM.

HVAC NOTES

- 1. THE LOCATIONS OF DUCTWORK SHOWN ON THE DRAWINGS IS APPROXIMATE AND IS NOT INTENDED TO SHOW EXACT LOCATIONS. CHECK AND VERIFY ALL DIMENSIONS AND EXISTING CONDITIONS AT THE SITE. PROVIDE ALL NECESSARY OFFSETS AND FITTINGS FOR A COMPLETE INSTALLATION.
- 2. INSTALL ALL EQUIPMENT AND MATERIALS IN STRICT ACCORDANCE WITH RESPECTIVE MANUFACTURER'S WRITTEN INSTRUCTIONS.
- 3. COORDINATE HVAC WORK WITH THE WORK OF ALL OTHERS TRADES. REWORK DUE TO THE LACK OF COORDINATION IS THE RESPONSIBILITY OF THE CONTRACTOR.
- 4. ALL DIMENSIONS AND SIZES ARE IN INCHES, UNLESS NOTED OTHERWISE.
- 5. FABRICATE AND INSTALL DUCTWORK IN ACCORDANCE WITH SMACNA STANDARDS.
- 6. INSTALL ALL WORK IN ACCORDANCE WITH ALL APPLICABLE CODES AND REGULATIONS, FEDERAL, STATE AND LOCAL INCLUDING UFC, PA UNIFORM BUILDING CODES, NEC, INTERNATIONAL MECHANICAL CODE, AND NFPA.
- 7. EXISTING EQUIPMENT AND MATERIALS TO REMAIN, UNLESS OTHERWISE NOTED.
- 8. SYSTEMS TO BE BALANCED AFTER ALL DUCTWORK IS INSTALLED AND SYSTEM IS OPERATIONAL.
- 9. ALL DUCTWORK DIMENSIONS ARE INSIDE CLEAR AREA OF DUCT. DUCTWORK TO BE 24 GA. GALVANIZED STEEL.
- 10. ALL DAMPERS ARE TO BE INSTALLED INSIDE DUCTWORK. THE USE OF DAMPERS AT TERMINAL POINTS IS NOT ACCEPTABLE.

NO. DATE REVISIONS

DEFENSE LOGISTICS AGENCY DLA INSTALLATION MANAGEMENT AT SUSQUEHANNA INSTALLATION MANAGEMENT DIVISION NEW CUMBERLAND, PA 17070-5002

REPAIRS TO BUILDING 67

	MECHANI	CAL PLAN	
DESIGNED BY: AJZ	CHE	CKED BY:	PROJECT NO. 4232
DRAWN BY:	CIVIL	N/A HERGENROTHER	DRAWING NO. M-102
AJZ	MECHANICAL	SHARLOG	SHEET 16 OF 2 2
SCALE: AS NOTED	ELECTRICAL ENERGY	OLSON SPIGELMYER	DATE OCT 2023

OCT 2023



IR IO.	DESCRIPTION		:UIT AKER		LO	AD -	- KV	4		CIR NO.	DESCRIPTION	CIRCUIT BREAKE	
		POLE	AMP	Α	Ø	В	Ø	С	Ø			POLE	= AN
1 3 U	UNKNOWN		40								HEAT PUMP INSIDE UNIT	2	5
_	EC OFFICE EC OFFICE S WALL	1 1	20							4	HEAT PUMP OUTSIDE UNIT	2	3
	IGHTS EXIT	1	20							_	DSS SYSTEM	1	2
1 LI	IGHTS	1	20							12	MECH RM LIGHTS	1	2
3 S	PARE	1	20							14	REC OFFICE SW WALL	1	2
	PARE	1	20							_	REC OFFICE	1	2
-	PACE									_	SPACE		-
	PACE									_	SPACE		┶
	PACE										SPACE		┷
23 S	PACE						-			24	SPACE		-
		TO	TALS										

EXISTING PANELBOARD Z002 SCHEDULE NOTES

PANFI BOARD 7002 AND CIRCUIT BREAKERS MUST BE DELIVERED TO THE CONTRACTING OFFICER'S REPRESENTATIVE AND PLACED IN STORAGE AT BUILDING 750 STORE ROOM.

POLE AMP A Ø B Ø C Ø NO. POLE AMP A Ø B Ø C Ø NO.	CIR NO.			CIRCUIT BREAKER							CIR NO.			CIRCUIT BREAKER	
3 SERVICE DISCONNECT 2 40 4 SPACE 1 1 1 1 1 1 1 1 1	NO.	BESCINI HOW	POLE	AMP	Α	Ø	В	Ø	С	Ø	110.			POLE AMP	
1 1 20 6 BASE BOARD HEATER 7 WATER HEATER 1 20 8 MENS ROOM 2 9 REC BATHROOMS 1 20 10 BASE BOARD HEATER 2 11 REC OFFICE 1 20 12 WOMENS ROOM 2 13 A/C OFFICE 2 20 14 BASE BOARD HEATER 2 16 CORRIDOR 2 17 SPACE 18 REC OFFICE WEST WALL -	1	SERVICE DISCONNECT	2	40							_		1	20	
7 WATER HEATER 1 20 8 MENS ROOM 2 9 REC BATHROOMS 1 20 10 BASE BOARD HEATER 2 11 REC OFFICE 1 20 12 WOMENS ROOM 2 13 A/C OFFICE 2 20 14 BASE BOARD HEATER 2 15 PACE 18 REC OFFICE WEST WALL -			1								<u> </u>		1	20	
9 REC BATHROOMS 1 20 10 BASE BOARD HEATER 2 11 REC OFFICE 1 20 12 WOMENS ROOM 2 13 A/C OFFICE 2 20 14 BASE BOARD HEATER 2 16 CORRIDOR 2 18 REC OFFICE WEST WALL -													2	20	
11 REC OFFICE	,	1	1								10		+		
15 A/C OFFICE 2 20 16 CORRIDOR 2 17 SPACE 18 REC OFFICE WEST WALL -	11	REC OFFICE	1								12		2	20	
		A/C OFFICE	2	20							1 ' '		2	20	
19 SPACE 20 SPACE -	17	SPACE	_	- 1							18	REC OFFICE WEST WALL	_	-	
	19	SPACE	_	_							20	SPACE	_	_	
TOTALS			TOT	TALS[

EXISTING PANELBOARD Z1 SCHEDULE NOTES


1. PANELBOARD Z1 SCHEDULE SHOWN FOR CIRCUIT DEMOLITION REFERENCE ONLY.

IR 10.	DESCRIPTION	CIRCUIT LOAD - KVA CIR NO. DESCRIPTION		CIRCUIT BREAKER									
ا. ن		POLE	AMP	Α	Ø	В	Ø	С	Ø		22001	POLE	AMF
	DSS SYSTEM	1	20							2	HEAT PUMP	2	50
	RECEPT MECH RM	1	20							4			
$\overline{}$	RECEPT WEST	1	20							6	CONDENSER	2	30
	RECEPT GFCI FOUNTAIN	1	20							8			
	RECEPT COUNTER TOP	1	20							10	EHU-1		15
	RECEPT OFFICE E WALL	1	20							Z			
	RECEPT OFFICE S WALL	1	20							14 16	EHU-2	2	15
	RECEPT PRINTER	1	20							10			
	LTS OFFICE & EXTERIOR	1	20							18 20	EHU-3 (EXISTING)	2	20
	LTS BATH & JANITOR LTS MECH RM	1	20							22			
	RESTROOM RECEPTACLES	1	20							24	EHU-4 (EXISTING)	2	20
	SPARE	1	20								SUMP PUMP	1	15
	SPARE	1	20							28			
_	SPARE	1	20							30	HOT WATER HEATER	2	20
	SPARE	1	20								EXHAUST FANS	1	15
$\overline{}$	SPARE	1	20								SPARE	1	20
$\overline{}$	SPARE	1	20								SPARE	1	20
_	SPARE	1	20								SPARE	1	20
$\overline{}$	SPARE	1	20								SPARE	1	20
	SPARE	1	20								SPARE	1	20
		TO	TALS										


PANELBOARD Z002 SCHEDULE KEY NOTES

- PANELBOARD Z002 IS GOVERNMENT FURNISHED, CONTRACTOR INSTALLED. PANELBOARD Z002 IS PRE-POPULATED WITH (42) 120V 20A/1P CIRCUIT BREAKERS.
- REMOVE EXISTING CIRCUIT BREAKER FROM PANELBOARD ZOO2 AND TURN OVER TO THE COR.
- PROVIDE NEW 10KA CIRCUIT BREAKER, AMPERE RATING AND NUMBER OF POLES AS INDICATED.
- PROVIDE PANELBOARD SCHEDULE WHEN COMPLETE.


	LIGHT FIXTURE SCHEDULE							
	T			LIGHT	-IXTUKE S	HEDULE		
LEGEND		LAMPS		FIXTURE	MOUNTING			
SYMBOL	DESCRIPTION	TYPE	WATTS	VOLTAGE	MOUNTING	BASIS OF DESIGN CATALOG NO.	ADDITIONAL NOTES	
			WAIIS					
	LED 2'X4' RECESSED DIRECT/INDIRECT TROFFER	LED	23	120	RECESSED GRID	LITHONIA MODEL NO. 2VTL4 30L ADPT EZ1 LP840	DIMMABLE, 4000K COLOR TEMP, 3000 LUMENS	
В	LED 2'X4' RECESSED DIRECT/INDIRECT TROFFER	LED	23	120	RECESSED GRID	LITHONIA MODEL NO. 2VTL4 30L ADPT EZ1 LP840 EL7L	DIMMABLE, 4000K COLOR TEMP, 3000 LUMENS, EMERGENCY BATTERY BACKUP	
•	12" ROUND SURFACE MOUNT LED DOWNLIGHT	LED	26	120	SURFACE MOUNT CEILING	COOPER MODEL NO. SMD12R209SWHE	SET TO 4000K COLOR TEMP, 2000 LUMENS	
D	LED WRAP AROUND WALL MOUNT VANITY	LED	35	120	SURFACE MOUNT	LITHONIA MODEL NO. FMVCSLS 48IN MVOLT 30K35K40K 90CRI BN	DIMMABLE, SELECTABLE COLOR TEMP, SET TO 400K	
_E	LED SURFACE MOUNTED SHOP LIGHT FIXTURE	LED	30	120	SURFACE MOUNT	LITHONIA MODEL NO. ZL1D L48 SMR 3000LM FST MVOLT 40K 80CRI E7W WH	4000K COLOR TEMP, 3000 LUMENS, EMERGENCY BATTERY BACKUP	
A	LED SURFACE MOUNTED EXTERIOR WALL SCONCE	LED	20	120	SURFACE MOUNT	LITHONIA MODEL NO. WDGE2 LED P1 40K 80CRI VW MVOLT SRM E4WH PE BAA DDBXD	4000K COLOR TEMP, 4W, EMERGENCY BATTERY BACKUP, BUTTON PHOTOCELL	
⊗	LED EXIT SIGN	LED	2	120	CEILING/ WALL MOUNT	PROGRESS LIGHTING MODEL NO. PETPEUR30	RED LETTERS, WHITE HOUSING WITH EMERGENCY BATTERY BACKUP	

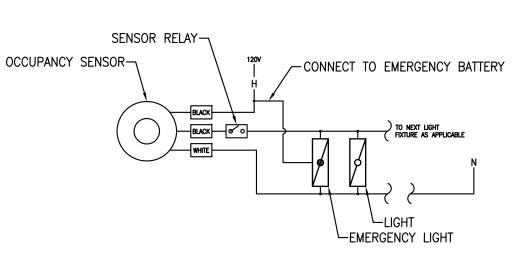


TYPICAL OFFICE OCCUPANCY SENSOR WIRING DIAGRAM

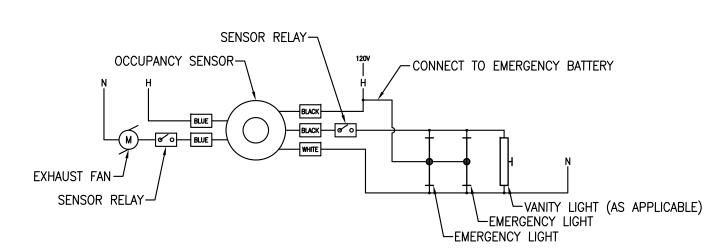


TYPICAL RESTROOM OCCUPANCY SENSOR WIRING DIAGRAM

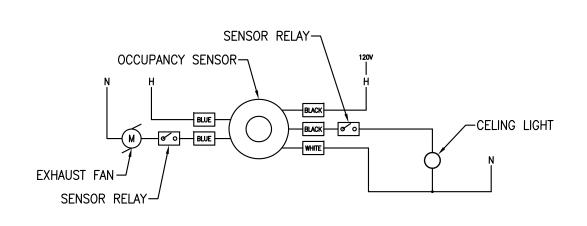

JANITOR CLOSET OCCUPANCY SENSOR WIRING DIAGRAM

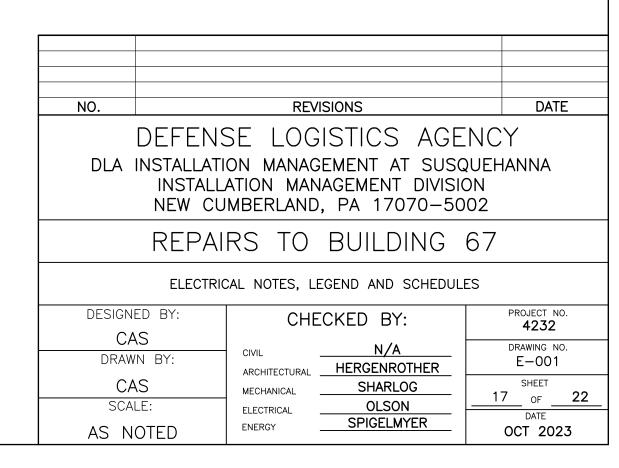

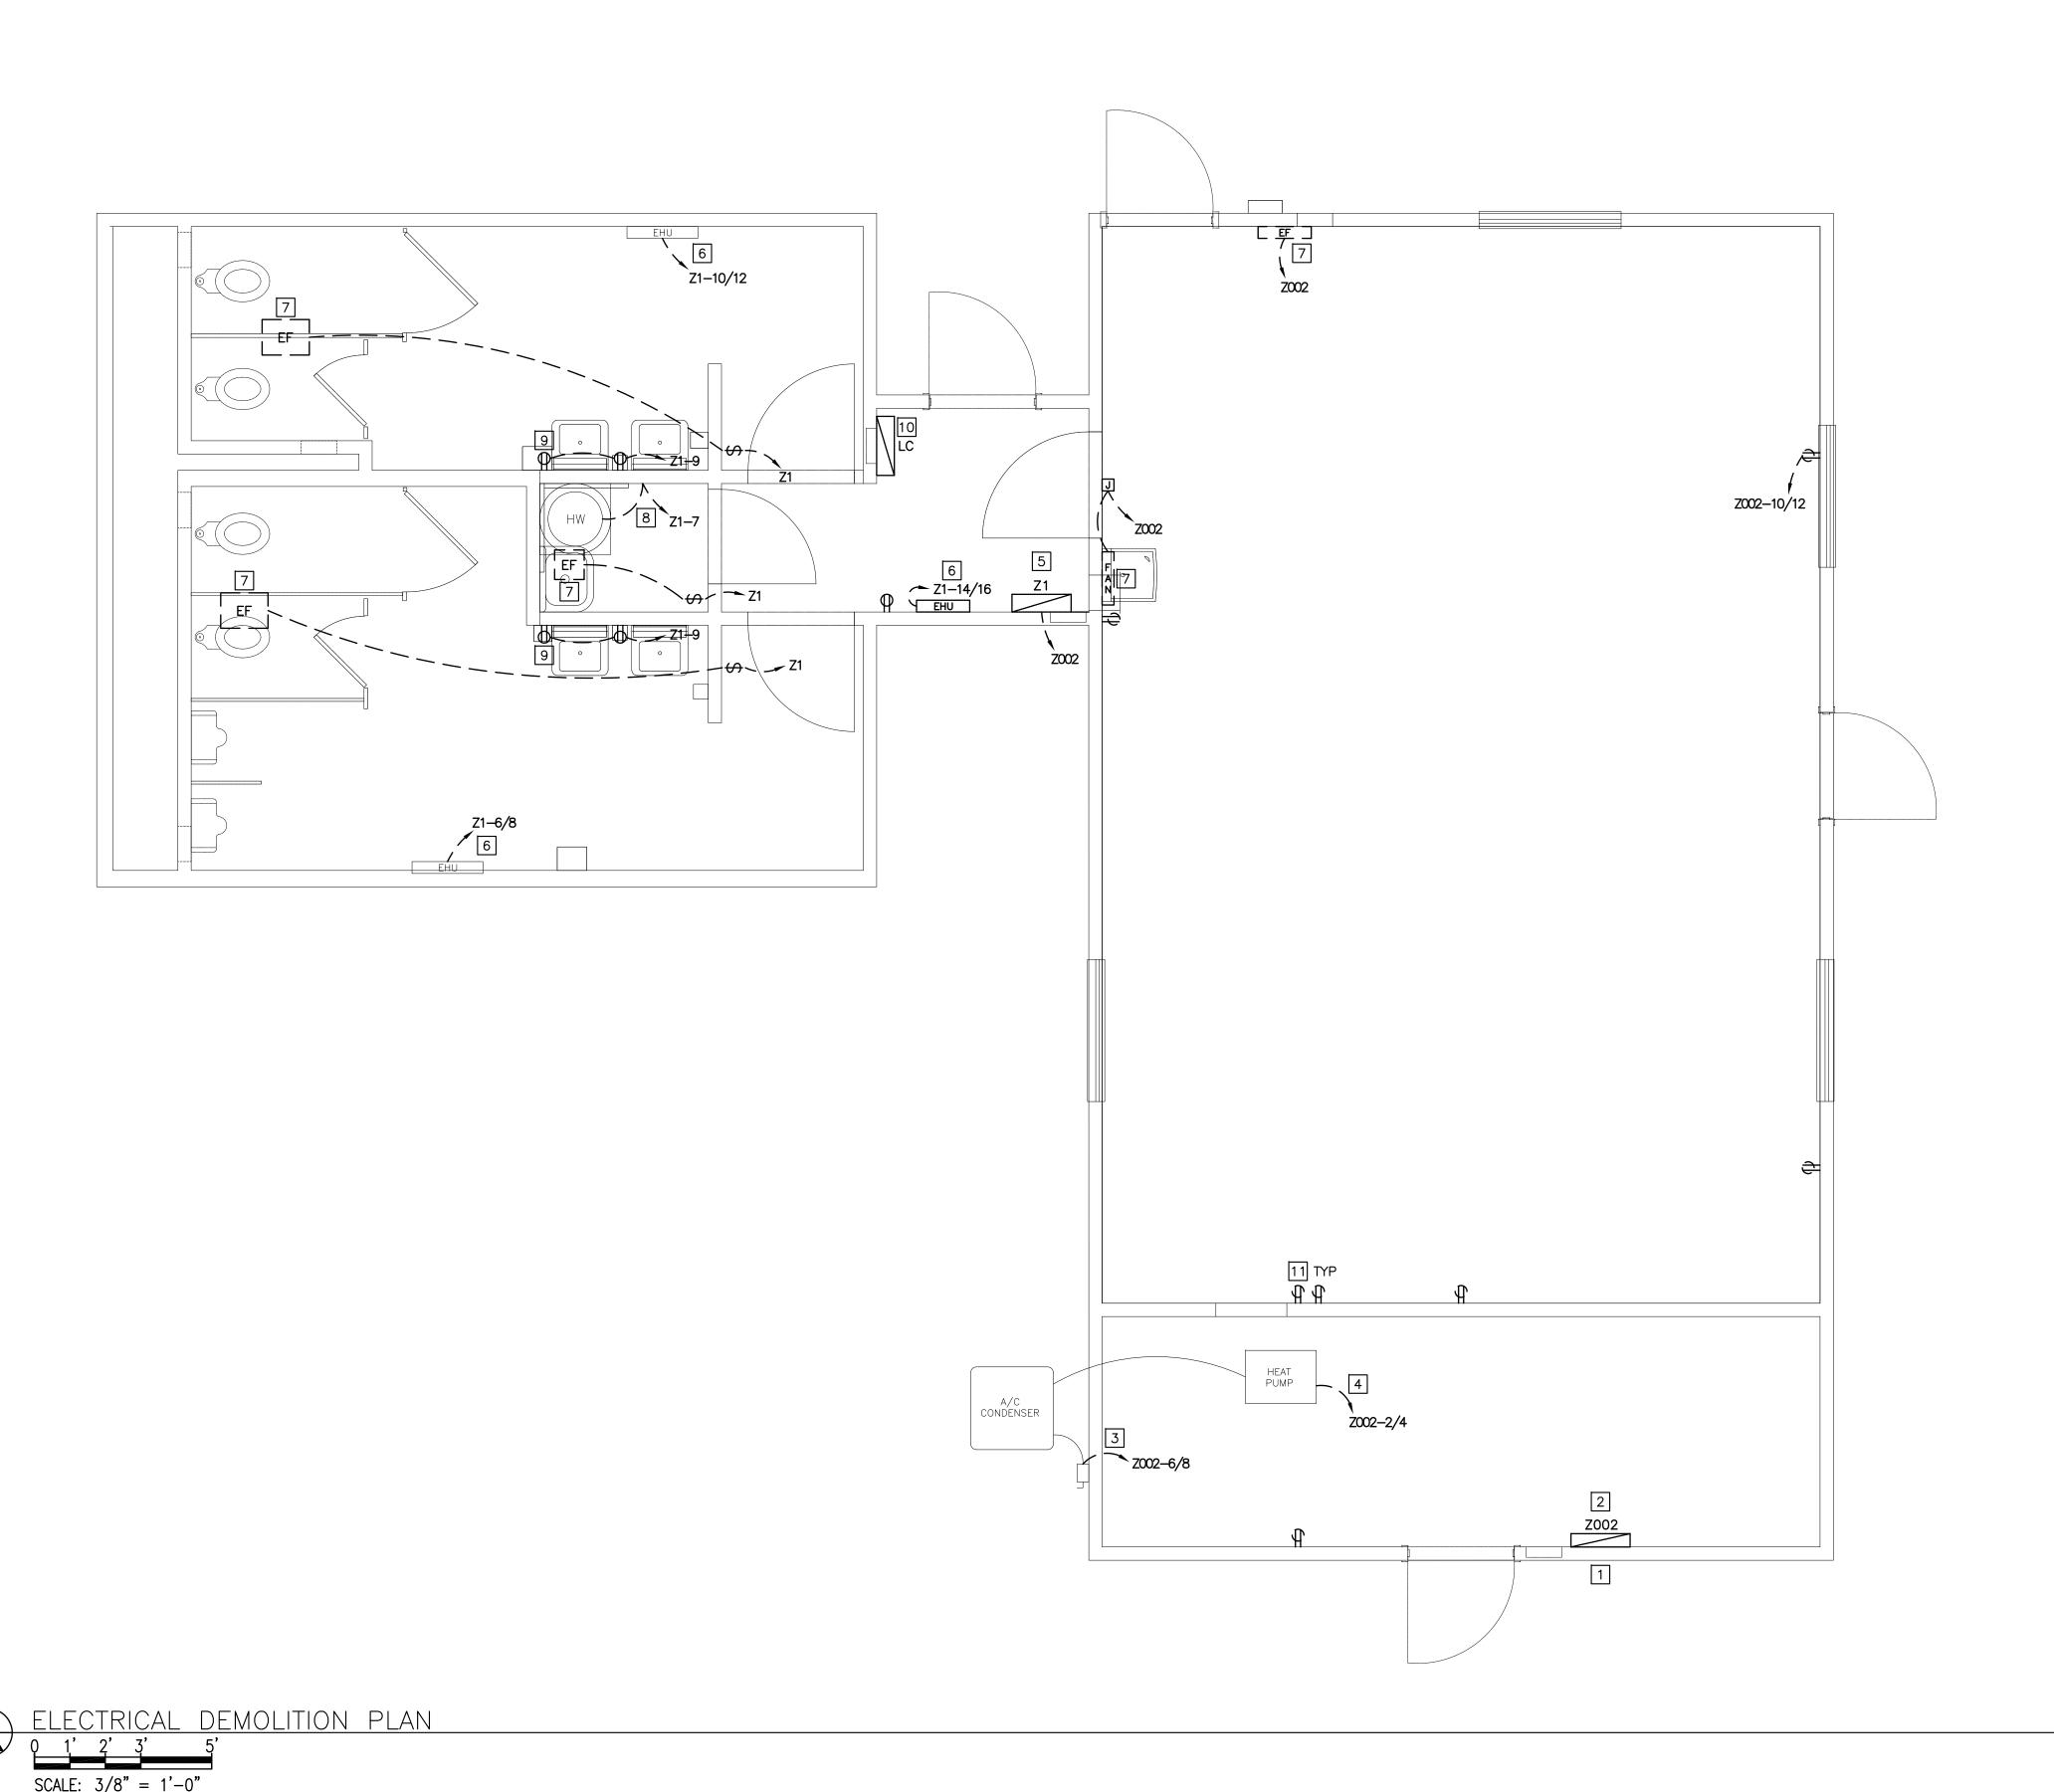

ELECTRICAL DEMOLITION NOTES

- REFER TO DRAWING E-001 FOR ELECTRICAL NOTES, LEGENDS AND SCHEDULES.
- 2. PRIOR TO PERFORMING THE WORK IN ELECTRICAL DEMOLITION KEY NOTE 1, THE DLA HIGH-VOLTAGE ELECTRICIAN WILL BE RESPONSIBLE FOR DE-ENERGIZING AND CUTTING THE OVERHEAD SERVICE CONDUCTORS FEEDING PANELBOARD Z002 FROM THE NEARBY UTILITY POLE. COORDINATE IN WRITING THROUGH THE CONTRACTING OFFICER'S REPRESENTATIVE AND PROVIDE FIVE WORKING DAYS NOTICE.
- 3. ELECTRICAL DEMOLITION WILL REQUIRE ENTIRE REMOVAL AND DISPOSAL OF EXISTING BRANCH CIRCUIT CONDUIT, WIRE, DEVICES, PANELBOARDS, ETC., UNLESS OTHERWISE NOTED.
- 4. FOR PANELBOARDS, RECEPTACLES, DEVICES AND EQUIPMENT SHOWN FOR REMOVAL AND DISPOSAL, PATCH AND PAINT DRYWALL. REFER TO ARCHITECTURAL DRAWINGS.
- 5. EXISTING FIRE ALARM SYSTEM, CONDUIT, WIRE, DEVICES WILL REMAIN AND ARE NOT IN THE SCOPE OF WORK.
- 6. EXISTING DATA AND COMMUNICATIONS CONDUIT, WIRE AND DEVICES WILL REMAIN AND ARE NOT IN THE SCOPE OF WORK.

ELECTRICAL DEMOLITION KEYNOTES

- REMOVE AND DISPOSE ABANDONED OVERHEAD SERVICE CONDUCTORS.
 REMOVE AND DISPOSE CONDULET BODY, CONDUIT AND WEATHERHEAD FROM BUILDING EXTERIOR. PATCH HOLE IN BUILDING. REFER TO ARCHITECTURAL DRAWINGS.
- 2 REMOVE PANELBOARD Z002 AND DELIVER TO THE CONTRACTING OFFICER'S REPRESENTATIVE.
- REMOVE AND DISPOSE BRANCH CIRCUIT FROM ELECTRICAL DISCONNECT BACK TO SOURCE PANELBOARD. CONDUIT AND CONDUCTORS FROM DISCONNECT TO CONDENSER WILL REMAIN.
- REMOVE AND DISPOSE BRANCH CIRCUIT FROM HEAT PUMP BACK TO SOURCE PANELBOARD. CONDUIT AND CONDUCTORS FROM HEAT PUMP TO CONDENSER WILL REMAIN.
- 5 REMOVE AND DISPOSE FEEDER CIRCUIT FROM PANELBOARD Z1 BACK TO PANELBORD Z002. REMOVE AND DISPOSE PANELBOARD Z1.
- REMOVE AND DISPOSE BRANCH CIRCUIT FROM ELECTRIC UNIT HEATER BACK TO SOURCE PANELBOARD. ELECTRIC UNIT HEATER IS ETR.
- 7 REMOVE AND DISPOSE BRANCH CIRCUIT FROM EXHAUST FAN BACK TO SOURCE PANELBORD.
- 8 REMOVE AND DISPOSE BRANCH CIRCUIT FROM HOT WATER HEATER TO SOURCE PANELBOARD.
- 9 REMOVE AND DISPOSE SURFACE MOUNT RECEPTACLE. REMOVE AND DISPOSE SURFACE MOUNT CONDUIT AND WIRE BACK TO SOURCE RECEPTACLE. PROVIDE BLANK COVER PLATE AT ABANDONED FLUSH
- REMOVE AND DISPOSE LIGHTING CONTACTOR CONTROLS AND ENCLOSURE. PATCH GYPSUM BOARD AND PAINT. REFER TO ARCHITECTURAL DRAWINGS.

MOUNT RECEPETACLE.

REMOVE AND DISPOSE FLUSH MOUNT RECEPTACLE AND WIRE BACK TO SOURCE PANELBOARD. DEVICE BOX WILL REMAIN ABANDONED. PROVIDE IVORY COLOR BLANK RECEPTACLE COVER.

NO. REVISIONS DATE


DEFENSE LOGISTICS AGENCY


REPAIRS TO BUILDING 67


DLA INSTALLATION MANAGEMENT AT SUSQUEHANNA INSTALLATION MANAGEMENT DIVISION NEW CUMBERLAND, PA 17070-5002

ELECTRICAL DEMOLITION PLAN

DESIGNED BY:	CHE	CKED BY:	PROJECT NO. 4232		
CAS	01/41	N/A		AWING N	
DRAWN BY:	CIVIL ARCHITECTURAL	HERGENROTHER	E	E-101	
CAS	MECHANICAL	SHARLOG	18	SHEET	22
SCALE:	ELECTRICAL	OLSON		OF _ DATE	
AS NOTED	ENERGY	SPIGELMYER	oc	T 202	23

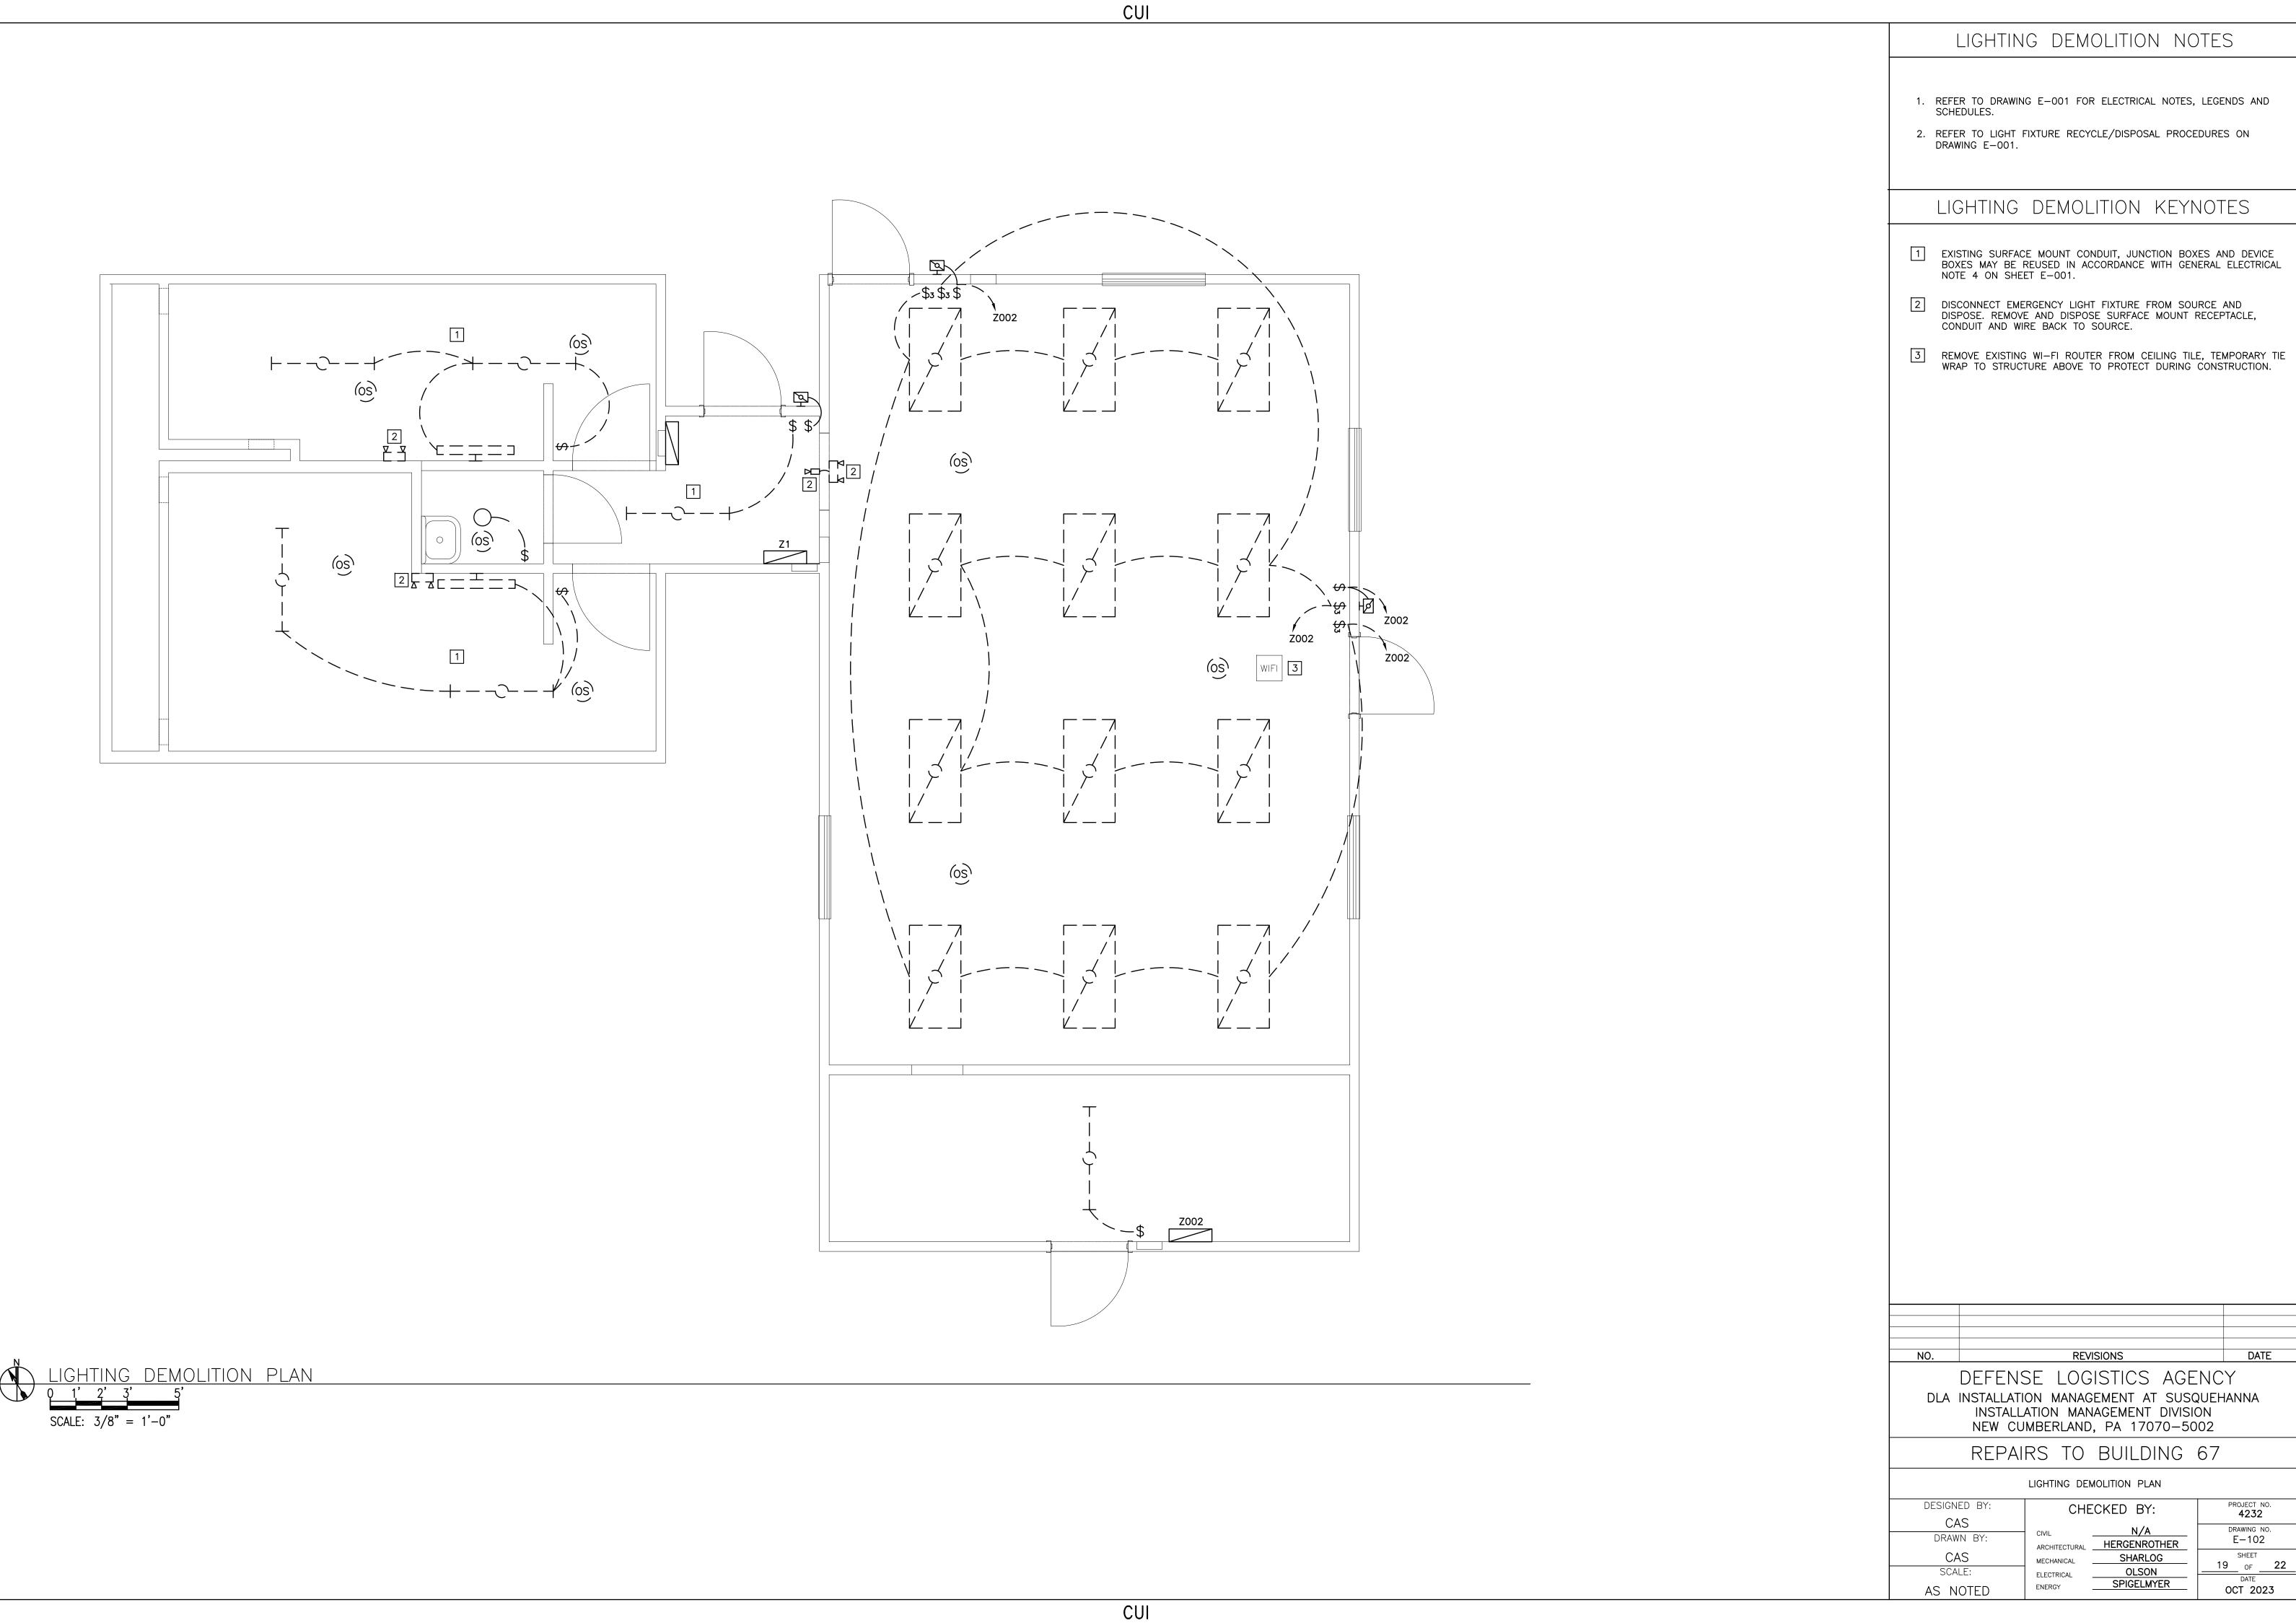

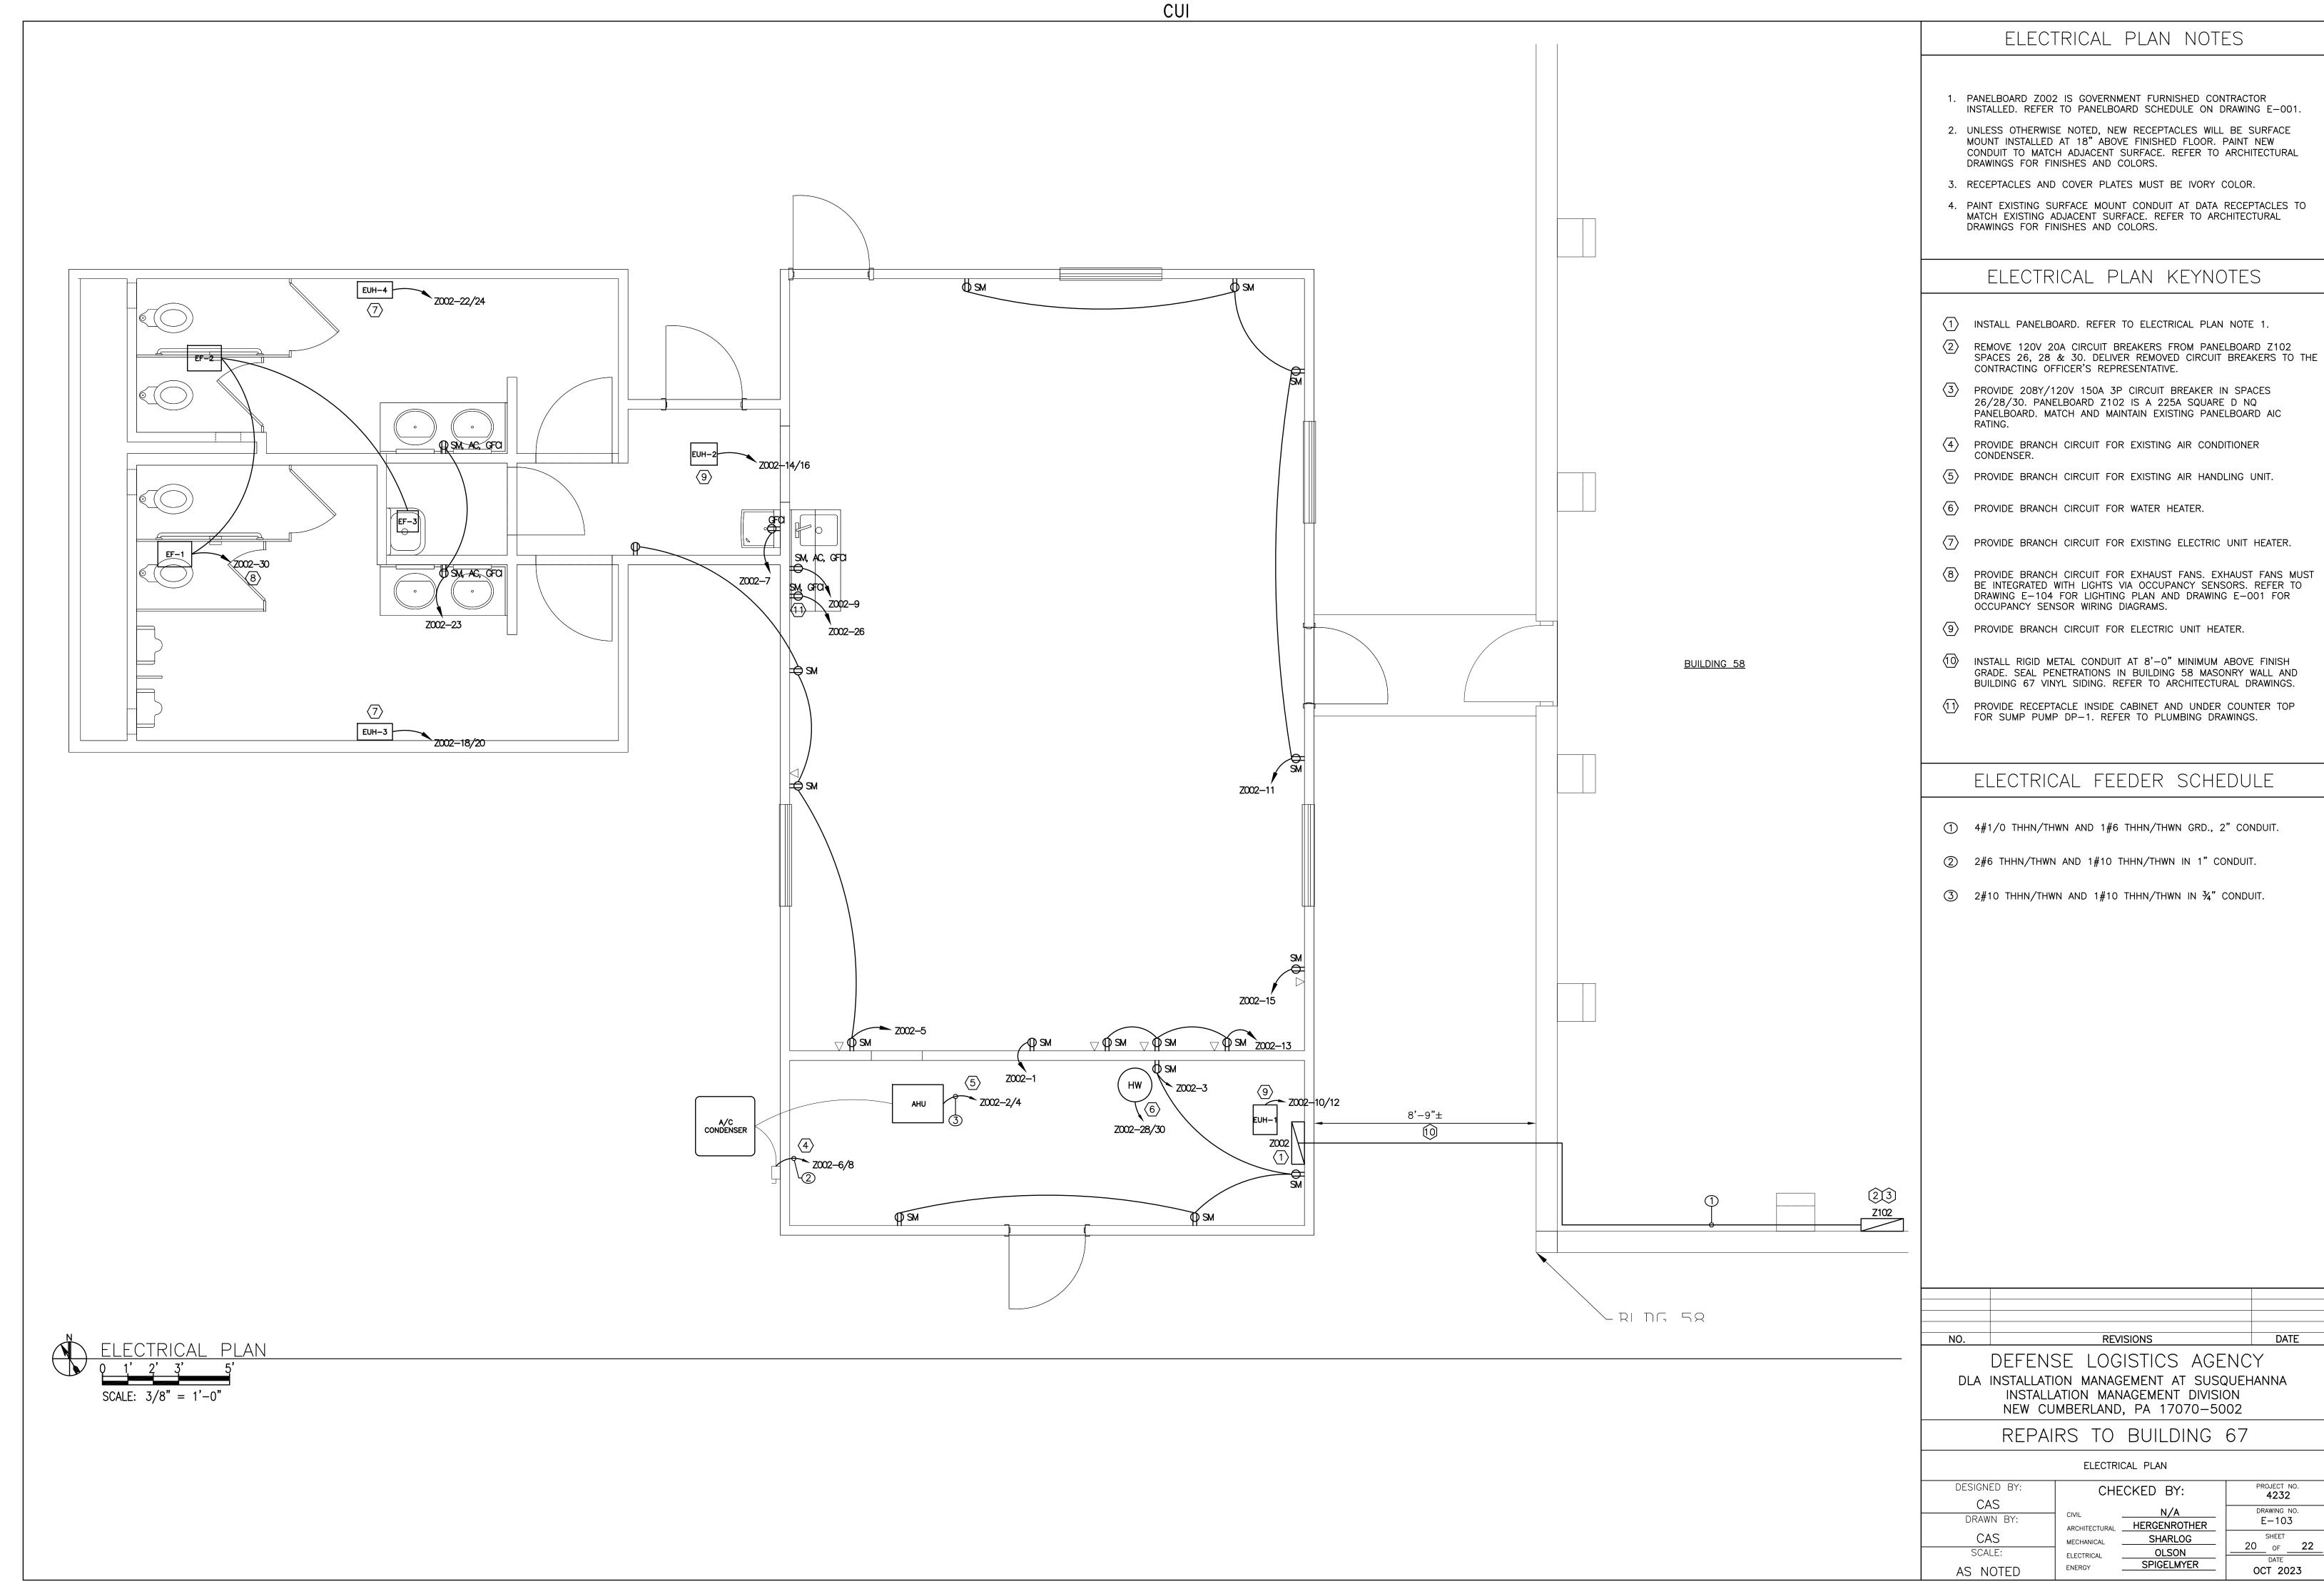

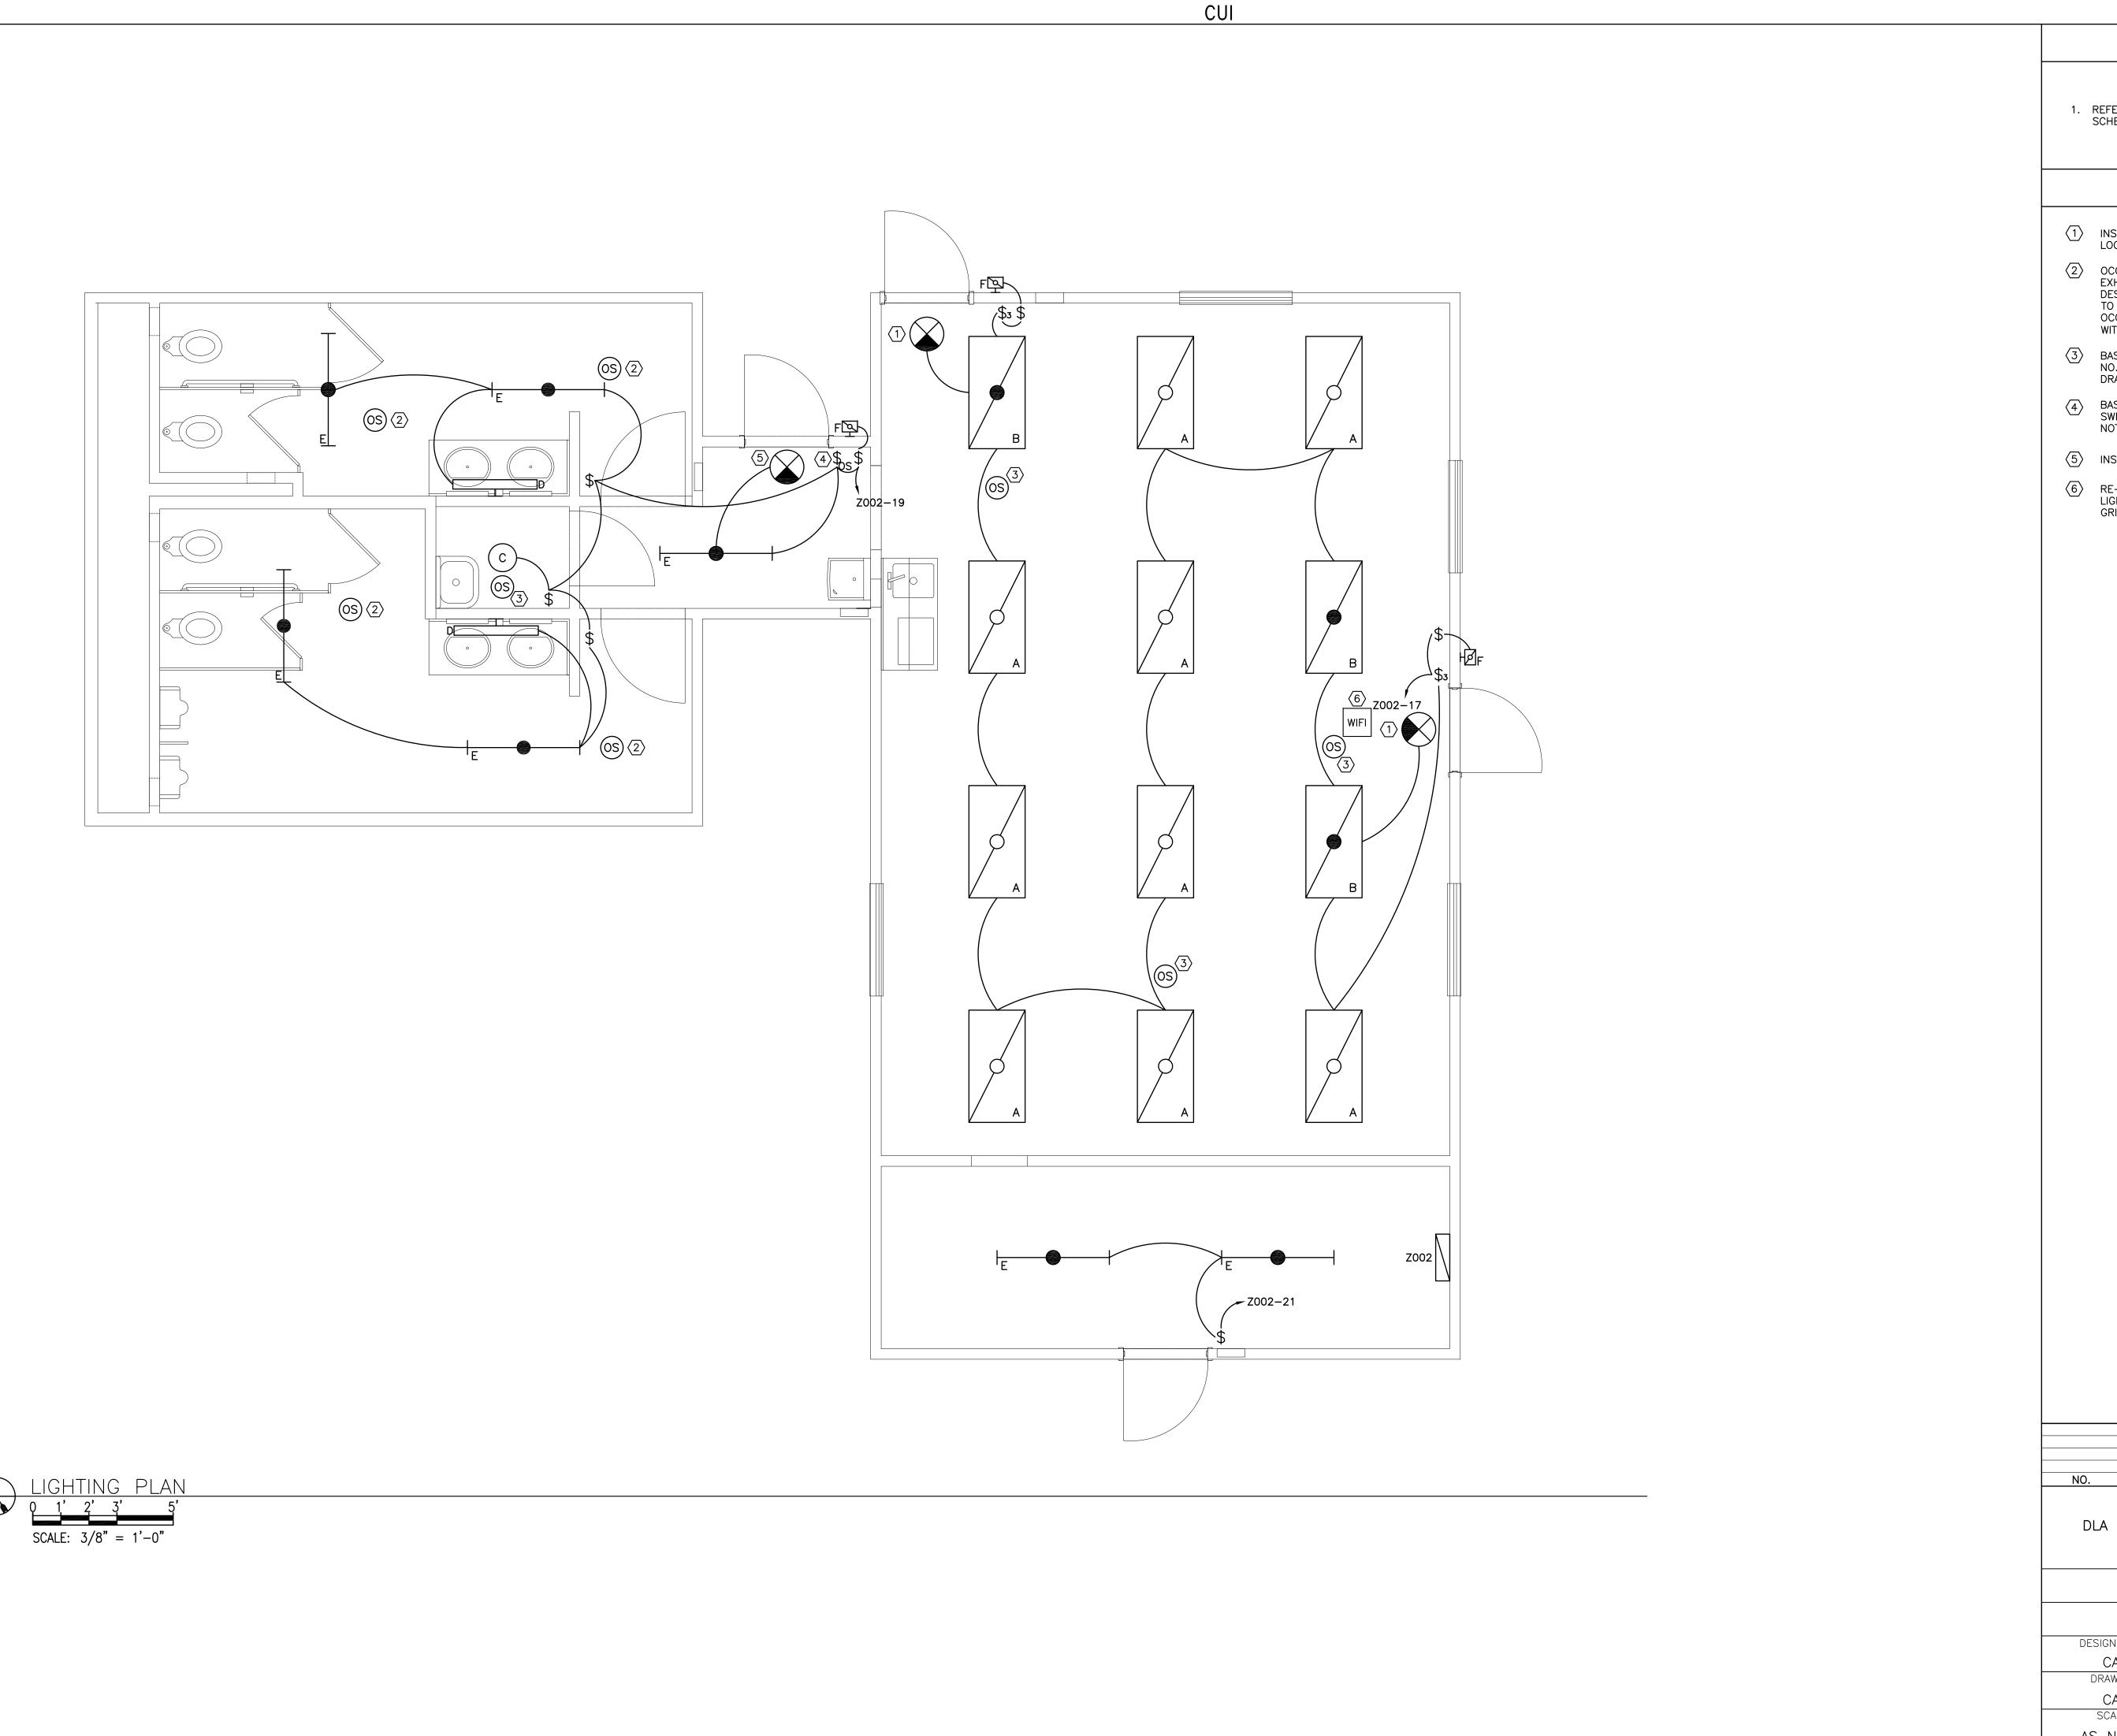

REFER TO DRAWING E-001 FOR ELECTRICAL NOTES, LEGENDS AND SCHEDULES.

LIGHTING PLAN KEYNOTES

- 1) INSTALL EMERGENCY EXIT SIGN IN SUSPENDED CEILING. COORDINATE LOCATION WITH ARCHITECTURAL DRAWINGS.
- OCCUPANCY SENSOR MUST CONTROL BATHROOM LIGHTS AND EXHAUST FANS. COORDINATE WITH MECHANICAL DRAWINGS. BASIS OF DESIGN IS SENSORSWITCH MODEL NO. CMR PDT 9 2P BAA. REFER TO GENERAL ELECTRICAL NOTE 11 ON DRAWING E-001 FOR OCCUPANCY SENSOR SETTINGS. WIRING MUST BE IN ACCORDANCE WITH MANUFACTURER'S REQUIREMENTS.
- BASIS OF DESIGN OCCUPANCY SENSOR IS SENSORSWITCH MODEL NO. CMR PDT 9 BAA. REFER TO GENERAL ELECTRICAL NOTE 11 ON DRAWING E-001 FOR OCCUPANCY SENSOR SETTINGS.
- BASIS OF DESIGN OCCUPANCY SENSOR LIGHT SWITCH IS SENSOR SWITCH MODEL NO. WSX PDT IV. REFER TO GENERAL ELECTRICAL NOTE 11 ON DRAWING E-001 FOR OCCUPANCY SENSOR SETTINGS.
- (5) INSTALL EMERGENCY EXIT SIGN IN GYPSUM BOARD CEILING.
- (6) RE-INSTALL EXISTING WI-FI ROUTER SAVED DURING CEILING AND LIGHT DEMOLITION. COORDINATE LOCATION WITH SUSPENDED CEILING GRID.

REVISIONS DATE DEFENSE LOGISTICS AGENCY

DLA INSTALLATION MANAGEMENT AT SUSQUEHANNA INSTALLATION MANAGEMENT DIVISION NEW CUMBERLAND, PA 17070-5002

REPAIRS TO BUILDING 67

LIGHTING	PLAI

DESIGNED BY:	CHE	CKED BY:	PROJECT NO. 4232
CAS		N/A	DRAWING NO.
DRAWN BY:	CIVIL ARCHITECTURAL	HERGENROTHER	E-104
CAS	MECHANICAL	SHARLOG	SHEET
SCALE:	ELECTRICAL	OLSON	21OF22
AS NOTED	ENERGY	SPIGELMYER	OCT 2023

