
CONSTRUCT NEW COMMUNITY LIVING CENTER (CLC)

DEPARTMENT OF VETERANS AFFAIRS PROJECT NO. 595-601

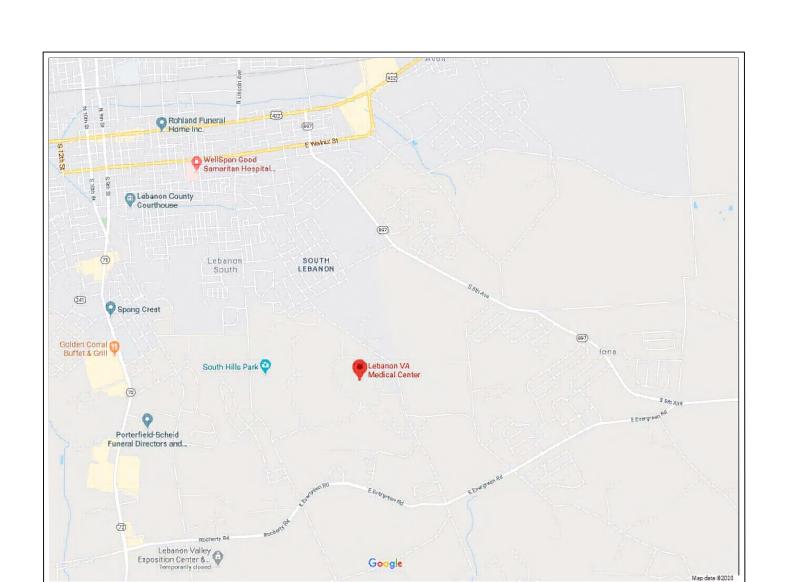

LOCATION MAP

AE100

AE113

AE114

SITE PLAN

OVERALL ARCHITECTURAL FIRST FLOOR DIMENSION PLAN

OVERALL ARCHITECTURAL FIRST FLOOR EDGE OF SLAB PLAN

FIRST FLOOR ARCHITECTURAL & EQUIPMENT PLAN - AREA A

FIRST FLOOR ARCHITECTURAL & EQUIPMENT PLAN - AREA B

FIRST FLOOR ARCHITECTURAL & EQUIPMENT PLAN - AREA C

FIRST FLOOR ARCHITECTURAL & EQUIPMENT PLAN - AREA D

OVERALL ARCHITECTURAL SECOND FLOOR DIMENSION PLAN

SECOND FLOOR ARCHITECTURAL & EQUIPMENT PLAN - AREA D

OVERALL ARCHITECTURAL ROOF PLAN

OVERALL ARCHITECTURAL SECOND FLOOR EDGE OF SLAB PLAN AE531

SECOND FLOOR ARCHITECTURAL & EQUIPMENT PLAN - AREA A AE532

SECOND FLOOR ARCHITECTURAL & EQUIPMENT PLAN - AREA C AE533

SANITARY FORCE MAIN PROFILE

GENERAL DETAILS

GENERAL DETAILS

WATER DETAILS

SEWER DETAILS

STORM DETAILS

STORM DETAILS

STORM DETAILS

LANDSCAPING DETAILS

DT 501

DT 502

DT 504

DT 505

VA FORM 08 - 6231

LEBANON VA MEDICAL CENTER 1700 SOUTH LINCOLN AVENUE LEBANON, PENNSYLVANIA



CAMPUS MAP
SCALE: NTS

SCHEDULES

SCHEDULES

CONTROLS DIAGRAMS

CONTROLS DIAGRAMS


CONTROLS DIAGRAMS

CONTROLS DIAGRAMS

CONTROLS DIAGRAMS

CONTROLS DIAGRAMS

CONTROLS LEGEND AND SYMBOLS

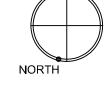

ADD ALT. NO. 1: INTERIOR AND EXTERIOR CAMERAS - PROVIDED BY CONTRACTOR

ADD ALT. NO. 5: ADD DINING ROOM AND MULTIPURPOSE ROOM PATIOS / WALL

ADD ALT. NO. 3: GAS SERVICE MAIN - PROVIDED BY CONTRACTOR

ADD ALT. NO. 7: EXPAND LENGTH OF LOOP ROAD / TURN-AROUND

ADD ALT. NO. 4: ADD SIDEWALKS ALONG LOOP ROAD

ADD ALT. NO. 6: FIT-OUT PATIENT'S LAUNDRY ROOM

ADD ALT. NO. 8: FIT-OUT WESTERN WING

ADD ALT. NO. 2: TREES AT PERIMETER OF LOOP ROAD - PROVIDED BY CONTRACTOR

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Ph: 610-270-0599

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DRAWING INDEX

DRAWING No	D. DRAWING TITLE	DRAWING No.	DRAWING TITLE	DRAWING No.	DRAWING TITLE	DRAWING No.	DRAWING TITLE	DRAWING No	DRAWING TITLE	DRAWING No.	DRAWING TITLE
	GENERAL		STRUCTURAL		ARCHITECTURAL		ARCHITECTURAL CONTINUED		MECHANICAL		ELECTRICAL
Gl001	COVER SHEET & DRAWING INDEX	S-001	ABBREVIATIONS & NOTES	AE140	OVERALL FIRST FLOOR REFLECTED CEILING PLAN	AE600	DOOR & BORROWED LIGHT LEGEND & DETAILS	M-001	ABBREVIATIONS, NOTES & SYMBOLS	E-001	ABBREVIATIONS & SYMBOLS
GI002	GENERAL INFORMATION, CODE REQUIREMENTS AND DRAWING LIST	SF100	OVERALL FOUNDATION PLAN	AE141	FIRST FLOOR REFLECTED CEILING PLAN - AREA A	AE601	BI-FOLD DOOR DETAILS	MS101	SIT E PLAN	E-002	NOTES
GI003	RENDERINGS	SF101	FOUNDATION PLAN, AREA A	AE142	FIRST FLOOR REFLECTED CEILING PLAN - AREA B	AE602	DOOR & BORROWED SCHEDULES	MH111	DUCT WORK PLAN FIRST FLOOR - AREA A	ES101	SITE PLAN
GI100	UL DESIGN CRITERIA	SF102	FOUNDATION PLAN, AREA B	AE143	FIRST FLOOR REFLECTED CEILING PLAN - AREA C	AE630	INTERIOR SCHEDULES	MH112	DUCT WORK PLAN FIRST FLOOR - AREA B	EL111	LIGHTING PLAN 1ST FLOOR, AREA A
GI101	UL DESIGN CRITERIA	SF103	FOUNDATION PLAN, AREA C	AE144	FIRST FLOOR REFLECTED CEILING PLAN - AREA D	AE701	EQUIPMENT SCHEDULE	MH113	DUCT WORK PLAN FIRST FLOOR - AREA C	EL112	LIGHTING PLAN 1ST FLOOR, AREA B
GI102	UL DESIGN CRITERIA	SF104	FOUNDATION PLAN, AREA D	AE150	OVERALL ARCHITECTURAL SECOND FLOOR REFLECTED CEILING PLAN	AE801	TOILET ACCESSORY & LOCKER SCHEDULES	MH114	DUCT WORK PLAN FIRST FLOOR - AREA D	EL113	LIGHTING PLAN 1ST FLOOR, AREA C
GI110	FIRST FLOOR LIFE SAFETY & OCCUPANT LOAD PLAN	SF110	OVERALL SLAB ON GRADE PLAN 1ST FLOOR	AE200	BUILDING ENVELOPE WALL & ROOF SYSTEMS	AF111	FIRST FLOOR FINISH & FLOOR PATTERN PLAN - AREA A	MH121	DUCT WORK PLAN SECOND FLOOR - AREA A	EL114	LIGHTING PLAN 1ST FLOOR, AREA D
GI120	SECOND FLOOR LIFE SAFETY & OCCUPANT LOAD PLAN	SF120	OVERALL FRAMING PLAN 2ND FLOOR	AE201	BUILDING ENVELOPE CURTAINWALL, DOOR AND WINDOW SYSTEMS	AF112	FIRST FLOOR FINISH & FLOOR PATTERN PLAN - AREA B	MH122	DUCT WORK PLAN SECOND FLOOR - AREA B	EP111	POWER PLAN 1ST FLOOR, AREA A
		SF121	FRAMING PLAN 2ND FLOOR, AREA A	AE202	EXTERIOR ELEVATIONS	AF113	FIRST FLOOR FINISH & FLOOR PATTERN PLAN - AREA C	MH123	DUCT WORK PLAN SECOND FLOOR - AREA C	EP112	POWER PLAN 1ST FLOOR, AREA B
	CIVIL	SF122	FRAMING PLAN 2ND FLOOR, AREA B	AE203	EXTERIOR ELEVATIONS	AF114	FIRST FLOOR FINISH & FLOOR PATTERN PLAN - AREA D	MH124	DUCT WORK PLAN SECOND FLOOR - AREA D	EP113	POWER PLAN 1ST FLOOR, AREA C
		SF123	FRAMING PLAN 2ND FLOOR, AREA C	AE300	BUILDING SECTIONS			MP111	PIPING PLAN FIRST FLOOR - AREA A	EP114	POWER PLAN 1ST FLOOR, AREA D
CS001	NOTES & LEGEND	SF124	FRAMING PLAN 2ND FLOOR, AREA D	AE310	EXTERIOR WALL SECTIONS - AREA A		FOOD SERVICE	MP112	PIPING PLAN FIRST FLOOR - AREA B	EP121	LIGHTNING PROTECTION PLAN
CS002	OVERALL SITE DEVELOPMENT PLAN	SF130	OVERALL FRAMING PLAN ROOF	AE311	EXTERIOR WALL SECTIONS - AREA A			MP113	PIPING PLAN FIRST FLOOR - AREA C	ET111	TELECOM PLAN 1ST FLOOR, AREA A
VL100	OVERALL EXISTING CONDITIONS	SF131	FRAMING PLAN ROOF, AREA A	AE312	EXTERIOR WALL SECTIONS - AREA A	QC101	EQUIPMENT DRAWING PLAN - AREAS A & B	MP114	PIPING PLAN FIRST FLOOR - AREA D	ET112	TELECOM PLAN 1ST FLOOR, AREA B
B-100	SUBSURFACE BORING LOCATION PLAN	SF132	FRAMING PLAN ROOF, AREA B	AE313	EXTERIOR WALL SECTIONS - AREA B	QC102	EQUIPMENT DRAWING PLAN - AREAS A & B	MP121	PIPING PLAN SECOND FLOOR - AREA A	ET 113	TELECOM PLAN 1ST FLOOR, AREA C
CD100	OVERALL SITE DEMOLITION PLAN	SF133	FRAMING PLAN ROOF, AREA C	AE314	EXTERIOR WALL SECTIONS - AREA C	QC103	EQUIPMENT DRAWING PLAN - AREAS A & B	MP122	PIPING PLAN SECOND FLOOR - AREA B	ET 114	TELECOM PLAN 1ST FLOOR, AREA D
GC001	EROSION AND SEDIMENT CONTROL DETAILS AND NOTES	SF134	FRAMING PLAN ROOF, AREA D	AE315	EXTERIOR WALL SECTIONS - AREA D	QC104	EQUIPMENT DRAWING PLAN - AREAS A & B	MP123	PIPING PLAN SECOND FLOOR - AREA C	FA111	FIRE ALARM PLAN 1ST FLOOR, AREA A
GC101	EROSION AND SEDIMENT CONTROL PLAN	S-301	BUILDING SECTIONS	AE316	EXTERIOR WALL SECTIONS - AREA D			MP124	PIPING PLAN SECOND FLOOR - AREA D	FA112	FIRE ALARM PLAN 1ST FLOOR, AREA B
GC151	ADD ALT NO 7 - EROSION AND SEDIMENT CONTROL PLAN	S-302	BUILDING SECTIONS	AE320	EXTERIOR PLAN DETAILS		FIRE PROTECTION	M-401	MECHANICAL CHILLED WATER CONNECTION SITE PLAN & MECHANICAL SECTIONS	FA113	FIRE ALARM PLAN 1ST FLOOR, AREA C
CS101	SITE LAYOUT AND UTILITY PLAN	S-501	FOUNDATION SECTIONS AND DETAILS	AE321	EXTERIOR PLAN DETAILS			M-402	MECHANICAL BUILDING 1 & 2 CHILLER YARD	FA114	FIRE ALARM PLAN 1ST FLOOR, AREA D
CS151	ADD ALT NO 7 - SITE LAYOUT AND UTILITY PLAN	S-510	FRAMING SECTIONS AND DETAILS	AE330	EXTERIOR SECTION DETAILS	FX001	DETAILS, GENERAL NOTES & LEGEND	M-403	MECHANICAL SECTIONS	E-401	ENLARGED PLANS MEZZANINE
CS200	ADD ALT NO 3 - GAS LINE EXTENSION UTILITY PLAN	S-511	FRAMING SECTIONS AND DETAILS	AE331	EXTERIOR SECTION DETAILS	FX111	PLAN 1ST FLOOR	M-404	MECHANICAL SECTIONS	E-501	DETAILS
CG100	OVERALL GRADING AND DRAINAGE PLAN	S-601	COLUMN SCHEDULE	AE332	EXTERIOR SECTION DETAILS	FX401	ENLARGED PLANS MEZZANINE	M-405	MECHANICAL SECTIONS	E-502	DETAILS
CG101	GRADING AND DRAINAGE PLAN	S-602	FOUNDATIONS SCHEDULES	AE333	EXTERIOR SECTION DETAILS			M-501	DETAILS	E-503	DETAILS
CG151	ADD ALT NO 7 - GRADING AND DRAINAGE PLAN AREA 1	S-701	TYPICAL CONCRETE DETAILS	AE340	ROOF DETAILS		PLUMBING	M-502	DETAILS	E-601	SINGLE LINE DIAGRAMS
CG152	ADD ALT NO 7 GRADING AND DRAINAGE PLAN AREA 2 AND 3	S-710	TYPICAL STEEL DETAILS	AE400	INTERIOR ELEVATION GENERAL NOTES & LEGENDS			M-503	DETAILS	E-602	GROUNDING DIAGRAM
L-101	LANDSCAPE AND SIGNAGE PLAN WITH ADD ALT NO 2	S-711	TYPICAL STEEL DETAILS	AE401	INTERIOR ELEVATIONS - AREAS A & B	P-001	ABBREVIATIONS, GENERAL NOTES & SYMBOLS	M-504	DETAILS	E-603	TELE/DATA RISER DIAGRAM
L-151	ADD ALT 7 - LANDSCAPE AND SIGNAGE PLAN WITH ADD ALT NO 2	S-712	SECTIONS & DETAILS	AE402	INTERIOR ELEVATIONS - AREAS A & B	P-111	PLAN 1ST FLOOR, AREA A	M-505	DETAILS	E-701	SCHEDULES
CT 201	ROADWAY PLAN AND PROFILE			AE403	INTERIOR ELEVATIONS - AREA B	P-112	PLAN 1ST FLOOR, AREA B	M-506	DETAILS	E-702	LIGHTING FIXTURE & PANEL SCHEDULES
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CU260	STORM PROFILES			AE405	INTERIOR ELEVATIONS - AREAS B	P-114	PLAN 1ST FLOOR, AREA D	M-602	RISER DIAGRAM		
CU261	STORM COMPUTATIONS	AE001	GENERAL NOTES, LEGENDS AND DETAILS	AE406	INTERIOR ELEVATIONS - AREAS C & D	P-401	ENLARGED PLANS MEZZANINE	M-701	SCHEDULES		
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ENLARGED PLANS & INTERIOR ELEVATIONS - TYPICAL RESIDENT ROOM

PARTITION TYPES & FRAMING DETAILS

INTERIOR AND MILLWORK DETAILS

MILLWORK DETAILS - RESIDENT ROOM & TOILET ROOM

MILLWORK DETAILS - KITCHEN

RATED ASSEMBLY DETAILS
CEILING & SOFFIT DETAILS

INTERIOR DETAILS

MILLWORK DETAILS

MILLWORK DETAILS

ENLARGED PLAN & INTERIOR ELEVATIONS- BARIATRIC RESIDENT ROOM 113

Project Title Project Number PRINTS OF THIS DRAWING SHALL NOT BE USED FOR ANY PURPOSE WHATSOEVER WITHOUT THE SEAL AND SIGNATURE OF THE MILLER-REMICK LLC CONSULTANT ENGINEER OF RECORD Office of **COVER SHEET & DRAWING INDEX** BID DOCUMENTS PROFESSIONAL ENGINEER CONSTRUCT NEW COMMUNITY 595-601 PROFESSIONAL ENGINEEER Construction LIVING CENTER (CLC) Miller-Remick LLC

M.E.P. & Structural Engineering
A Service Disabled Veteran Owned **Building Number** and Facilities ARRAY 1 West Elm Street, Ste 500
Conshohocken, PA 19428 148 S Queen St, Suite 201 LANDSCAPE ARCHITECTURE Management Drawing Number LEBANON, PENNSYLVANIA 1010 KINGS HIGHWAY SOUTH Martinsburg, WV 25401 SURVEY AND MAPPING architects, 0:610-270-0599 CHERRY HILL, NEW JERSEY 08034 Phone: 304-725-8456 | SECURITY CONSULTING **FULLY SPRINKLERED** f: 601-270-0995 PHONE: (856)429-4000 Checked Drawn GI001 FAX: (856)429-5002 U.S. Department of Veterans Affairs www.gordon.us.com SP MP MR PROJECT NO: 0499-0124 Date:

RISER DIAGRAMS DOMESTIC WATER

RISER DIAGRAMS SANITARY WASTE

RISER DIAGRAMS NATURAL GAS

SCHEDULES

RISER DIAGRAMS MEDICAL GASES

NFPA KITCHEN CORRIDOR REQUIREMENTS

18.3.2.5.3* Within a smoke compartment, where residential or commercial cooking equipment is used to prepare meals for 30 or fewer persons, one cooking facility shall be permitted to be open to the corridor, provided that all of the following conditions are met: (1) The portion of the health care facility served by the cooking facility is limited to 30 beds and is separated from other portions of the health care facility by a smoke barrier constructed in accordance with 18.3.7.3, 18.3.7.6 , and 18.3.7.8. (2) The cooktop or range is equipped with a range hood of a width at least equal to the width of the cooking surface, with grease baffles or other greasecollecting and clean-out capability.

The hood systems have a minimum airflow of 500 cfm (14,000 L/ min). (3) The hood systems that are not ducted to the exterior additionally have a charcoal filter to remove smoke and odor. (4) The cooktop or range complies with all of the

following: (a) The cooktop or range is protected with a fire suppression system listed in accordance with ANSI/UL 300, Standard for Fire Testing of Fire Extin- guishing Systems for Protection of Commercial Cooking Equipment, or is tested and meets all requirements of UL 300A, Extinguishing System Units for Residential Range Top Cooking Surfaces, in accordance with the applicable testing document's scope. (b) A manual release of the extinguishing system is provided in accordance with Section

10.5 of NFPA 96. (c) An interlock is provided to turn off all sources of fuel and electrical power to the cooktop or range when the suppression system is (6) The use of solid fuel for cooking is

(7) Deep-fat frying is prohibited. (8) Portable fire extinguishers in accordance with NFPA 96 are located in all kitchen areas. (9)* A switch meeting all of the following is

(a) A locked switch, or a switch located in a restricted location, is provided within the cooking facility that deactivates the cooktop or range.

b) The switch is used to deactivate the cooktop or range whenever the kitchen is not under staff supervision.

c) The switch is on a timer, not exceeding a 120-Minute capacity, that automatically deactivates the cooktop or range, independent of

staff action. Procedures for the use, inspection, testing, and maintenance of the cooling equipment are in accordance with Chapter 11 of NFPA 96 and the manufacturer's instructions are followed. Not less than two AC-powered photoelectric smoke alarms will battery backup, interconnected in accordance with 9.6.2.10.5, and equipped with a silence feature are located not closer than 20 ft (6.1 m) and not further than 25 ft (7.6 m) from the cooktop *or* range.

The smoke alarms required by 18.5.2.5.3(1-3). arc permit- ted to be located outside the kitchen area where such placement is necessary for compliance with the 20 ft (7.6 m) minimum distance criterion.

A single system smoke detector is permitted to be installed in lieu of the smoke alarms required 18.3.2.5.5.(11). provided the following criteria are (a) The detector is located not closer than 20 ft (6.l m) and not further than 25 R (7.6

building- wide occupant notification signal. b. The detector is not required to notily emergency forces. (e) The local audible signal initiated by (he detector is permitted to be silenced and reset by a button on the detector or by a switch installed

ft (7.6 m) to the cooktop or range.

PUBLIC BUILDINGS AMENDMENT ACT OF 1988 AND OMB CIRCULAR A-119

APPLICABLE CODES:

APPLICABLE VA DIRECTIVES, AND DESIGN MANUALS

INTERNATIONAL MECHANICAL CODE 2018

INTERNATIONAL FUEL GAS CODE 2018 INTERNATIONAL FIRE CODE 2018

INTERNATIONAL ENERGY CONSERVATION CODE 2018 INTERNATIONAL PLUMBING CODE 2018 NFPA 70-2014, NATIONAL ELECTRICAL CODE

VA BARRIER FREE DESIGN STANDARD 2017

INTERIOR FLOOR FINISH REQUIREMENTS

INTERNATIONAL FIRE CODE 2018

INTERNATIONAL WILDLAND - URBAN INTERFACE CODE 2009 INTERNATIONAL PERFORMANCE CODE FOR BUILDINGS AND FACILITIES 2018 ARCHITECTURAL BARRIERS ACT ACCESSIBILITY STANDARDS (ABAAS)

m) from the cooktop or range. (b) The detector is permitted to initiate a Incal audible alarm signnl only.

a. The detector is not required to initiate a

within 10 ft (5.0 m) of the system smoke System smoke detectors that are required to be installed in corridors or spaces open to the corridor by other sections of this chapter are not used to meet the require- ments of I8.5.2.5.3(I1) and are located not closer than 25

CODE REQUIREMENTS

APPLICABLE CODES (CONTINUED):

- NATIONAL FIRE CODES, WITH THE EXCEPTION OF NFPA 5000 AND NFPA 9000 INTERNATIONAL BUILDING CODE 2018 (*ONLY WHEN SPECIFICALLY REFERENCED)

2018 EDITION - FACILITY GUIDELINES INSTITUTE FOR DESIGN AND CONSTRUCTION OF HEALTH CARE FACILITIES" AIR CONDITIONING AND VENTILATING SYSTEMS. (NFPA 90A-2018)

VA SEISMIC DESIGN REQUIREMENTS, H-18-8 ASME BOILER AND PRESSURE VESSEL CODE

> ASME CODE FOR PRESSURE PIPING ARCHITECTURAL BARRIERS ACT ACCESSIBILITY STANDARDS (ABAAS) INCLUDING VA SUPPLEMENT, BARRIER FREE DESIGN GUIDE (PG-18-13)

- LIFE SAFETY CODE NFPA 101 (2018).

HEALTH CARE FACILITIES NFPA 99-2018

ENERGY POLICY ACT OF 2005 (EPAct) DOE INTERIM FINAL RULE: ENERGY CONSERVATION STANDARDS FOR NEW FEDERAL, COMMERCIAL AND MULTI-FAMILY HIGH-RISE RESIDENTIAL BUILDINGS AND

NEW LOW-RISE RESIDENTIAL BUILDINGS, 10 CFR PARTS 433, 434 AND 435

MEMORANDUM OF UNDERSANDING (MOU) VENTILATION FOR ACCEPTABLE INDOOR AIR QUALITY - ASHRAE STANDARD

FEDERAL LEADERSHIP INHIGH PERFORMANCE AND SUSTAINABLE BUILDINGS:

NFPA 101

CLASS A OR B

NEW HEALTHCARE (CHAPTER 18, SECTION 18.1.1.1.4) BUILDING OCCUPANCY CLASSIFICATION TYPE OF CONSTRUCTION IIB (0,0,0) **BUILDING HEIGHT (TABLE 504.3)** 1 STORY WITH AN UNOCCUPIED MECHANICAL (4 OF TABLE 18.1.6.1) BUILDING AREA (TABLE 506.2) FLOOR AREA / TOTAL AREA

19,152 GROSS SQ.FT. FIRST FLOOR 1,798 GROSS SQ. FT. SECOND FLOOR NFPA 13 SPRINKLER SYSTEM FIRE SUPPRESSION SYSTEM SEISMIC / WIND REQUIREMENTS OCCUPANCY CATEGORY RISK CATEGORY III SEISMIC DESIGN CATEGORY В

WIND ZONE В CORRIDOR WIDTH CORRIDOR SERVING 50 PEOPLE OR LESS N/A PER NFPA 44 INCHES (SECTION 18.2.3.4) CORRIDORS NON HOSPITAL CORRIDOR ACCESS (MIN.) 72 INCHES (SECTION 18.2.3.4 (7)) ALLOWABLE DEAD END CORRIDOR 30 FEET (SECTION 18.2.5.2)

MINIMUM CLEAR DOOR WIDTH FOR SLEEPING UNITS 41 1/2 INCHES (SECTION 18.2.3.6 (1 TRAVEL DISTANCE MAXIMUM ALLOWABLE TRAVEL DISTANCE 200 FEET (SECTION 18.2.6.2.1) COMMON PATH OF TRAVEL 100 FEET (SECTION 18.2.5.3)

<u>OCCUPANT</u> OCCUPANT LOAD SEE SHEET GI110 & GI120

OCCUPANT LOAD > 500 < 1000 - NOT LESS THAN 3 (7.4.1.2) (MINIMUM) NUMBER OF EXITS REQUIRED EXIT CAPACITY SEE SHEET GI110 CORRIDOR FIRE-RESISTANT RATING (TABLE 1020.01)

ANY OCCUPANT LOAD SMOKE PARTITION **INTERIOR FINISHES** INTERIOR WALL AND CEILING FINISH REQUIREMENTS CLASS A OR B

TYPE IIB CONSTRUCTION TYPE **BUILDING ELEMENTS** HOURS UL DESIGN# STRUCTURAL FRAME INCLUDING COLUMNS, GIRDERS, BEAMS, TRUSSES AND SPANDRELS THAT HAVE DIRECT CONNECTIONS TO THE COLUMNS **EXTERIOR** BEARING WALLS INTERIOR BETWEEN RESIDENT & FLOOR CONSTRUCTION MECHANICAL ROOMS AND ASSOCIATED SECONDARY BETWEEN RESIDENT ROOM & MEMBERS UNOCCUPIED SPACE ROOF CONSTRUCTION AND ASSOCIATED SECONDARY PRIMARY ROOF MEMBERS NON-LOADBEARING WALLS AND PARTITIONS HOURS UL DESIGN# EXTERIOR WALLS (TABLE 602) FIRE WALLS (706) EXIT ENCLOSURES (707.3.2 / 1022.1) N/A EXITS PASSAGEWAY (707.3.4 / 1023.3) # U465 N/A HORIZONTAL EXITS (707.3.5 / 1025.1) # U465, U469 INCIDENTAL USE AREAS (707.3.7 / 509) OCCUPANCIES SEPARATION (706.3.9 / 508.4) 2 FIRE PARTITIONS (708) # U465 # U465 SMOKE BARRIERS (709) N/A SHAFT ENCLOSURES (713) # U465 CORRIDOR WALLS (708.3 / 1017.1) (RESIDENT WINGS ONLY)

1) ALL RATED INTERIOR PARTITION SHOULD BE CONSTRUCTED IN ACCORDANCE WITH

THE RATED PARTITION SCHEDULE UNLESS NOTED OTHERWISE ON THE FLOOR PLANS

FIRE RATINGS

SHEET NAME NUMBER GI002 GENERAL INFORMATION, CODE REQUIREMENTS, AND DRAWING LIST GI003 RENDERINGS GI100 UL DESIGN CRITERIA GI101 UL DESIGN CRITERIA GI102 UL DESIGN CRITERIA GI110 FIRST FLOOR LIFE SAFETY & OCCUPANT LOAD PLAN GI120 SECOND FLOOR LIFE SAFETY & OCCUPANT LOAD PLAN ARCHITECTURAL AE001 ARCHITECTURAL GENERAL NOTES, LEGENDS, AND DETAILS AE100 ARCHITECTURAL SITE PLAN AE110 OVERALL ARCHITECTURAL FIRST FLOOR DIMENSION PLAN AE110A OVERALL ARCHITECTURAL FIRST FLOOR EDGE OF SLAB PLAN AE111 FIRST FLOOR ARCHITECTURAL & EQUIPMENT PLAN - AREA A AE112 FIRST FLOOR ARCHITECTURAL & EQUIPMENT PLAN - AREA B AE113 FIRST FLOOR ARCHITECTURAL & EQUIPMENT PLAN - AREA C AE114 FIRST FLOOR ARCHITECTURAL & EQUIPMENT PLAN - AREA D AE120 OVERALL ARCHITECTURAL SECOND FLOOR DIMENSION PLAN AE120A OVERALL ARCHITECTURAL SECOND FLOOR EDGE OF SLAB PLAN AE121 SECOND FLOOR ARCHITECTURAL & EQUIPMENT PLAN - AREA A AE123 SECOND FLOOR ARCHITECTURAL & EQUIPMENT PLAN - AREA C AE124 SECOND FLOOR ARCHITECTURAL & EQUIPMENT PLAN - AREA D AE130 OVERALL ARCHITECTURAL ROOF PLAN AE140 OVERALL ARCHITECTURAL FIRST FLOOR REFLECTED CEILING PLAN AE141 ARCHITECTURAL FIRST FLOOR REFLECTED CEILING PLAN - AREA A AE142 ARCHITECTURAL FIRST FLOOR REFLECTED CEILING PLAN - AREA B AE143 ARCHITECTURAL FIRST FLOOR REFLECTED CEILING PLAN - AREA C AE144 ARCHITECTURAL FIRST FLOOR REFLECTED CEILING PLAN - AREA D AE150 OVERALL ARCHITECTURAL SECOND FLOOR REFLECTED CEILING PLAN AE200 ARCHITECTURAL BUILDING ENVELOPE WALL & ROOF SYSTEMS AE201 ARCHITECTURAL BUILDING ENVELOPE CURTAINWALL, DOOR, AND WINDOW AE202 ARCHITECTURAL EXTERIOR ELEVATIONS AE203 ARCHITECTURAL EXTERIOR ELEVATIONS AE300 ARCHITECTURAL BUILDING SECTIONS AE310 ARCHITECTURAL EXTERIOR WALL SECTIONS - AREA A AE311 ARCHITECTURAL EXTERIOR WALL SECTIONS - AREA A AE312 ARCHITECTURAL EXTERIOR WALL SECTIONS - AREA A AE313 ARCHITECTURAL EXTERIOR WALL SECTIONS - AREA B AE314 ARCHITECTURAL EXTERIOR WALL SECTIONS - AREA C AE315 ARCHITECTURAL EXTERIOR WALL SECTIONS - AREA D AE316 ARCHITECTURAL EXTERIOR WALL SECTIONS - AREA D AE320 ARCHITECTURAL EXTERIOR PLAN DETAILS AE321 ARCHITECTURAL EXTERIOR PLAN DETAILS AE330 ARCHITECTURAL EXTERIOR SECTION DETAILS AE331 ARCHITECTURAL EXTERIOR SECTION DETAILS AE332 ARCHITECTURAL EXTERIOR SECTION DETAILS AE333 ARCHITECTURAL EXTERIOR SECTION DETAILS AE340 ARCHITECTURAL ROOF DETAILS AE400 ARCHITECTURAL INTERIOR ELEVATION GENERAL NOTES & LEGENDS AE401 | ARCHITECTURAL INTERIOR ELEVATIONS - AREAS A & B AE402 ARCHITECTURAL INTERIOR ELEVATIONS - AREAS A & B AE403 ARCHITECTURAL INTERIOR ELEVATIONS - AREA B AE404 ARCHITECTURAL INTERIOR ELEVATIONS - AREA B AE405 ARCHITECTURAL INTERIOR ELEVATIONS - AREA B AE406 ARCHITECTURAL INTERIOR ELEVATIONS - AREAS C & D AE407 ARCHITECTURAL ENLARGED PLANS & INTERIOR ELEVATIONS - TYPICAL RESIDENT ROOM AE408 ARCHITECTURAL ENLARGED PLAN & INTERIOR ELEVATIONS - BARIATRIC RESIDENT ROOM 113 AE501 ARCHITECTURAL PARTITION TYPES & FRAMING DETAILS AE502 ARCHITECTURAL RATED ASSEMBLY DETAILS AE510 ARCHITECTURAL CEILING & SOFFIT DETAILS AE520 ARCHITECTURAL INTERIOR DETAILS AE521 ARCHITECTURAL INTERIOR & MILLWORK DETAILS AE530 ARCHITECTURAL MILLWORK DETAILS AE531 ARCHITECTURAL MILLWORK DETAILS - KITCHEN AE532 ARCHITECTURAL MILLWORK DETAILS AE533 ARCHITECTURAL MILLWORK DETAILS - RESIDENT ROOM & TOILET ROOM AE600 ARCHITECTURAL DOOR & BORROWED LIGHT LEGEND & DETAILS

AE601 ARCHITECTURAL BI-FOLD DOOR DETAILS

AE630 ARCHITECTURAL INTERIOR SCHEDULES AE701 ARCHITECTURAL EQUIPMENT SCHEDULE

AE602 ARCHITECTURAL DOOR & BORROWED SCHEDULES

AE801 ARCHITECTURAL TOILET ACCESSORY & LOCKER SCHEDULES

AF111 ARCHITECTURAL FIRST FLOOR FINISH & FLOOR PATTERN PLAN - AREA A AF112 ARCHITECTURAL FIRST FLOOR FINISH & FLOOR PATTERN PLAN - AREA B AF113 ARCHITECTURAL FIRST FLOOR FINISH & FLOOR PATTERN PLAN - AREA C AF114 ARCHITECTURAL FIRST FLOOR FINISH & FLOOR PATTERN PLAN - AREA D

DRAWING LIST

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f: 601-270-0995

148 S Queen St, Suite 201 | LANDSCAPE ARCHITECTURE Martinsburg, WV 25401 SURVEY AND MAPPING Phone: 304-725-8456 | SECURITY CONSULTING www.gordon.us.com

Miller-Remick LLC A Service Disabled Veteran Owned PHONE: (856)429-4000 FAX: (856)429-5002

ENGINEER OF RECORD **PROFESSIONAL ENGINEER**

Office of Construction and Facilities Management

Drawing Title Project Title Project Number GENERAL INFORMATION, CODE BID DOCUMENTS CONSTRUCT NEW COMMUNITY 595-601 REQUIREMENTS, AND DRAWING LIST LIVING CENTER (CLC) **Building Number** CLC-1 **Drawing Number** Approved: LEBANON, PENNSYLVANIA GI002 Checked Drawn MPY

PROFESSIONAL ENGINEEER

Date:

ARRAY 1 West Elm Street, Ste 400
Conshohocken, PA 19429 architects, o: 610-270-0599

1010 KINGS HIGHWAY SOUTH CHERRY HILL, NEW JERSEY 08034 MR PROJECT NO: 0499-0124

MILLER-REMICK LLC

U.S. Department of Veterans Affairs

VA FORM 08 - 6231


Revisions:



nch = one foot

8
16
0
PM




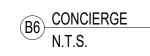



C8 KITCHEN 2 N.T.S.

B8 KITCHEN N.T.S.

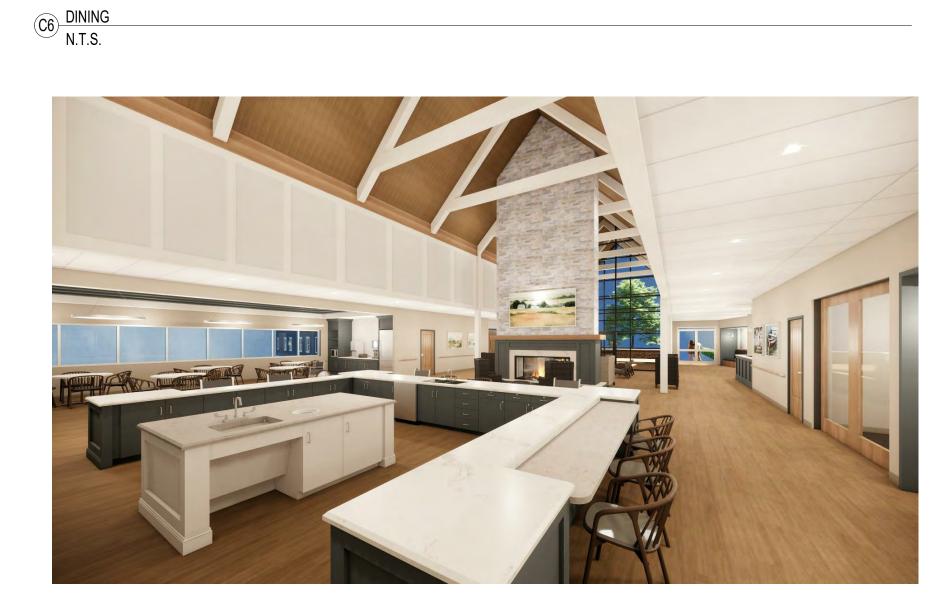



O6 GREAT-ROOM N.T.S.




D8 KITCHEN 3
N.T.S.

RESIDENT TOILET ROOM
N.T.S.

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	ARRAY-ARCHITECTS.COM 1 West Elm Street, Ste 400 Conshohocken, PA 19428 o: 610-270-0599 f: 601-270-0995	Miller-Remick LLC M.E.P. & Structural Engineering A Service Disabled Veteran Owned Small Business 1010 KINGS HIGHWAY SOUTH CHERRY HILL, NEW JERSEY 08034 PHONE: (856)429-4000 FAX: (856)429-5002 MR PROJECT NO: 0499-0124		Construction and Facilities Management U.S. Department of Veterans Affair			LIVING CENTER (CLC)	Building Number CLC-1
					Approved:		Location LEBANON, PENNSYLVANIA	Drawing Number
Revisions: Date:							Issue Date 2023-02-09 Checked JP MPY,LM	GI003
VA FORM 08 - 6231		 		_	_			

F6 FIREPLACE N.T.S.

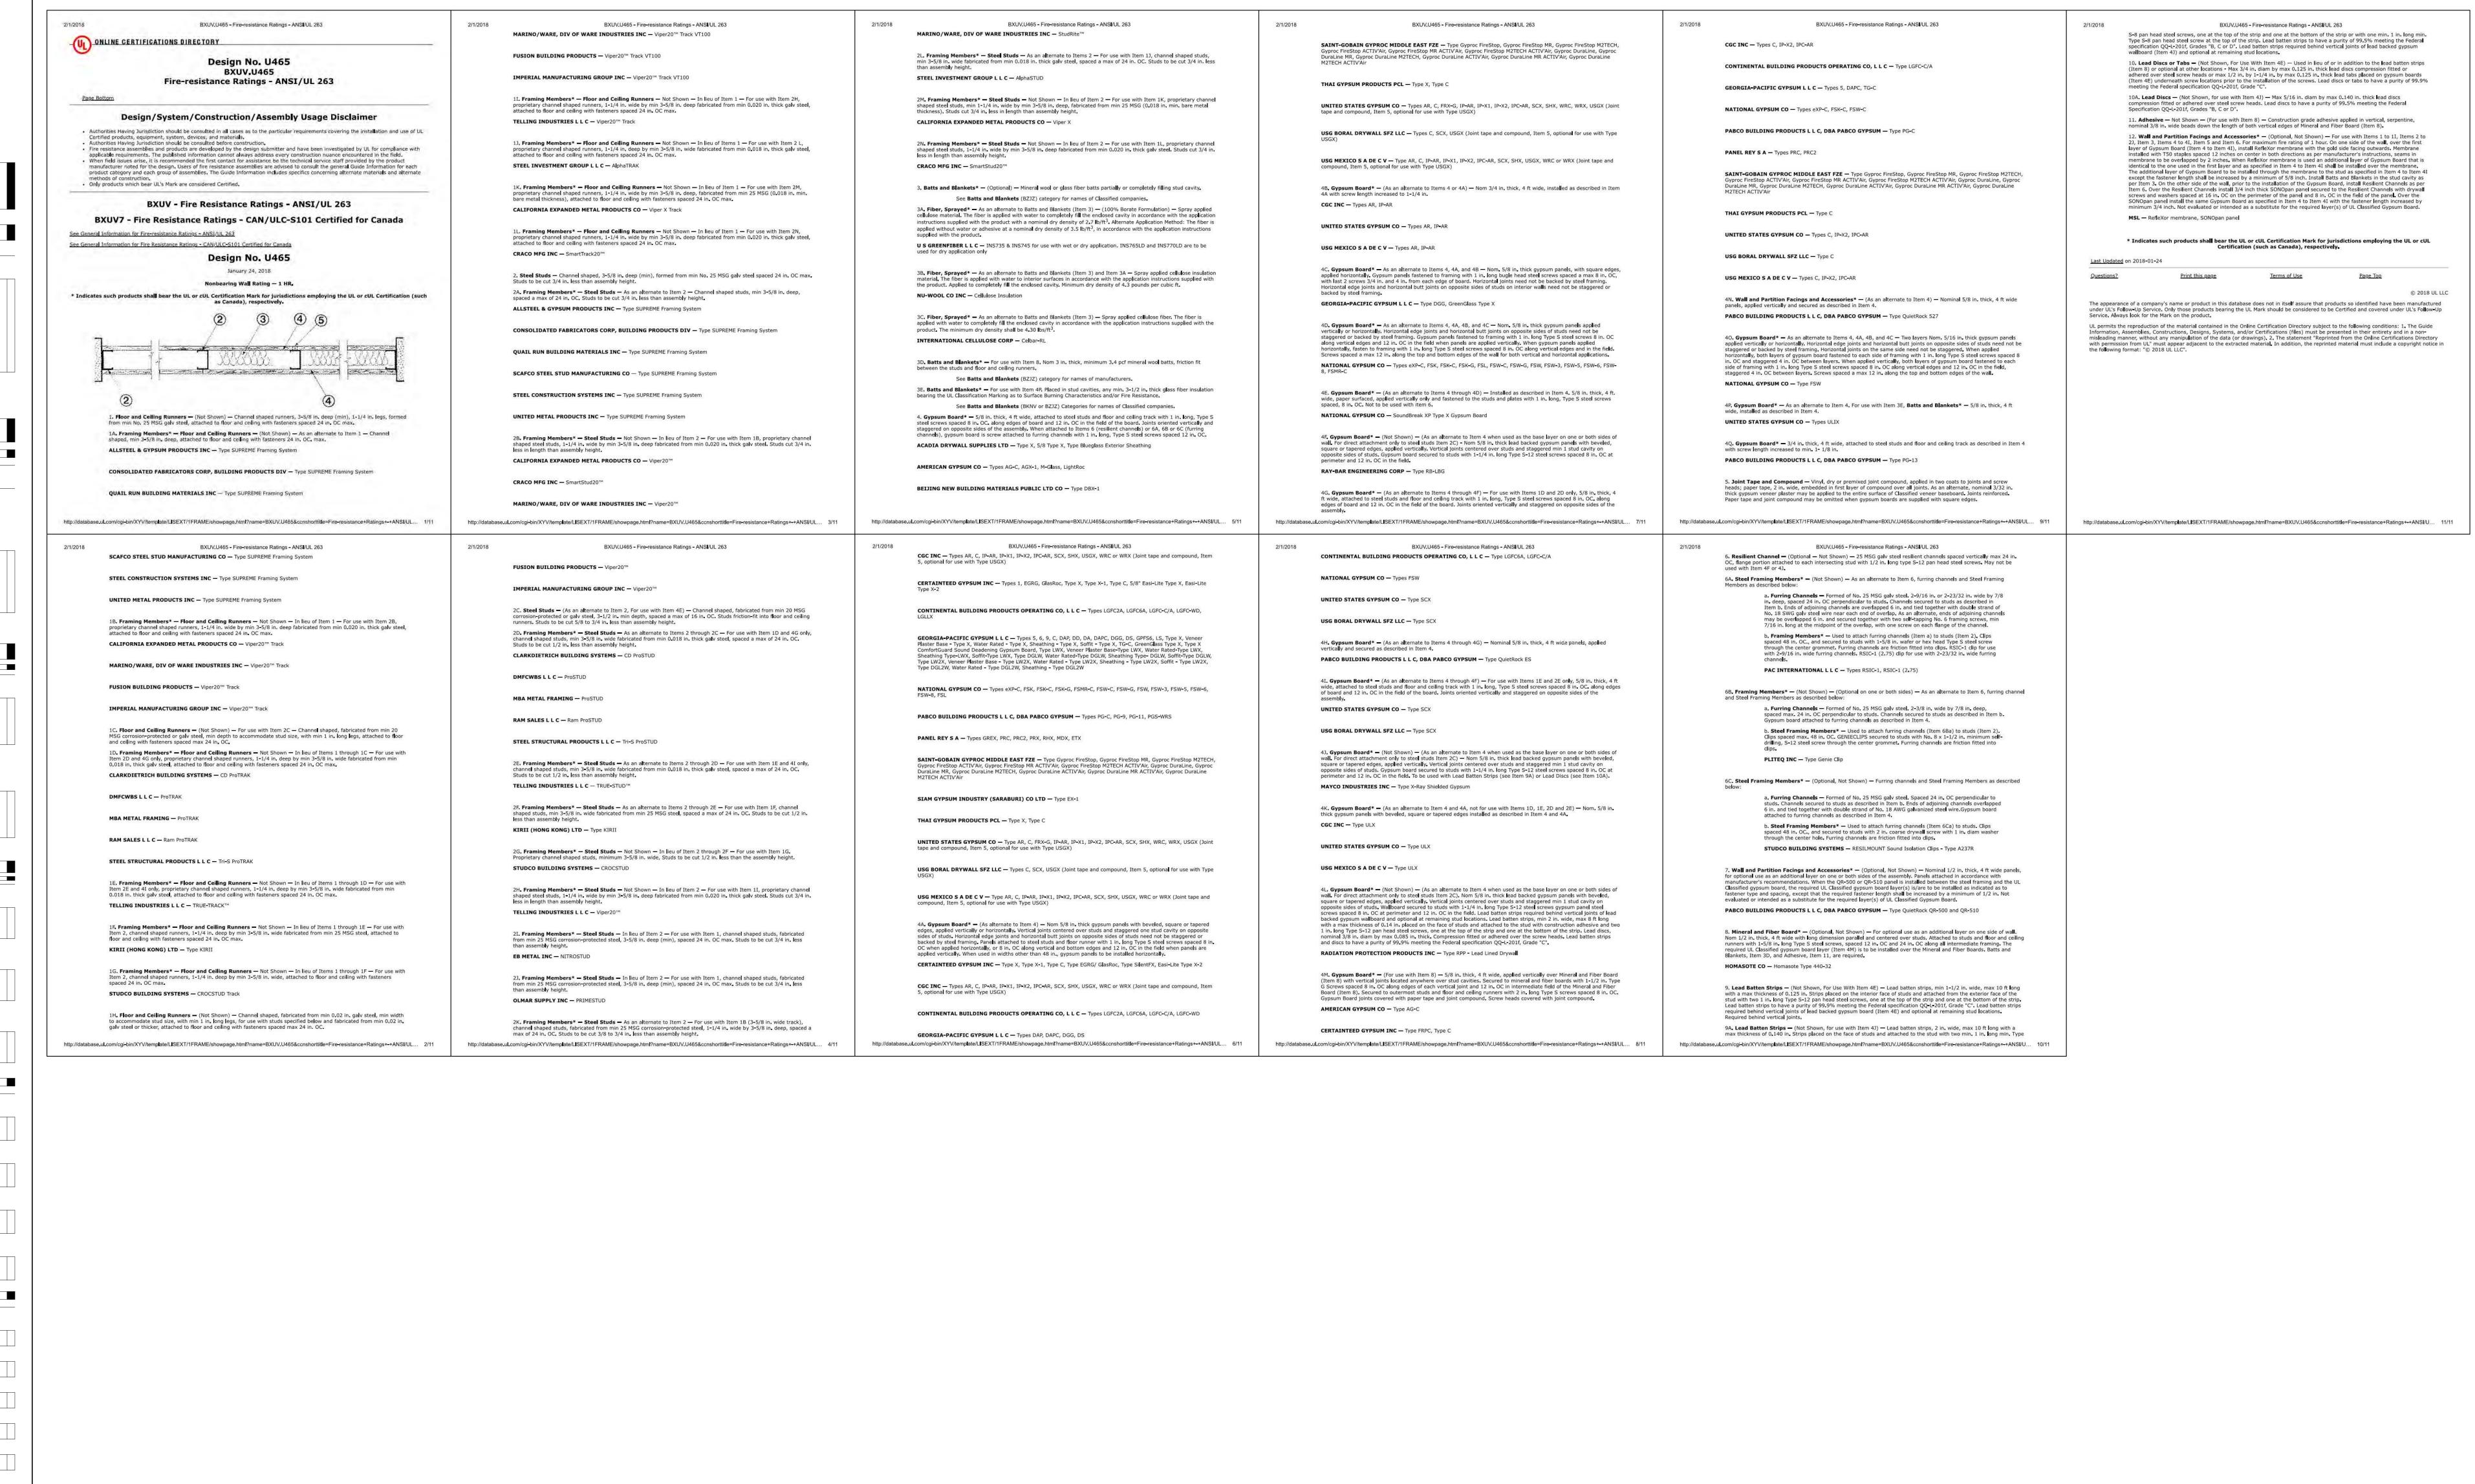

PRINTS OF THIS DRAWING SHALL NOT BE USED FOR ANY PURPOSE WHATSOEVER WITHOUT THE SEAL AND SIGNATURE OF THE **Drawing Title Project Title Project Number** MILLER-REMICK LLC ENGINEER OF RECORD Office of **UL DESIGN CRITERIA** BID DOCUMENTS **PROFESSIONAL ENGINEER** CONSTRUCT NEW COMMUNITY 595-601 PROFESSIONAL ENGINEEER Miller-Remick LLC Construction LIVING CENTER (CLC) **Building Number** and Facilities CLC-1 A Service Disabled Veteran Owned ARRAY 1 West Elm Street, Ste 400
Conshohocken PA 19429 **Drawing Number** Management Approved: 148 S Queen St, Suite 201 LANDSCAPE ARCHITECTURE LEBANON, PENNSYLVANIA 1010 KINGS HIGHWAY SOUTH Martinsburg, WV 25401 SURVEY AND MAPPING architects, o: 610-270-0599 CHERRY HILL, NEW JERSEY 08034 Phone: 304-725-8456 | SECURITY CONSULTING PHONE: (856)429-4000 f: 601-270-0995 Checked Drawn GI100 U.S. Department of Veterans Affairs FAX: (856)429-5002 www.gordon.us.com MR PROJECT NO: 0499-0124 MPY of Veterans Affairs JP Date: Revisions VA FORM 08 - 6231

