

# RENOVATION TO HILL CLUBHOUSE BOYS & GIRLS CLUB

## SYMBOLS

<p><b>SECTION TAG</b> DETAIL NUMBER SHEET NUMBER</p> <p><b>INTERIOR ELEVATION</b> ELEVATION NUMBER SHEET NUMBER</p> <p><b>EXTERIOR ELEVATION</b> ELEVATION NUMBER SHEET NUMBER</p> <p><b>DETAIL TAG</b> DETAIL NUMBER</p> <p><b>PARTITION/BULKHEAD TAG</b> (REFER TO A1.0 FOR TYPES)</p>	<p><b>ROOM TAG</b> ROOM NAME ROOM NUMBER</p> <p><b>CASEWORK TAG</b> BASIS OF DESIGN MODEL NUMBER (CUSTOM/MODIFIED CABINETS HAVE "M" SUFFIX) CABINET NOMINAL HEIGHT CABINET WIDTH</p> <p><b>WINDOW TAG</b></p> <p><b>CURTAIN WALL TAG</b></p> <p><b>STOREFRONT TAG</b></p> <p><b>INTERIOR WINDOW TAG</b></p>	<p><b>DOOR TAG</b></p> <p><b>ROOF TAG</b></p> <p><b>NEW DOOR</b></p> <p><b>EXISTING DOOR</b></p> <p><b>EXISTING COL. LINE</b> OCTAGON ITALIC TEXT</p> <p><b>NEW COL. LINE</b> CIRCLE STANDARD TEXT</p>																																																																																																																																																																																																																																																																																																																				
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BITUMINOUS</td> <td>FFE FURNITURE, FIXTURES AND EQUIPMENT</td> <td>NA NOT APPLICABLE</td> <td>SYS SYSTEM</td> </tr> <tr> <td>BLDG BUILDING</td> <td>FFE FINISH FLOOR ELEVATION</td> <td>NC NOISE CRITERIA</td> <td>T TREAD</td> </tr> <tr> <td>BLKG BLOCKING</td> <td>FIN FINISH</td> <td>NIC NOT IN CONTRACT</td> <td>T&amp;B TOP AND BOTTOM</td> </tr> <tr> <td>BM BEAM</td> <td>FIXT FIXTURE</td> <td>NO NUMBER</td> <td>T&amp;G TONGUE AND GROOVE</td> </tr> <tr> <td>BO BOTTOM OF</td> <td>FLR FLOOR</td> <td>NOM NOMINAL</td> <td>TELE TELEPHONE</td> </tr> <tr> <td>BRG BEARING</td> <td>FND FOUNDATION</td> <td>NTS NOT TO SCALE</td> <td>TEMP TEMPORARY</td> </tr> <tr> <td>BSMNT BASEMENT</td> <td>FO FACE OF</td> <td>OA OUTSIDE AIR</td> <td>THK THICKNESS</td> </tr> <tr> <td>CB CEMENT BOARD</td> <td>FR FIRE PROTECTION</td> <td>OC ON CENTER</td> <td>TKBD TACK BOARD</td> </tr> <tr> <td>CBU CEMENTITIOUS BACKER UNIT</td> <td>FRP FIBER REINFORCED PLASTIC</td> <td>OD OUTSIDE DIAMETER</td> <td>TLT TOILET</td> </tr> 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COVER	LAM LAMINATE	RWL RAIN WATER LEADER		EJC EXPANSION JOINT COVER	LAV LAVATORY	S SOUTH		EL ELEVATION	LB POUNDS	SA SUPPLY AIR		ELEC ELECTRICAL	LGM LIGHT GAUGE METAL	SC SOLID CORE		ELEV ELEVATOR	LH LONG LEG HORIZONTAL	SD STORM DRAIN		EMER EMERGENCY		SECT SECTION		ENCL ENCLOSURE				ENG ENGINEER			
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## ARCHITECTURAL

- CS1 COVER SHEET
- A1.1 DEMOLITION PLAN, RENOVATION PLAN, REFLECTED CEILING PLAN, SCHEDULES
- A8.1 ENLARGED PLANS, ACCESSIBILITY DETAILS

## PLUMBING


- P0.1 PLUMBING NOTES & SCHEDULES
- P1.1 PLUMBING PLANS

## MECHANICAL

- M0.1 HVAC NOTES & SCHEDULES
- M1.1 HVAC PLANS

## ELECTRICAL

- E0.1 ELECTRICAL NOTES & SCHEDULES
- E1.1 ELECTRICAL PLANS

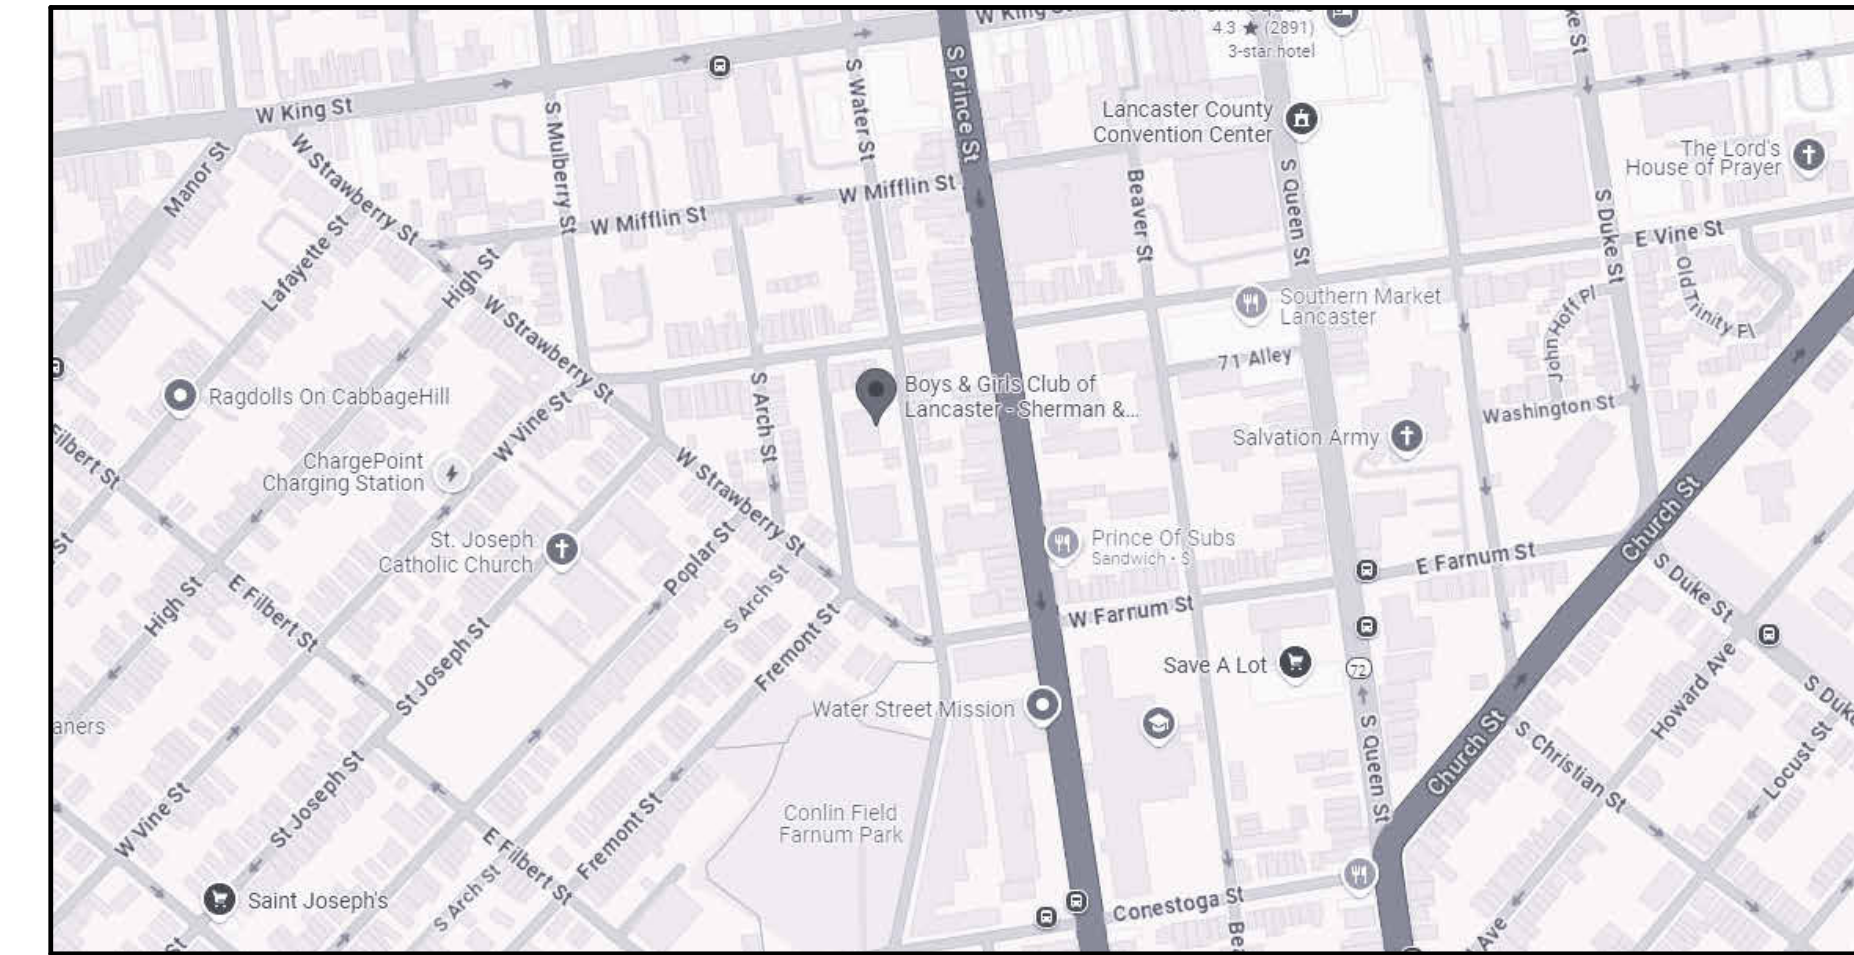

LOCATION MAP

## PROJECT SUMMARY

THE PROPOSED PROJECT IS AT THE EXISTING BOYS & GIRLS CLUB OF LANCASTER - SOUTHEAST CLUBHOUSE LOCATED AT 116 S WATER ST, LANCASTER, PA 17603

THE PROJECT CONSISTS OF RENOVATION OF THE EXISTING RESTROOMS. THE RENOVATIONS WILL INCLUDE NEW WALLS, DOORS, TOILET FIXTURES AND ACCESSORIES, AND FINISHES. PLUMBING, MECHANICAL, AND ELECTRICAL SCOPE WILL ALSO BE INCLUDED.

## BUILDING CODE ANALYSIS:

PENNSYLVANIA UNIFORM CONSTRUCTION CODE (UCC):  
INTERNATIONAL BUILDING CODE - 2018  
INTERNATIONAL BUILDING CODE - 2018 CHAPTER 11  
INTERNATIONAL EXISTING BUILDING CODE - 2018  
INTERNATIONAL FIRE CODE - 2018  
INTERNATIONAL PLUMBING CODE - 2018  
INTERNATIONAL ENERGY CONSERVATION CODE - 2018  
INTERNATIONAL MECHANICAL CODE - 2018  
ICC A117.1 - 2012 ACCESSIBILITY CODE

## PLUMBING CODE ANALYSIS:

INTERNATIONAL PLUMBING CODE - 2018

403.1.1 FIXTURE CALCULATIONS  
TO DETERMINE THE OCCUPANT LOAD OF EACH SEX, THE TOTAL OCCUPANT LOAD SHALL BE DIVIDED IN HALF. TO DETERMINE THE REQUIRED NUMBER OF FIXTURES, THE FIXTURE RATIO OR RATIOS FOR FIXTURE TYPE SHALL BE APPLIED TO THE OCCUPANT LOAD OF EACH SEX IN ACCORDANCE WITH TABLE 403.1

2018 EXISTING INTERNATIONAL BUILDING CODE §10.1 MINIMUM FIXTURES:  
WHERE THE OCCUPANT LOAD OF THE STORY IS INCREASED BY 20 PERCENT, PLUMBING FIXTURES FOR THE STORY SHALL BE PROVIDED IN QUANTITIES SPECIFIED IN THE INTERNATIONAL PLUMBING CODE BASED ON THE INCREASED OCCUPANT LOAD.

BUILDING REQUIREMENTS

EXISTING OCCUPANCY NO CHANGE

EXIST FIRST FLOOR PLUMBING FIXTURES:

WATER CLOSETS: 3  
URINALS: 1  
LAVATORIES: 4

PROPOSED PLUMBING FIXTURES:

WATER CLOSETS: 4  
LAVATORIES: 4

CONSULTANT:

RENOVATION TO  
HILL CLUBHOUSE

BOYS & GIRLS CLUB  
116 S WATER ST, LANCASTER, PA 17603

ISSUE DATES  
DATE: 10/01/2024  
DESCRIPTION: BID DOCUMENTS

PROJ #: 24-800-01 DRAWN BY: SAB  
SHEET TITLE:

COVER SHEET

SHEET NUMBER:



CS1

BID



**SPECIFIC DEMOLITION NOTES - SHEET AD1.1**

08-01	REMOVE DOOR, HARDWARE AND FRAME
08-02	REMOVE DOOR, HARDWARE AND FRAME - EXISTING MASONRY OPENING TO REMAIN
09-01	REMOVE STUD WALL CONSTRUCTION - REFER TO ARCHITECTURAL DWGS FOR EXTENT.
10-01	REMOVE TOILET ACCESSORIES - ENTIRE ROOM, SALVAGE
10-02	REMOVE TOILET PARTITIONS - ENTIRE ROOM
22-01	REFER TO PLUMBING DRAWINGS FOR REMOVAL OF PLUMBING FIXTURES AND EQUIPMENT
23-01	REFER TO HVAC DRAWINGS FOR REMOVAL OF HVAC COMPONENTS
26-01	REFER TO ELECTRICAL DRAWINGS FOR REMOVAL OF ELECTRICAL EQUIPMENT - BY ELECTRICAL CONTRACTOR.

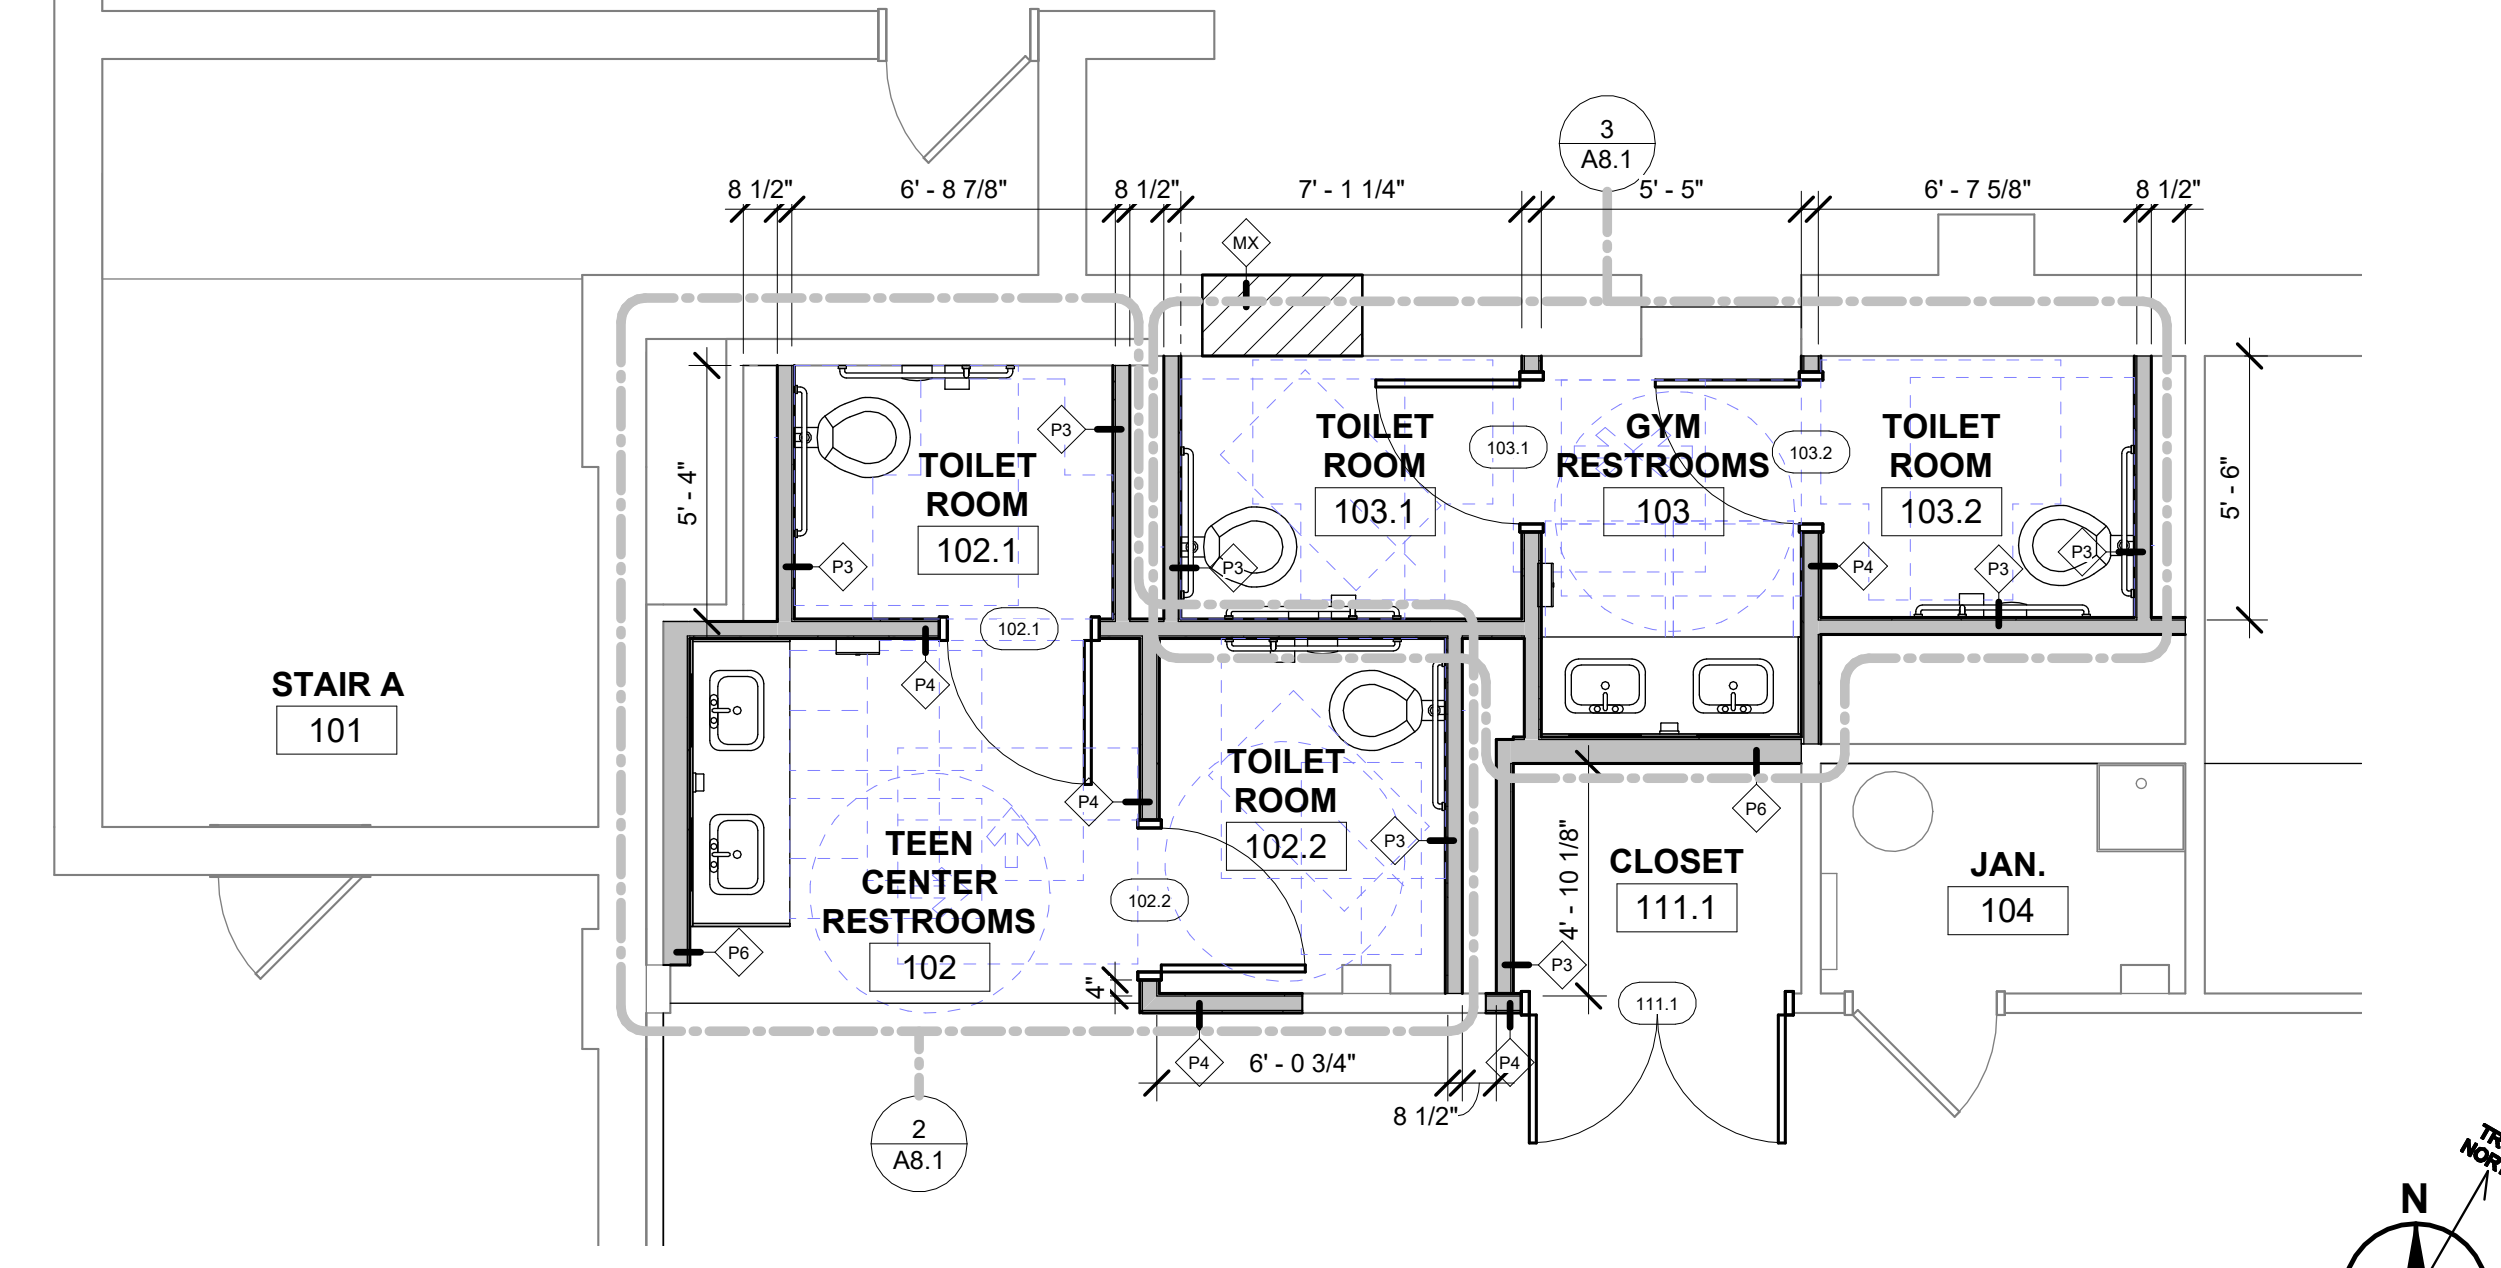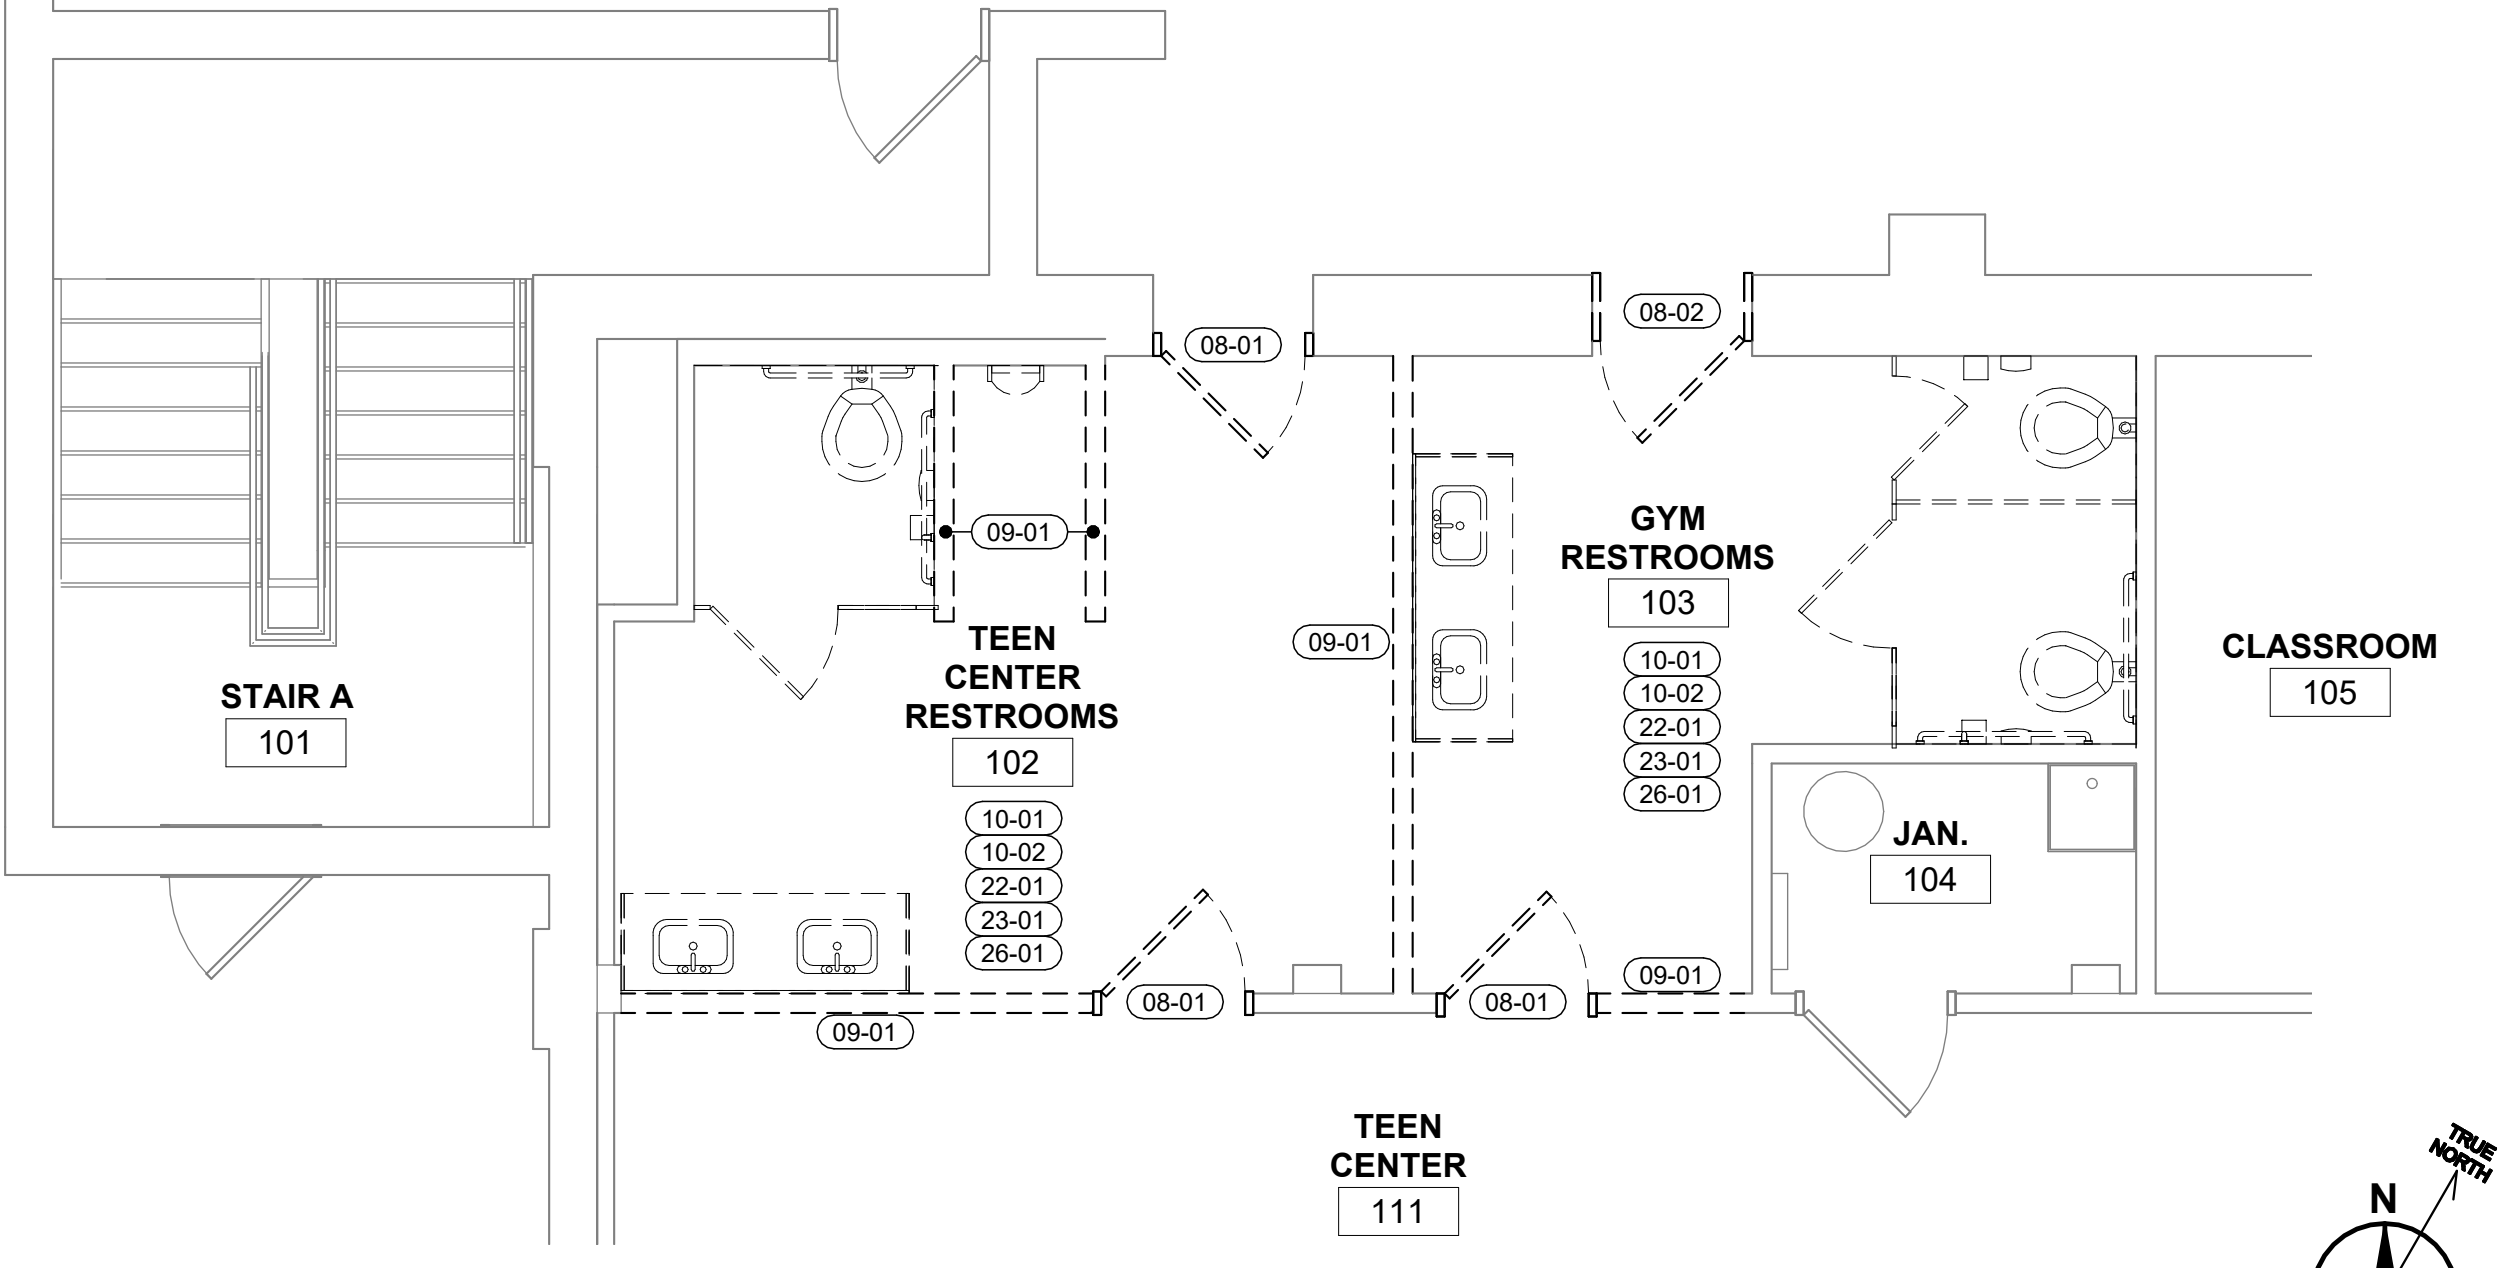

**PARTITION TYPE SCHEDULE & NOTES**

**INTERIOR PARTITIONS**

**STUD PARTITIONS**

	P3	3 5/8" MTL. STUDS W/ ONE LAYER OF 5/8" GWB ON ONE SIDE, FILL W/ ACOUS. BATT INSUL.
	P4	NOTE: (2) BACK-TO-BACK P3 WALLS. STC-50
	P6	3 5/8" MTL. STUDS W/ 5/8" GWB E.S., FILL W/ ACOUS. BATT INSUL.
	P6	6" MTL. STUDS W/ ONE LAYER OF 5/8" GWB ON ONE SIDE

**WALL INFILLS**

	MX	C.M.U. INFILL TO MATCH EXISTING WALL THICKNESS. MATCH EXISTING FIRE-RATING, WHERE APPLICABLE.
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**6 FIRST FLOOR - DEMOLITION PLAN**  
A1.1 1/4" = 1'-0"


**5 FIRST FLOOR - RENOVATION PLAN**  
A1.1 1/4" = 1'-0"

**GENERAL ACOUSTICAL CEILING INSTALLATION NOTES**

- THE CONTRACTOR SHALL FIELD CHECK THE PREMISES AND VERIFY THAT THE CEILING LAYOUT SHOWN ON THE DRAWINGS CAN BE ACCOMMODATED AND VERIFY ALL CLEARANCES AS REQUIRED FOR ALL LIGHTING FIXTURES, DUCT WORK, AND SPRINKLERS BEFORE PROCEEDING WITH ANY INSTALLATION. REPORT ANY DISCREPANCIES TO THE ARCHITECT PRIOR TO PROCEEDING.
- REVIEW CEILING LAYOUT WITH MEP COORDINATION DRAWINGS.
- CEILING SHALL BE TRUE, FLAT, STRAIGHT AND REGULAR, PROVIDE STABILIZER BARS AS REQUIRED TO DISTRIBUTE LOAD EQUALLY OVER TWO OR MORE RUNNERS.
- LEVEL CEILING TO BE WITHIN 1/8" IN 12 FEET IN ANY DIRECTION. LEVEL WITH HANGER WIRE TAUT AND PLUMB, WITHOUT KINKING OR BENDING HANGER WIRES.
- INSTALL MAX. LENGTHS OF EDGE MOLDING AT INTERSECTION OF CEILING AND VERTICAL SURFACE. MITRE ALL CORNERS.
- COORDINATE INSTALLATION WITH ELECTRICAL, MECHANICAL AND SPRINKLER REQUIREMENTS.
- INSTALL CEILING TILE HOLD DOWN CLIPS IN ALL VESTIBULES, AIR LOCKS AND PARTITIONS WITH CUT CEILING TILES.
- LAY DIRECTIONAL PATTERN UNITS IN SINGLE DIRECTION.
- ALL FIXTURE TRIM (LIGHTING, SPEAKER, HVAC GRILLS, ETC.) SHALL BE METAL AND PAINTED TO MATCH ADJACENT CEILING FINISH. PLASTIC TRIM IS NOT ACCEPTABLE UNLESS APPROVED BY THE ARCHITECT.
- REGULAR CEILING TILE TO BE CUT AND FITTED SNUG AGAINST PARTITIONS. DO NOT SHIM THE GRID TO ALLOW CEILING TILE TO PASS OVER TOP OF PARTITION.
- FINAL GRID HEIGHTS AND LAY-OUT TO BE DETERMINED IN THE FIELD FOLLOWING COORDINATION.

**DOOR SCHEDULE**

DOOR NUMBER	SIZE		DOOR TYPE	DOOR MATERIAL	FIRE RATING	FRAME				COMMENTS	
	WIDTH	LEAF 2				FRAME TYPE	FRAME MATERIAL	HEAD	JAMB		
102.1	3'-0"		7'-0"	F	HM	-	HM1	HM	10/A1.1	11/A1.1	
102.2	3'-0"		7'-0"	F	HM	-	HM1	HM	10/A1.1	11/A1.1	
103.1	3'-0"		7'-0"	F	HM	-	HM1	HM	10/A1.1	11/A1.1	
103.2	3'-0"		7'-0"	F	HM	-	HM1	HM	10/A1.1	11/A1.1	
111.1	2'-8"	2'-8"	7'-0"	F	HM	-	HM2	HM	10/A1.1	11/A1.1	

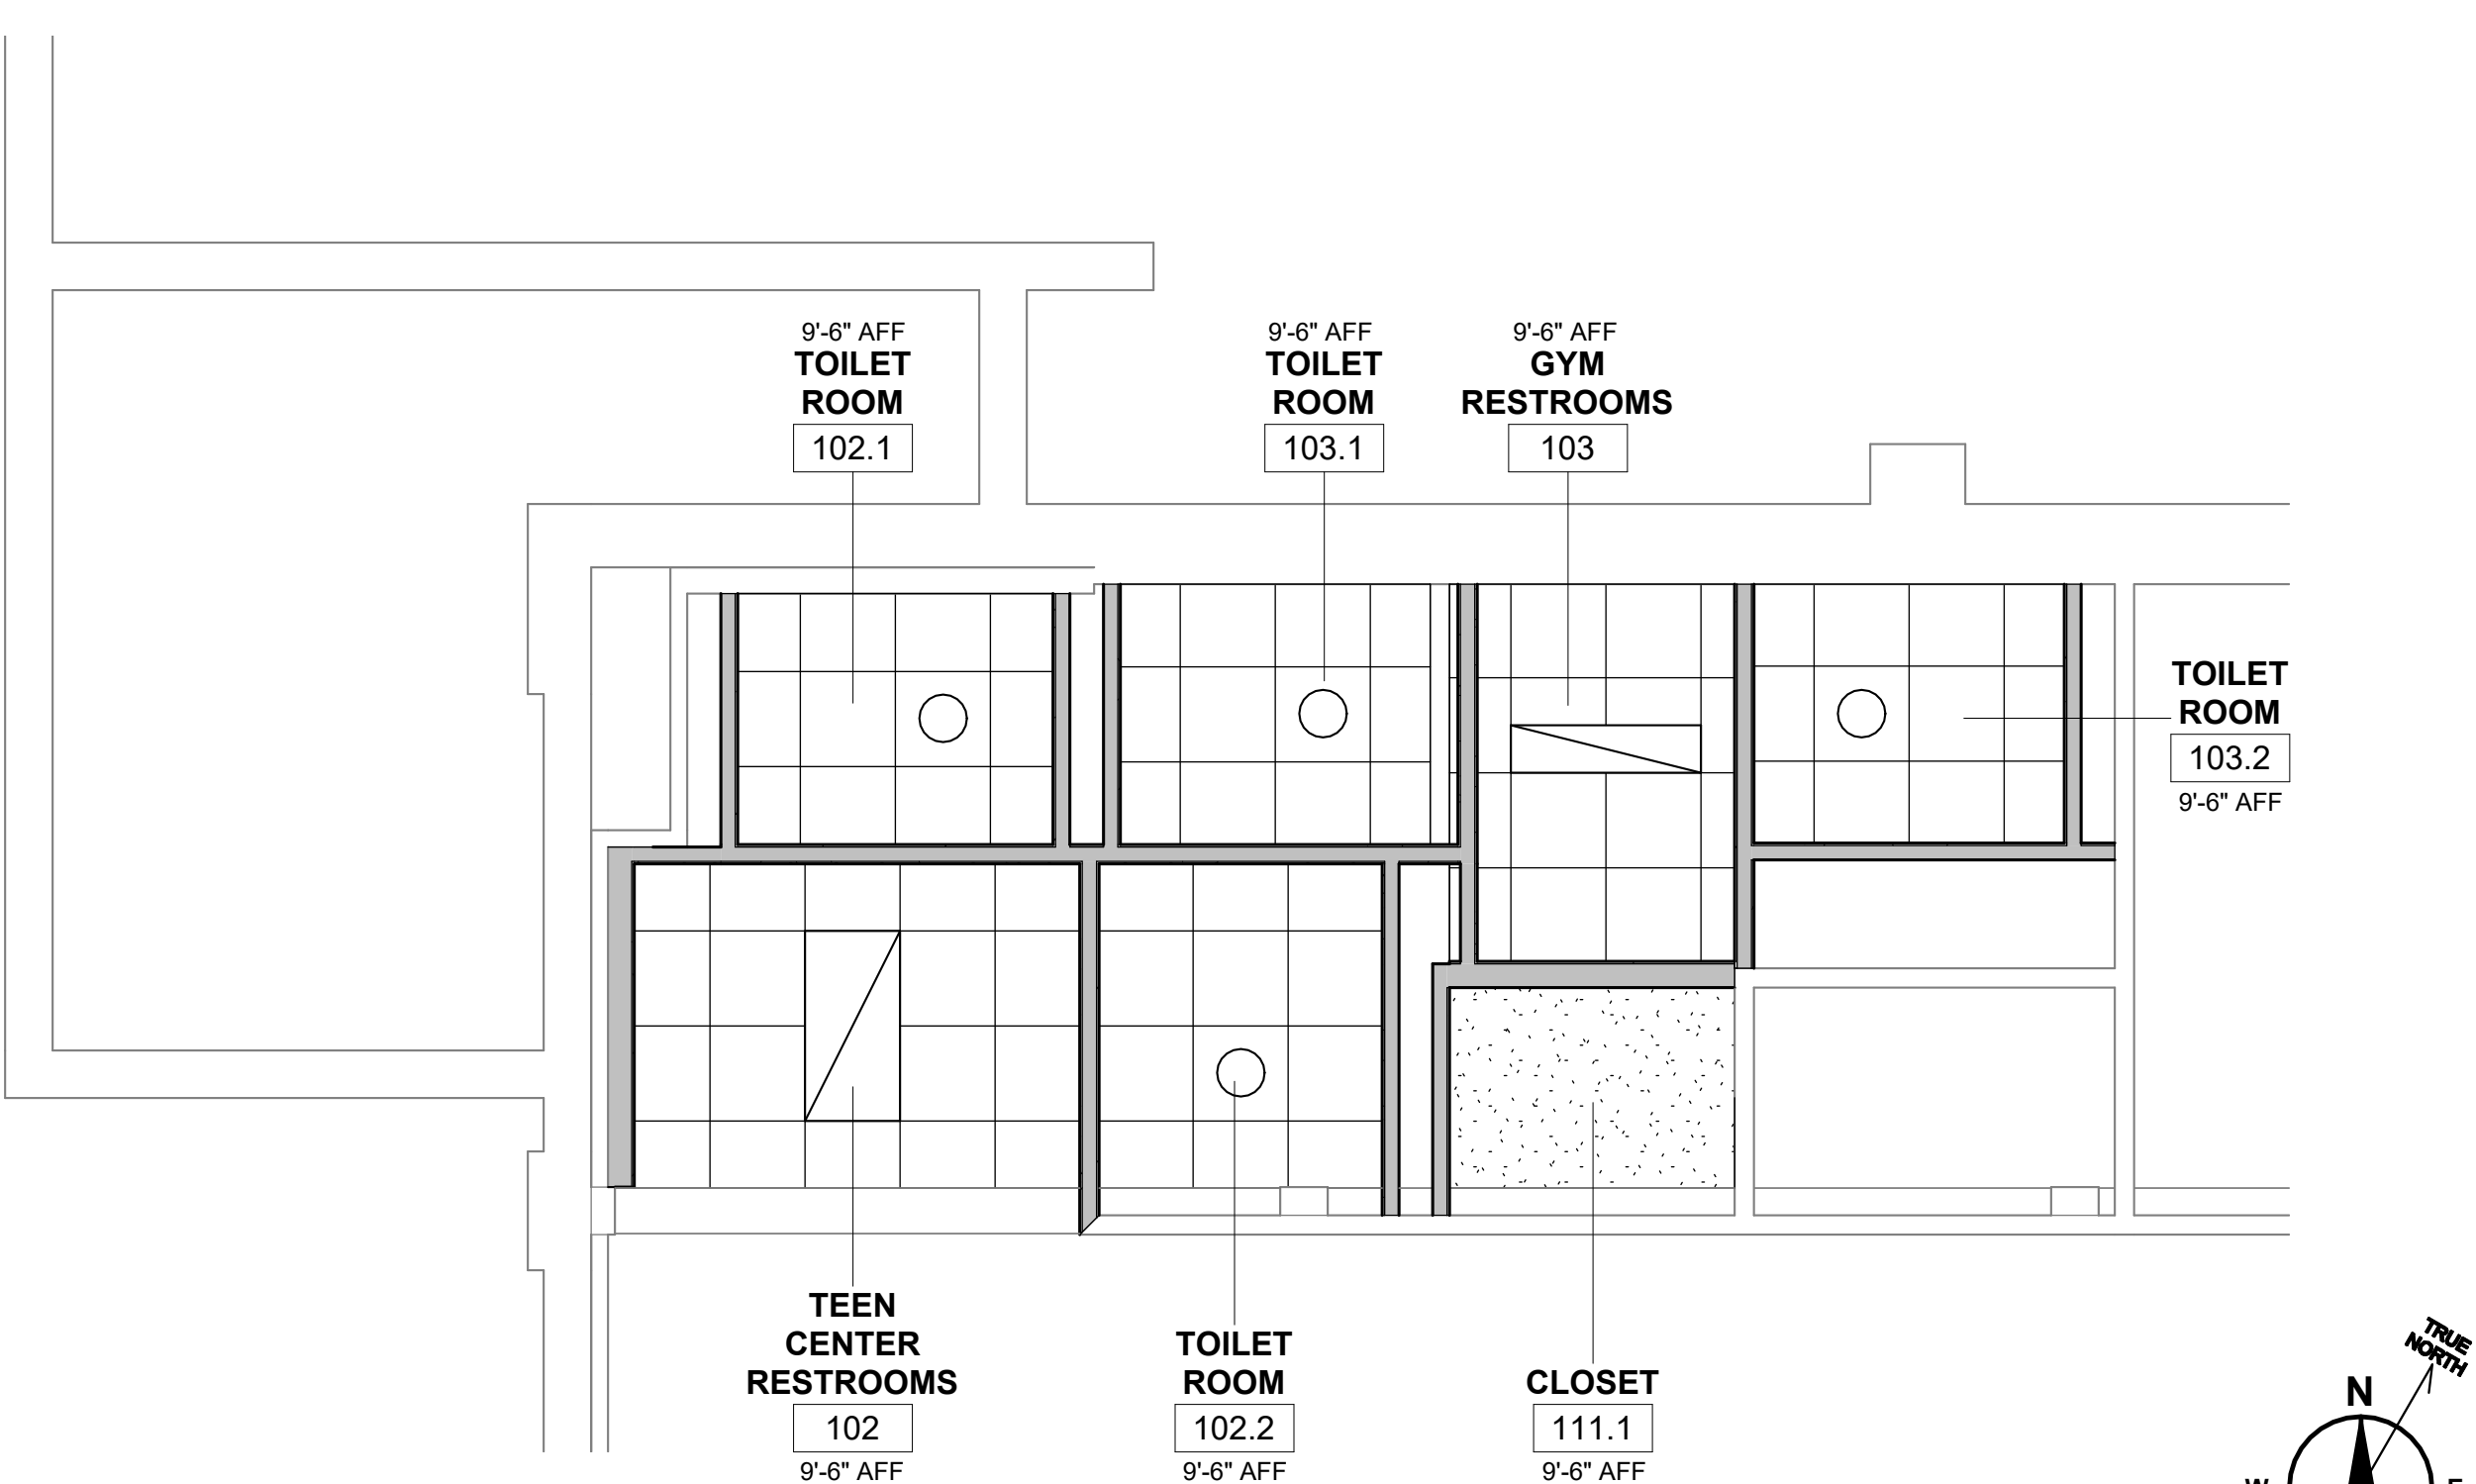


**GENERAL REFLECTED CEILING PLAN LEGEND AND NOTES:**

	INDICATES A LIGHTING FIXTURE. REFER TO ELECTRICAL DWGS.
	INDICATES A HVAC DIFFUSER. REFER TO MECHANICAL DWGS.
	INDICATES AN EXHAUST FAN W/ LED LIGHT. REFER TO MEP DWGS.
	INDICATES CRITICAL ENVIRONMENT DIFFUSER. REFER TO MECHANICAL DWGS.
	INDICATES PYRAMID DIFFUSER. REFER TO FINISH SCHEDULE.
	INDICATES 2X4 A.C.T. CEILING. REFER TO FINISH SCHEDULE.
	INDICATES 2X2 A.C.T. CEILING. REFER TO FINISH SCHEDULE.
	INDICATES G.W.B. CEILING. REFER TO FINISH SCHEDULE.


**NOTES:**

- REFER TO FINISH SCHEDULE FOR CEILING MATERIALS.
- REFER TO WALL AND BUILDING SECTIONS FOR INFORMATION RELATED TO SLOPED CEILINGS.
- ALL EXPOSED STRUCTURE IS TO BE PAINTED - COLOR SELECTION BY ARCHITECT.
- ALL EXPOSED EQUIPMENT IS TO BE PAINTED - COLOR SELECTION BY ARCHITECT. EXPOSED MECHANICAL, ELECTRICAL, PLUMBING AND ARCHITECTURAL TO BE PAINTED.

**8 DOOR TYPES**  
A1.1 1/4" = 1'-0"

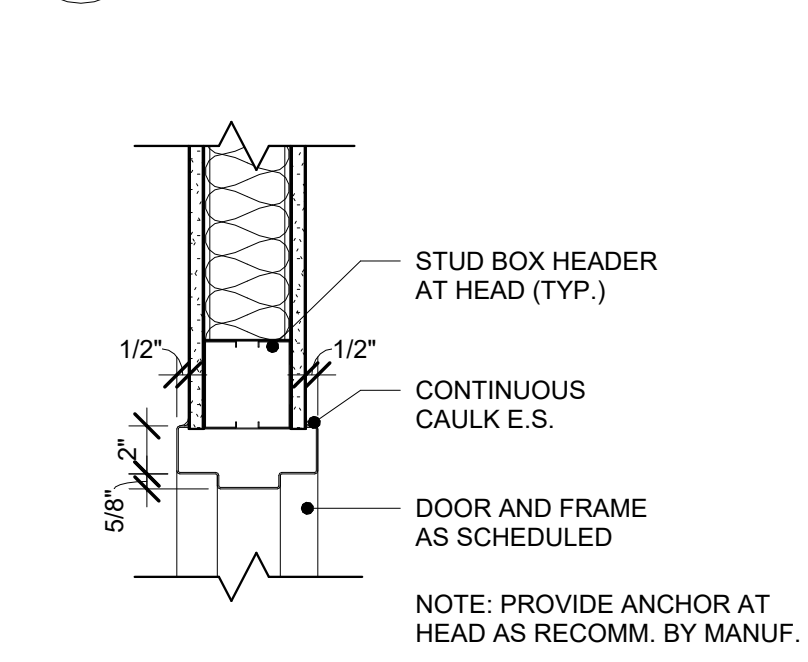


**9 HOLLOW METAL FRAME TYPES**  
A1.1 1/4" = 1'-0"

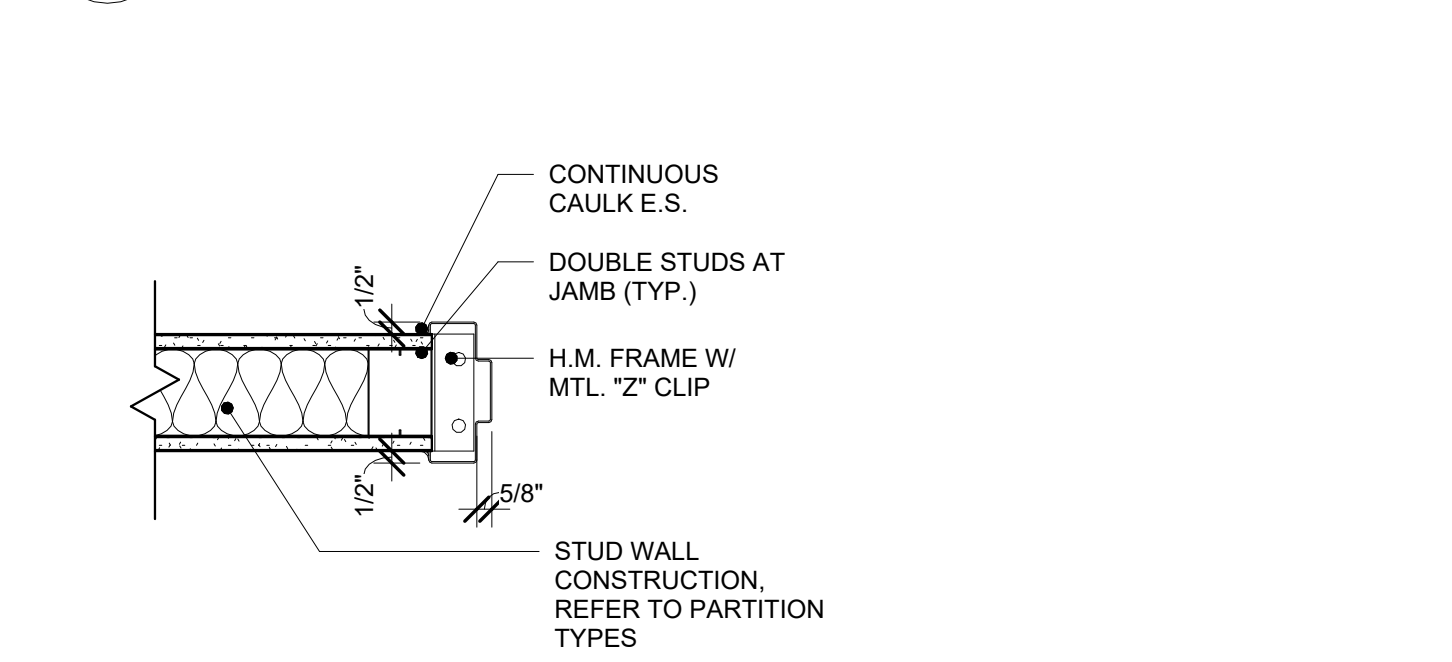

**10 HEAD DETAIL**  
A1.1 1 1/2" = 1'-0"

**11 JAMB DETAIL**  
A1.1 1 1/2" = 1'-0"

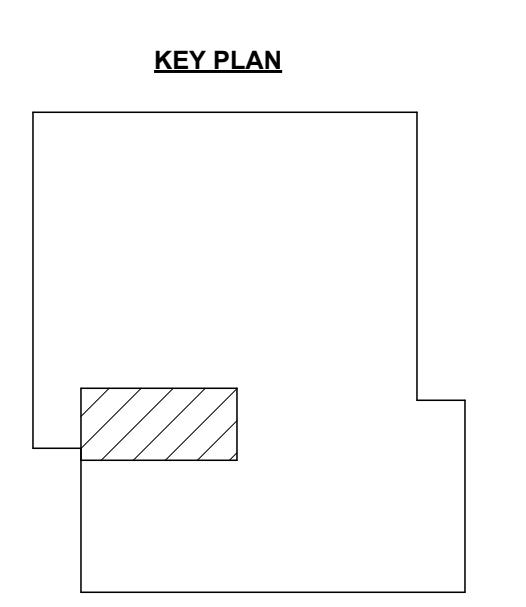

SEAL: \_\_\_\_\_  
CONSULTANT: \_\_\_\_\_

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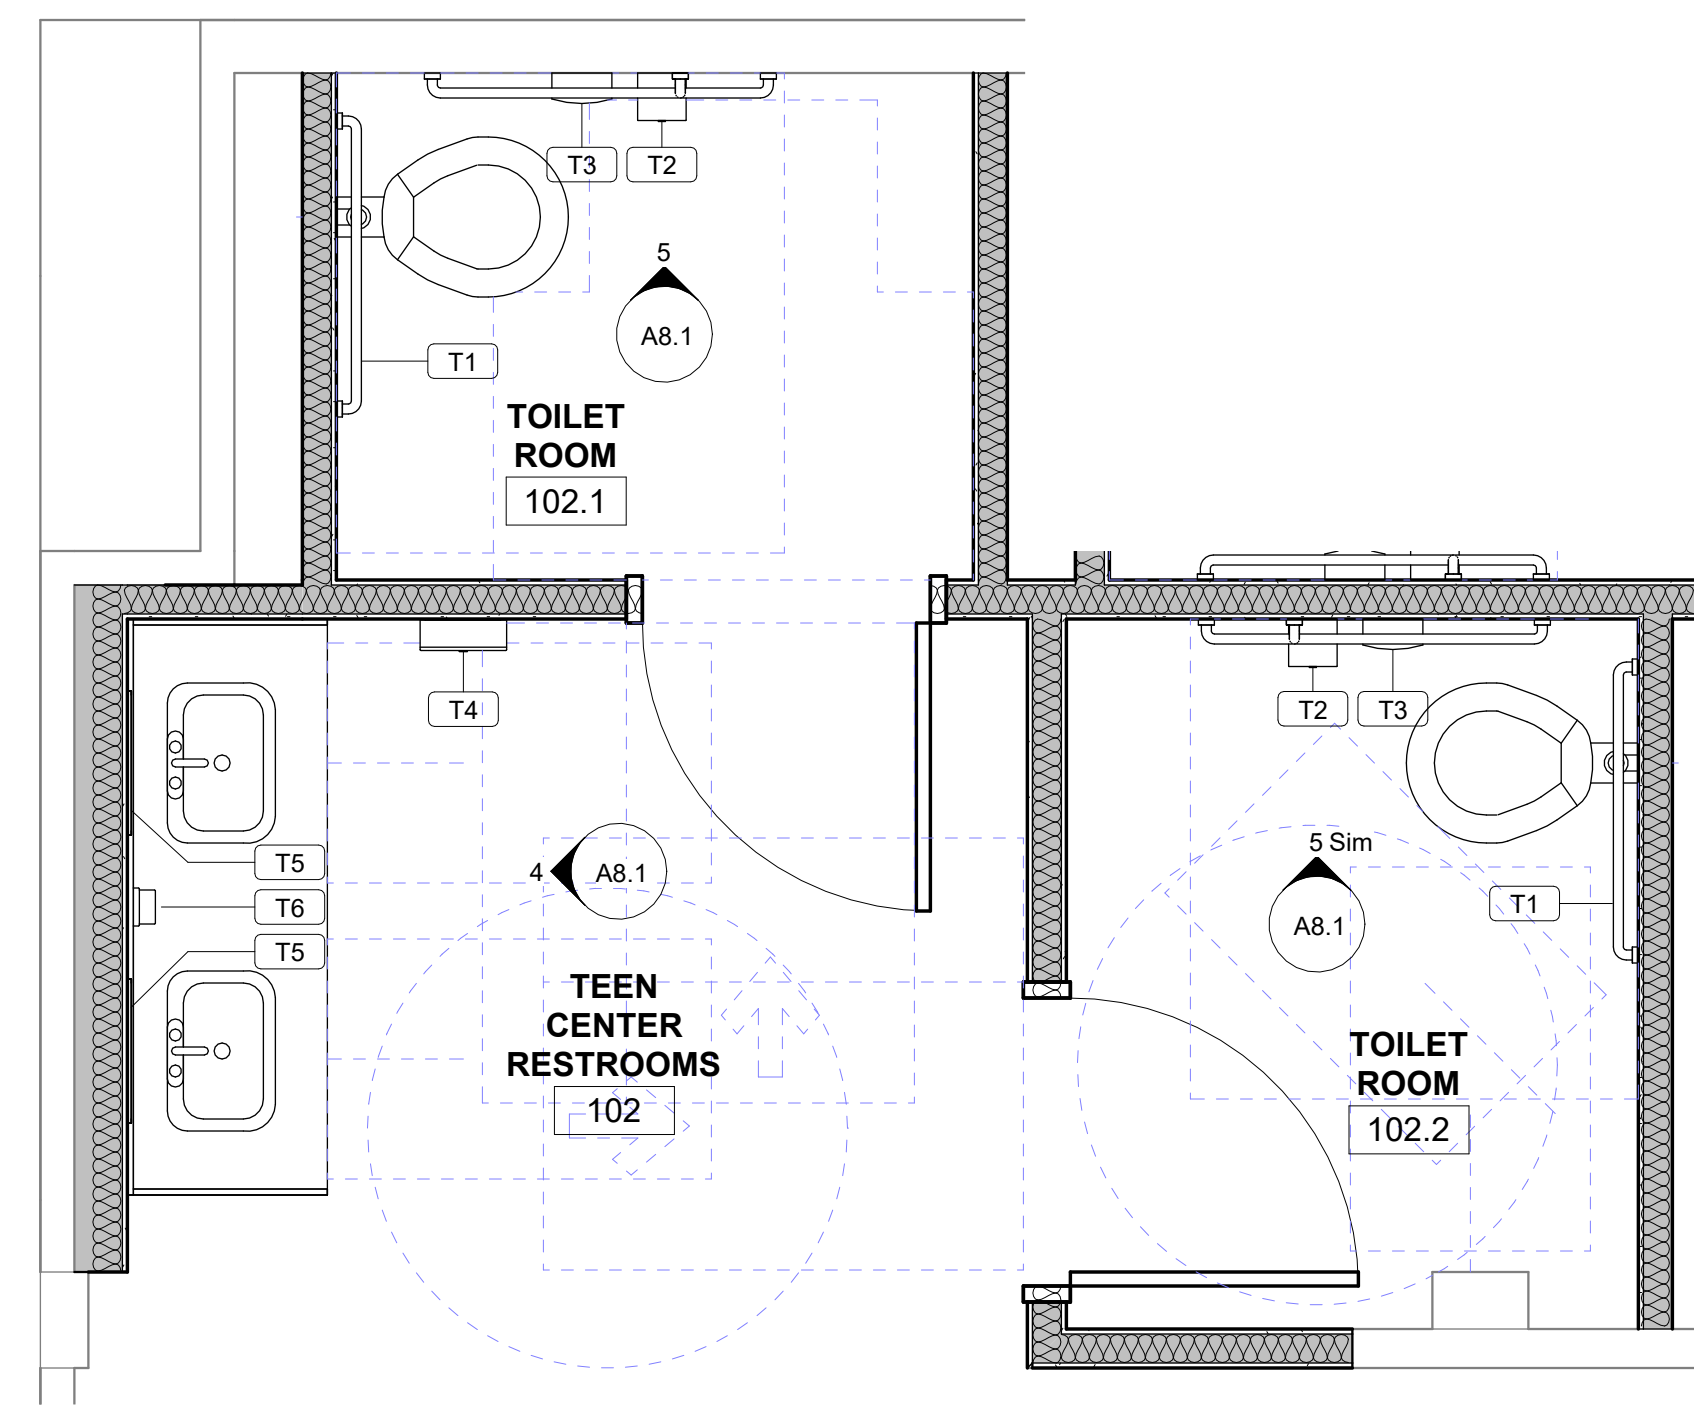


SEAL:  
CONSULTANT:


RENOVATION TO  
HILL CLUBHOUSE  
BOYS & GIRLS CLUB  
116 S WATER ST, LANCASTER, PA 17603

ISSUE DATES  
DATE:  
DESCRIPTION:  
PROJ #: 24-800-01  
DRAWN BY: SAB  
SHEET TITLE:  
ENLARGED PLANS, ACCESSIBILITY DETAILS  
SHEET NUMBER:


Type Mark	Description	Comments
T1	Grab Bar Set - Water Closet	
T2	Surface-Mounted Multi-Roll Toilet Tissue Dispenser	
T3	Surface-Mounted Sanitary Napkin Disposal	
T4	Bobrick B-262 Classic Series Surface Mounted Paper Towel Dispenser	
T5	Bobrick B-165 1836 Channel Frame Mirror	
T6	Surface Mounted Soap Dispenser, Bobrick - B2111	



2 ENLARGED PLAN - TEEN CENTER RESTROOMS  
A8.1 1/2" = 1'-0"

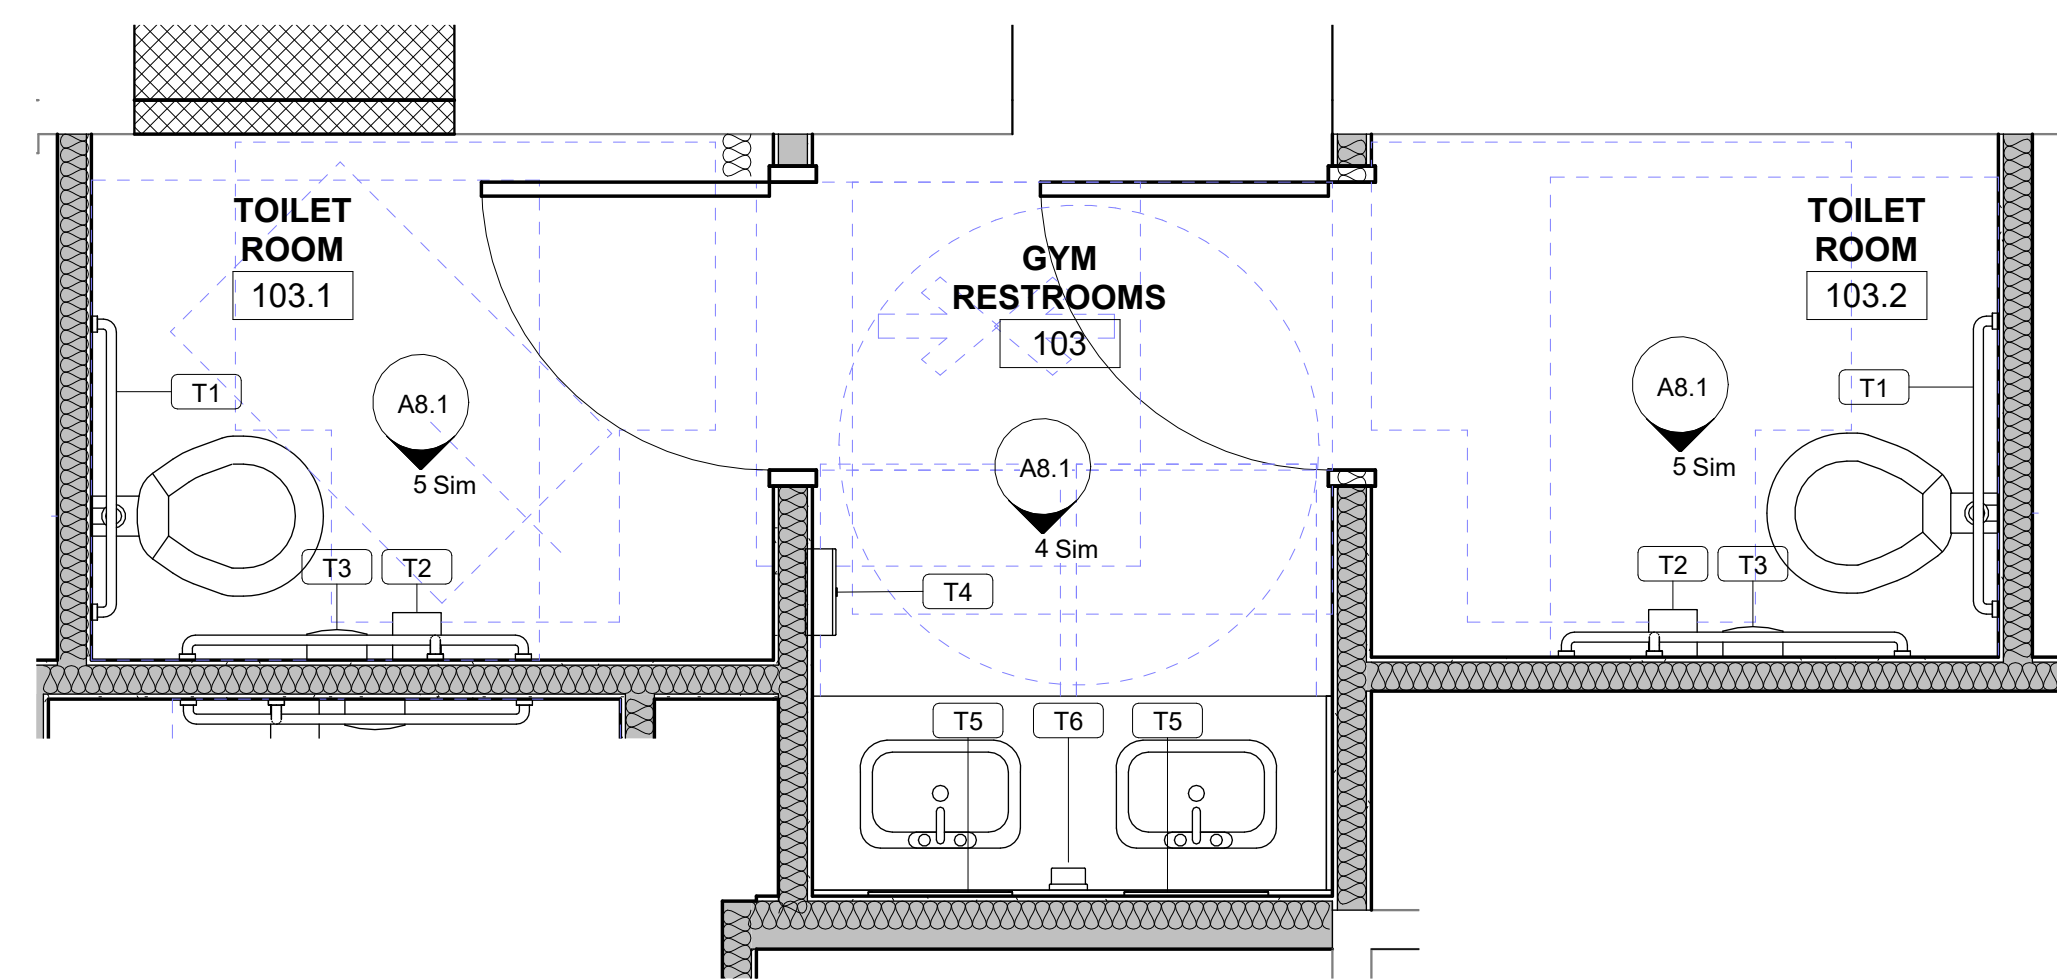


3 ENLARGED PLAN - GYM RESTROOMS  
A8.1 1/2" = 1'-0"

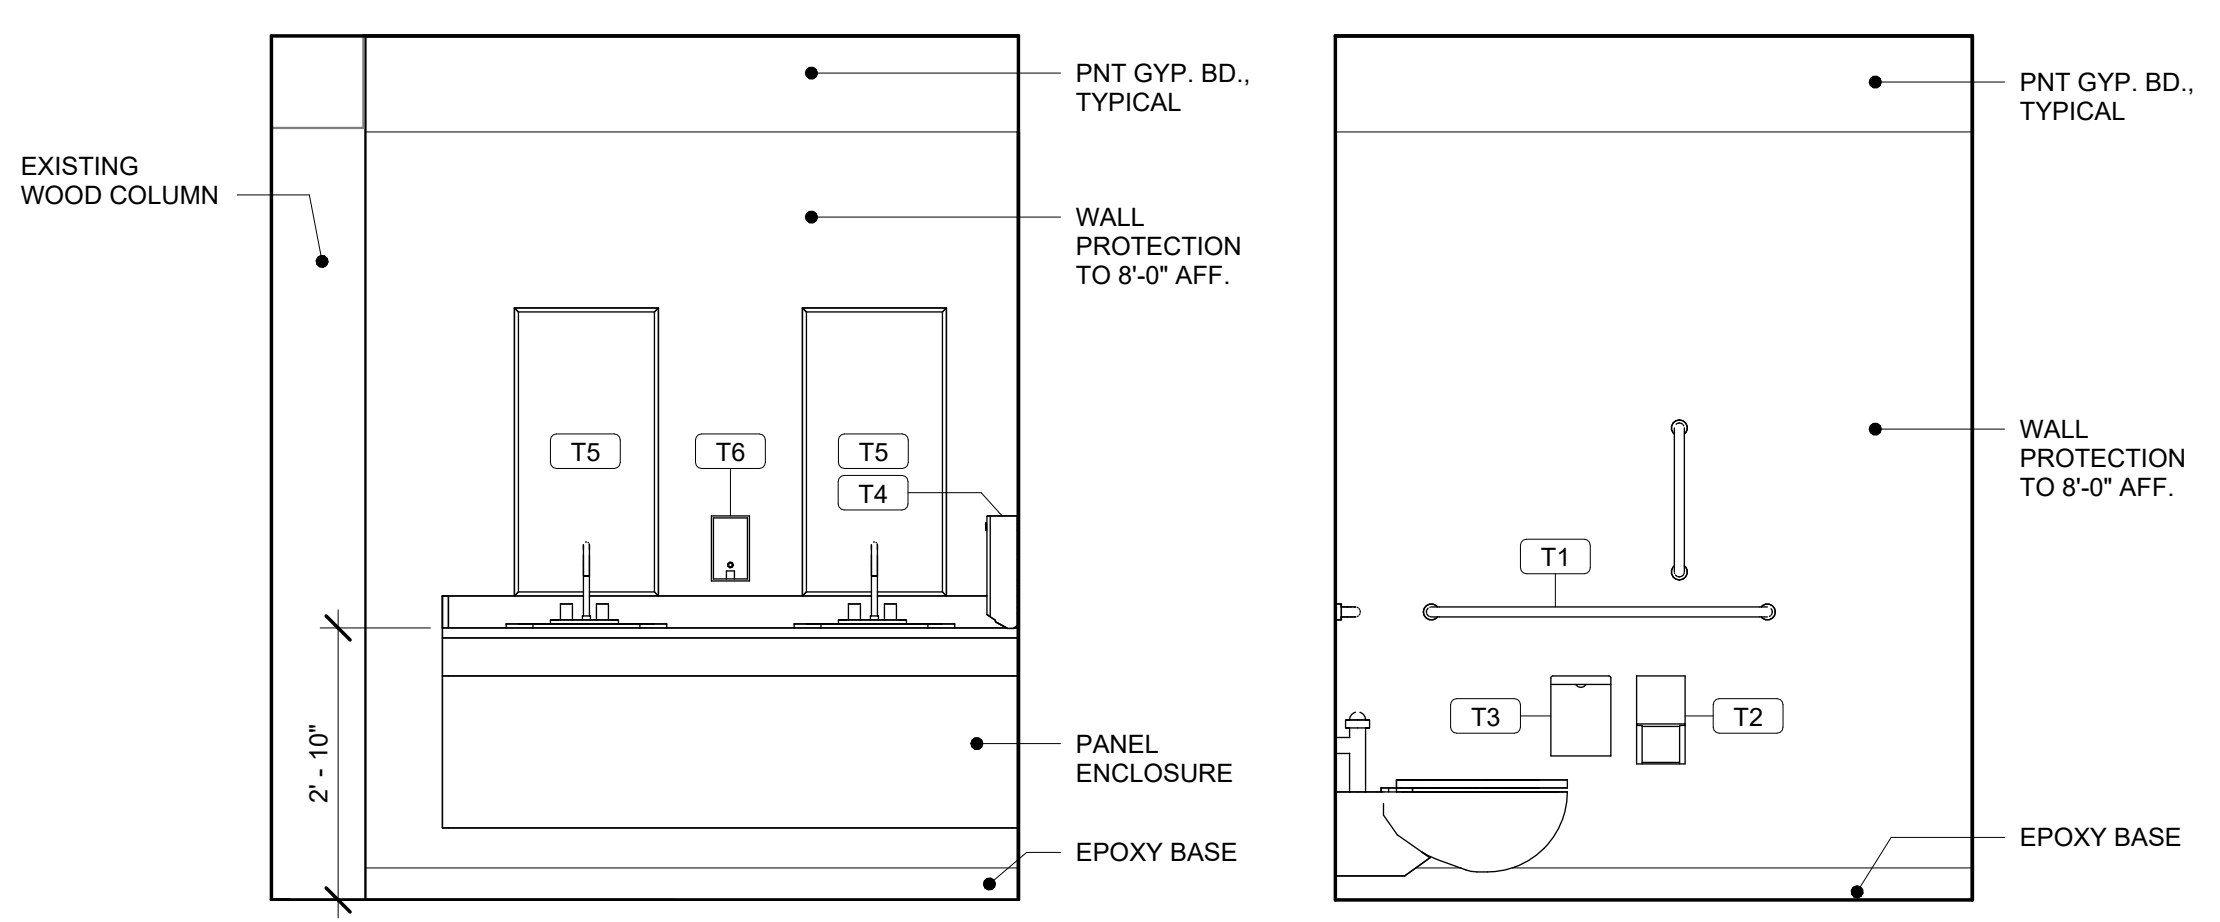


4 INTERIOR ELEVATION  
A8.1 1/2" = 1'-0"

5 INTERIOR ELEVATION  
A8.1 1/2" = 1'-0"

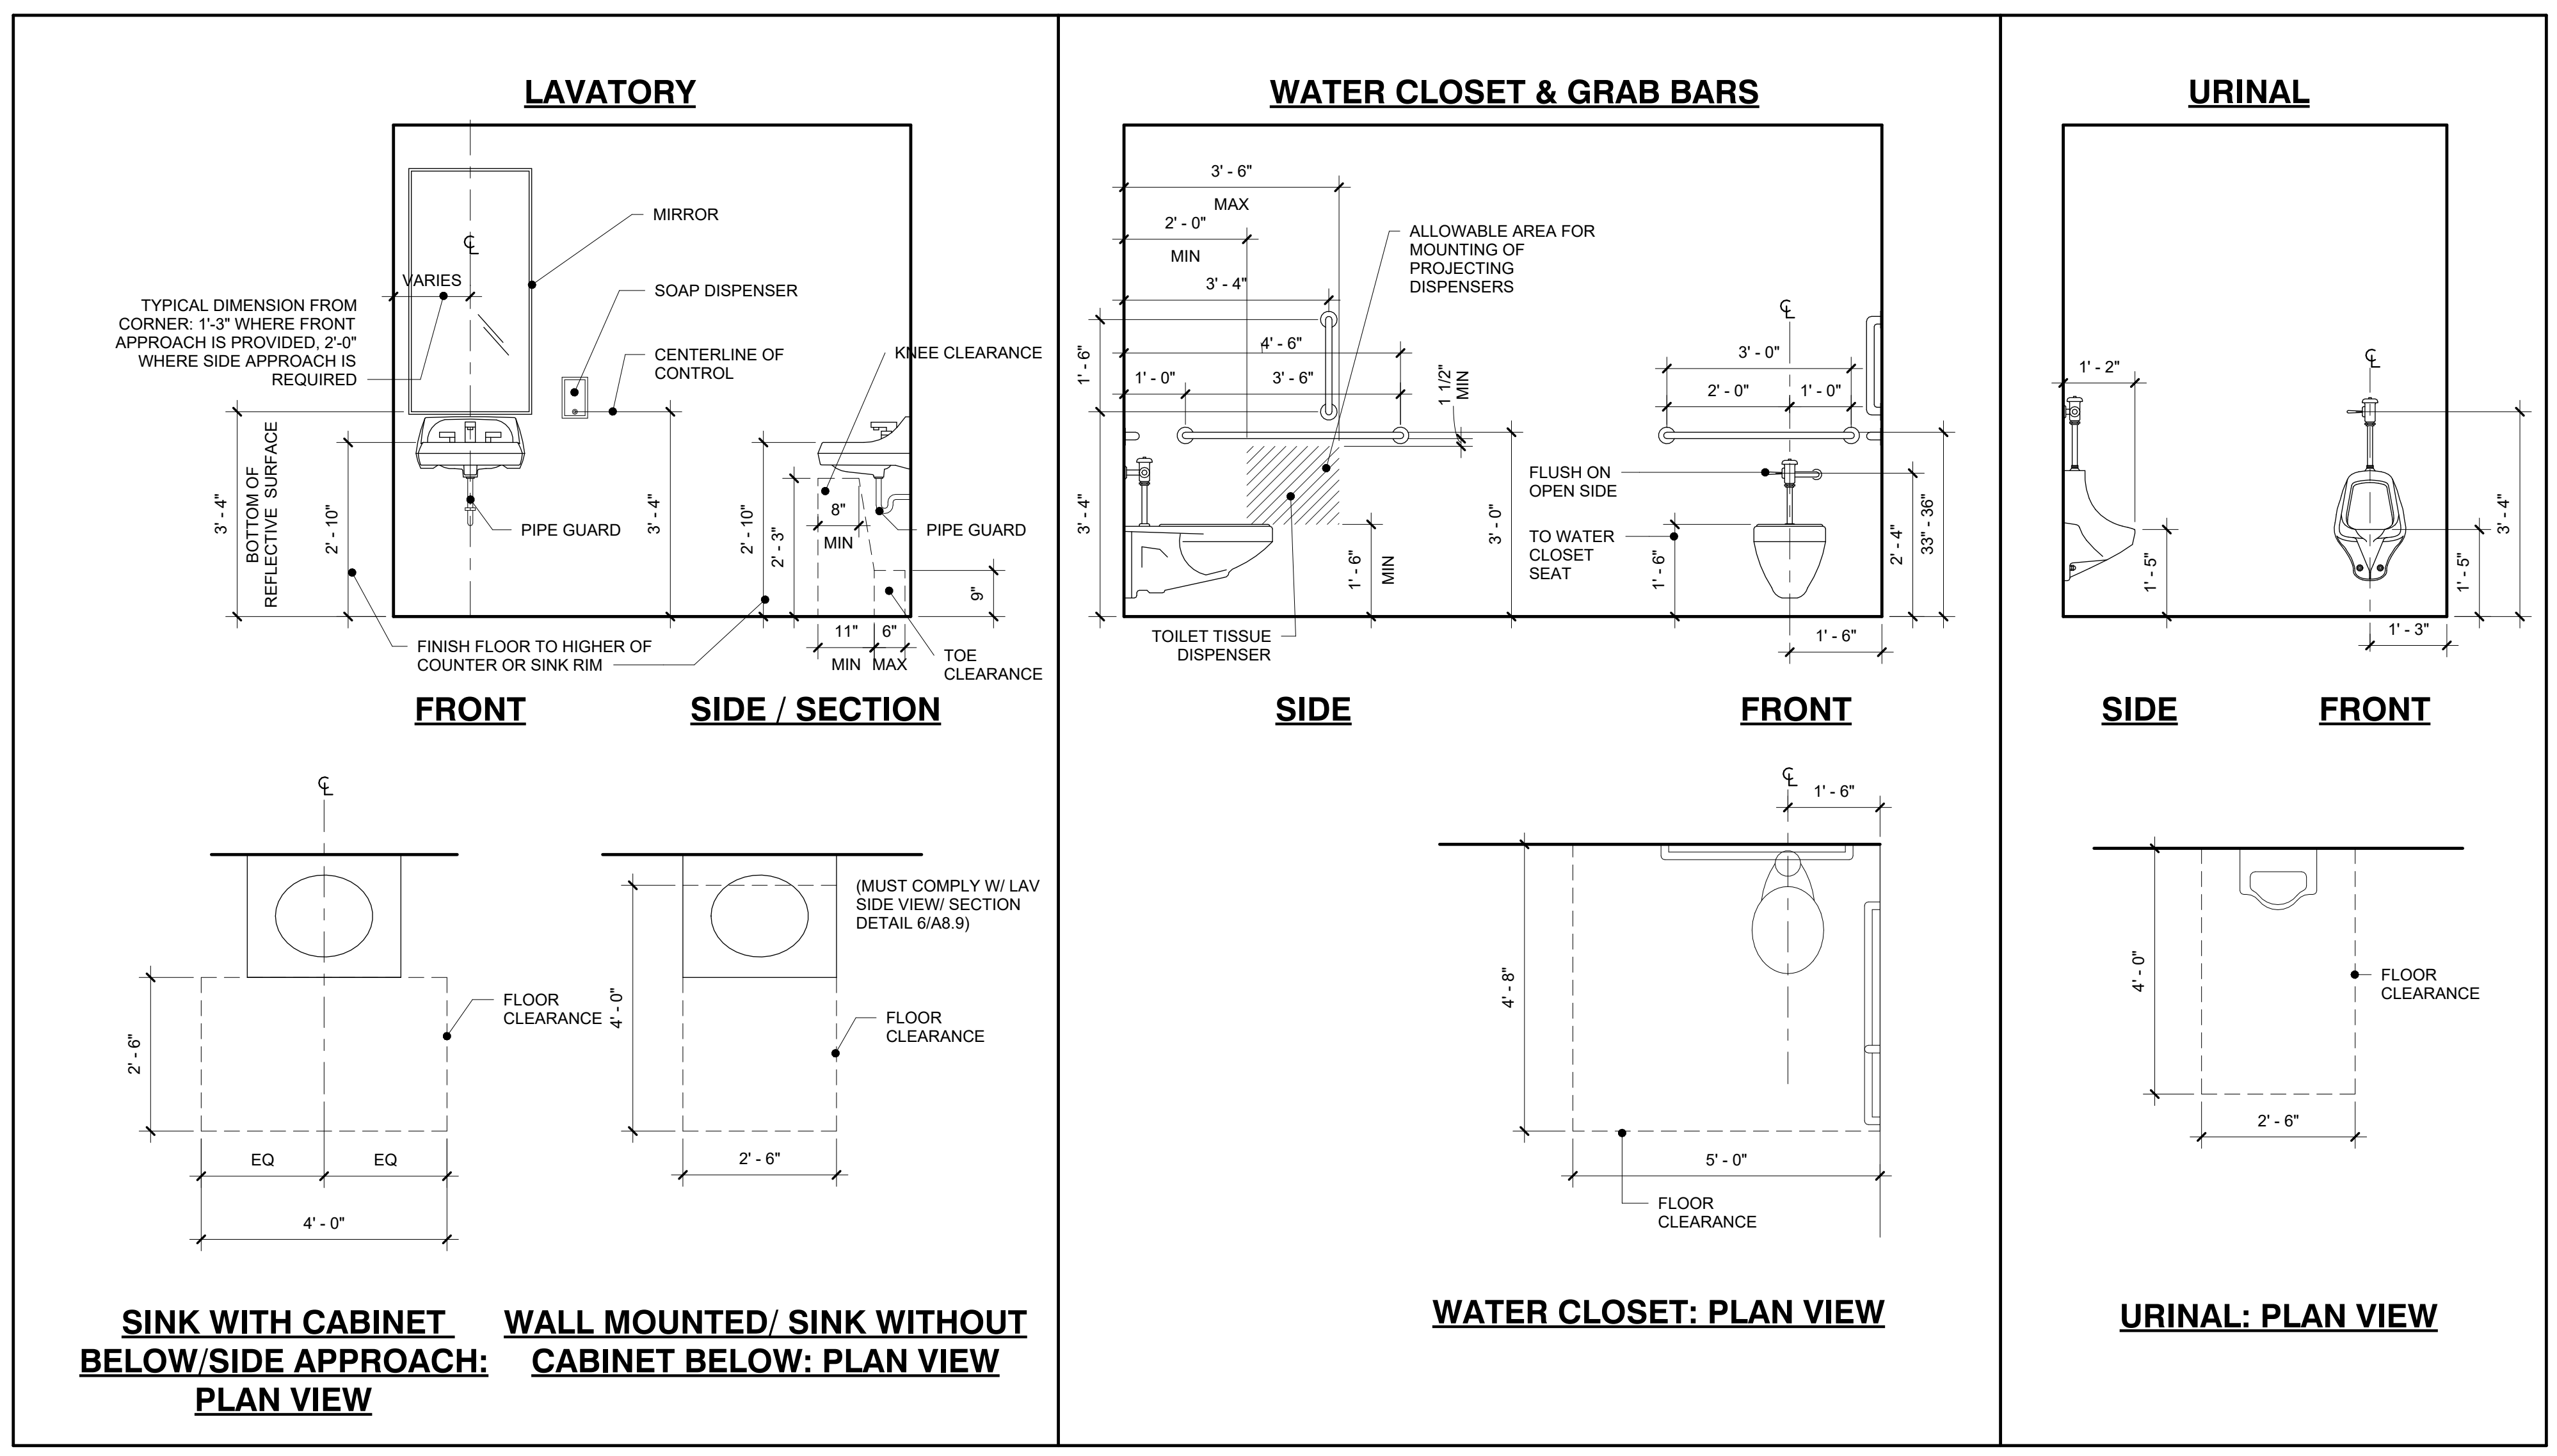

1 ACCESSIBILITY DETAILS - ADULT  
A8.1 1/2" = 1'-0"

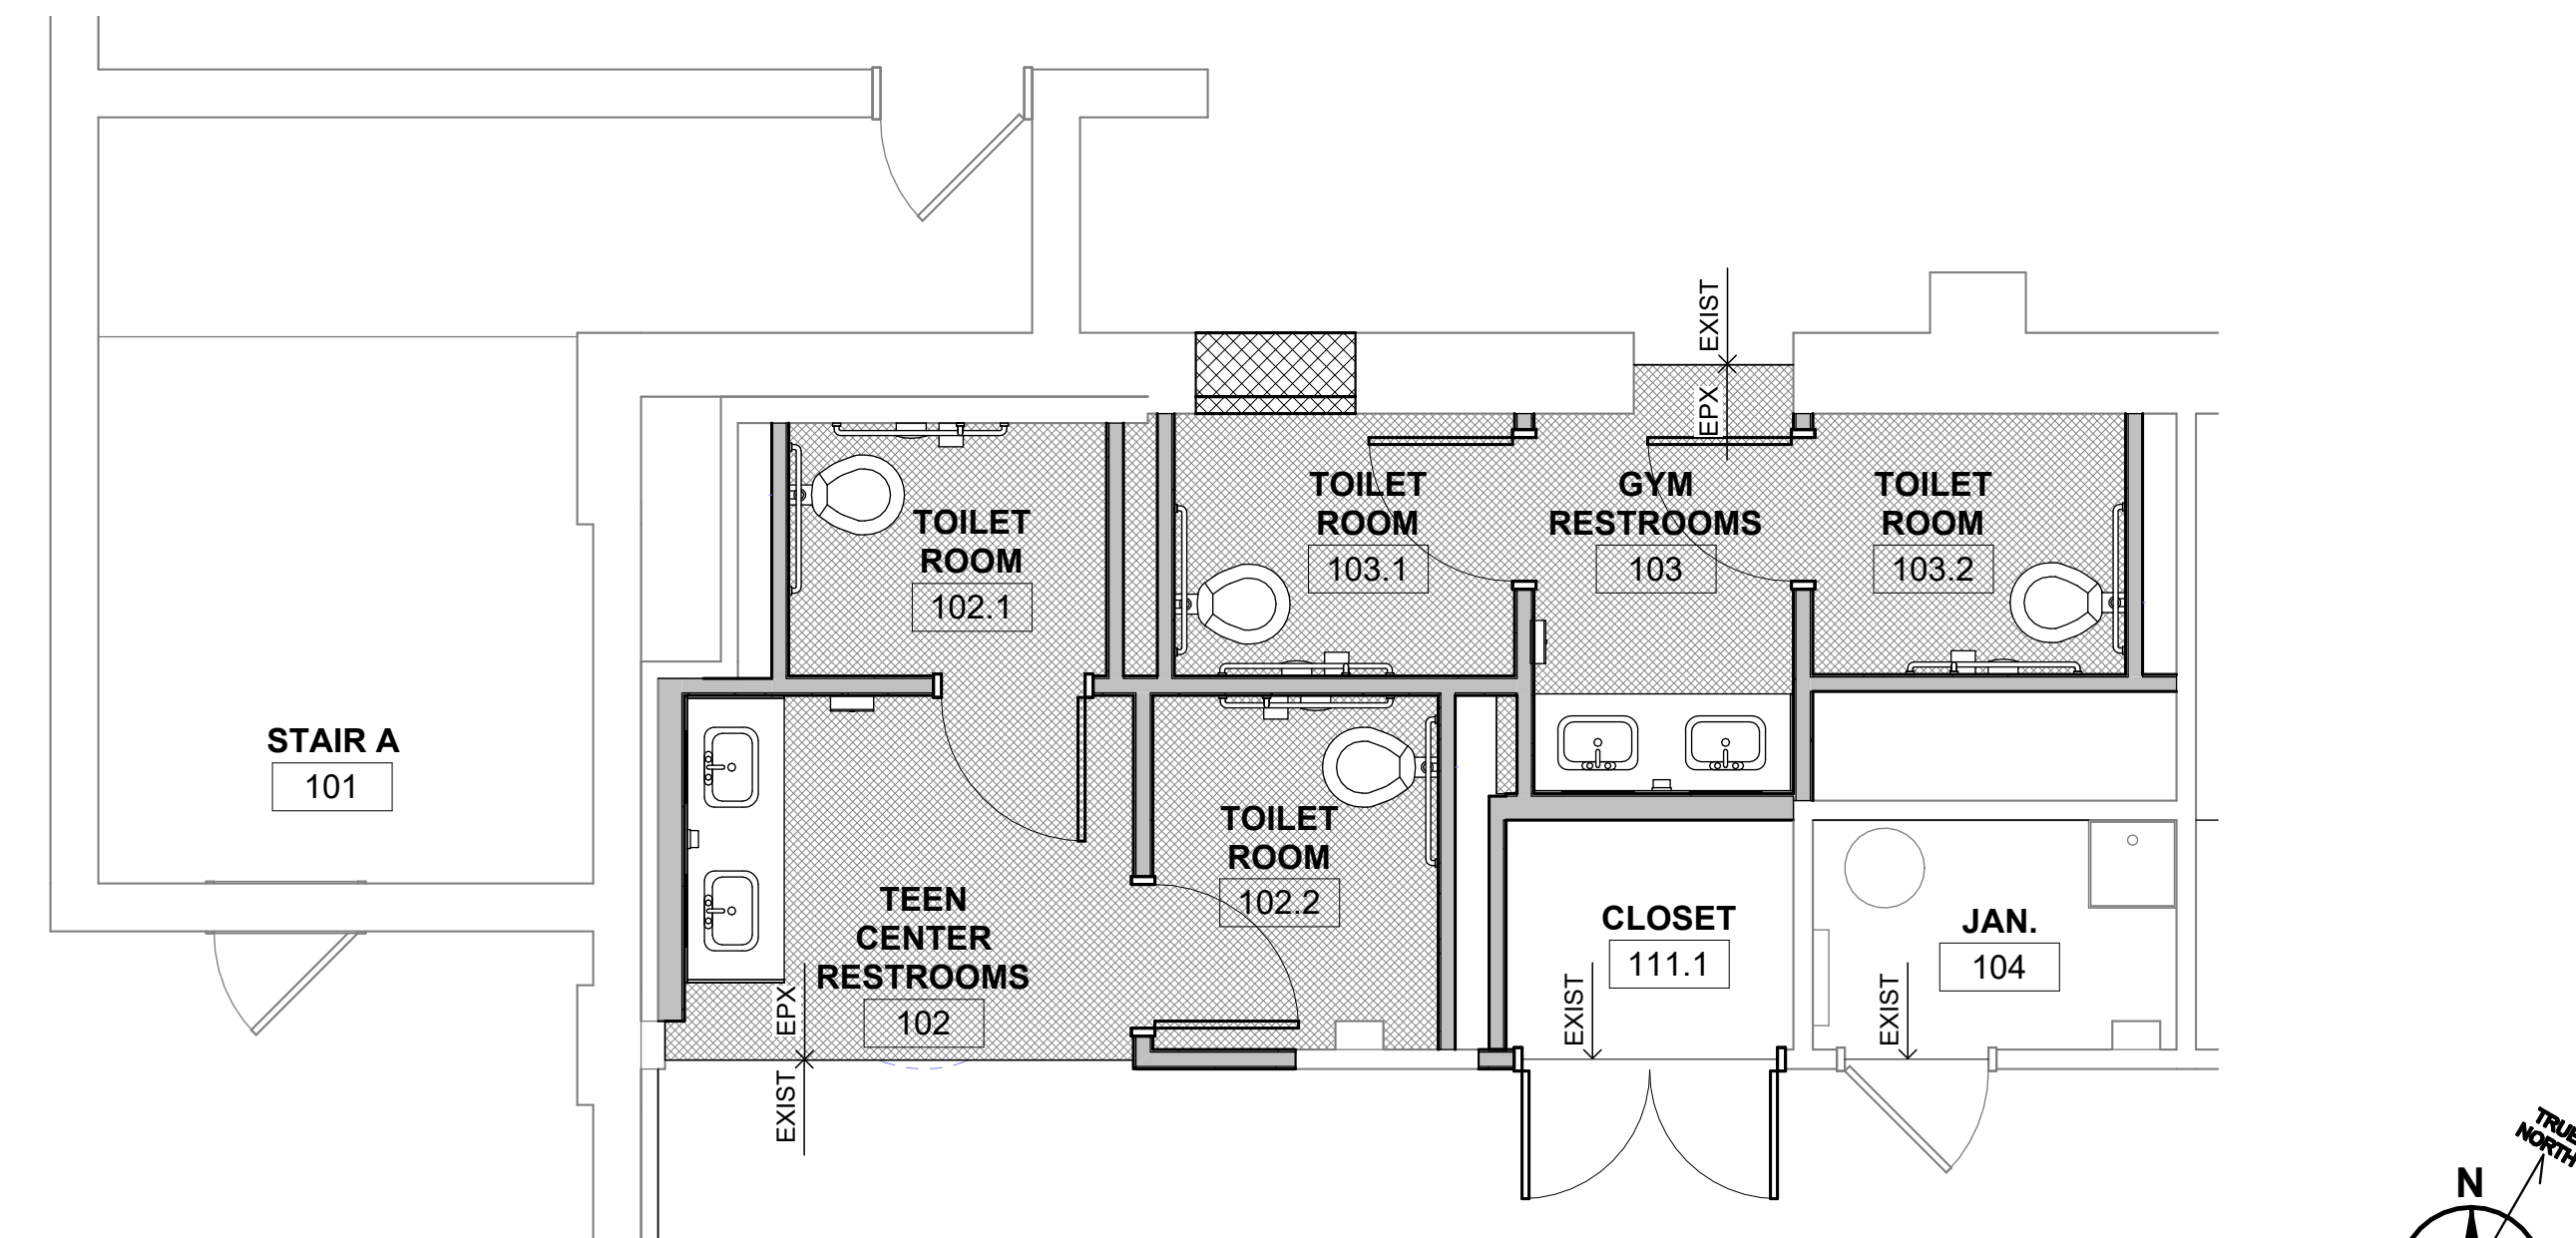

6 FIRST FLOOR - FINISH PLAN  
A8.1 1/4" = 1'-0"

FINISH LEGEND										
<b>FLOOR FINISHES</b>										
EPX	DUREX DYMAFLAKE, COLOR: TBD									
EXIST	EXISTING FLOORING TO REMAIN									
<b>WALL FINISHES</b>										
WP	WALL PROTECTION PANELS, ACROVYN SELECTED FROM MANUFACTURER'S FULL RANGE									
<b>BASE FINISHES</b>										
RB	TARKETT JOHNSONITE 4" RUBBER COVE BASE; COLORS 1-4 TBD									
EPX	EPOXY BASE									
<b>CEILING FINISHES</b>										
ACT	ACOUSTIC CEILING TILE; REFER TO SPECIFICATION FOR PRODUCT TYPES AND SPECIFIC LOCATIONS.									
GWB	NEW DRYWALL CEILING, PAINTED									
<b>PAINT</b>										
PNT-1	COLOR TO MATCH EXISTING WALL PAINT									
PNT-2	SHERWIN WILLIAMS, TRIM PAINT COLOR: TBD									
PNT-3	SHERWIN WILLIAMS, CEILING PAINT COLOR: TBD									

ROOM FINISH SCHEDULE											
NUMBER	NAME	FLOOR FINISH	SUB-FLR	BASE	WALL FINISH				Ceiling Finish	Casework	COMMENTS
					N	E	S	W			
101	STAIR A	---	WOOD	---	---	---	---	---	---	---	NO WORK
102	TEEN CENTER RESTROOMS	EPX	WOOD	EPX	WP/ PNT	WP/ PNT	WP/ PNT	WP/ PNT	ACT	SS-1	
102.1	TOILET ROOM	EPX	WOOD	EPX	WP/ PNT	WP/ PNT	WP/ PNT	WP/ PNT	ACT	---	
102.2	TOILET ROOM	EPX	WOOD	EPX	WP/ PNT	WP/ PNT	WP/ PNT	WP/ PNT	ACT	---	
103	GYM RESTROOMS	EPX	WOOD	EPX	WP/ PNT	WP/ PNT	WP/ PNT	WP/ PNT	ACT	SS-1	
103.1	TOILET ROOM	EPX	WOOD	EPX	WP/ PNT	WP/ PNT	WP/ PNT	WP/ PNT	ACT	---	
103.2	TOILET ROOM	EPX	WOOD	EPX	WP/ PNT	WP/ PNT	WP/ PNT	WP/ PNT	ACT	---	
104	JAN.	---	---	---	---	---	---	---	---	---	NO WORK
111.1	CLOSET	EXIST	WOOD	RB	PNT	PNT	PNT	PNT	GWB	---	

10/1/2024 11:29:08 AM



























# RENOVATIONS TO SE CLUBHOUSE BOYS & GIRLS CLUB

## SYMBOLS

<p><b>SECTION TAG</b> DETAIL NUMBER SHEET NUMBER</p> <p><b>INTERIOR ELEVATION</b> ELEVATION NUMBER SHEET NUMBER</p> <p><b>EXTERIOR ELEVATION</b> ELEVATION NUMBER SHEET NUMBER</p> <p><b>DETAIL TAG</b> A8.8</p> <p><b>PARTITION/BULKHEAD TAG</b> (REFER TO A1.0 FOR TYPES)</p>	<p><b>ROOM TAG</b> OFFICE ROOM NAME ROOM NUMBER B130</p> <p><b>CASEWORK TAG</b> BASIS OF DESIGN MODEL NUMBER (CUSTOM/MODIFIED CABINETS HAVE "M" SUFFIX) CABINET NOMINAL HEIGHT CABINET WIDTH W13</p> <p><b>WINDOW TAG</b> CW13</p> <p><b>CURTAIN WALL TAG</b> AL13</p> <p><b>STOREFRONT TAG</b> IW13</p> <p><b>INTERIOR WINDOW TAG</b> IW13</p>	<p><b>DOOR TAG</b> NEW DOOR</p> <p><b>ROOF TAG</b> EXISTING COL. LINE OCTAGON ITALIC TEXT</p> <p><b>NEW COL. LINE</b> CIRCLE STANDARD TEXT</p>																																																																																																																																																																																																																																																																																																																								
<p><b>HATCH PATTERNS</b></p> <p>METAL STUD, BRICK, CONCRETE, CMU, EARTH, STEEL, RIGID INSULATION, BATT INSUL., ROUGH WOOD, GRAVEL, FINISHED WOOD, PLYWOOD</p>																																																																																																																																																																																																																																																																																																																										
<p><b>ABBREVIATIONS</b> (NOT ALL ABBREVIATIONS APPEAR IN PROJECT)</p> <table border="1"> <tr> <td>AC AIR CONDITIONING</td> <td>EP ELECTRICAL PANEL</td> <td>LLV LONG LEG VERTICAL</td> <td>SF SQUARE FEET/FOOT</td> </tr> <tr> <td>ACM ALUMINUM COMPOSITE MATERIAL</td> <td>EPDM ETHYLENE PROPYLENE DIENE M-CLASS</td> <td>MAX MAXIMUM</td> <td>SHT SHEET</td> </tr> <tr> <td>ACoust ACUSTICAL</td> <td>EQ EQUAL</td> <td>MECH MECHANICAL</td> <td>SIM SIMILAR</td> </tr> <tr> <td>ACT ACUSTIC CEILING TILE</td> <td>EQUIP EQUIPMENT</td> <td>MED MEDIUM</td> <td>SM SHEET METAL</td> </tr> <tr> <td>ADJ ADJACENT</td> <td>ES EACH SIDE</td> <td>MEMBR MEMBRANE</td> <td>SM SURFACE MOUNTED</td> </tr> <tr> <td>AFF ABOVE FINISHED FLOOR</td> <td>ETR EXISTING TO REMAIN</td> <td>MFR MANUFACTURER</td> <td>SPEC SPECIFIED OR SPECIFICATION</td> </tr> <tr> <td>AFG ABOVE FINISHED GRADE</td> <td>EWCC ELECTRIC WATER COOLER</td> <td>MH MAN HOLE</td> <td>SPK SPRINKLER OR SPEAKER</td> </tr> <tr> <td>AGGR AGGREGATE</td> <td>EXH EXHAUST</td> <td>MIN MINIMUM</td> <td>SPKR SPEAKER</td> </tr> <tr> <td>ALT ALTERNATE</td> <td>EXIST EXISTING</td> <td>MISC MISCELLANEOUS</td> <td>SO SQUARE</td> </tr> <tr> <td>ALUM ALUMINUM</td> <td>EXP EXPANSION</td> <td>MO MASONRY OPENING</td> <td>SS STAINLESS STEEL</td> </tr> <tr> <td>ANOD ANODIZED</td> <td>EXT EXTERIOR</td> <td>MR MOISTURE RESISTANT</td> <td>STC SOUND TRANSMISSION COEFFICIENT</td> </tr> <tr> <td>APPROX APPROXIMATE</td> <td>FA FIRE ALARM</td> <td>MTD MOUNTED</td> <td>STL STEEL</td> </tr> <tr> <td>ARCH ARCHITECTURAL</td> <td>FD FLOOR DRAIN</td> <td>MTG MOUNTING</td> <td>STOR STORAGE</td> </tr> <tr> <td>ATTN ATTENTION</td> <td>FDC FIRE DEPARTMENT CONNECTION</td> <td>MTL METAL</td> <td>STRG STRINGER</td> </tr> <tr> <td>AV AUDIOVISUAL</td> <td>FE FIRE EXTINGUISHER</td> <td>MULL MULLION</td> <td>STRUCT STRUCTURE OR STRUCTURAL</td> </tr> <tr> <td>BD BOARD</td> <td>FEQ FIRE EXTINGUISHER CABINET</td> <td>MW MICROWAVE</td> <td>SUSP SUSPENDED</td> </tr> <tr> <td>BIT BITUMINOUS</td> <td>FFE FINISH FLOOR ELEVATION</td> <td>N NORTH</td> <td>SYM SYMMETRICAL</td> </tr> <tr> <td>BLDG BUILDING</td> <td>FIN FINISH</td> <td>NA NOT APPLICABLE</td> <td>SYS SYSTEM</td> </tr> <tr> <td>BLKG BLOCKING</td> <td>FIXT FIXTURE</td> <td>NC NOISE CRITERIA</td> <td>T TREAD</td> </tr> <tr> <td>BM BEAM</td> <td>FLR FLOOR</td> <td>NIC NOT IN CONTRACT</td> <td>T&amp;B TOP AND BOTTOM</td> </tr> <tr> <td>BOF BOTTOM OF</td> <td>FND FOUNDATION</td> <td>NO NUMBER</td> <td>T&amp;G TONGUE AND GROOVE</td> </tr> <tr> <td>BRG BEARING</td> <td>FO FACE OF</td> <td>NOM NOMINAL</td> <td>TELE TELEPHONE</td> </tr> <tr> <td>BSMNT BASEMENT</td> <td>FP FIRE PROTECTION</td> <td>NTS NOT TO SCALE</td> <td>TEMP TEMPORARY</td> </tr> <tr> <td>CB CEMENT BOARD</td> <td>FRG FIBER REINFORCED CONCRETE</td> <td>OD ON CENTER</td> <td>THK THICKNESS</td> </tr> <tr> <td>CBU CEMENTITIOUS BACKER UNIT</td> <td>FRP FIBER REINFORCED PLASTIC</td> <td>OD OUTSIDE DIAMETER</td> <td>TKBD TACK BOARD</td> </tr> <tr> <td>CCTV CLOSED CIRCUIT TELEVISION</td> <td>FRZ FREEZER</td> <td>OD OVERFLOW DRAIN</td> <td>TLT TOILET</td> </tr> <tr> <td>CFS COLD FORMED STEEL</td> <td>FTZ FEET/FOOT</td> <td>OFCI OWNER FURNISHED CONTRACTOR INSTALLED</td> <td>TMPD TEMPERED</td> </tr> <tr> <td>CG CORNER GUARD</td> <td>FTG FOOTING</td> <td>OFF OFFICE</td> <td>TO TOP OF</td> </tr> <tr> <td>CI CAST IRON</td> <td>FURN FURNITURE</td> <td>OFI OWNER FURNISHED, OWNER INSTALLED</td> <td>TOB TOP OF BEAM</td> </tr> <tr> <td>CIP CAST-IN-PLACE</td> <td>FURR FURRING</td> <td>OH OVERHEAD</td> <td>TOC TOP OF CONCRETE</td> </tr> <tr> <td>CJ CONTROL JOINT</td> <td>GA GAUGE</td> <td>OPNG OPENING</td> <td>TOS TOP OF STEEL</td> </tr> <tr> <td>CL CENTERLINE</td> <td>GALV GALVANIZED</td> <td>OPP OPPOSITE</td> <td>TS TUBE STEEL</td> </tr> <tr> <td>CLG CEILING</td> <td>GEN GENERAL</td> <td>ORD OVERFLOW ROOF DRAIN</td> <td>TV TELEVISION</td> </tr> <tr> <td>CLR CLEAR</td> <td>GFRG GLASS FIBER REINFORCED CONCRETE</td> <td>PBD PARTICLE BOARD</td> <td>TYP TYPICAL</td> </tr> <tr> <td>CMU CONCRETE MASONRY UNIT</td> <td>GFRG GLASS FIBER REINFORCED CONCRETE</td> <td>PC PRECAST OR PLUMBING CONTRACT(OR)</td> <td>UNO UNLESS NOTED OTHERWISE</td> </tr> <tr> <td>CO CLEANOUT</td> <td>GFRG GLASS FIBER REINFORCED CONCRETE</td> <td>PERF PERFORATED</td> <td>UNON UNLESS OTHERWISE NOTED</td> </tr> <tr> <td>COL COLUMN</td> <td>GFRG GLASS FIBER REINFORCED CONCRETE</td> <td>PERM PERIMETER</td> <td>VAR VARIES</td> </tr> <tr> <td>CONC CONCRETE</td> <td>GFRG GLASS FIBER REINFORCED CONCRETE</td> <td>PERP PERPENDICULAR</td> <td>VCT VINYL COMPOSITION TILE</td> </tr> <tr> <td>CONST CONSTRUCTION</td> <td>GFRG GLASS FIBER REINFORCED CONCRETE</td> <td>PL PLATE</td> <td>VERT VERTICAL</td> </tr> <tr> <td>CONT CONTINUOUS</td> <td>GFRG GLASS FIBER REINFORCED CONCRETE</td> <td>PLAM PLASTIC LAMINATE</td> <td>VEST VESTIBULE</td> </tr> <tr> <td>COORD COORDINATE</td> <td>GFRG GLASS FIBER REINFORCED CONCRETE</td> <td>PLBG PLUMBING</td> <td>VIF VERIFY IN FIELD</td> </tr> <tr> <td>CORR CORRIDOR</td> <td>GFRG GLASS FIBER REINFORCED CONCRETE</td> <td>PLF POUNDS PER LINEAR FOOT</td> <td>VR VAPOR RETARDER</td> </tr> <tr> <td>CPT CARPET</td> <td>GFRG GLASS FIBER REINFORCED CONCRETE</td> <td>PNL PANEL</td> <td>VT VINYL TILE</td> </tr> <tr> <td>CT CERAMIC TILE</td> <td>GFRG GLASS FIBER REINFORCED CONCRETE</td> <td>PNT PAINT OR PAINTED</td> <td>VWC VINYL WALL COVERING</td> </tr> <tr> <td>CTR CENTER</td> <td>GFRG GLASS FIBER REINFORCED CONCRETE</td> <td>PREFAB PREFABRICATED</td> <td>W WIDE/WEST</td> </tr> <tr> <td>CTSCK COUNTERSUNK</td> <td>GFRG GLASS FIBER REINFORCED CONCRETE</td> <td>PROJ PROJECT</td> <td>WI WITH</td> </tr> <tr> <td>CW COLD WATER</td> <td>GFRG GLASS FIBER REINFORCED CONCRETE</td> <td>PSF POUNDS PER SQUARE FOOT</td> <td>W/O WITHOUT</td> </tr> <tr> <td>D DEEP DEPTH</td> <td>GFRG GLASS FIBER REINFORCED CONCRETE</td> <td>PT PRESSURE TREATED</td> <td>WC WATER CLOSET</td> </tr> <tr> <td>DBL DOUBLE</td> <td>GFRG GLASS FIBER REINFORCED CONCRETE</td> <td>PTD PAINTED</td> <td>WD WOOD</td> </tr> <tr> <td>DEG DEGREE</td> <td>GFRG GLASS FIBER REINFORCED CONCRETE</td> <td>PVC POLYVINYL CHLORIDE</td> <td>WP WATERPROOF/WATERPROOFING</td> </tr> <tr> <td>DEMO DEMOLISH OR DEMOLITION</td> <td>GFRG GLASS FIBER REINFORCED CONCRETE</td> <td>QT QUARRY TILE</td> <td>WPM WATERPROOF MEMBRANE</td> </tr> <tr> <td>DEPT DEPARTMENT</td> <td>GFRG GLASS FIBER REINFORCED CONCRETE</td> <td>QTY QUANTITY</td> <td>WSCT WAINSCOT</td> </tr> <tr> <td>DF DRINKING FOUNTAIN</td> <td>GFRG GLASS FIBER REINFORCED CONCRETE</td> <td>RA RETURN AIR</td> <td>WT WEIGHT</td> </tr> <tr> <td>DIA DIAMETER</td> <td>GFRG GLASS FIBER REINFORCED CONCRETE</td> <td>RB RESILIENT BASE</td> <td>WWF WELDED WIRE FABRIC</td> </tr> <tr> <td>DIFF DIFFUSER</td> <td>GFRG GLASS FIBER REINFORCED CONCRETE</td> <td>RCP REFLECTED CEILING PLAN</td> <td>WWW WELDED WIRE MESH</td> </tr> <tr> <td>DIM DIMENSION</td> <td>GFRG GLASS FIBER REINFORCED CONCRETE</td> <td>RD ROOF DRAIN</td> <td></td> </tr> <tr> <td>DIMS DIMENSIONS</td> <td>GFRG GLASS FIBER REINFORCED CONCRETE</td> <td>RDL ROOF DRAIN LEADER</td> <td></td> </tr> <tr> <td>DIV DIVISION</td> <td>GFRG GLASS FIBER REINFORCED CONCRETE</td> <td>REC RECESSED</td> <td></td> </tr> <tr> <td>DMPF DAMP PROOFING</td> <td>GFRG GLASS FIBER REINFORCED CONCRETE</td> <td>RECPT RECEPTACLE</td> <td></td> </tr> <tr> <td>DN DOWN</td> <td>GFRG GLASS FIBER REINFORCED CONCRETE</td> <td>REF REFERENCE</td> <td></td> </tr> <tr> <td>DO DOOR OPENING</td> <td>GFRG GLASS FIBER REINFORCED CONCRETE</td> <td>REFR REFRIGERATOR</td> <td></td> </tr> <tr> <td>DR DOOR</td> <td>GFRG GLASS FIBER REINFORCED CONCRETE</td> <td>REFR REFRIGERATOR</td> <td></td> </tr> <tr> <td>DRN DRAIN</td> <td>GFRG GLASS FIBER REINFORCED CONCRETE</td> <td>REIN REINFORCED REINFORCING</td> <td></td> </tr> <tr> <td>DS DOWNSPOUT</td> <td>GFRG GLASS FIBER REINFORCED CONCRETE</td> <td>REQ REQUIRE/REQUIRED</td> <td></td> </tr> <tr> <td>DTL DETAIL</td> <td>GFRG GLASS FIBER REINFORCED CONCRETE</td> <td>REV REVISION/REVISED</td> <td></td> </tr> <tr> <td>DW DISHWASHER</td> <td>GFRG GLASS FIBER REINFORCED CONCRETE</td> <td>RM ROOM</td> <td></td> </tr> <tr> <td>DWG DRAWING</td> <td>GFRG GLASS FIBER REINFORCED CONCRETE</td> <td>RO ROUGH OPENING</td> <td></td> </tr> <tr> <td>E EAST</td> <td>GFRG GLASS FIBER REINFORCED CONCRETE</td> <td>RTD RATED</td> <td></td> </tr> <tr> <td>EA EACH</td> <td>GFRG GLASS FIBER REINFORCED CONCRETE</td> <td>RTG RATING</td> <td></td> </tr> <tr> <td>EC ELECTRICAL CONTRACT(OR)</td> <td>GFRG GLASS FIBER REINFORCED CONCRETE</td> <td>RWL RAIN WATER LEADER</td> <td></td> </tr> <tr> <td>EJ EXPANSION JOINT</td> <td>GFRG GLASS FIBER REINFORCED CONCRETE</td> <td>S SOUTH</td> <td></td> </tr> <tr> <td>EJC EXPANSION JOINT COVER</td> <td>GFRG GLASS FIBER REINFORCED CONCRETE</td> <td>SA SUPPLY AIR</td> <td></td> </tr> <tr> <td>EL ELEVATION</td> <td>GFRG GLASS FIBER REINFORCED CONCRETE</td> <td>SC SOLID CORE</td> <td></td> </tr> <tr> <td>ELEC ELECTRICAL</td> <td>GFRG GLASS FIBER REINFORCED CONCRETE</td> <td>SD STORM DRAIN</td> <td></td> </tr> <tr> <td>ELEV ELEVATOR</td> <td>GFRG GLASS FIBER REINFORCED CONCRETE</td> <td>SECT SECTION</td> <td></td> </tr> <tr> <td>EMER EMERGENCY</td> <td>GFRG GLASS FIBER REINFORCED CONCRETE</td> <td></td> <td></td> </tr> <tr> <td>ENCL ENCLOSURE</td> <td>GFRG GLASS FIBER REINFORCED CONCRETE</td> <td></td> <td></td> </tr> <tr> <td>ENG ENGINEER</td> <td>GFRG GLASS FIBER REINFORCED CONCRETE</td> <td></td> <td></td> </tr> </table>			AC AIR CONDITIONING	EP ELECTRICAL PANEL	LLV LONG LEG VERTICAL	SF SQUARE FEET/FOOT	ACM ALUMINUM COMPOSITE MATERIAL	EPDM ETHYLENE PROPYLENE DIENE M-CLASS	MAX MAXIMUM	SHT SHEET	ACoust ACUSTICAL	EQ EQUAL	MECH MECHANICAL	SIM SIMILAR	ACT ACUSTIC CEILING TILE	EQUIP EQUIPMENT	MED MEDIUM	SM SHEET METAL	ADJ ADJACENT	ES EACH SIDE	MEMBR MEMBRANE	SM SURFACE MOUNTED	AFF ABOVE FINISHED FLOOR	ETR EXISTING TO REMAIN	MFR MANUFACTURER	SPEC SPECIFIED OR SPECIFICATION	AFG ABOVE FINISHED GRADE	EWCC ELECTRIC WATER COOLER	MH MAN HOLE	SPK SPRINKLER OR SPEAKER	AGGR AGGREGATE	EXH EXHAUST	MIN MINIMUM	SPKR SPEAKER	ALT ALTERNATE	EXIST EXISTING	MISC MISCELLANEOUS	SO SQUARE	ALUM ALUMINUM	EXP EXPANSION	MO MASONRY OPENING	SS STAINLESS STEEL	ANOD ANODIZED	EXT EXTERIOR	MR MOISTURE RESISTANT	STC SOUND TRANSMISSION COEFFICIENT	APPROX APPROXIMATE	FA FIRE ALARM	MTD MOUNTED	STL STEEL	ARCH ARCHITECTURAL	FD FLOOR DRAIN	MTG MOUNTING	STOR STORAGE	ATTN ATTENTION	FDC FIRE DEPARTMENT CONNECTION	MTL METAL	STRG STRINGER	AV AUDIOVISUAL	FE FIRE EXTINGUISHER	MULL MULLION	STRUCT STRUCTURE OR STRUCTURAL	BD BOARD	FEQ FIRE EXTINGUISHER CABINET	MW MICROWAVE	SUSP SUSPENDED	BIT BITUMINOUS	FFE FINISH FLOOR ELEVATION	N NORTH	SYM SYMMETRICAL	BLDG BUILDING	FIN FINISH	NA NOT APPLICABLE	SYS SYSTEM	BLKG BLOCKING	FIXT FIXTURE	NC NOISE CRITERIA	T TREAD	BM BEAM	FLR FLOOR	NIC NOT IN CONTRACT	T&B TOP AND BOTTOM	BOF BOTTOM OF	FND FOUNDATION	NO NUMBER	T&G TONGUE AND GROOVE	BRG BEARING	FO FACE OF	NOM NOMINAL	TELE TELEPHONE	BSMNT BASEMENT	FP FIRE PROTECTION	NTS NOT TO SCALE	TEMP TEMPORARY	CB CEMENT BOARD	FRG FIBER REINFORCED CONCRETE	OD ON CENTER	THK THICKNESS	CBU CEMENTITIOUS BACKER UNIT	FRP FIBER REINFORCED PLASTIC	OD OUTSIDE DIAMETER	TKBD TACK BOARD	CCTV CLOSED CIRCUIT TELEVISION	FRZ FREEZER	OD OVERFLOW DRAIN	TLT TOILET	CFS COLD FORMED STEEL	FTZ FEET/FOOT	OFCI OWNER FURNISHED CONTRACTOR INSTALLED	TMPD TEMPERED	CG CORNER GUARD	FTG FOOTING	OFF OFFICE	TO TOP OF	CI CAST IRON	FURN FURNITURE	OFI OWNER FURNISHED, OWNER INSTALLED	TOB TOP OF BEAM	CIP CAST-IN-PLACE	FURR FURRING	OH OVERHEAD	TOC TOP OF CONCRETE	CJ CONTROL JOINT	GA GAUGE	OPNG OPENING	TOS TOP OF STEEL	CL CENTERLINE	GALV GALVANIZED	OPP OPPOSITE	TS TUBE STEEL	CLG CEILING	GEN GENERAL	ORD OVERFLOW ROOF DRAIN	TV TELEVISION	CLR CLEAR	GFRG GLASS FIBER REINFORCED CONCRETE	PBD PARTICLE BOARD	TYP TYPICAL	CMU CONCRETE MASONRY UNIT	GFRG GLASS FIBER REINFORCED CONCRETE	PC PRECAST OR PLUMBING CONTRACT(OR)	UNO UNLESS NOTED OTHERWISE	CO CLEANOUT	GFRG GLASS FIBER REINFORCED CONCRETE	PERF PERFORATED	UNON UNLESS OTHERWISE NOTED	COL COLUMN	GFRG GLASS FIBER REINFORCED CONCRETE	PERM PERIMETER	VAR VARIES	CONC CONCRETE	GFRG GLASS FIBER REINFORCED CONCRETE	PERP PERPENDICULAR	VCT VINYL COMPOSITION TILE	CONST CONSTRUCTION	GFRG GLASS FIBER REINFORCED CONCRETE	PL PLATE	VERT VERTICAL	CONT CONTINUOUS	GFRG GLASS FIBER REINFORCED CONCRETE	PLAM PLASTIC LAMINATE	VEST VESTIBULE	COORD COORDINATE	GFRG GLASS FIBER REINFORCED CONCRETE	PLBG PLUMBING	VIF VERIFY IN FIELD	CORR CORRIDOR	GFRG GLASS FIBER REINFORCED CONCRETE	PLF POUNDS PER LINEAR FOOT	VR VAPOR RETARDER	CPT CARPET	GFRG GLASS FIBER REINFORCED CONCRETE	PNL PANEL	VT VINYL TILE	CT CERAMIC TILE	GFRG GLASS FIBER REINFORCED CONCRETE	PNT PAINT OR PAINTED	VWC VINYL WALL COVERING	CTR CENTER	GFRG GLASS FIBER REINFORCED CONCRETE	PREFAB PREFABRICATED	W WIDE/WEST	CTSCK COUNTERSUNK	GFRG GLASS FIBER REINFORCED CONCRETE	PROJ PROJECT	WI WITH	CW COLD WATER	GFRG GLASS FIBER REINFORCED CONCRETE	PSF POUNDS PER SQUARE FOOT	W/O WITHOUT	D DEEP DEPTH	GFRG GLASS FIBER REINFORCED CONCRETE	PT PRESSURE TREATED	WC WATER CLOSET	DBL DOUBLE	GFRG GLASS FIBER REINFORCED CONCRETE	PTD PAINTED	WD WOOD	DEG DEGREE	GFRG GLASS FIBER REINFORCED CONCRETE	PVC POLYVINYL CHLORIDE	WP WATERPROOF/WATERPROOFING	DEMO DEMOLISH OR DEMOLITION	GFRG GLASS FIBER REINFORCED CONCRETE	QT QUARRY TILE	WPM WATERPROOF MEMBRANE	DEPT DEPARTMENT	GFRG GLASS FIBER REINFORCED CONCRETE	QTY QUANTITY	WSCT WAINSCOT	DF DRINKING FOUNTAIN	GFRG GLASS FIBER REINFORCED CONCRETE	RA RETURN AIR	WT WEIGHT	DIA DIAMETER	GFRG GLASS FIBER REINFORCED CONCRETE	RB RESILIENT BASE	WWF WELDED WIRE FABRIC	DIFF DIFFUSER	GFRG GLASS FIBER REINFORCED CONCRETE	RCP REFLECTED CEILING PLAN	WWW WELDED WIRE MESH	DIM DIMENSION	GFRG GLASS FIBER REINFORCED CONCRETE	RD ROOF DRAIN		DIMS DIMENSIONS	GFRG GLASS FIBER REINFORCED CONCRETE	RDL ROOF DRAIN LEADER		DIV DIVISION	GFRG GLASS FIBER REINFORCED CONCRETE	REC RECESSED		DMPF DAMP PROOFING	GFRG GLASS FIBER REINFORCED CONCRETE	RECPT RECEPTACLE		DN DOWN	GFRG GLASS FIBER REINFORCED CONCRETE	REF REFERENCE		DO DOOR OPENING	GFRG GLASS FIBER REINFORCED CONCRETE	REFR REFRIGERATOR		DR DOOR	GFRG GLASS FIBER REINFORCED CONCRETE	REFR REFRIGERATOR		DRN DRAIN	GFRG GLASS FIBER REINFORCED CONCRETE	REIN REINFORCED REINFORCING		DS DOWNSPOUT	GFRG GLASS FIBER REINFORCED CONCRETE	REQ REQUIRE/REQUIRED		DTL DETAIL	GFRG GLASS FIBER REINFORCED CONCRETE	REV REVISION/REVISED		DW DISHWASHER	GFRG GLASS FIBER REINFORCED CONCRETE	RM ROOM		DWG DRAWING	GFRG GLASS FIBER REINFORCED CONCRETE	RO ROUGH OPENING		E EAST	GFRG GLASS FIBER REINFORCED CONCRETE	RTD RATED		EA EACH	GFRG GLASS FIBER REINFORCED CONCRETE	RTG RATING		EC ELECTRICAL CONTRACT(OR)	GFRG GLASS FIBER REINFORCED CONCRETE	RWL RAIN WATER LEADER		EJ EXPANSION JOINT	GFRG GLASS FIBER REINFORCED CONCRETE	S SOUTH		EJC EXPANSION JOINT COVER	GFRG GLASS FIBER REINFORCED CONCRETE	SA SUPPLY AIR		EL ELEVATION	GFRG GLASS FIBER REINFORCED CONCRETE	SC SOLID CORE		ELEC ELECTRICAL	GFRG GLASS FIBER REINFORCED CONCRETE	SD STORM DRAIN		ELEV ELEVATOR	GFRG GLASS FIBER REINFORCED CONCRETE	SECT SECTION		EMER EMERGENCY	GFRG GLASS FIBER REINFORCED CONCRETE			ENCL ENCLOSURE	GFRG GLASS FIBER REINFORCED CONCRETE			ENG ENGINEER	GFRG GLASS FIBER REINFORCED CONCRETE		
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## ARCHITECTURAL

- CS1 COVER SHEET
- AD1.1 FIRST FLOOR DEMOLITION PLAN
- A1.1 FIRST FLOOR PLAN
- A6.1 FIRST FLOOR REFLECTED CEILING PLAN
- A8.1 GROUND FLR INTERIOR PLAN & EQUIP. SCHEDULES

## PLUMBING


- P0.1 PLUMBING NOTES & SCHEDULES
- P1.1 PLUMBING PLANS

## MECHANICAL

- M0.1 HVAC NOTES & SCHEDULES
- M1.1 HVAC PLANS

## ELECTRICAL

- E0.1 ELECTRICAL NOTES & SCHEDULES
- E1.1 ELECTRICAL PLANS

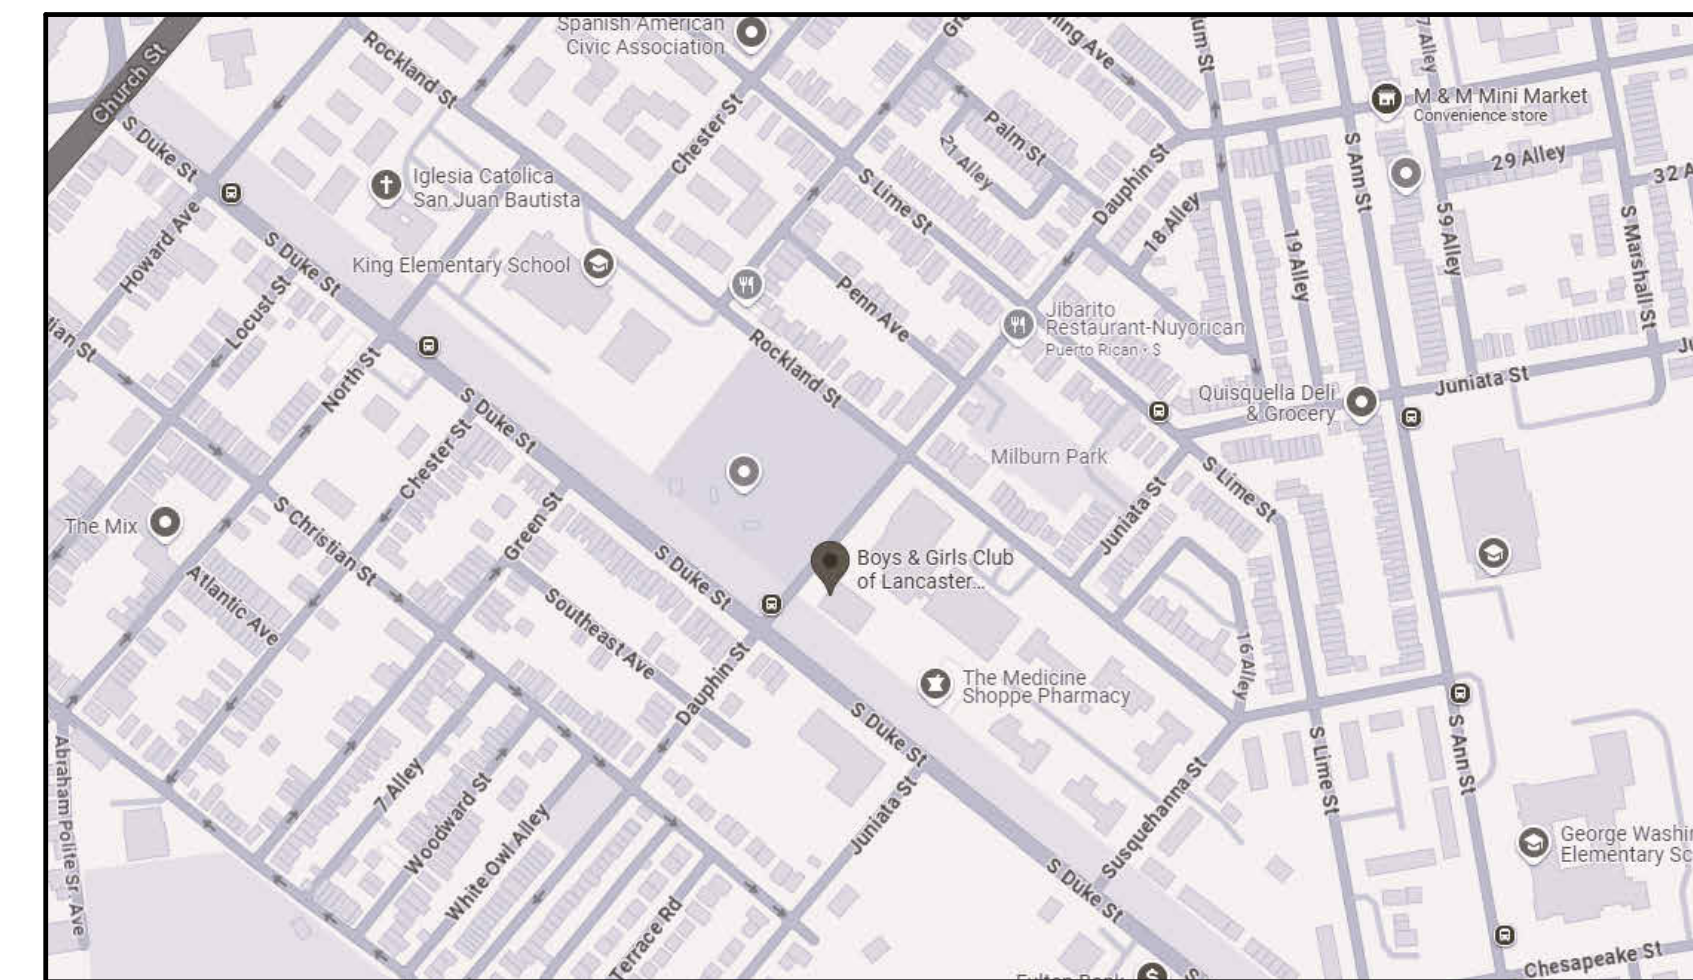

LOCATION MAP

## PROJECT SUMMARY

THE PROPOSED PROJECT IS AT THE EXISTING BOYS & GIRLS CLUB OF LANCASTER - SOUTHEAST CLUBHOUSE LOCATED AT 333 DAUPHIN ST, LANCASTER, PA 17602.

THE PROJECT CONSISTS OF RENOVATION OF THE EXISTING RESTROOMS. THE RENOVATIONS WILL INCLUDE NEW WALLS, DOORS, TOILET FIXTURES AND ACCESSORIES, AND FINISHES. PLUMBING, MECHANICAL AND ELECTRICAL SCOPE WILL ALSO BE INCLUDED.

## BUILDING CODE ANALYSIS:

PENNSYLVANIA UNIFORM CONSTRUCTION CODE (UCC):  
INTERNATIONAL BUILDING CODE - 2018  
INTERNATIONAL EXISTING BUILDING CODE - 2018  
INTERNATIONAL FIRE CODE - 2018  
INTERNATIONAL PLUMBING CODE - 2018  
INTERNATIONAL ENERGY CONSERVATION CODE - 2018  
INTERNATIONAL MECHANICAL CODE - 2018  
ICC A117.1 - 2012 ACCESSIBILITY CODE

## PLUMBING CODE ANALYSIS:

INTERNATIONAL PLUMBING CODE - 2018

403.1.1 FIXTURE CALCULATIONS  
TO DETERMINE THE OCCUPANT LOAD OF EACH SEX, THE TOTAL OCCUPANT LOAD SHALL BE DIVIDED IN HALF. TO DETERMINE THE REQUIRED NUMBER OF FIXTURES, THE FIXTURE RATIO OR RATIOS FOR FIXTURE TYPE SHALL BE APPLIED TO THE OCCUPANT LOAD OF EACH SEX IN ACCORDANCE WITH TABLE 403.1

2018 EXISTING INTERNATIONAL BUILDING CODE 810.1 MINIMUM FIXTURES:  
WHERE THE OCCUPANT LOAD OF THE STORY IS INCREASED BY 20 PERCENT, PLUMBING FIXTURES FOR THE STORY SHALL BE PROVIDED IN QUANTITIES SPECIFIED IN THE INTERNATIONAL PLUMBING CODE BASED ON THE INCREASED OCCUPANT LOAD.

BUILDING REQUIREMENTS  
EXISTING OCCUPANCY NO CHANGE  
REQUIRED PLUMBING FIXTURES  
WC MEN: 1  
WC WOMEN: 2  
LAVS MEN: 1  
LAVS WOMEN: 1  
PROPOSED PLUMBING FIXTURES  
WC MEN: 2  
WC WOMEN: 2  
LAVS: 3

RENOVATIONS TO  
SE CLUBHOUSE

BOYS & GIRLS CLUB  
333 DAUPHIN ST, LANCASTER, PA 17602

ISSUE DATES  
DATE: 10/01/2024  
DESCRIPTION: BID DOCUMENTS

PROJ #: 24-800-01  
SHEET TITLE: COVER SHEET

COVER SHEET

SHEET NUMBER:

CS1


BID

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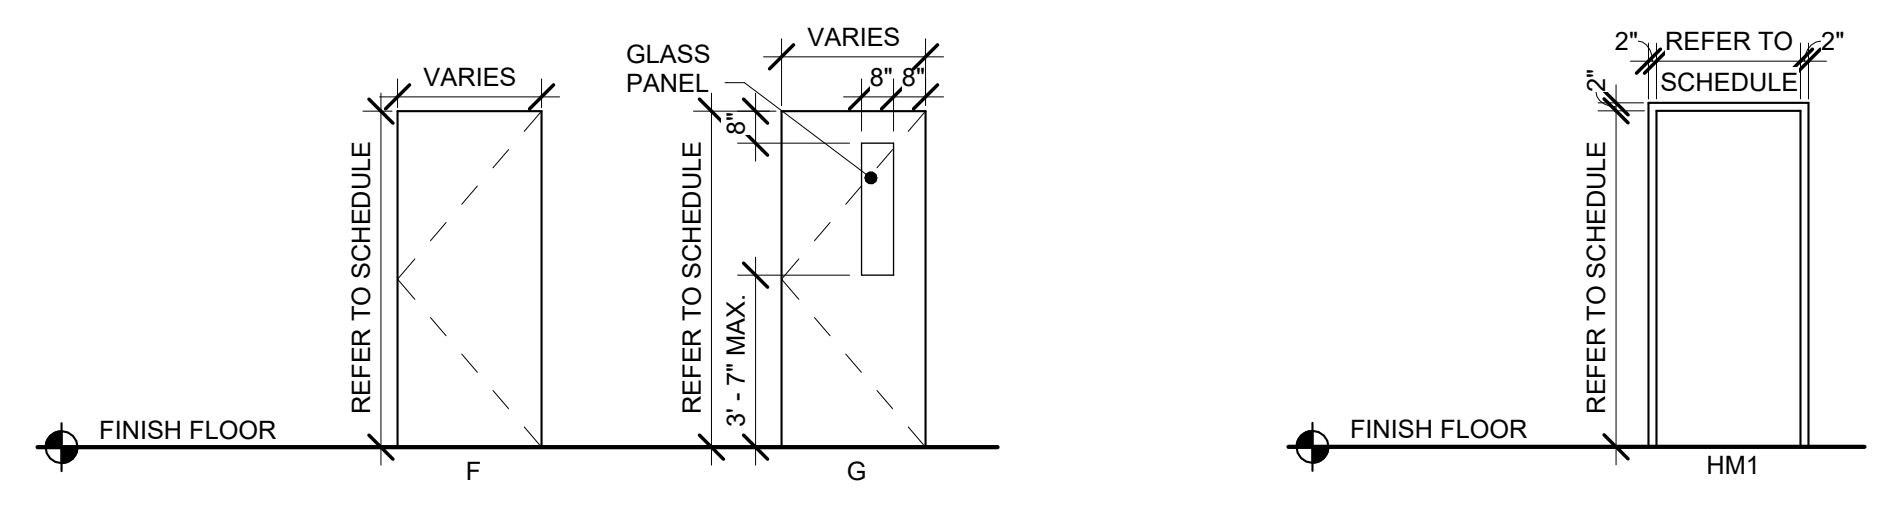


**5 FIRST FLOOR - RENOVATION PLAN**  
A1.1 1/4" = 1'-0"

DOOR NUMBER	Width	HEIGHT	DOOR		FIRE RATING	FRAME				COMMENTS
			DOOR TYPE	DOOR MATERIAL		FRAME TYPE	FRAME MATERIAL	HEAD	JAMB	
107	3'-0"	7'-0"	G	WD	-	HM1	HM	8/A1.1	9/A1.1	
108	3'-0"	7'-0"	F	HM	-	HM1	HM	8/A1.1	9/A1.1	
109	3'-0"	7'-0"	F	HM	-	HM1	HM	8/A1.1	9/A1.1	
110	2'-8"	7'-0"	F	HM	-	HM1	HM	8/A1.1	9/A1.1	
111	2'-8"	7'-0"	F	HM	-	HM1	HM	8/A1.1	9/A1.1	


**PARTITION TYPE SCHEDULE & NOTES**

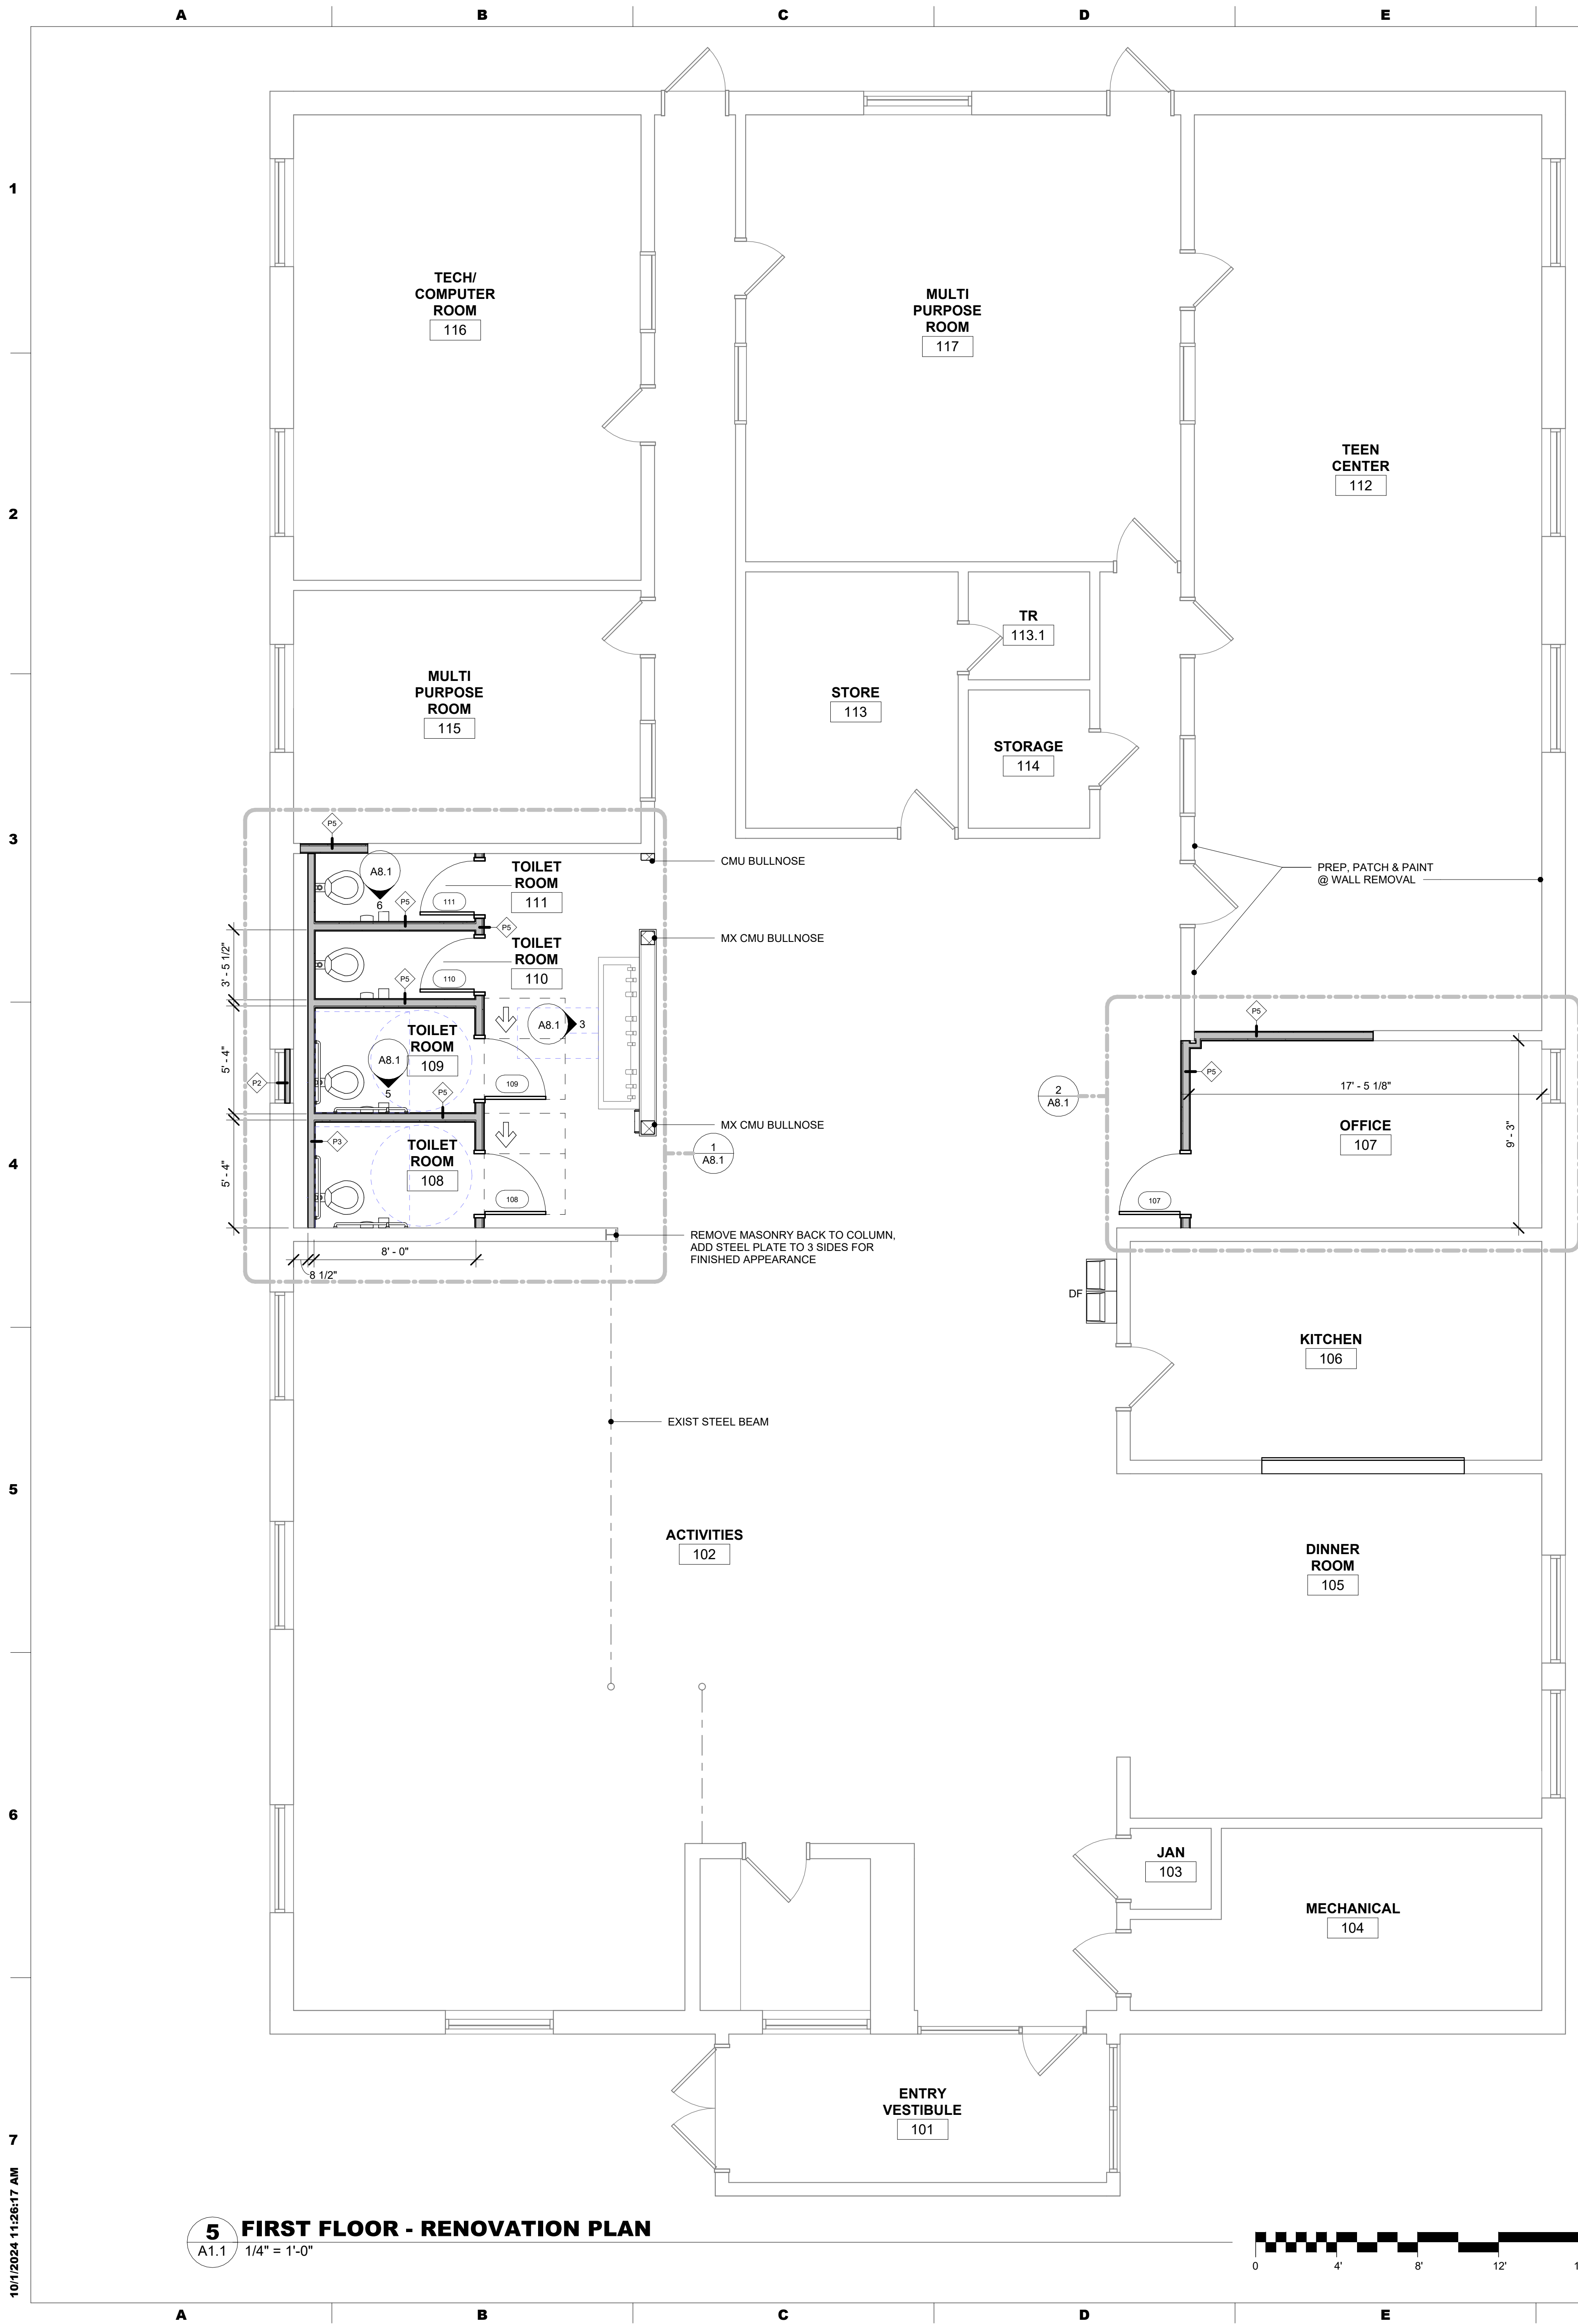- INTERIOR PARTITIONS**
- STUD PARTITIONS**
- P2: APPLY BLACK FILM TO INSIDE OF ALUM. WINDOW GLASS, INSTALL RIGID INSULATION IN OPENING
  - P3: 3/8" MTL. STUDS W/ ONE LAYER OF 5/8" GWB ON ONE SIDE, FILL W/ ACOUS. BATT INSUL. NOTE: (2) BACK-TO-BACK P3 WALLS: STC-50
  - P5: 3/8" MTL. STUDS W/ (1) LAYER 5/8" GWB, FILL W/ ACOUS. BATT INSUL. (2) LAYERS 5/8" GWB. STC-50
  - MX: MASONRY INFILL TO MATCH EXISTING WALL UNLESS NOTED OTHERWISE




**6 DOOR TYPES**  
A1.1 1/4" = 1'-0"


**7 HOLLOW METAL FRAME TYPES**  
A1.1 1/4" = 1'-0"

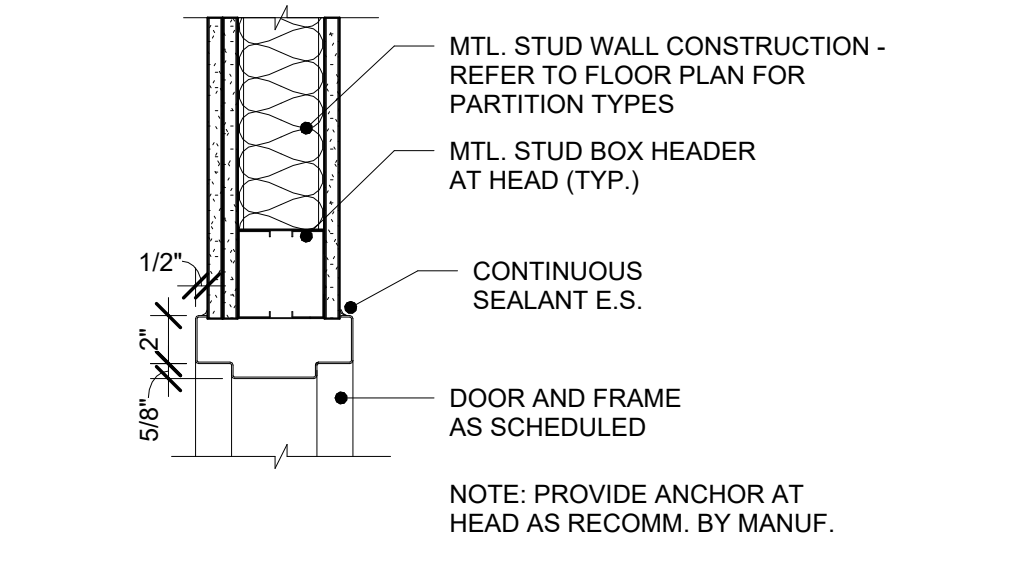


**8 HEAD DETAIL**  
A1.1 1 1/2" = 1'-0"

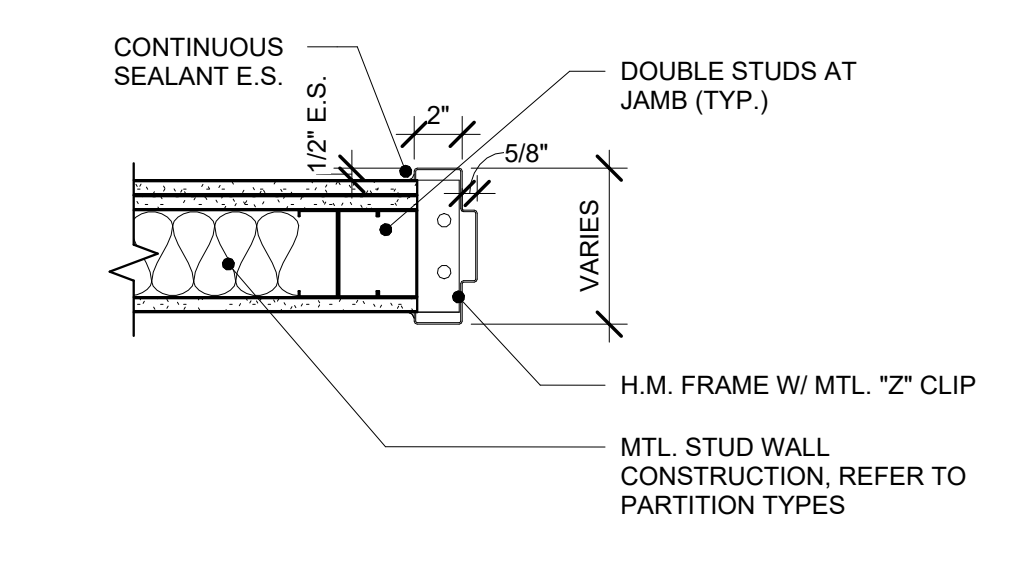

**9 JAMB DETAIL**  
A1.1 1 1/2" = 1'-0"

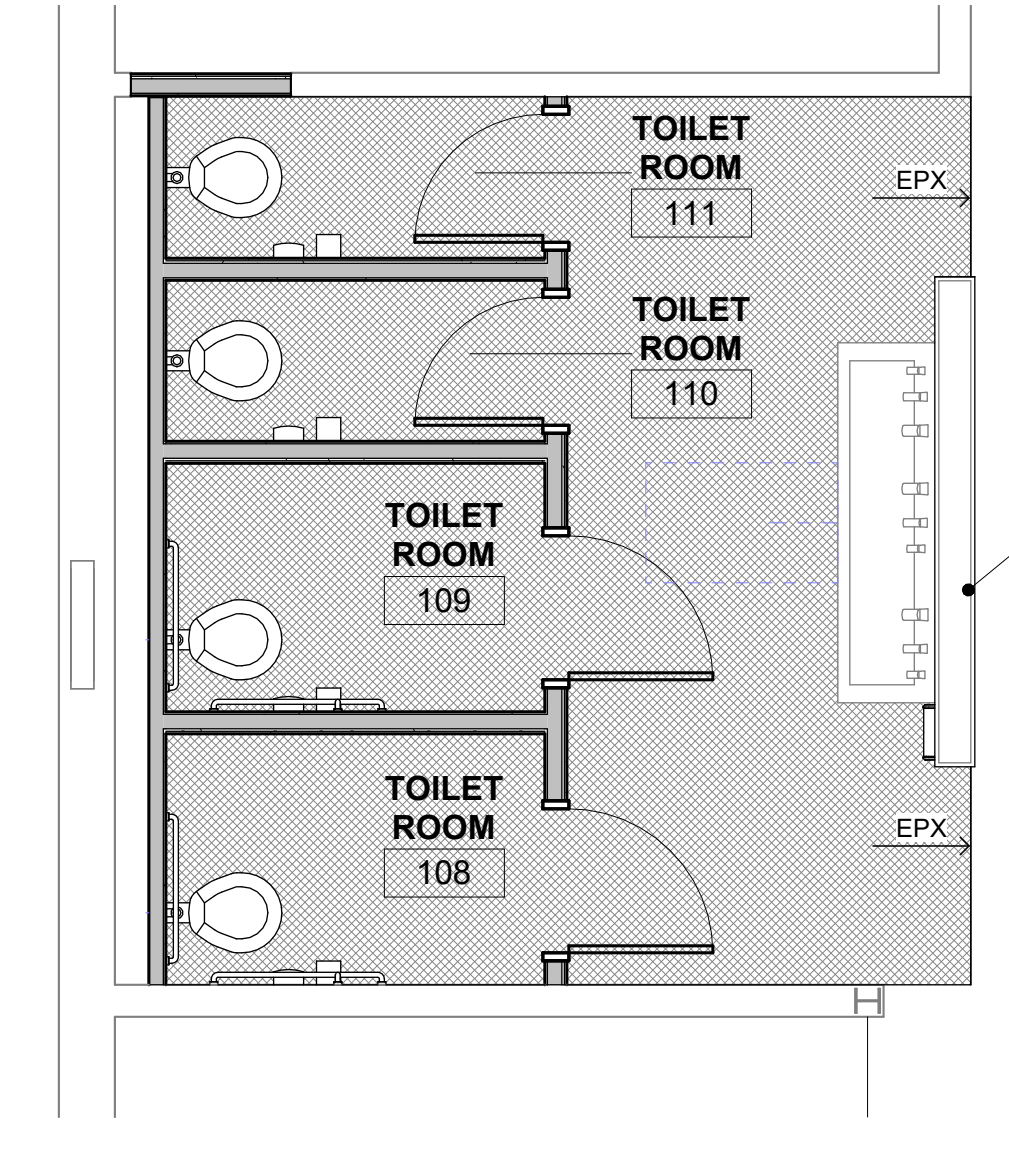

**10 FIRST FLOOR - PARTIAL FINISH PLAN**  
A1.1 1/4" = 1'-0"

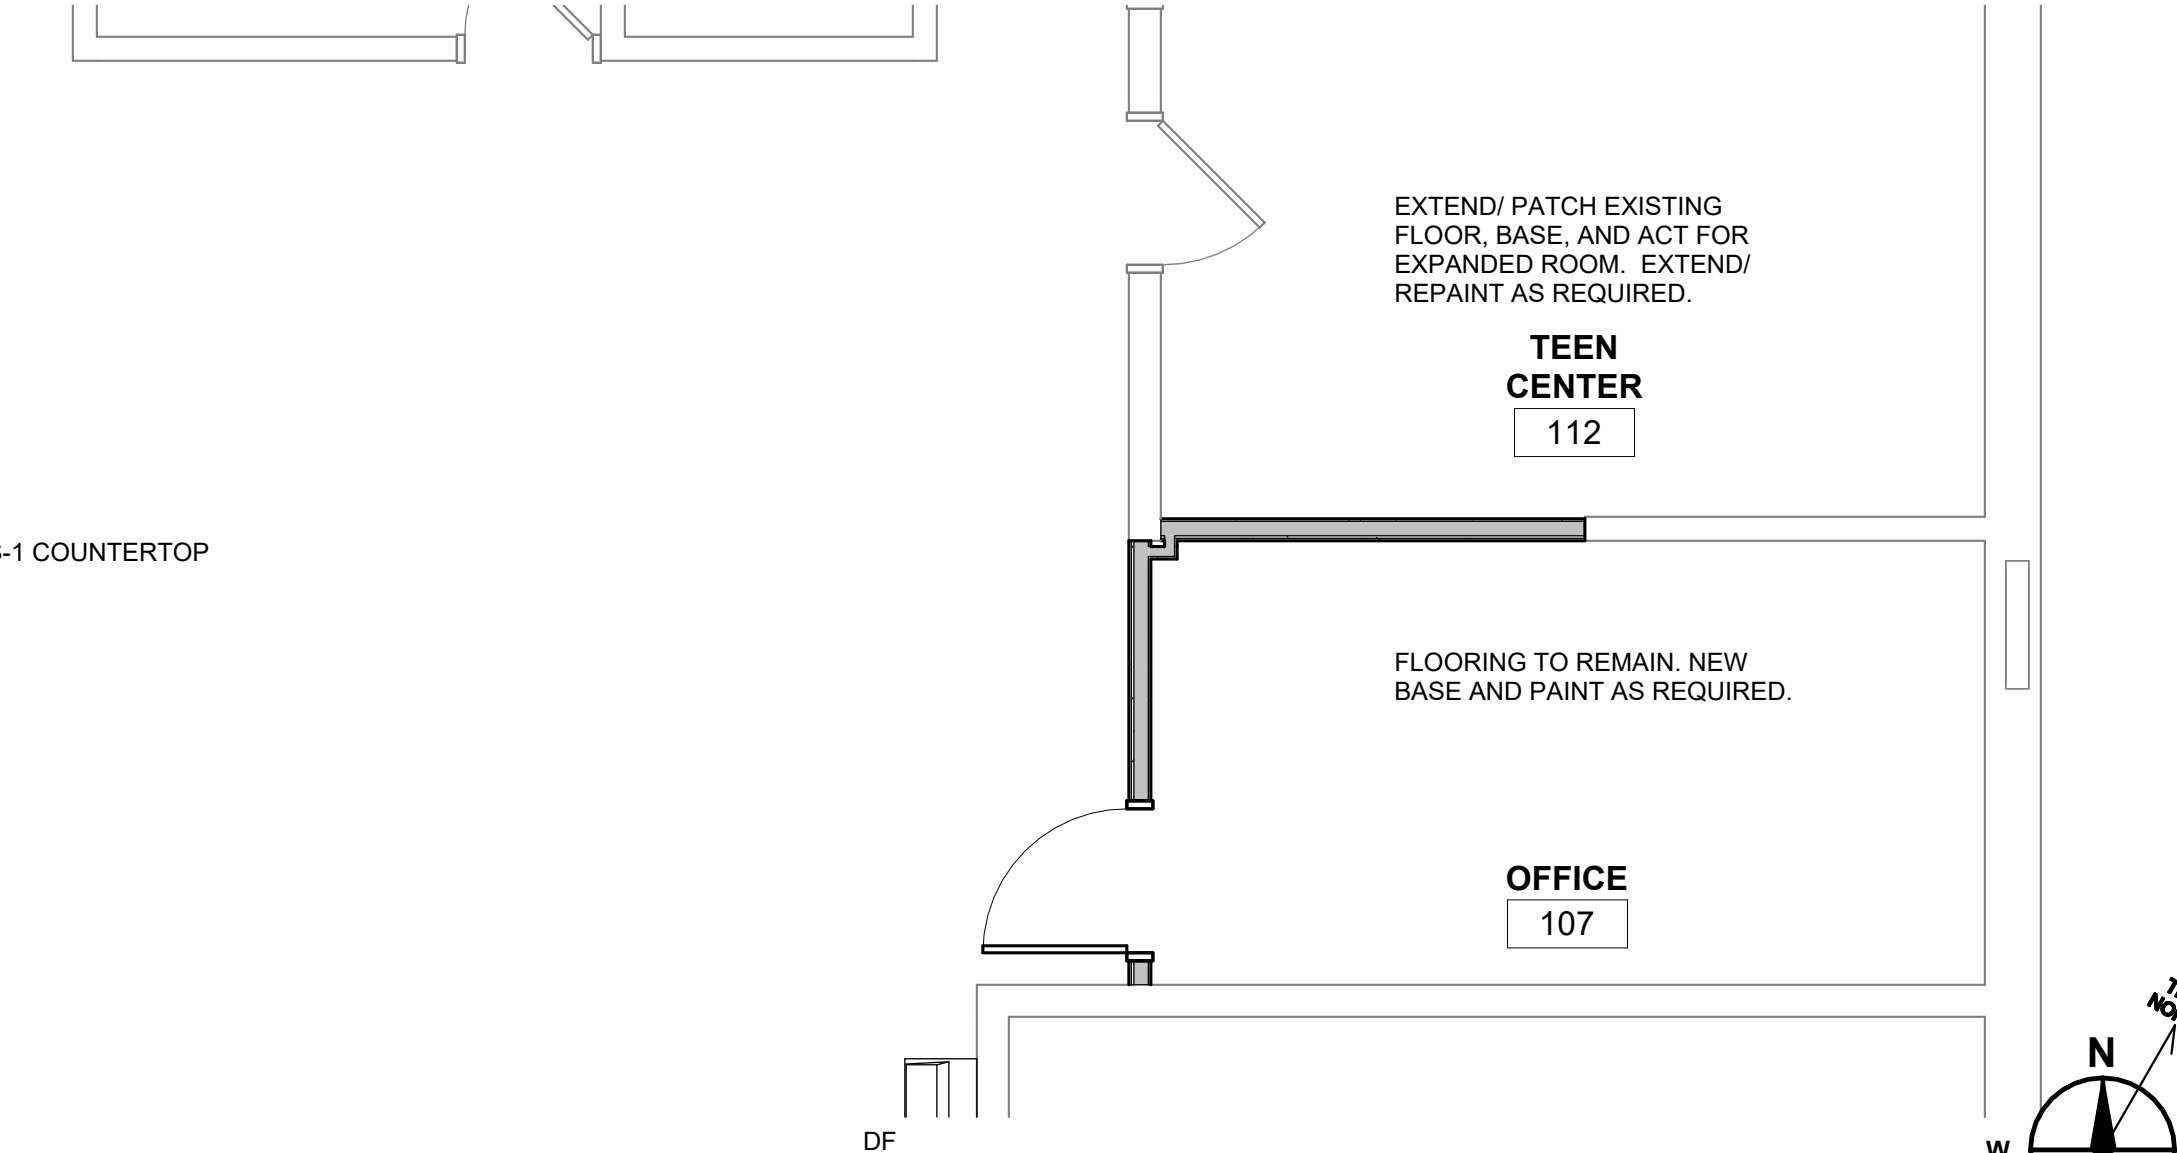

NUMBER	NAME	FLOOR FINISH	SUB-FLR	BASE	WALL FINISH				Ceiling Finish	COMMENTS
					N	E	S	W		
102	ACTIVITIES	---	CONCRETE	EXIST	---	PNT	---	---	---	EXTEND EXISTING BASE AS REQUIRED AT NEW PARTITION. PAINT NEW PARTITION & DOOR FRAME.
107	OFFICE	EXIST	CONCRETE	EXIST	PNT	---	---	PNT	ACT	EXTEND EXISTING BASE AS REQUIRED AT NEW PARTITIONS.
108	TOILET ROOM	EPX	CONCRETE	EPX	WP/ PNT	WP/ PNT	PNT	WP/ PNT	ACT	
109	TOILET ROOM	EPX	CONCRETE	EPX	WP/ PNT	WP/ PNT	WP/ PNT	WP/ PNT	ACT	
110	TOILET ROOM	EPX	CONCRETE	EPX	WP/ PNT	WP/ PNT	WP/ PNT	WP/ PNT	ACT	
111	TOILET ROOM	EPX	CONCRETE	EPX	WP/ PNT	WP/ PNT	WP/ PNT	WP/ PNT	ACT	
112	TEEN CENTER	EXIST	CONCRETE	EXIST	---	---	PNT	---	EXIST/ACT	EXTEND FLOORING, WALL BASE, AND CEILING AS REQUIRED FOR ENLARGED SPACE.

FLOOR FINISHES		BASE FINISHES	
EPX DUREX DYMAFLAKE, COLOR: TBD	EXIST EXISTING FLOORING TO REMAIN	EPX EPOXY BASE	
WALL FINISHES		CEILING FINISHES	
WP WALL PROTECTION PANELS, ACOVYN SELECTED FROM MANUFACTURER'S FULL RANGE		ACT ACOUSTIC CEILING TILE; REFER TO SPECIFICATION FOR PRODUCT TYPES AND SPECIFIC LOCATIONS.	
PAINT		COUNTERTOP FINISHES	
PNT-1 COLOR TO MATCH EXISTING WALL PAINT	PNT-2 SHERWIN WILLIAMS, TRIM PAINT COLOR: TBD	SS-1 SOLID SURFACE COUNTERTOP, CORIAN OR SIM.; SELECTED FROM MANUFACTURER'S FULL COLOR RANGE	

SEAL: \_\_\_\_\_  
CONSULTANT: \_\_\_\_\_

RENOVATIONS TO  
**SE CLUBHOUSE**  
BOYS & GIRLS CLUB  
333 DAUPHIN ST, LANCASTER, PA 17602

ISSUE DATES  
DATE: 10/01/2024  
DESCRIPTION: BID DOCUMENTS  
PROJ #: 24-80C-01  
DRAWN BY: SAB  
SHEET TITLE:


10/1/2024 11:28:17 AM





10/1/2024 11:26:18 AM

A B C D E F G H I J

1  
2  
3  
4  
5  
6  
7

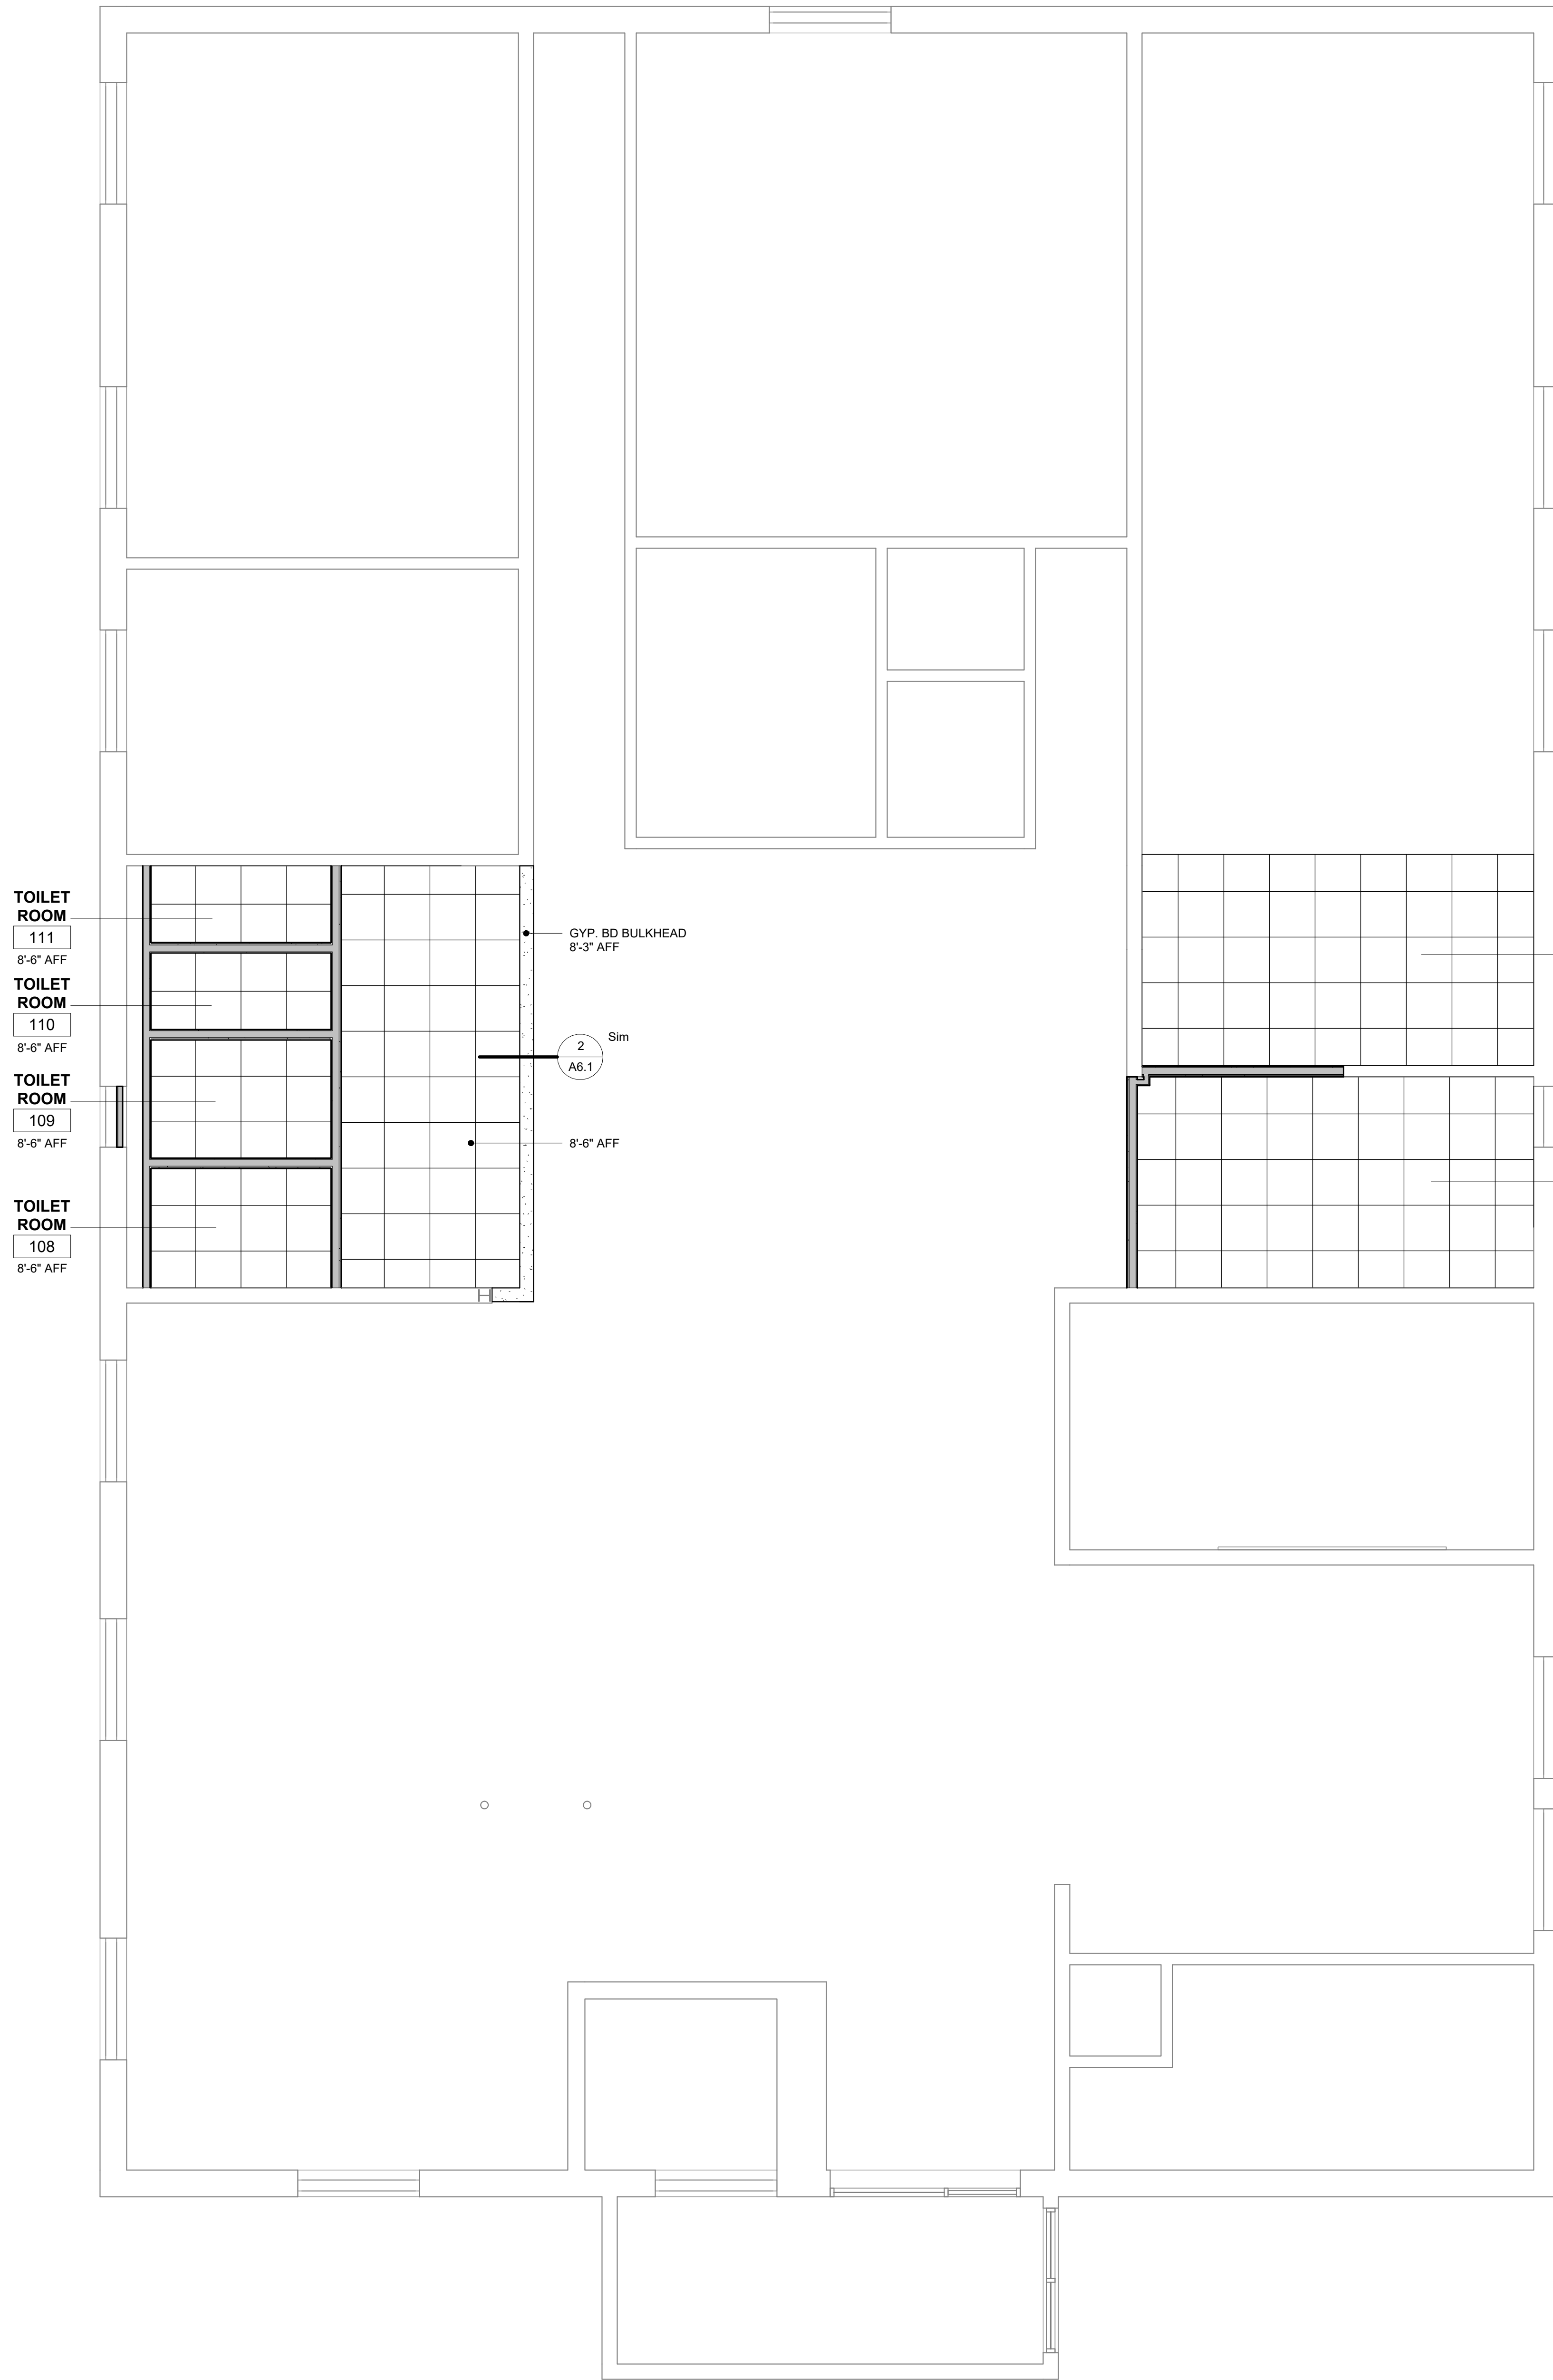

**1 FIRST FLOOR - REFLECTED CEILING PLAN**  
A6.1 1/4" = 1'-0"

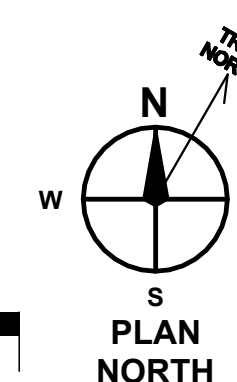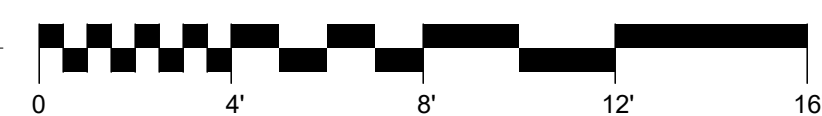

**GENERAL ACOUSTICAL CEILING INSTALLATION NOTES**


1. THE CONTRACTOR SHALL FIELD CHECK THE PREMISES AND VERIFY THAT THE CEILING LAYOUT SHOWN ON THE DRAWINGS CAN BE ACCOMMODATED AND VERIFY ALL CLEARANCES AS REQUIRED FOR ALL LIGHTING FIXTURES, DUCT WORK, AND SPRINKLERS BEFORE PROCEEDING WITH ANY INSTALLATION. REPORT ANY DISCREPANCIES TO THE ARCHITECT PRIOR TO PROCEEDING.
2. REVIEW CEILING LAYOUT WITH MEP COORDINATION DRAWINGS.
3. CEILING SHALL BE TRUE, FLAT, STRAIGHT AND REGULAR. PROVIDE STABILIZER BARS AS REQUIRED TO DISTRIBUTE LOAD EQUALLY OVER TWO OR MORE RUNNERS.
4. LEVEL CEILING TO BE WITHIN 1/8" IN 12 FEET IN ANY DIRECTION. LEVEL WITH HANGER WIRE TAUT AND PLUMB, WITHOUT KINKING OR BENDING HANGER WIRES.
5. INSTALL MAX. LENGTHS OF EDGE MOLDING AT INTERSECTION OF CEILING AND VERTICAL SURFACE. MITRE ALL CORNERS.
6. COORDINATE INSTALLATION WITH ELECTRICAL, MECHANICAL AND SPRINKLER REQUIREMENTS.
7. INSTALL CEILING TILE HOLD DOWN CLIPS IN ALL VESTIBULES, AIR LOCKS AND PARTITIONS WITH CUT CEILING TILES.
8. LAY DIRECTIONAL PATTERN UNITS IN SINGLE DIRECTION.
9. ALL FIXTURE TRIM (LIGHTING, SPEAKER, HVAC GRILLS, ETC.) SHALL BE METAL AND PAINTED TO MATCH ADJACENT CEILING FINISH. PLASTIC TRIM IS NOT ACCEPTABLE UNLESS APPROVED BY THE ARCHITECT.
10. REGULAR CEILING TILE TO BE CUT AND FITTED SNUG AGAINST PARTITIONS. DO NOT SHIM THE GRID TO ALLOW CEILING TILE TO PASS OVER TOP OF PARTITION.
11. FINAL GRID HEIGHTS AND LAY-OUT TO BE DETERMINED IN THE FIELD FOLLOWING COORDINATION.

**GENERAL REFLECTED CEILING PLAN LEGEND AND NOTES:**

	- INDICATES A LIGHTING FIXTURE, REFER TO ELECTRICAL DWGS.
	- INDICATES A HVAC DIFFUSER, REFER TO MECHANICAL DWGS.
	- INDICATES A EXHAUST FAN W/ LED LIGHT, REFER TO MEP DWGS.
	- INDICATES CRITICAL ENVIRONMENT DIFFUSER, REFER TO MECHANICAL DWGS.
	- INDICATES PYRAMID DIFFUSER, REFER TO FINISH SCHEDULE.
	- INDICATES 2X4 A.C.T. CEILING, REFER TO FINISH SCHEDULE.
	- INDICATES 2X2 A.C.T. CEILING, REFER TO FINISH SCHEDULE.
	- INDICATES G.W.B. CEILING, REFER TO FINISH SCHEDULE.

**NOTES:**

- 1) REFER TO FINISH SCHEDULE FOR CEILING MATERIALS.
- 2) REFER TO WALL AND BUILDING SECTIONS FOR INFORMATION RELATED TO SLOPED CEILINGS.
- 3) ALL EXPOSED STRUCTURE IS TO BE PAINTED - COLOR SELECTION BY ARCHITECT.
- 4) ALL EXPOSED EQUIPMENT IS TO BE PAINTED - COLOR SELECTION BY ARCHITECT. EXPOSED MECHANICAL, ELECTRICAL, PLUMBING AND ARCHITECTURAL TO BE PAINTED.

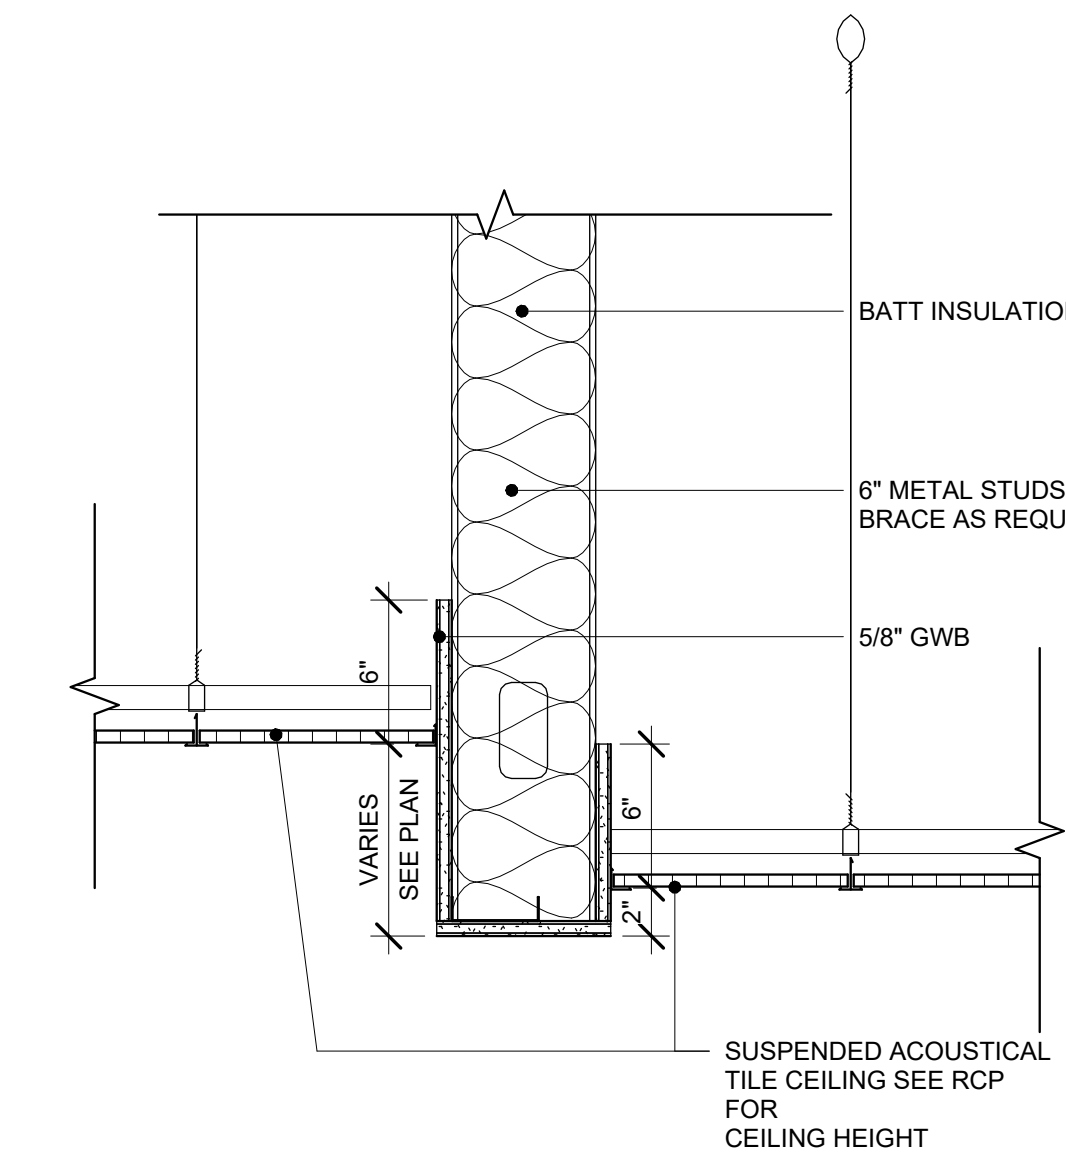

**2 TYPICAL BULKHEAD DETAIL**  
A6.1 1 1/2" = 1'-0"

SEAL:


CONSULTANT:

RENOVATIONS TO  
**SE CLUBHOUSE**  
BOYS & GIRLS CLUB  
333 DAUPHIN ST, LANCASTER, PA 17602


ISSUE DATES	DESCRIPTION	DATE	BY
10/01/2024	BID DOCUMENTS		

PROJ # : 24-800-01 DRAWN BY : SAB  
SHEET TITLE:  
**FIRST FLOOR REFLECTED CEILING PLAN**  
SHEET NUMBER:  
**A6.1**  
**BID**






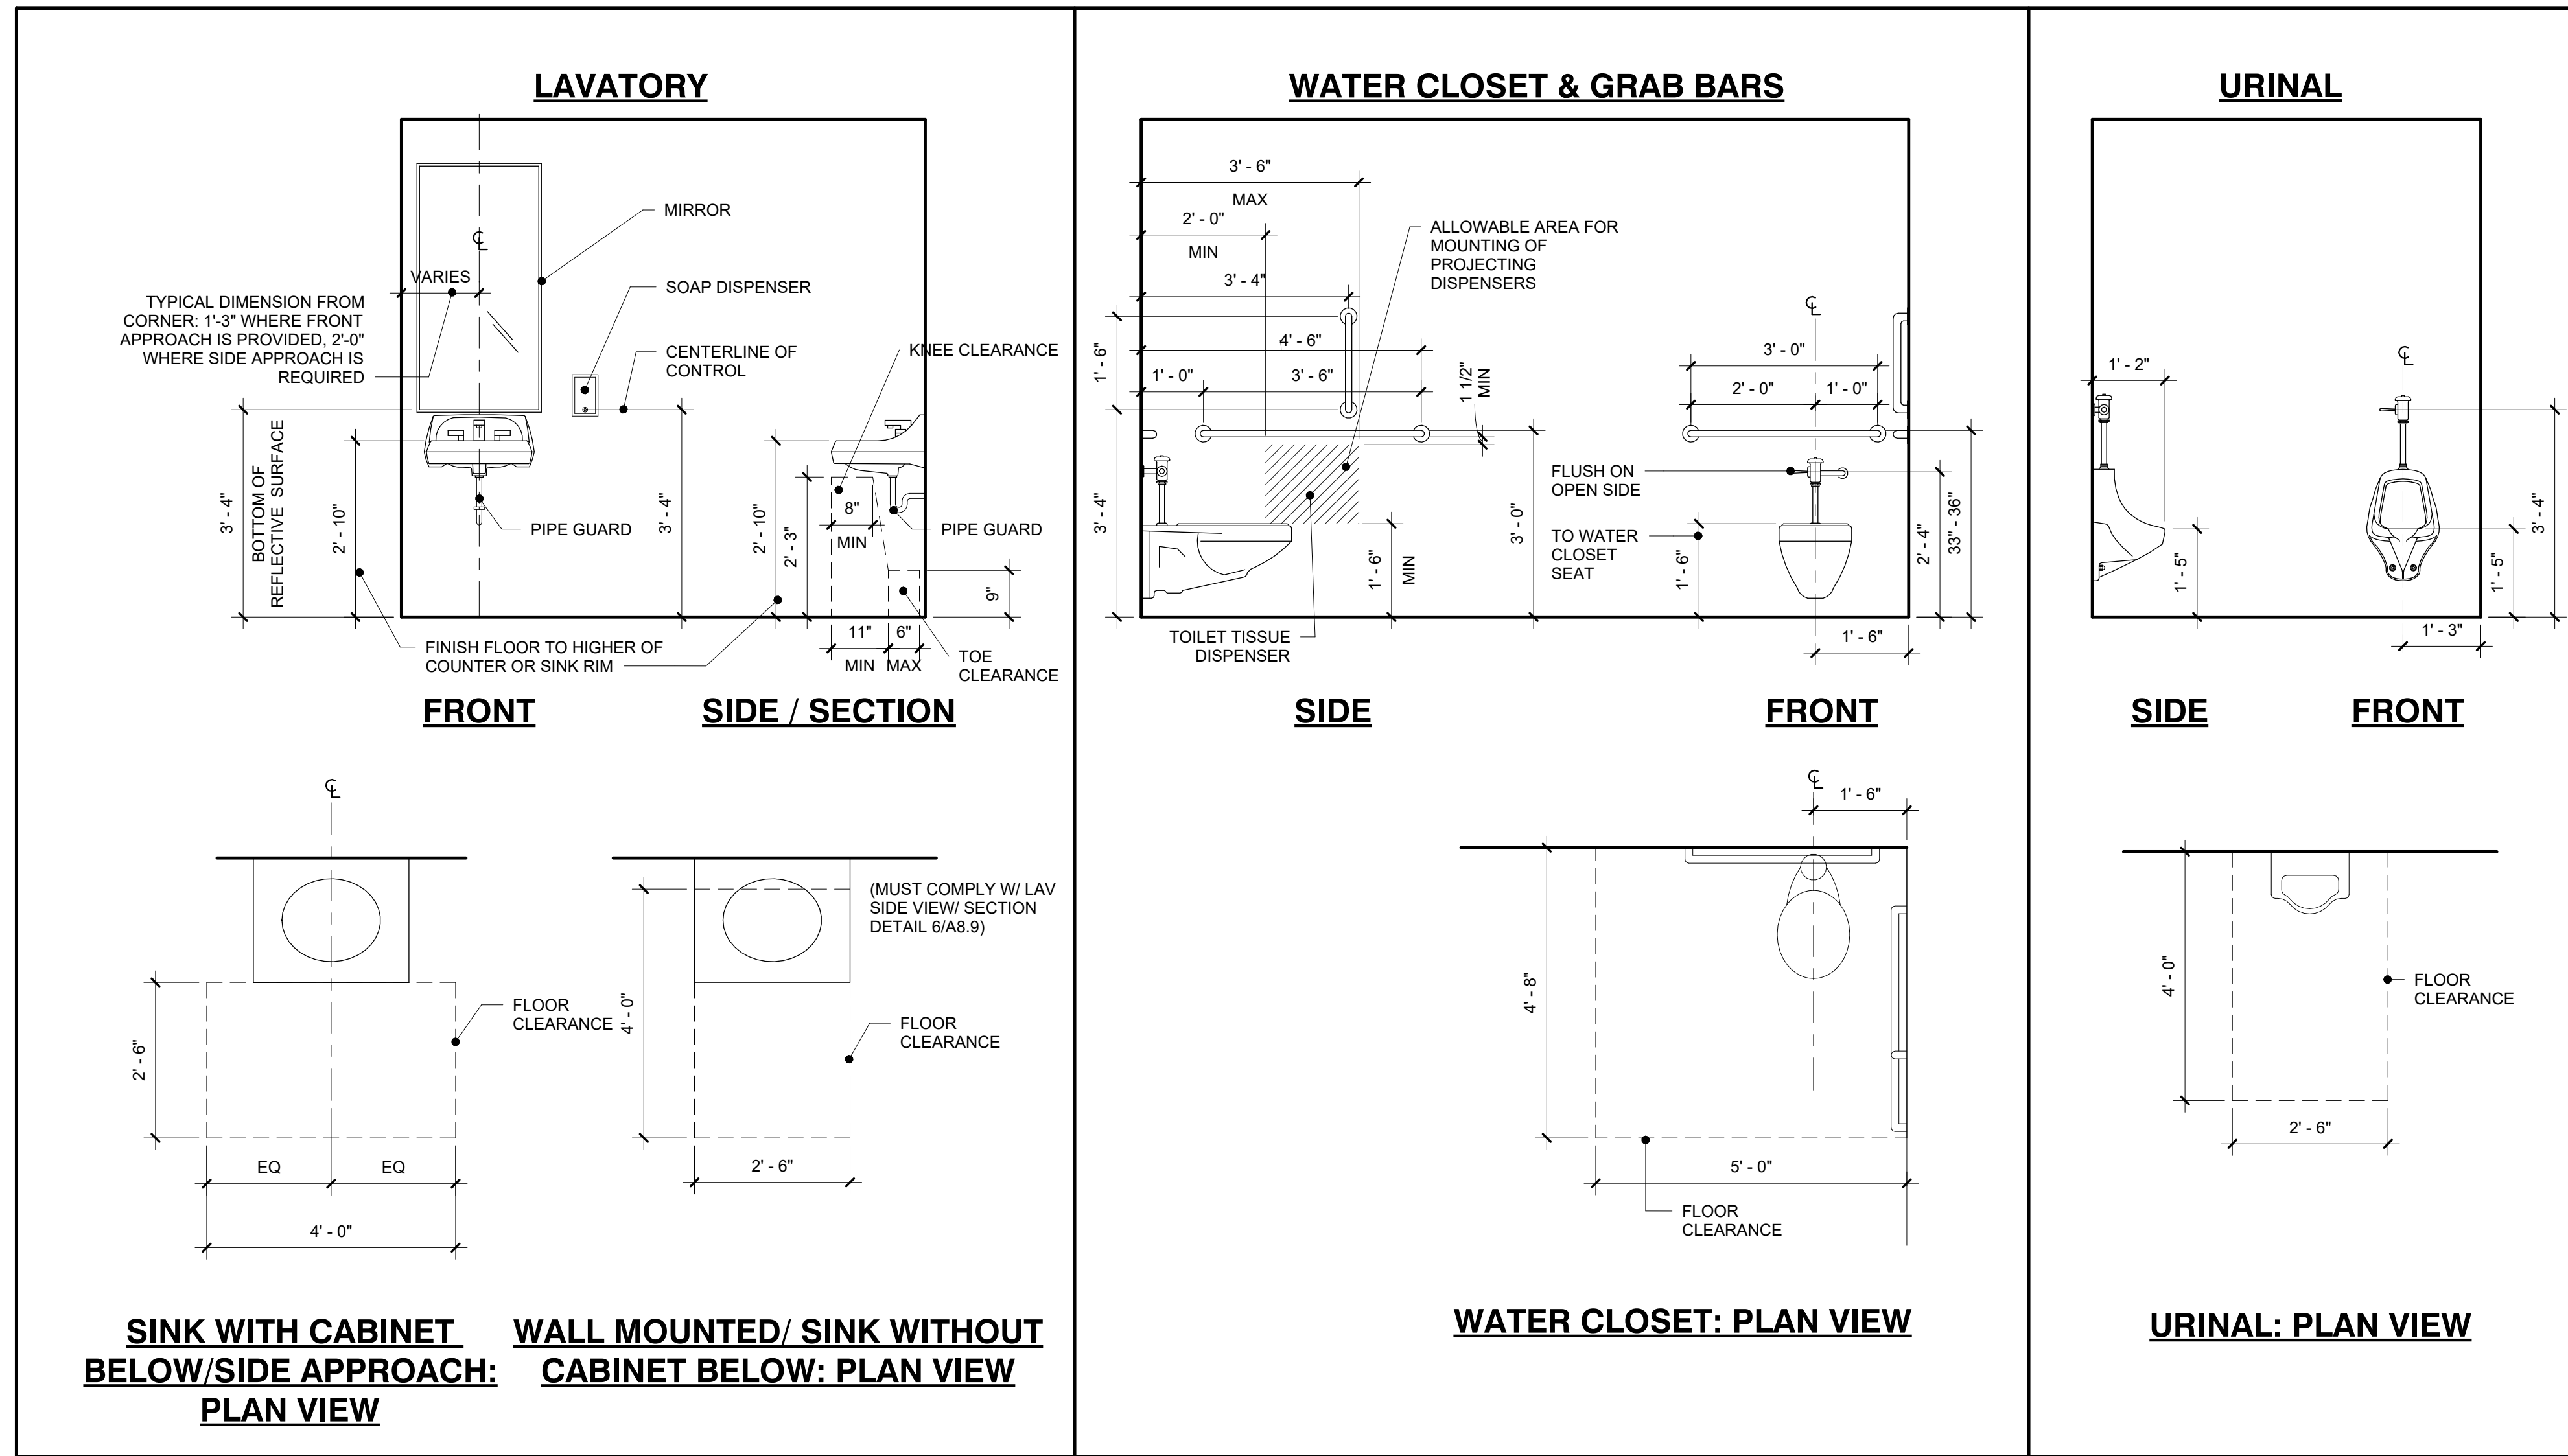


TOILET ACCESSORY SCHEDULE		
Type Mark	Description	Comments
T1	Grab Bar Set - Water Closet	
T2	Surface-Mounted Multi-Roll Toilet Tissue Dispenser	
T3	SANITARY NAPKIN DISPOSAL, SURFACE-MOUNTED	
T4	Automatic Surface Mounted ADA Hand Dryer	

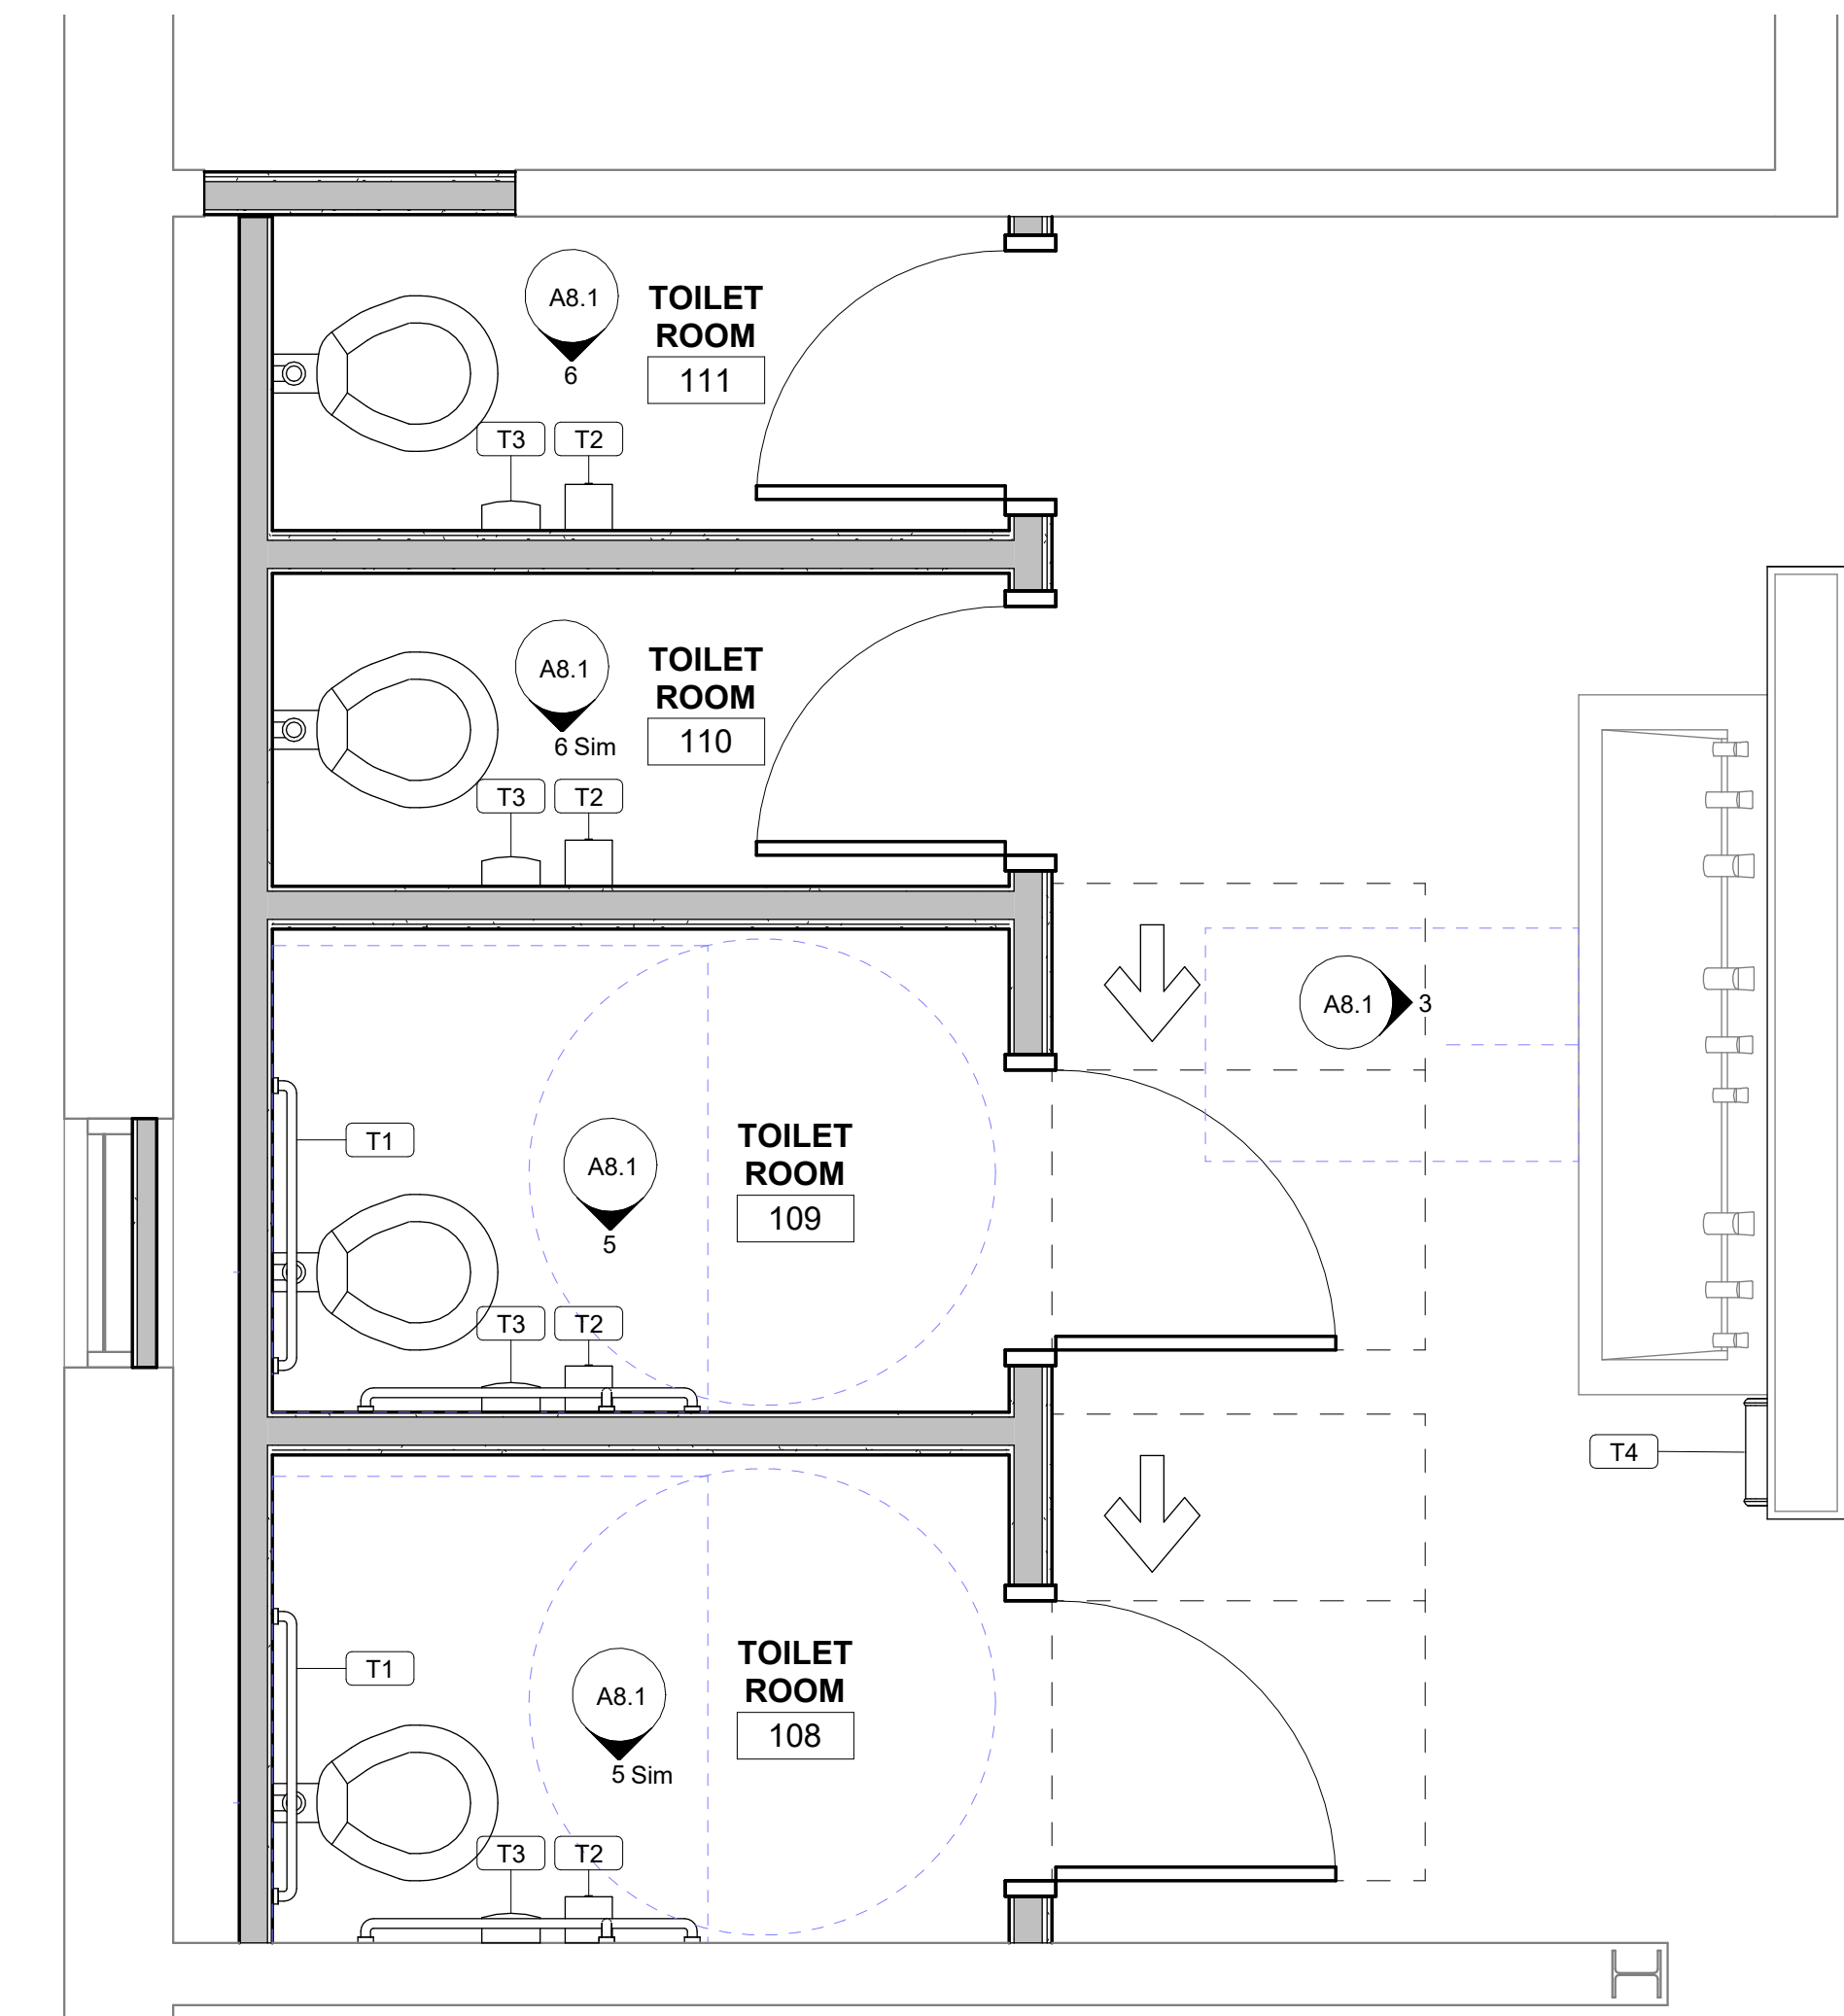

**4 ACCESSIBILITY DETAILS**  
 A8.1 1/2" = 1'-0"

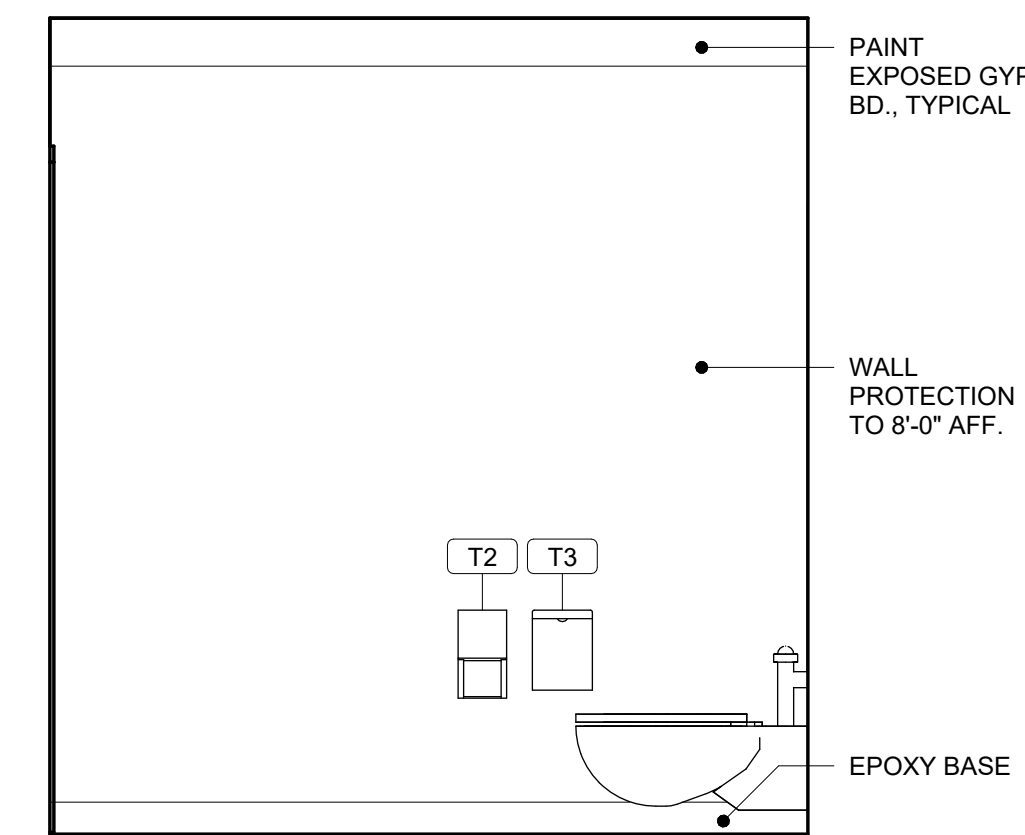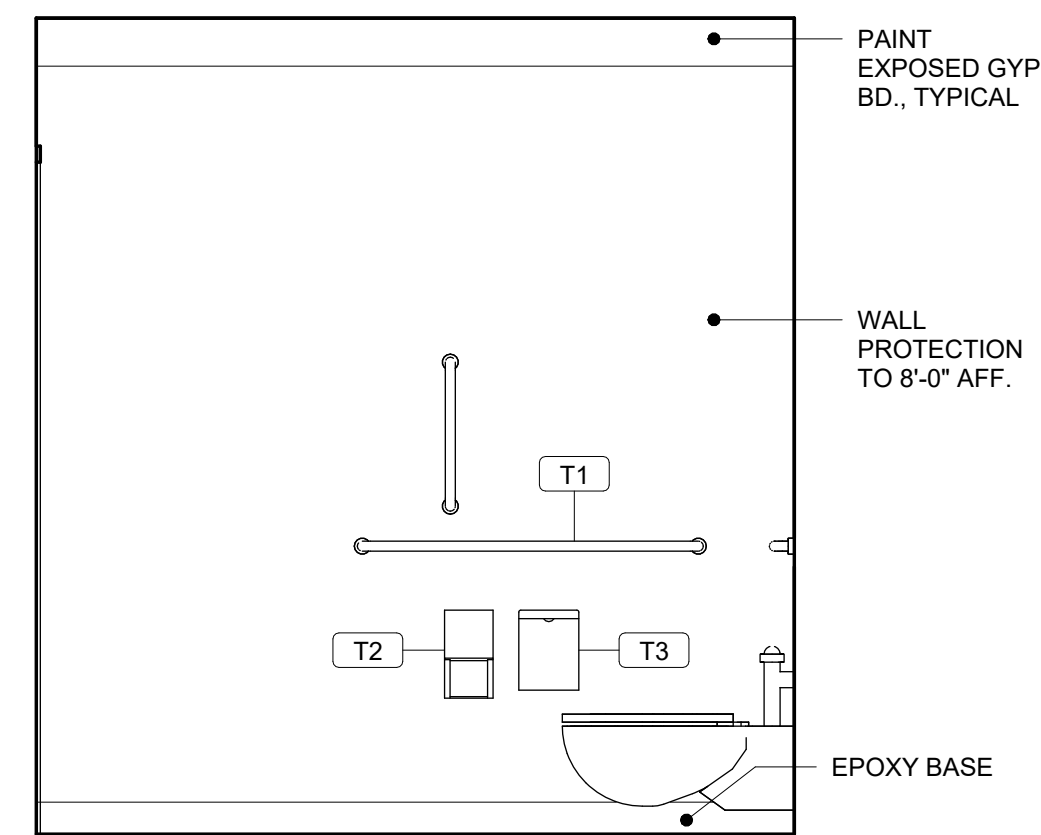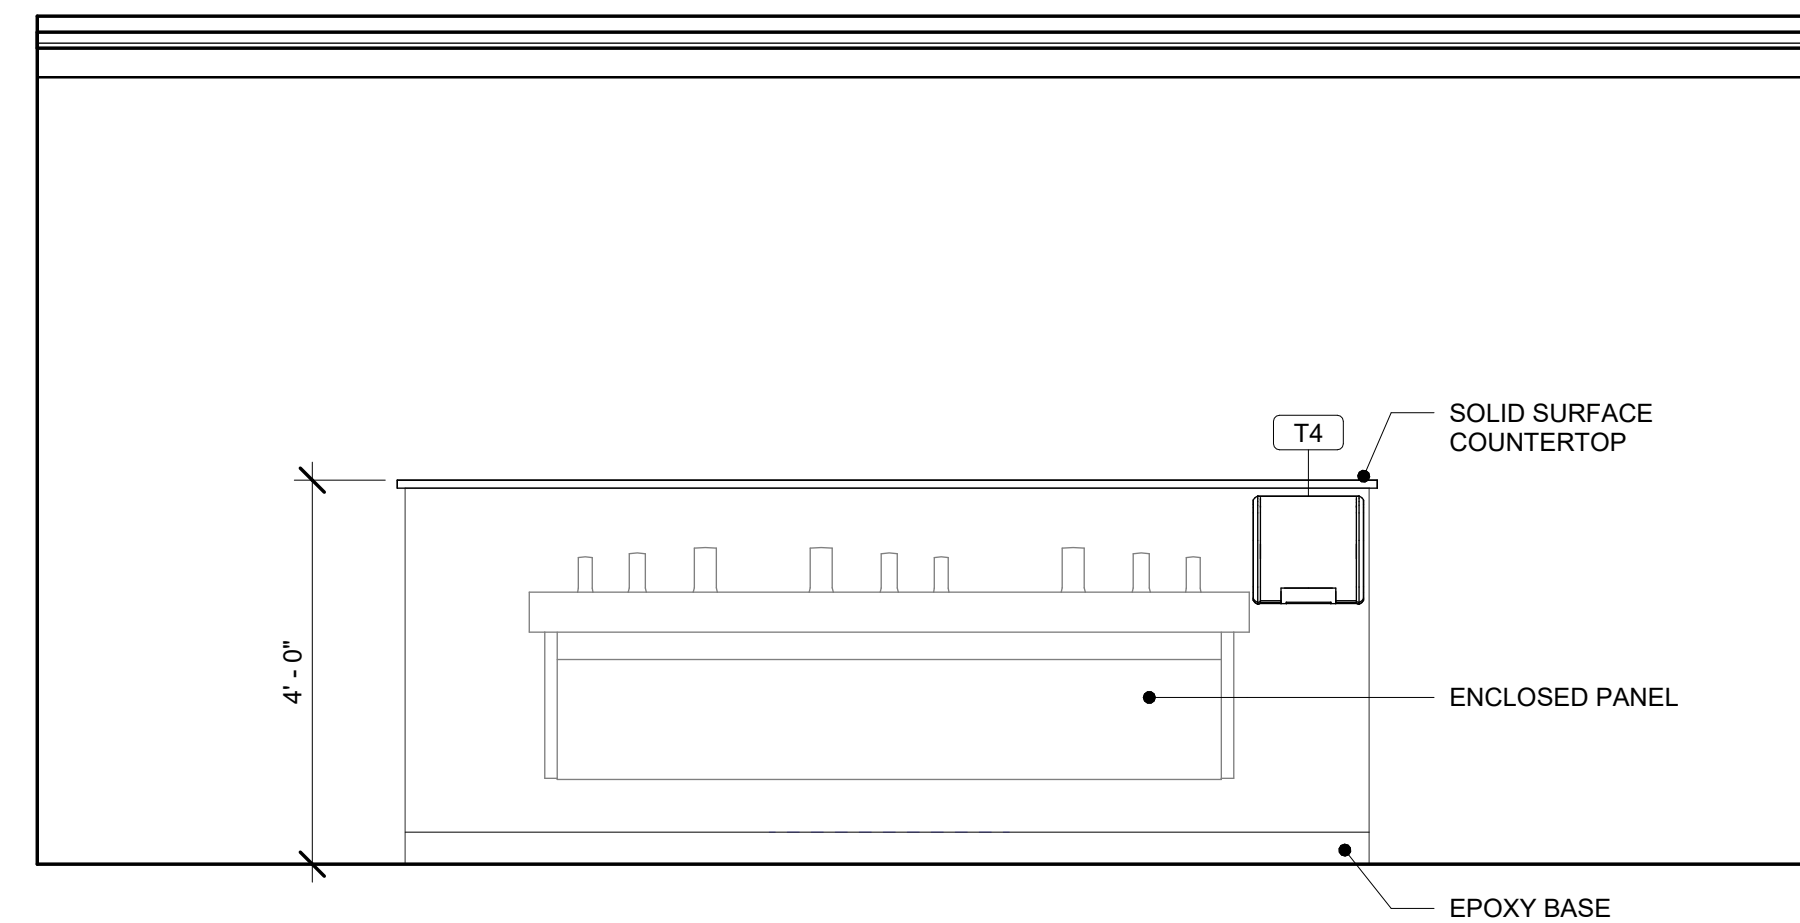

**1 ENLARGED PLAN - RESTROOMS**  
 A8.1 1/2" = 1'-0"

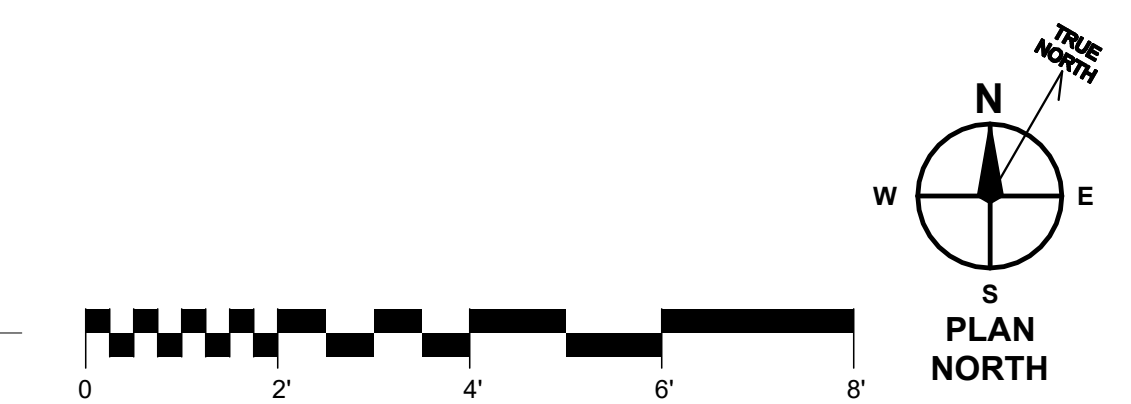


**3 INTERIOR ELEVATION**  
 A8.1 1/2" = 1'-0"

**5 INTERIOR ELEVATION**  
 A8.1 1/2" = 1'-0"  
 109 TOILET ROOM

**6 INTERIOR ELEVATION**  
 A8.1 1/2" = 1'-0"  
 111 TOILET ROOM

**2 ENLARGED PLAN - OFFICE**  
 A8.1 1/2" = 1'-0"

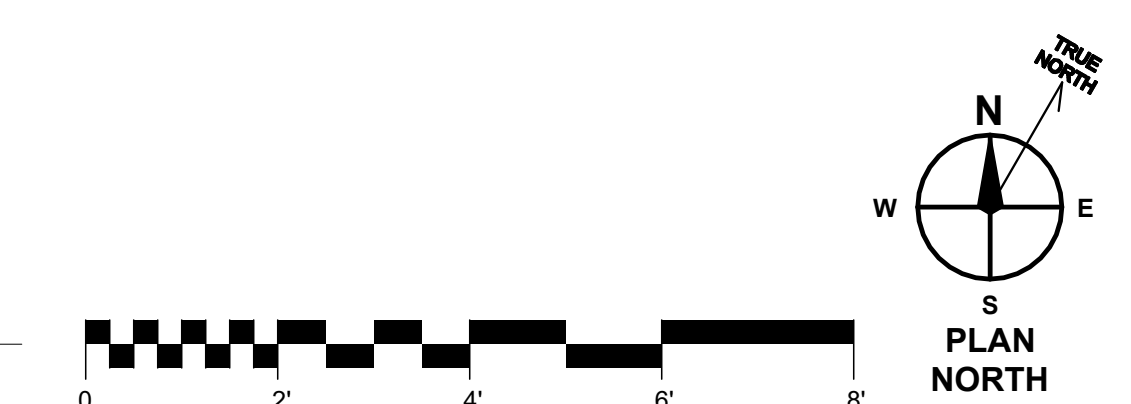

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# RENOVATION TO JACK WALKER CLUBHOUSE BOYS & GIRLS CLUB

## SYMBOLS

<p><b>SECTION TAG</b> DETAIL NUMBER SHEET NUMBER</p> <p><b>INTERIOR ELEVATION</b> ELEVATION NUMBER SHEET NUMBER</p> <p><b>EXTERIOR ELEVATION</b> ELEVATION NUMBER SHEET NUMBER</p> <p><b>DETAIL TAG</b></p> <p><b>PARTITION/BULKHEAD TAG</b> (REFER TO A1.0 FOR TYPES)</p>	<p><b>ROOM TAG</b> ROOM NAME ROOM NUMBER</p> <p><b>CASEWORK TAG</b> BASIS OF DESIGN MODEL NUMBER (CUSTOM/MODIFIED CABINETS HAVE "M" SUFFIX) CABINET NOMINAL HEIGHT CABINET WIDTH</p> <p><b>WINDOW TAG</b></p> <p><b>CURTAIN WALL TAG</b></p> <p><b>STOREFRONT TAG</b></p> <p><b>INTERIOR WINDOW TAG</b></p>	<p><b>DOOR TAG</b></p> <p><b>ROOF TAG</b></p> <p><b>NEW DOOR</b></p> <p><b>EXISTING DOOR</b></p> <p><b>EXISTING COL. LINE</b> OCTAGON ITALIC TEXT</p> <p><b>NEW COL. LINE</b> CIRCLE STANDARD TEXT</p>
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## HATCH PATTERNS

METAL STUD	BRICK	CONCRETE	CMU	EARTH	STEEL
RIGID INSULATION	BATT INSUL.	ROUGH WOOD	GRAVEL	FINISHED WOOD	PLYWOOD

## ABBREVIATIONS

(NOT ALL ABBREVIATIONS APPEAR IN PROJECT)

AC AIR CONDITIONING	EP ELECTRICAL PANEL	LLV LONG LEG VERTICAL	SF SQUARE FEET/FOOT
ACM ALUMINUM COMPOSITE MATERIAL	EPDM ETHYLENE PROPYLENE DIENE M-CLASS	MAX MAXIMUM	SHT SHEET
ACQUST ACOUSTICAL	EQ EQUAL	MECH MECHANICAL	SIM SIMILAR
ACT ACOUSTIC CEILING TILE	EQUIP EQUIPMENT	MED MEDIUM	SM SHEET METAL
ADJ ADJACENT	ES EACH SIDE	MEMB MEMBRANE	SM SURFACE MOUNTED
AFF ABOVE FINISHED FLOOR	ETR EXISTING TO REMAIN	MFR MANUFACTURER	SPEC SPECIFIED OR SPECIFICATION
AFG ABOVE FINISHED GRADE	EWG ELECTRIC WATER COOLER	MH MAN HOLE	SPK SPRINKLER OR SPEAKER
AGGR AGGREGATE	EXH EXHAUST	MIN MINIMUM	SPR SPEAKER
ALT ALTERNATE	EXIST EXISTING	MISC MISCELLANEOUS	SO SQUARE
ALUM ALUMINUM	EXP EXPANSION	MO MASONRY OPENING	SS STAINLESS STEEL
ANOD ANODIZED	EXT EXTERIOR	MR MOISTURE RESISTANT	STC SOUND TRANSMISSION COEFFICIENT
APPROX APPROXIMATE	FA FIRE ALARM	MTD MOUNTED	STRG STRINGER
ARCH ARCHITECTURAL	FDR FLOOR DRAIN	MTG MOUNTING	STRUCT STRUCTURE OR STRUCTURAL
ATTN ATTENTION	FDC FIRE DEPARTMENT CONNECTION	MTL METAL	SUSP SUSPENDED
AV AUDIOVISUAL	FE FIRE EXTINGUISHER	MULL MULLION	SYM SYMMETRICAL
BD BOARD	FEI FIRE EXTINGUISHER CABINET	MW MICROWAVE	SYS SYSTEM
BIT BITUMINOUS	FFE FURNITURE, FIXTURES AND EQUIPMENT	N NORTH	T TREAD
BLDG BUILDING	FFI FINISH FLOOR ELEVATION	NA NOT APPLICABLE	T&B TOP AND BOTTOM
BLKG BLOCKING	FIN FINISH	NC NOISE CRITERIA	T&G TONGUE AND GROOVE
BM BEAM	FLR FLOOR	NIC NOT IN CONTRACT	TELE TELEPHONE
BO BOTTOM OF	FND FOUNDATION	NO NUMBER	TEMP TEMPORARY
BOT BOTTOM	FO FACE OF	NOM NOMINAL	THK THICKNESS
BSM BEARING	FRP FIBER REINFORCED PLASTIC	NTS NOT TO SCALE	TKBD TACK BOARD
BSMNT BASEMENT	FRT FIRE RETARDANT TREATED	OC ON CENTER	TLT TOILET
CB CEMENT BOARD	FRZ FREEZER	OD OUTSIDE DIAMETER	TMPD TEMPERED
CBU CEMENTITIOUS BACKER UNIT	FT FEET/FOOT	OD OVERFLOW DRAIN	TOB TOP OF BEAM
CCV CLOSED CIRCUIT TELEVISION	FTG FOOTING	OFCI OWNER FURNISHED CONTRACTOR INSTALLED	TOC TOP OF CONCRETE
CFG COLD FORMED STEEL	FURN FURNITURE	OFF OFFICE	TOS TOP OF STEEL
CG CORNER GUARD	FURR FUR	OFDI OWNER FURNISHED, OWNER INSTALLED	TS TUBE STEEL
CI CAST IRON	GA GAUGE	OH OVERHEAD	TV TELEVISION
CIP CAST-IN-PLACE	GALV GALVANIZED	OPNG OPENING	TYP TYPICAL
CJ CONTROL JOINT	GEN GENERAL CONTRACT(OR)	OPP OPPOSITE	UNO UNLESS NOTED OTHERWISE
CL CL CENTERLINE	GRFC GLASS FIBER REINFORCED CONCRETE	ORD OVERFLOW ROOF DRAIN	UNO UNLESS OTHERWISE NOTED
CLG CEILING	GFRG GLASS FIBER REINFORCED GYPSUM	PBD PARTICLE BOARD	VAR VARIES
CLR CLEAR	GLZ GLAZING	PC PRECAST OR PLUMBING CONTRACT(OR)	VCT VINYL COMPOSITION TILE
CMU CONCRETE MASONRY UNIT	GRD GROUND	PERF PERFORATED	VERT VERTICAL
CO CLEANOUT	GWB GYPSUM WALL BOARD	PERM PERIMETER	VEST VESTIBULE
COL COLUMN	GYP GYPSUM	PERP PERPENDICULAR	VIF VERIFY IN FIELD
CONC CONCRETE	HIC HIGHHEIGHT	PLB PL PLATE	VLR VAPOR RETARDER
CONST CONSTRUCTION	HDWD HARDWOOD	PLM PLASTIC LAMINATE	VPC VAPOR RETARDER
CONT CONTINUOUS	HDWR HARDWARE	PLB POUNDS PER LINEAR FOOT	VT VINYL TILE
COORD COORDINATE	HGT HEIGHT	PNL PANEL	WV WIDE/WEEST
CORR CORRIDOR	HM HOLLOW METAL	PNT PAINT OR PAINTED	W WITH
CPT CARPET	HNDRL HANDRAIL	PREFAB PREFABRICATED	W/O WITHOUT
CT CERAMIC TILE	HO HOLD OPEN	PROJ PROJECT	WC WATER CLOSET
CTR CENTER	HORIZ HORIZONTAL	PSF POUNDS PER SQUARE FOOT	WD WOOD
CTSK COUNTERSUNK	HSS HOLLOW STRUCTURAL SECTION	PT PRESSURE TREATED	WP WATERPROOF/WATERPROOFING
CW COLD WATER	HTG HEATING	PTD PAINTED	WPM WATERPROOF MEMBRANE
D DEEP DEPTH	HVAC HEATING VENTILATION AND AIR CONDITIONING	QT QUARRY TILE	WSTC WAINSCOT
DBL DOUBLE	HWI HOT WATER	QTY QUANTITY	WT WEIGHT
DEG DEGREE	IDW INSIDE DIAMETER	RA RETURN AIR	WWF WELDED WIRE FABRIC
DEMO DEMOLISH OR DEMOLITION	IN INCHES	RB RESILIENT BASE	WWW WELDED WIRE MESH
DEPT DEPARTMENT	INT INTERMEDIATE	RCF REFLECTED CEILING PLAN	
DF DRINKING FOUNTAIN	INV INVERT	RD ROOF DRAIN	
DIAM DIAMETER	JAN JANITOR	RDL ROOF DRAIN LEADER	
DIFF DIFFUSER	JST JOIST	REC RECESSED	
DIR DIMENSION	JT JOINT	REC RECEPTACLE	
DIMS DIMENSIONS	KIT KITCHEN	REF REFERENCE	
DIV DIVISION	KT JOINT	REF REFRIGERATOR	
DIMP DAMP PROOFING	LAM LAMINATE	REF REFRIGERATOR	
DN DOWN	LAV LAVATORY	REIN REINFORCED REINFORCING	
DR DOOR	LB POUNDS	REQ REQUIRE/REQUIRED	
DRN DRAIN	LGM LIGHT GAUGE METAL	REV REVISION/REVISED	
DS DOWNSPOUT	LHL LONG LEG HORIZONTAL	RM ROOM	
DTL DETAIL		RO ROOF OPENING	
DW DISHWASHER		RTD RATED	
DWG DRAWING		RTG RATING	
E EAST		RVL RAIN WATER LEADER	
EA EACH		S SOUTH	
EJ ELECTRICAL CONTRACTOR		SA SUPPLY AIR	
EJC ELECTRICAL CONTRACTOR		SC SOLID CORE	
EJL EXPANSION JOINT		SD STORM DRAIN	
EJC EXPANSION JOINT COVER		SECT SECTION	
ELEV ELEVATION			
ELEC ELECTRICAL			
ELEV ELEVATOR			
EMER EMERGENCY			
ENCL ENCLOSURE			
ENG ENGINEER			

## ARCHITECTURAL

- CS1 COVER SHEET
- A0.1 GENERAL STRUCTURAL NOTES & SCHEDULE OF SPECIAL INSPECTIONS
- AD1.1 FIRST FLOOR DEMOLITION PLAN
- AD1.2 ROOF DEMOLITION PLAN
- A1.1 FIRST FLOOR PLAN
- A5.1 ROOF PLAN
- A5.2 TYPICAL ROOF DETAILS
- A5.3 TYPICAL ROOF DETAILS
- A6.1 FIRST FLOOR REFLECTED CEILING PLAN
- A7.1 RAMP AND STAIRS ENLARGED PLANS
- A7.2 RAMP AND STAIRS SECTIONS
- A7.3 TYPICAL DETAILS
- A8.1 TOILET ROOM ENLARGED PLANS & INTERIOR ELEVATIONS
- A9.1 DOOR & WINDOW SCHEDULE, TYPES, & DETAILS
- A10.1 FINISH SCHEDULE & LEGEND

## MECHANICAL

- M0.1 HVAC NOTES & SCHEDULES
- MD1.1 HVAC DEMO PLAN
- M1.1 HVAC PLAN

## ELECTRICAL


- E0.1 ELECTRICAL NOTES & SCHEDULES
- ED1.1 ELECTRICAL DEMO PLAN
- E1.1 ELECTRICAL PLAN

## CIVIL

- SHEET 1 OF 2 EXISTING CONDITIONS / DEMOLITION / LAYOUT & GRADING PLAN
- SHEET 2 OF 2 DETAILS

## PLUMBING

- P0.1 PLUMBING NOTES & SCHEDULES
- PD1.1 DEMO PLUMBING PLAN
- P1.1 NEW PLUMBING PLAN

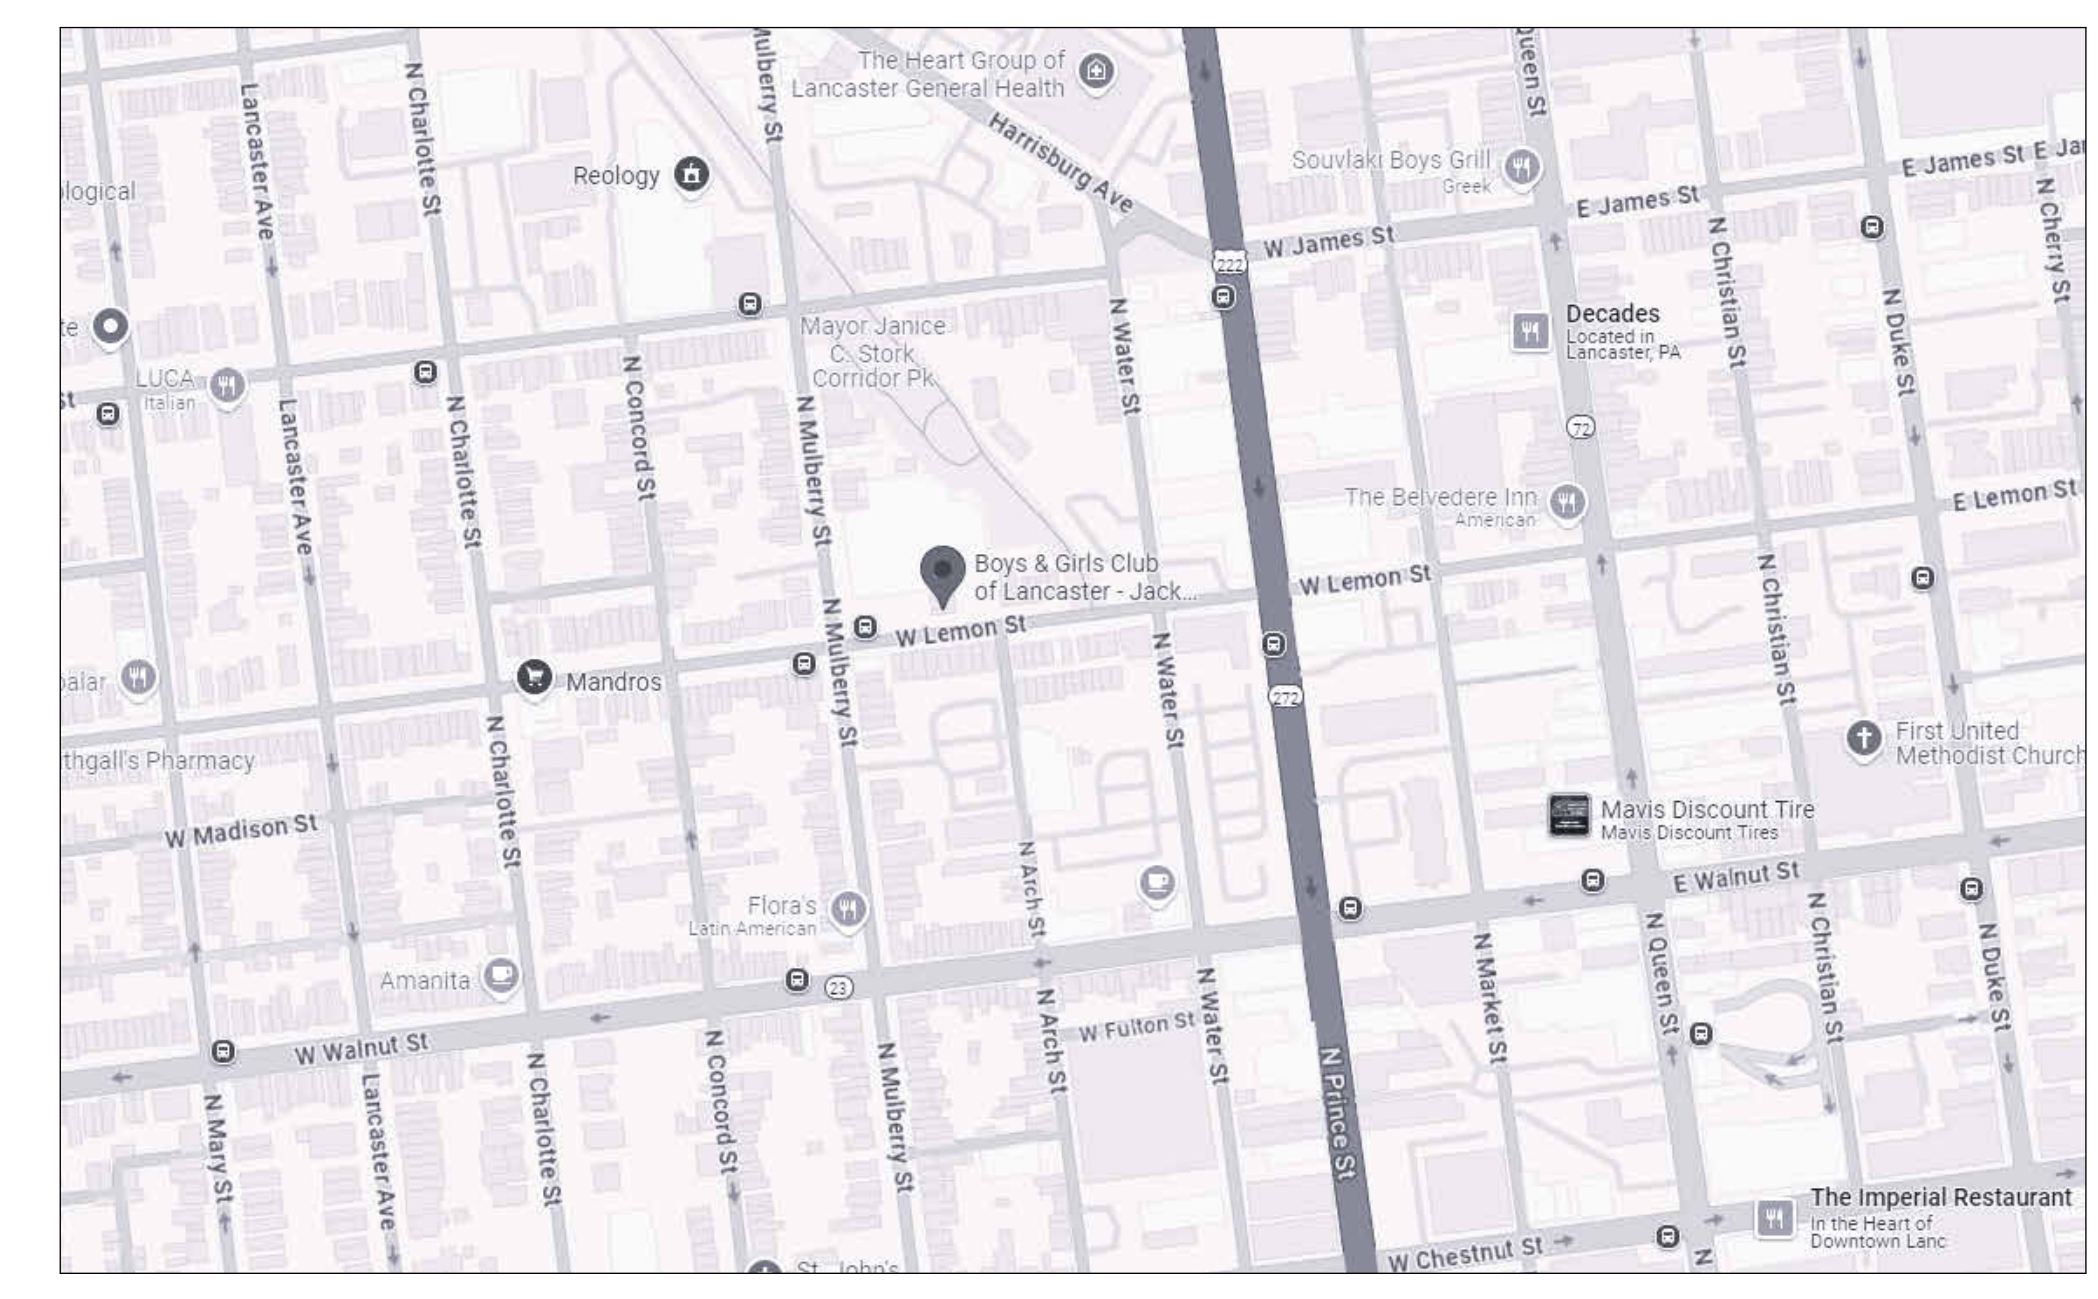

## LOCATION MAP

## BUILDING CODE ANALYSIS:

PENNSYLVANIA UNIFORM CONSTRUCTION CODE (UCC):  
INTERNATIONAL BUILDING CODE - 2018  
INTERNATIONAL BUILDING CODE - 2018 CHAPTER 11  
INTERNATIONAL EXISTING BUILDING CODE - 2018  
INTERNATIONAL FIRE CODE - 2018  
INTERNATIONAL PLUMBING CODE - 2018  
INTERNATIONAL ENERGY CONSERVATION CODE - 2018  
INTERNATIONAL MECHANICAL CODE - 2018  
ICC A117.1 - 2012 ACCESSIBILITY CODE

**IBC 2018**  
USE GROUP A-3 ASSEMBLY, Clubhouse  
Construction Type: IIB

**IBC 2018**  
**305.6 Alterations.** A facility that is altered shall comply with the applicable provisions in Chapter 11 of the International Building Code, unless technically infeasible. Where compliance with this section is technically infeasible, the alteration shall provide access to the maximum extent technically feasible.  
Exceptions: 1. The altered element or space is not required to be on an accessible route, unless required by Section 305.7. 2. Accessible means of egress required by Chapter 10 of the International Building Code are not required to be provided in existing facilities.

305.7 Alterations affecting an area containing a primary function, the route to the primary function area shall be accessible. The accessible route to the primary function area shall include toilet facilities and drinking fountains serving the area of primary function. ROUTE REMAINS ACCESSIBLE.

305.8 Scoping for alterations. The provisions of Sections 305.8.1 through 305.8.15 shall apply to alterations to existing buildings and facilities.  
305.8.5 Ramps: Where slopes steeper than allowed in Section 1012.2.2 of the International Building Code are necessitated by space limitations, the slope of ramps in or providing access to existing facilities shall comply with Table 305.8.5.  
Steeper than 1:10 but not steeper than 1:8 Max. Rise 3 inches  
Steeper than 1:12 but not steeper than 1:10 Max. Rise 6 inches

**ALTERATION-LEVEL 2**  
603.1 Scope. Level 2 alterations include the reconfiguration of space, the addition or elimination of any door or window, the reconfiguration or extension of any system, or the installation of any additional equipment.  
603.2 Application. Level 2 alterations shall comply with the provisions of Chapter 7 for Level 1 alterations as well as the provisions of Chapter 8.

**801.3 Compliance.** New construction elements, components, systems, and spaces shall comply with the requirements of the International Building Code.  
Exceptions:  
2. Newly installed electrical equipment shall comply with the requirements of Section 807.  
6. New structural members and connections shall be permitted to comply with alternative design criteria in accordance with Section 302.

**803.2 Automatic sprinkler systems.** Automatic sprinkler systems shall be provided in accordance with the requirements of Sections 803.2.1 through 803.2.4. Installation requirements shall be in accordance with the International Building Code. SPRINKLERS EXISTING TO BE REVISED TO MEET NEW LAYOUT

**803.4 Fire alarm and detection.** An approved fire alarm system shall be installed in accordance with Sections 803.4.1 through 803.4.3. Where automatic sprinkler protection is provided in accordance with Section 803.2 and is connected to the building fire alarm system, automatic heat detection shall not be required. FIRE ALARM DETECTION SYSTEM EXISTING.

## PLUMBING CODE ANALYSIS:

INTERNATIONAL PLUMBING CODE - 2018

403.1.1 FIXTURE CALCULATIONS  
TO DETERMINE THE OCCUPANT LOAD OF EACH SEX, THE TOTAL OCCUPANT LOAD SHALL BE DIVIDED IN HALF. TO DETERMINE THE REQUIRED NUMBER OF FIXTURES, THE FIXTURE RATIO OR RATIOS FOR FIXTURE TYPE SHALL BE APPLIED TO THE OCCUPANT LOAD OF EACH SEX IN ACCORDANCE WITH TABLE 403.1

2018 EXISTING INTERNATIONAL BUILDING CODE 610.1 MINIMUM FIXTURES:  
WHERE THE OCCUPANT LOAD OF THE STORY IS INCREASED BY 20 PERCENT, PLUMBING FIXTURES FOR THE STORY SHALL BE PROVIDED IN QUANTITIES SPECIFIED IN THE INTERNATIONAL PLUMBING CODE BASED ON THE INCREASED OCCUPANT LOAD.

BUILDING REQUIREMENTS

EXISTING OCCUPANCY

840 OCC / 2 = 420 MALE AND 420 FEMALE

URINAL / WATER CLOSETS - 9 EXISTING  
LAVATORIES - 7 EXISTING  
DRINKING FOUNTAINS - 1 EXISTING  
SERVICE SINKS - 1 EXISTING

NEW FIXTURES  
WATER CLOSETS - 9  
LAVATORIES - 7  
DRINKING FOUNTAINS - 1  
SERVICE SINKS - 1

PROJECT SUMMARY	
THE PROPOSED PROJECT IS AT THE EXISTING BOYS & GIRLS CLUB OF LANCASTER - JACK WALKER CLUBHOUSE LOCATED AT 229 W LEMON ST, LANCASTER, PA 17603	THE PROJECT CONSISTS OF RENOVATION OF THE EXISTING RESTROOMS, REMOVAL AND REPLACEMENT OF EXTERIOR STAIRS AND RAMPS, AND ROOF REPLACEMENT. THE INTERIOR RENOVATIONS WILL INCLUDE NEW WALLS, DOORS, TOILET FIXTURES AND ACCESSORIES, AND FINISHES. THE EXTERIOR RENOVATIONS WILL INCLUDE NEW CONCRETE STAIRS AND RAMPS WITH ASSOCIATED STEEL GUARDRAILS, AND ROOF REPLACEMENT. CIVIL, PLUMBING, MECHANICAL, AND ELECTRICAL. SCOPE WILL ALSO BE INCLUDED.

RENOVATION TO  
**JACK WALKER CLUBHOUSE**  
BOYS & GIRLS CLUB  
229 W LEMON ST, LANCASTER, PA 17603

ISSUE DATES	DESCRIPTION:
DATE:	BID DOCUMENTS
10/01/2024	

PROJ #: 24-80-01 DRAWN BY: SAB  
SHEET TITLE:  
**COVER SHEET**  
CS1  
BID

SEAL:  
CONSULTANT:

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GENERAL STRUCTURAL NOTES:

- 1. The drawings shall be used in conjunction with the drawings of all other disciplines. The contractor shall verify the requirements of other trades as to sleeves, chases, hangers, inserts, anchors, holes and other items to be placed or set in the structural work.
2. The contractor shall be responsible for complying with all safety precautions and regulations during the work. The engineer will not advise on nor issue direction as to safety precautions and programs.
3. The structural drawings herein represent the finished structure. The contractor shall provide all temporary shoring, guying and bracing required to erect and hold the structure in proper alignment until all structural work and connections have been completed.
4. The engineer shall not be responsible for the methods, techniques and sequences of procedures to perform the work. The supervision of the work is the sole responsibility of the contractor.
5. Drawings indicate general and typical details of construction. Where conditions are not specifically shown, similar details of construction shall be used, subject to approval by the engineer.
6. Loading applied to the structure during the process of construction shall not exceed the safe load-carrying capacity of the structural members. The live loadings used in the design of this structure are indicated in the "Design Criteria Notes". Do not apply any construction loads until structural framing is properly connected together and until all temporary bracing is in place.
7. All ASTM and other references are per the latest editions of these standards, unless otherwise noted.
8. In accordance with Section 1704 of IBC 2018, special inspections will be required for this project. Special inspections shall be performed in accordance with the "Schedule of Special Inspections". All fabricators shall satisfy the "Exception" noted in section 1704.2.5.1, which requires the fabricator to maintain an agreement with an approved independent inspection or quality control agency. The contractor shall notify the special inspector at least 48 hours in advance for work that will require inspection or testing.
9. Unless otherwise indicated, all items noted to be demolished shall become the contractor's property and be removed from the site.
10. Contractors shall visit the site prior to bid to ascertain conditions which may adversely affect the work or cost thereof.

DESIGN CRITERIA NOTES:

- 1. The intended design standards and/or criteria are as follows:
General: Uniform statewide bidg. code (IBC 2018, Chapter 16 as amended)
Concrete: ACI 318-14
2. Design gravity dead loads used in the design of this structure are as follows (refer to IBC 2018 section 1606):
All other Actual weight
3. Design gravity live loads used in the design of this structure are as follows (refer to IBC 2018 section 1607):
Concrete Ramps & Stairs 100 PSF
4. The structure has been designed as Risk Category II in accordance with IBC 2018 table 1604.5.
5. This structure has been designed with "safety factors" in accordance with generally accepted principles of structural engineering. The fundamental nature of the "safety factor" is to compensate for uncertainties in the design, fabrication and erection of structural building components. It is intended that "safety factors" be used so that the load carrying capacity of the structure does not fall below the design load and that the building will perform under design load without distress. While the use of "safety factors" implies some excess capacity beyond design load, such excess capacity cannot be adequately predicted and SHALL NOT BE RELIED UPON.

EXISTING CONSTRUCTION NOTES:

- 1. Before proceeding with any work within the existing facility, the contractor shall familiarize himself with existing structural and other conditions. It shall be the contractor's responsibility to provide all necessary bracing, shoring and other safeguards to maintain all parts of the existing work in a safe condition during the process of demolition and construction and to protect from damage those portions of the existing work which are to remain.
2. The contractor shall field verify the dimensions, elevations, etc. necessary for the proper construction and alignment of the new portions of the work to the existing work. The contractor shall make all measurements necessary for fabrication and erection of structural members. Any discrepancy shall be immediately brought to the attention of the engineer.
DEMOLITION NOTES:
1. The contractor is to obtain and pay for all necessary permits for the demolition and removal work required.
2. Demolition procedures, shoring requirements, sequences, techniques, etc. either given in or implied by these drawings are suggestions only.
3. Prior to undertaking any demolition work, the contractor shall ascertain, by survey, the existing conditions of the property and the extent of the demolition work involved.
4. The contractor shall perform all demolition work in such a manner as to protect the existing structure and be responsible to properly repair any damage which may occur as a result of his demolition work. If the contractor damaged the existing structure to remain, he shall notify the owner and engineer immediately and for all repair costs, including design and inspection expenses.
5. The contractor shall cease demolition operations and notify the owner and engineer immediately if it appears that the integrity of the structure has been affected by the demolition work.
6. The contractor shall not cut or alter any structural members to remain without written authorization by the engineer or as indicated on the structural drawings.
7. All existing dimensions (distances, elevations, member sizes, etc.) shown on the drawings shall be verified in the field by the contractor.
8. The contractor shall provide a temporary platform to catch debris from slab removal. Do not allow resulting debris to accumulate in the work area. All debris shall be disposed of in a legal manner with as little disturbance to adjacent spaces and occupants as possible.
9. Cutting of existing concrete slabs shall be performed in a neat professional manner. Drill corners and saw cut straight lines around the perimeter of the new opening.

SUBGRADE PREPARATION NOTES:

- 1. All site preparation shall conform to the requirements of IBC 2018 Chapter 18.
2. Within an area a minimum of 5 feet beyond the building limits, excavate a minimum of 4" of existing soil. Remove all organics, pavement, roots, debris and otherwise unsuitable material.
3. The surface of the exposed subgrade shall be inspected by probing or testing to check for pockets of soft or unsuitable material. Excavate unsuitable soil as directed by the geotechnical engineer/testing agency.
4. Fill all excavated areas with approved controlled fill. Place in 8 inch loose lifts and compact to a minimum of 95% of the maximum dry density in accordance with ASTM D-698.
5. All controlled fill material shall be a select granular material free from all organics or otherwise deleterious material with not more than 20% by weight passing a No. 200 sieve (classified as SC, SM, SP or better in accordance with the unified soil classification system) and with a plasticity index not exceeding 6%.
6. Provide field density tests for each 3,000 s.f. of building area for each lift of controlled fill.

FOUNDATION NOTES:

- 1. All foundation construction shall conform to the requirements of IBC 2018 Chapter 18.
2. All footings have been designed based upon an assumed soil bearing pressure of 3,000 psf. All footings shall bear on undisturbed, firm natural soil or compacted fill. All foundation excavations shall be evaluated by the geotechnical engineer/testing agency prior to pouring foundation concrete.
3. Top of footing elevation shall be as shown on the foundation plan. These elevations are a maximum and shall be lowered as required to obtain the required design bearing pressure or lowered below new or existing utilities per typical details.
4. All foundation concrete shall obtain a 28 day compressive strength of 4,000 psi. All concrete to be permanently exposed to weather shall be air entrained to 5% (+-1%) with an admixture that conforms to ASTM C-260.
5. All concrete work shall conform to the requirements of ACI 301, "Specification for Structural Concrete Buildings". Hot weather concreting shall be in accordance with ACI 305. Cold weather concreting shall be in accordance with ACI 306.
6. All reinforcing steel shall conform to ASTM A-615, Grade 60. Reinforcing shall be detailed and installed per ACI 315 and CRSI Manual of Standard Practice.
7. Unless otherwise noted, the following concrete cover shall be provided for reinforcement:
A) Concrete cast against and permanently exposed to earth: 3"
B) Concrete exposed to earth or weather: #6 through #18 bars: 2" #5 bar, W31 or D31 wire and smaller: 1-1/2"
8. All reinforcing marked continuous (cont.) on the plans and details shall be lapped 36xbar diameters at splices unless otherwise noted.
9. No unbalanced backfilling shall be placed against foundation walls unless walls are securely braced against overturning, either by temporary bracing or by permanent construction.
10. Prior to commencing any foundation work, coordinate work with any existing utilities. Foundations shall be lowered where required to avoid utilities.

SLAB ON GRADE NOTES:

- 1. Slab-on-grade construction shall conform to the requirements of ACI 301, "Specification for Structural Concrete Buildings" and IBC 2018 Section 1907.
2. Provide concrete slabs as indicated on plans over 4" of porous fill as follows:
4" slab reinforced with 6x6-W14xW4 welded wire fabric and with 4000 psi mix concrete
Maximum slump for all concrete slabs shall be 5 inches, using type 1 cement.
3. All welded wire fabric shall be in accordance with ASTM A-1064. Lap adjoining pieces at least one full mesh.
4. All porous fill material shall be a clean granular material with 100% passing a 1-1/2" sieve and no more than 5% passing a no. 4 sieve. Porous fill shall be compacted to 95% max. dry density per ASTM D-698.
5. Slab joints shall be filled with approved material. This should take place as late as possible, preferably 4 to 6 weeks after the slab has been cast. Prior to filling, remove all debris from the slab joints, then fill in accordance with the manufacturer's recommendations as follows: fill with field molded or elastomeric sealant.
6. Unless otherwise approved, all welded wire fabric shall be blocked into the position indicated with precast concrete blocks having a compressive strength equal to that of the slab.
7. Slabs to be permanently exposed to weather shall be air entrained to 5% (+-1%) with an admixture that conforms to ASTM C-260.
8. In order to avoid concrete shrinkage cracking, the maximum length of slab cast in any one continuous pour is recommended to be less than 100 feet. The maximum spacing of joints shall be 12'.
9. The alternate wires of the welded wire fabric must be pre-cut at the slab contraction joint locations to create a "weakened plane". Without cutting the alternate wires, the strength of the wire will prevent the slab from cracking (separating) at the joint and the slab may begin to crack elsewhere.
10. The use of polypropylene fibers (in lieu of welded wire fabric) is prohibited without the written authorization of the engineer.

CAST-IN-PLACE CONCRETE NOTES:

- 1. Concrete mixes shall be designed per ACI 301, using Portland cement conforming to ASTM C-150 or C-595, aggregate conforming to ASTM C-33, and admixtures conforming to ASTM C-494, C-1017, C-618, C-989 and C-260. Concrete shall be ready-mixed in accordance with ASTM C-94.
2. Concrete shall conform to the following compressive strength, slump and water/cement ratio requirements:
Concrete Min. Fc (28 days) Slump\* W/C ratio
Concrete not noted 3000 psi#2 to 4" 50 Foundation See Fdn. Notes 2" to 4" 50 Slabs-on-grade See "Slab-on-Grade Notes" 50
\*At contractor's option, an approved admixture may be used to produce flowable concrete. Maximum slump shall not exceed 10 inches. The contractor shall submit test results of the proposed concrete mixes along with the manufacturer's technical data for approval prior to pouring concrete.
3. All concrete work shall conform to the requirements of ACI 301, "Specification for Structural Concrete Buildings" and IBC 2018 Chapter 19. Hot weather concreting shall be in accordance with ACI 305. Cold weather concreting shall be in accordance with ACI 306.
4. All reinforcing steel shall conform to ASTM A-615, grade 60. Reinforcing steel shall be detailed and installed per ACI 315 and CRSI Manual of Standard Practice.
5. All welded wire fabric (W.W.F.) shall conform to ASTM A-1064.
6. All reinforcing steel shall be set and tied in place prior to pouring of concrete, except that vertical dowels for masonry wall reinforcing may be "floating" in place. Do not field bend bars partially embedded in hardened concrete unless specifically indicated or approved by the engineer.
7. Reinforcing steel, including hooks and bends, shall be detailed in accordance with ACI 315. All reinforcing steel indicated as being continuous (cont) shall be lapped with a type 2 lap splice unless otherwise noted.
8. Unless otherwise noted, the following concrete cover shall be provided for reinforcement:
A) Concrete exposed to earth or weather: #6 through #18 bars: 2" #5 bar, W31 or D31 wire and smaller: 1-1/2"
B) Foundation concrete (see "Foundation Notes")
9. Bar supports and holding bars shall be provided for all reinforcing steel to insure minimum concrete cover. Bar supports shall be plastic tipped or stainless steel.
10. All edges of permanently exposed concrete surfaces shall be chamfered 3/4" unless otherwise noted.
11. In accordance with IBC 2018, special inspections are required for the concrete work. The owner will hire the special inspector to perform all required special inspections.
12. Formwork shall remain in place until concrete has obtained at least 90% of its 28 day compressive strength. The contractor shall provide all shoring and reshoring.
POST-INSTALLED ANCHOR NOTES:
1. Except where indicated on the drawings, post-installed anchors shall consist of the following anchor types as provided by HILTI, Inc. Contact HILTI at (800) 679-8000 for product related questions.
A. Resin doweling into concrete
1. Adhesive anchors for cracked and uncracked concrete use:
A. HILTI HIT-HY 200 safe set system with HILTI hollow drill bit and vacuum with continuously deformed rebar per ICC ESR-319
2. Basis of design includes the following design parameters:
A. Cracked concrete
B. Water-saturated concrete
C. Base material temperature of 23-104 degrees Fahrenheit
D. Allowable with hammer-drill, hollow drill bit system, and core drilling methods
E. Current ICC-ES report with approval for development of bar using ACI provisions for embedment depths greater than 20 bar diameters
2. Anchor capacity used in design shall be based on the technical data published by HILTI or other such method as approved by the structural engineer of record. Substitution requests for alternate products must be approved in writing by the structural engineer of record prior to use. Contractor shall provide calculations that have been sealed by another licensed engineer demonstrating that the substituted product is capable of meeting the performance of the specified product. Substitutions will be evaluated by their having an ICC ESR showing compliance with the relevant building code for seismic uses, load resistance, installation category, and availability of comprehensive installation instructions. Adhesive anchor evaluation will also consider creep, in-service temperature, installation temperature, moisture condition of concrete, and drilling methods.
3. Use of diamond core bit with roughening tool for anchor holes requires approval from engineer of record prior to drilling. Unless otherwise shown in the drawings, all holes shall be drilled perpendicular to the concrete surface.
4. Install anchors per the manufacturer's printed installation instructions, as included in the anchor packaging.
5. Overhead adhesive anchors must be installed using the HILTI Profi Piston Plug System.
6. ACI/CRSI adhesive anchor installer certification is required for all installers of adhesive anchors in horizontal or upwardly inclined orientation. The HILTI Adhesive Anchor Installer Certification Program (HAAACP) is an approved equivalent.
7. The contractor shall arrange an anchor manufacturer's representative to provide onsite installation training for all anchor products specified. The structural engineer of record must provide documented confirmation that all personnel who install anchors are trained prior to the commencement of anchor installation.
8. Anchor capacity is dependent upon spacing between adjacent anchors and proximity of anchors to edge of concrete. Install anchors in accordance with spacing and edge clearances indicated on the drawings.
9. Existing reinforcing bars in the concrete structure may conflict with specific anchor locations. Unless noted on the drawings that the bars can be cut, the contractor shall review the existing structural drawings and shall undertake to locate the position of the reinforcing bars at the locations of the concrete anchors by HILTI PS 1000 or other GPR, X-RAY, chipping or other approved means.

GUARDRAIL NOTES:

- 1. Engineer, fabricate, and install handrails and railing systems to comply with requirements of ASTM A-985 for structural performance based on the following:
a. Testing performed according to ASTM A-894 and E 935.
b. Structural computations.
2. Railing System and Handrail Design Live Loads: Engineer, fabricate, and install handrails and railing system to withstand the following structural loads without exceeding the allowable design working stress of the materials involved, including anchors and connections. Apply each load to produce the maximum stress in each of the respective components of each metal fabrication:
a. Top Rail of Guardrail System: Capable of withstanding the following loads applied as indicated:
1. Concentrated load of 200 lbs applied at any point and in any direction.
2. Uniform load of 50 lbs per linear foot applied in any direction.
3. Concentrated and uniform loads above need not be assumed to act concurrently.
b. Handrails Not Serving as Top Rails: Capable of withstanding the following loads applied as indicated.
1. Concentrated load of 200 lbs applied at any point and in any direction.
2. Uniform load of 50 lbs per linear foot applied in any direction.
3. Concentrated and uniform loads above need not to be assumed to act concurrently.
c. Infill Area of Guardrail Systems: Capable of withstanding a horizontal concentrated load of 50 lbs applied to one sq. ft. at any point on the system including panels, intermediate rails, balusters, or other elements composing the infill area.
1. Above load need not be assumed to act concurrently with loads on top rails of railing system in determining stress on guard.
3. Submit Shop drawings detailing fabrication and installation of guardrail systems. Include plans, elevations, sections, and details of the guardrails and their connections. Show anchorage and accessory items.
a. Include delegated design structural analysis data sealed and signed by the qualified professional engineer who was responsible for their preparation.
4. Welding Standards: Comply with applicable provisions of AWS D1.1 "Structural Welding Code-Steel" and AWS D1.3 "Structural Welding Code-Sheet Steel."
a. Certify that each welder has satisfactorily passed AWS qualification tests for welding processed involved and, if pertinent, has undergone recertification.

SCHEDULE OF SPECIAL INSPECTIONS:

SPECIAL INSPECTIONS SHALL BE PROVIDED IN ACCORDANCE WITH THE TABLE(S) BELOW.

Table with 3 columns: TYPE, CONTINUOUS SPECIAL INSPECTION, PERIODIC SPECIAL INSPECTION. Rows include: VERIFY MATERIALS BELOW SHALLOW FOUNDATIONS ARE ADEQUATE TO ACHIEVE THE DESIGN BEARING CAPACITY, VERIFY EXCAVATIONS ARE EXTENDED TO PROPER DEPTH AND HAVE REACHED PROPER MATERIAL, PERFORM CLASSIFICATION AND TESTING OF COMPACTED FILL MATERIALS, VERIFY USE OF PROPER MATERIALS, DENSITIES AND LIFT THICKNESSES DURING PLACEMENT AND COMPACTION OF COMPACTED FILL, PRIOR TO PLACEMENT OF COMPACTED FILL, INSPECT SUBGRADE AND VERIFY THAT SITE HAS BEEN PREPARED PROPERLY.

Table with 5 columns: TYPE, CONTINUOUS SPECIAL INSPECTION, PERIODIC SPECIAL INSPECTION, REFERENCED STANDARD, IBC REFERENCE. Rows include: INSPECT REINFORCEMENT AND VERIFY PLACEMENT, REINFORCING BAR WELDING, VERIFY USE OF REQUIRED DESIGN MIX, PRIOR TO CONCRETE PLACEMENT, FABRICATE SPECIMENS FOR STRENGTH TESTS, PERFORM SLUMP AND AIR CONTENT TESTS, AND DETERMINE THE TEMPERATURE OF THE CONCRETE, INSPECT CONCRETE PLACEMENT FOR PROPER APPLICATION TECHNIQUES, VERIFY MAINTENANCE OF SPECIFIED CURING TEMPERATURE AND TECHNIQUES, INSPECT FORMWORK FOR SHAPE, LOCATION AND DIMENSIONS OF THE CONCRETE BEING FORMED.

SEAL:

CONSULTANT:

ISSUE DATES: 10/01/2024

DESCRIPTION: BID DOCUMENTS

PROJ #: 2480C-01 DRAWN BY: MBG

SHEET TITLE: GENERAL STRUCTURAL NOTES & SCHEDULE OF SPECIAL INSPECTIONS SHEET NUMBER:

A0.1

BID




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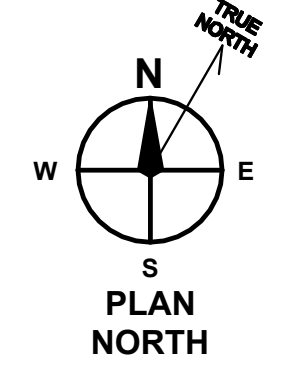
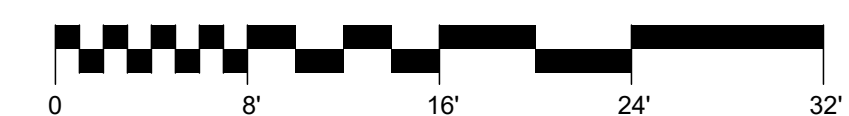
RENOVATION TO JACK WALKER CLUBHOUSE BOYS & GIRLS CLUB 229 W LEMON ST, LANCASTER, PA 17603





SPECIFIC DEMOLITION NOTES - SHEET AD1.1	
03-01	REMOVE CONCRETE LANDING IN ENTIRETY
03-02	REMOVE CONCRETE STAIR CONSTRUCTION AND ASSOCIATED PIPE HAND RAILS.
03-03	REMOVE CONCRETE PIERS
04-01	REMOVE MASONRY WALL CONSTRUCTION. REFER TO ARCHITECTURAL AND STRUCTURAL DWGS. FOR EXTENT AND COORDINATION
05-01	REMOVE METAL GUARDRAILS
05-02	REMOVE METAL COLUMNS & ROOF STRUCTURE
06-01	REMOVE WOOD STAIR CONSTRUCTION AND ASSOCIATED HANDRAILS
06-02	REMOVE WOOD RAMP CONSTRUCTION AND ASSOCIATED HANDRAILS
08-01	REMOVE DOOR, HARDWARE AND FRAME - RESIZE OPENING AS REQ. - REFER TO ARCHITECTURAL DWGS FOR SIZE & EXTENT.
09-01	REMOVE FLOOR FINISH - VCT & RUBBER BASE
09-02	REMOVE EPOXY FLOORING
10-01	REMOVE AND SALVAGE TOILET ACCESSORIES - ENTIRE ROOM
10-02	REMOVE TOILET PARTITIONS - ENTIRE ROOM
11-01	REMOVE WHEELCHAIR LIFT AND ALL ASSOCIATED EQUIPMENT
22-01	REFER TO PLUMBING DRAWINGS FOR REMOVAL OF PLUMBING FIXTURES AND EQUIPMENT
23-01	REFER TO MECHANICAL DRAWINGS FOR REMOVAL OF MECHANICAL EQUIPMENT
26-01	REFER TO ELECTRICAL DRAWINGS FOR REMOVAL OF ELECTRICAL EQUIPMENT

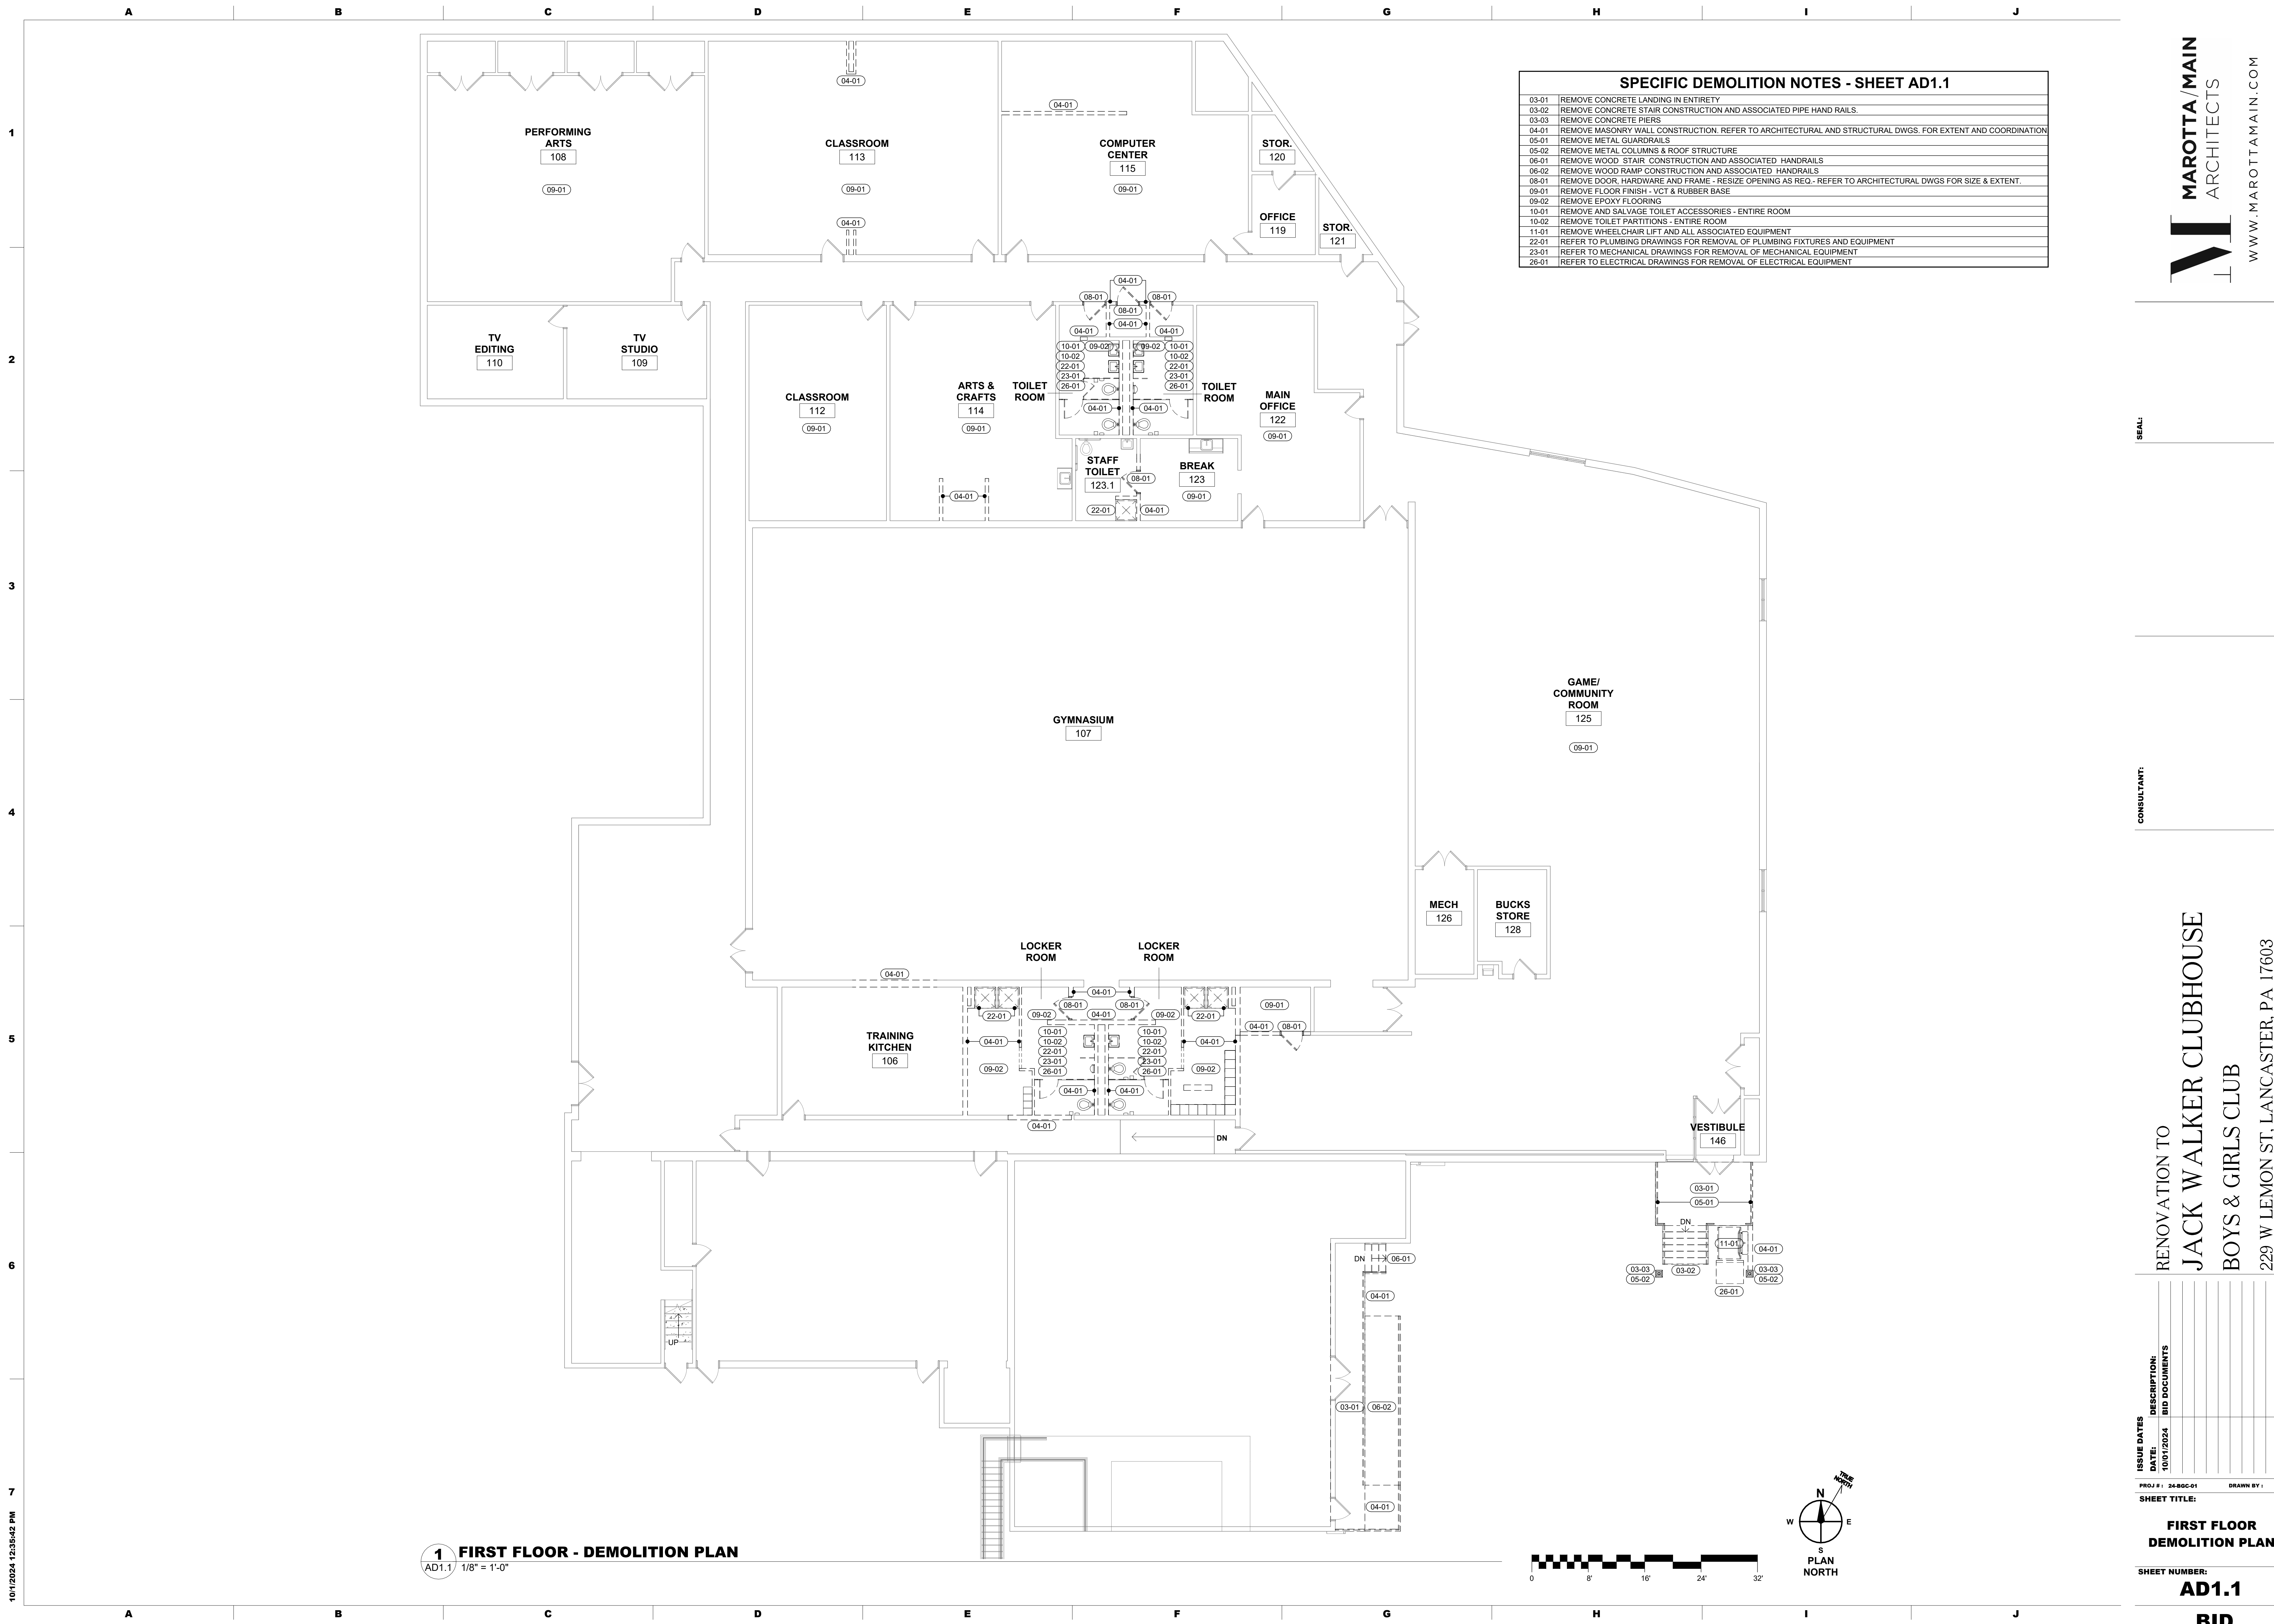**1 FIRST FLOOR - DEMOLITION PLAN**  
AD1.1 1/8" = 1'-0"



GAME/  
COMMUNITY  
ROOM  
125  
09-01

MECH  
126  
BUCKS  
STORE  
128

GYMNASIUM  
107

TRAINING  
KITCHEN  
106

LOCKER ROOM  
LOCKER ROOM

VESTIBULE  
146

MAIN  
OFFICE  
122  
09-01

ARTS &  
CRAFTS  
ROOM  
114  
09-01

CLASSROOM  
112  
09-01

COMPUTER  
CENTER  
115  
09-01

CLASSROOM  
113  
09-01

TV  
EDITING  
110

TV  
STUDIO  
109

PERFORMING  
ARTS  
108  
09-01

OFFICE  
119

STOR.  
121

STOR.  
120

SEAL:

CONSULTANT:

RENOVATION TO  
JACK WALKER CLUBHOUSE  
BOYS & GIRLS CLUB  
229 W LEMON ST, LANCASTER, PA 17603

ISSUE DATES	DESCRIPTION
DATE: 10/01/2024	BID DOCUMENTS

PROJ #: 24-800-01 DRAWN BY: S&B  
SHEET TITLE:

**FIRST FLOOR  
DEMOLITION PLAN**

SHEET NUMBER:  
**AD1.1**

**BID**




**ROOF DEMOLITION NOTES**


- ROOF DEMOLITION**
- 07-01 DEMO CANOPY ENTIRE CONSTRUCTION. REFER TO AD1.1
  - 07-02 DEMO EXISTING EPDM ROOFING SYSTEM, INSULATION, CRICKETS, FLASHING METAL FACIA AND ASSOC. WOOD BLOCKING, EXISTING METAL ROOF DECK. NOT TO BE DISTURBED.
  - 07-03 DEMO EXISTING GUTTERS AND DOWN SPOUTS
  - 07-04 GC TO REMOVE EXISTING MECH CURB - MC TO REMOVE EQUIPMENT. GC TO PROVIDE DECK INFILL. COORDINATE WITH MECH CONTRACTOR REINSTALL.

**ROOF DEMOLITION LEGEND**


- (E) RD EXISTING ROOF DRAIN
- (E) V EXISTING VENT PIPE. REFER TO PLUMBING DRAWINGS FOR REMOVAL. IN-FILL OPENING FOR FUTURE ROOF.
- EXISTING ROOF TOP EQUIPMENT AND CURBS (VARIOUS SIZES). REMOVE ROOF CURBS AND IN-FILL OPENING FOR FUTURE ROOF.
- EXISTING ROOF TOP EQUIPMENT AND WOOD RAILS (VARIOUS SIZES). REMOVE ROOF RAILS FOR FUTURE ROOF.

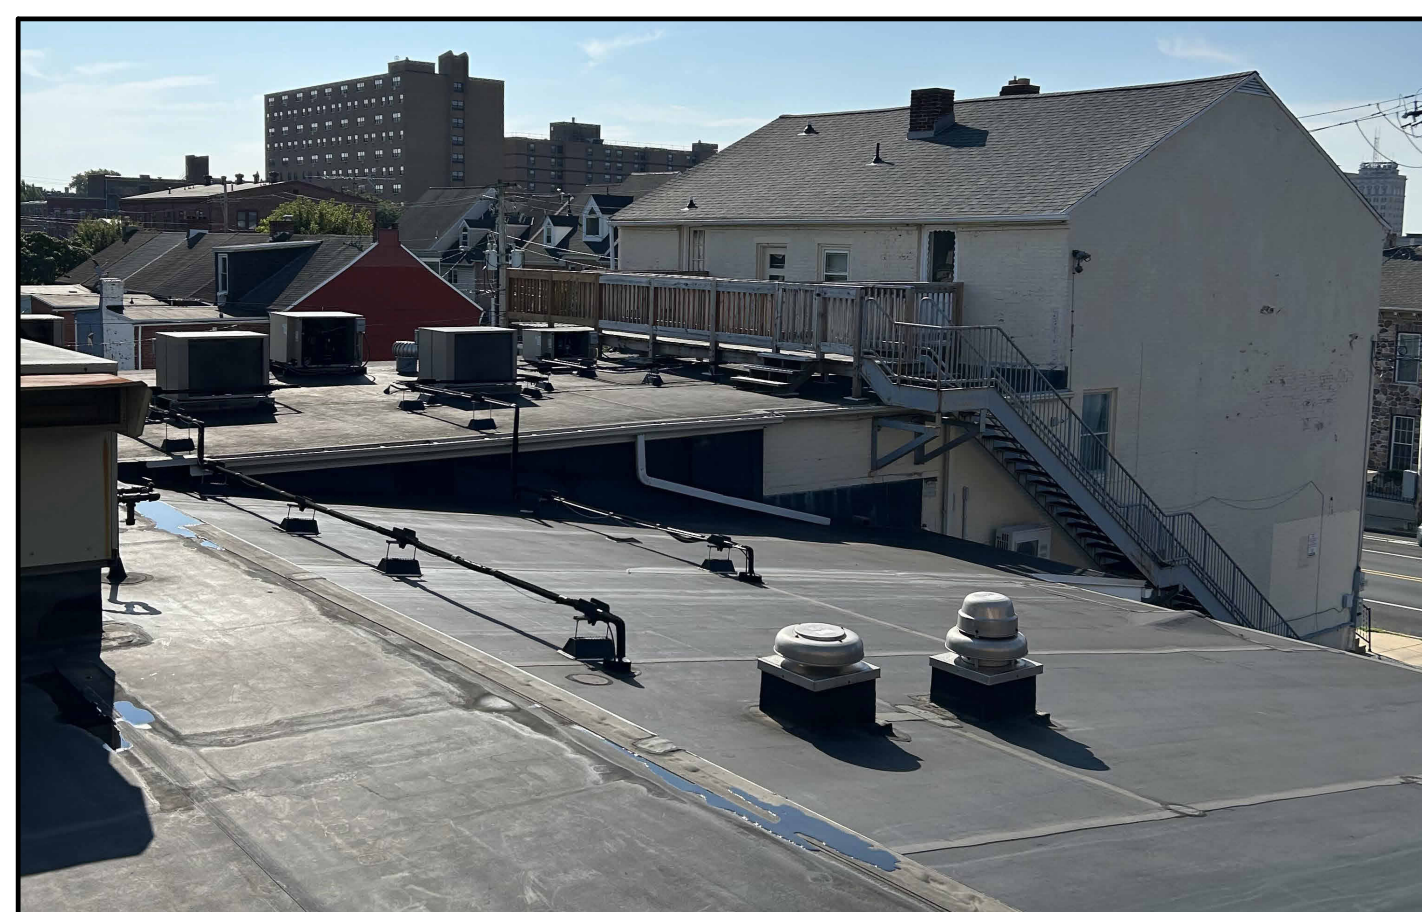



**EXISTING CONDITION PHOTO 01**

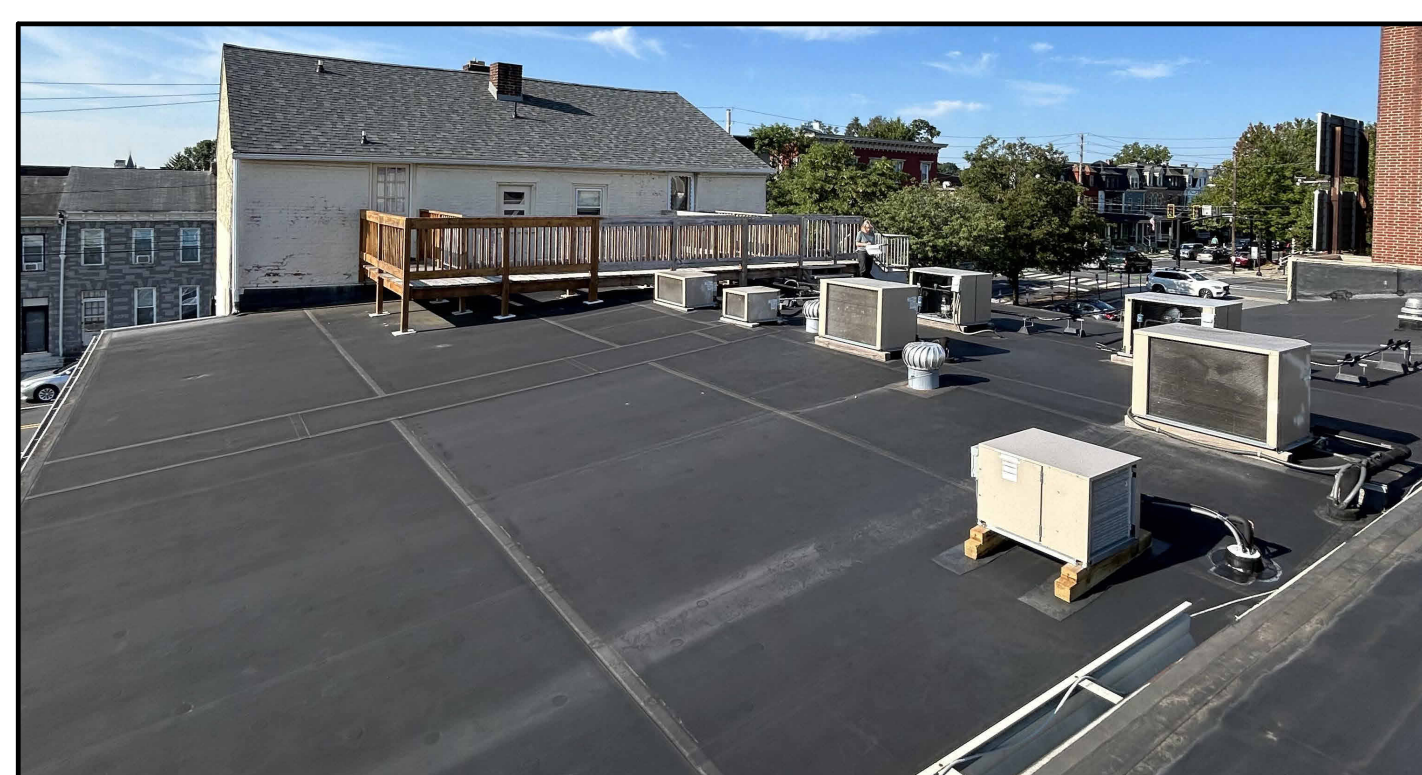

**EXISTING CONDITION PHOTO 02**

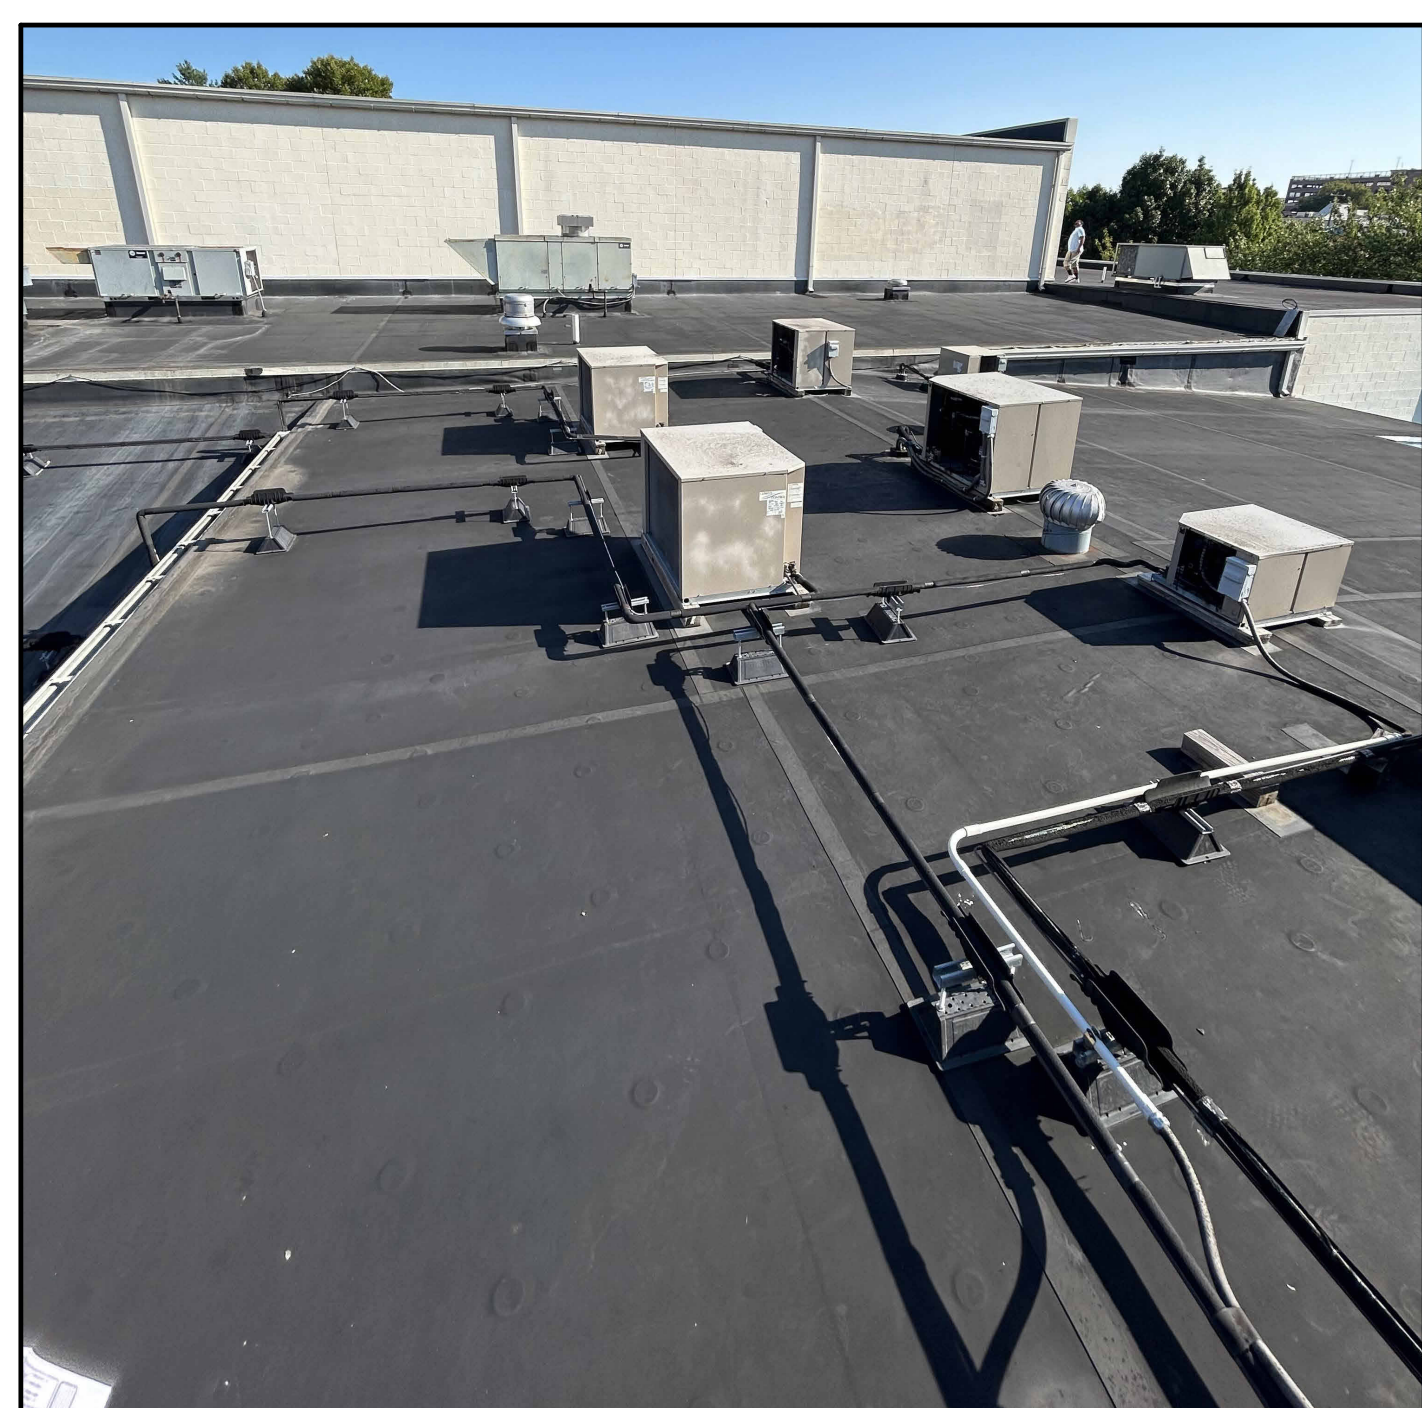

**EXISTING CONDITION PHOTO 03**

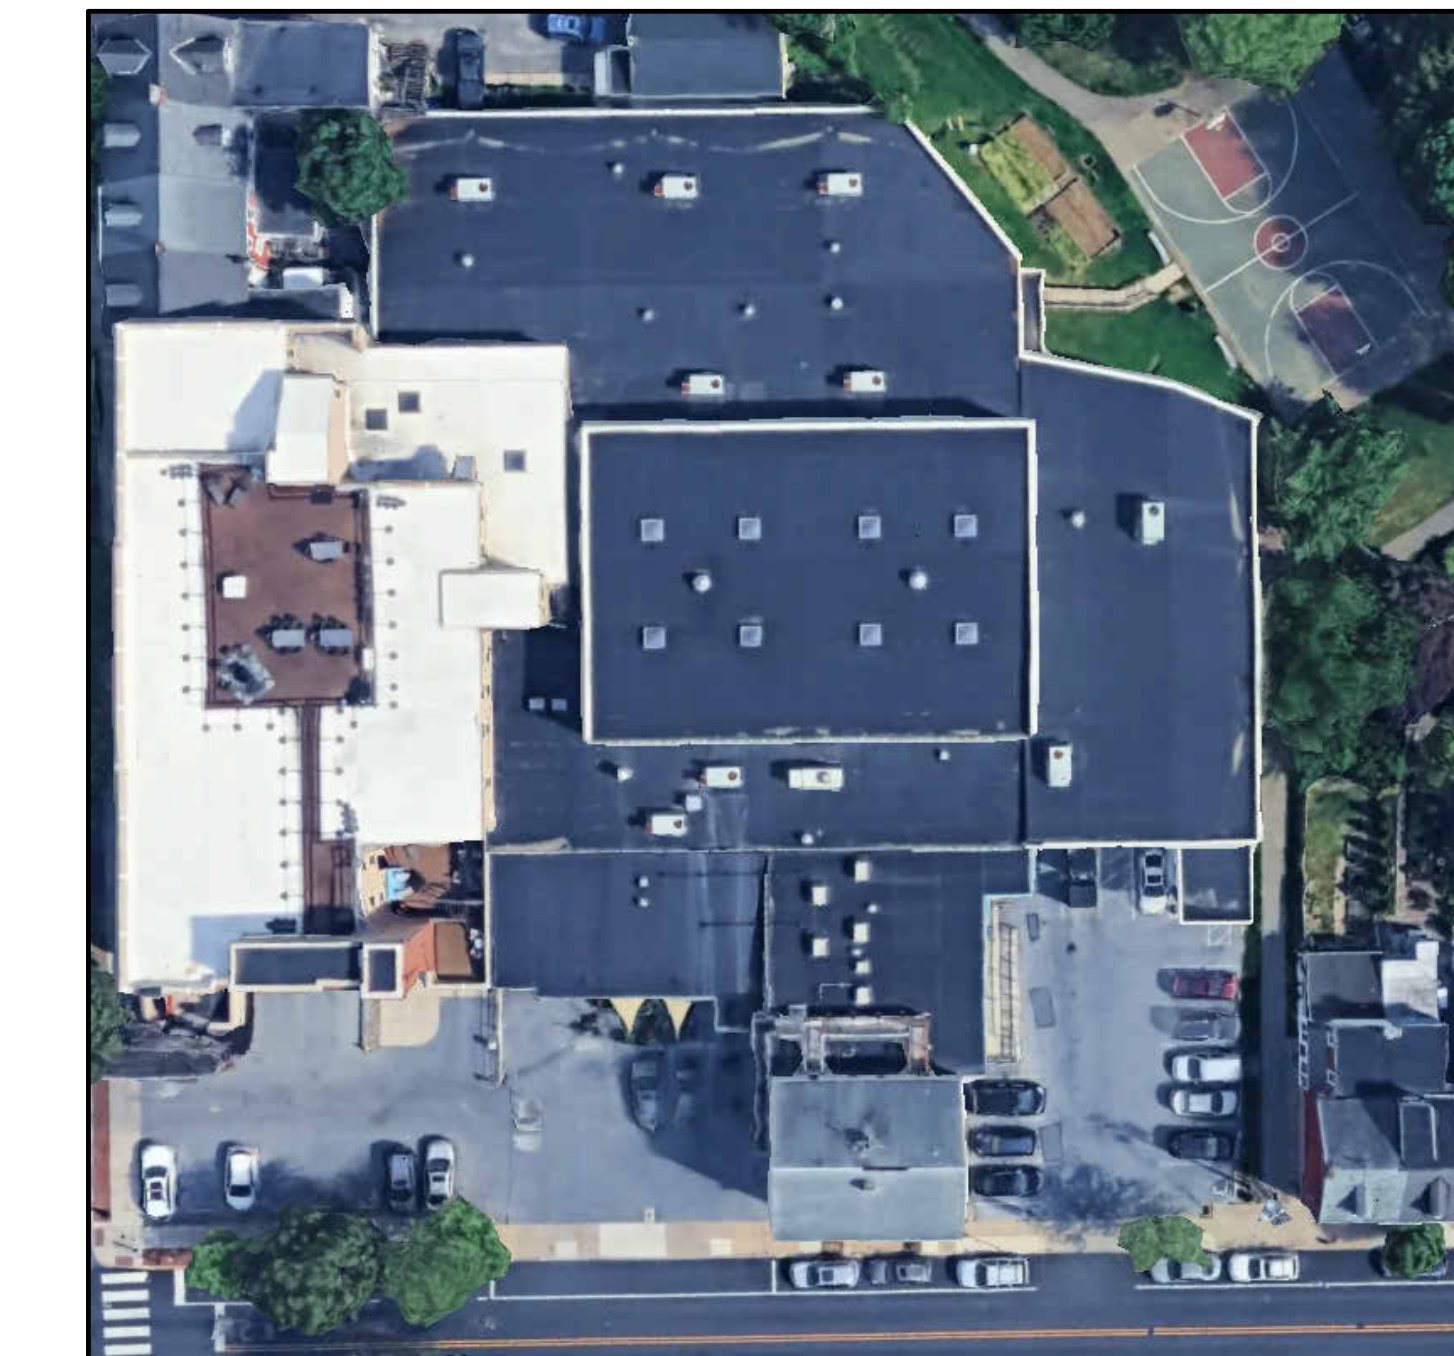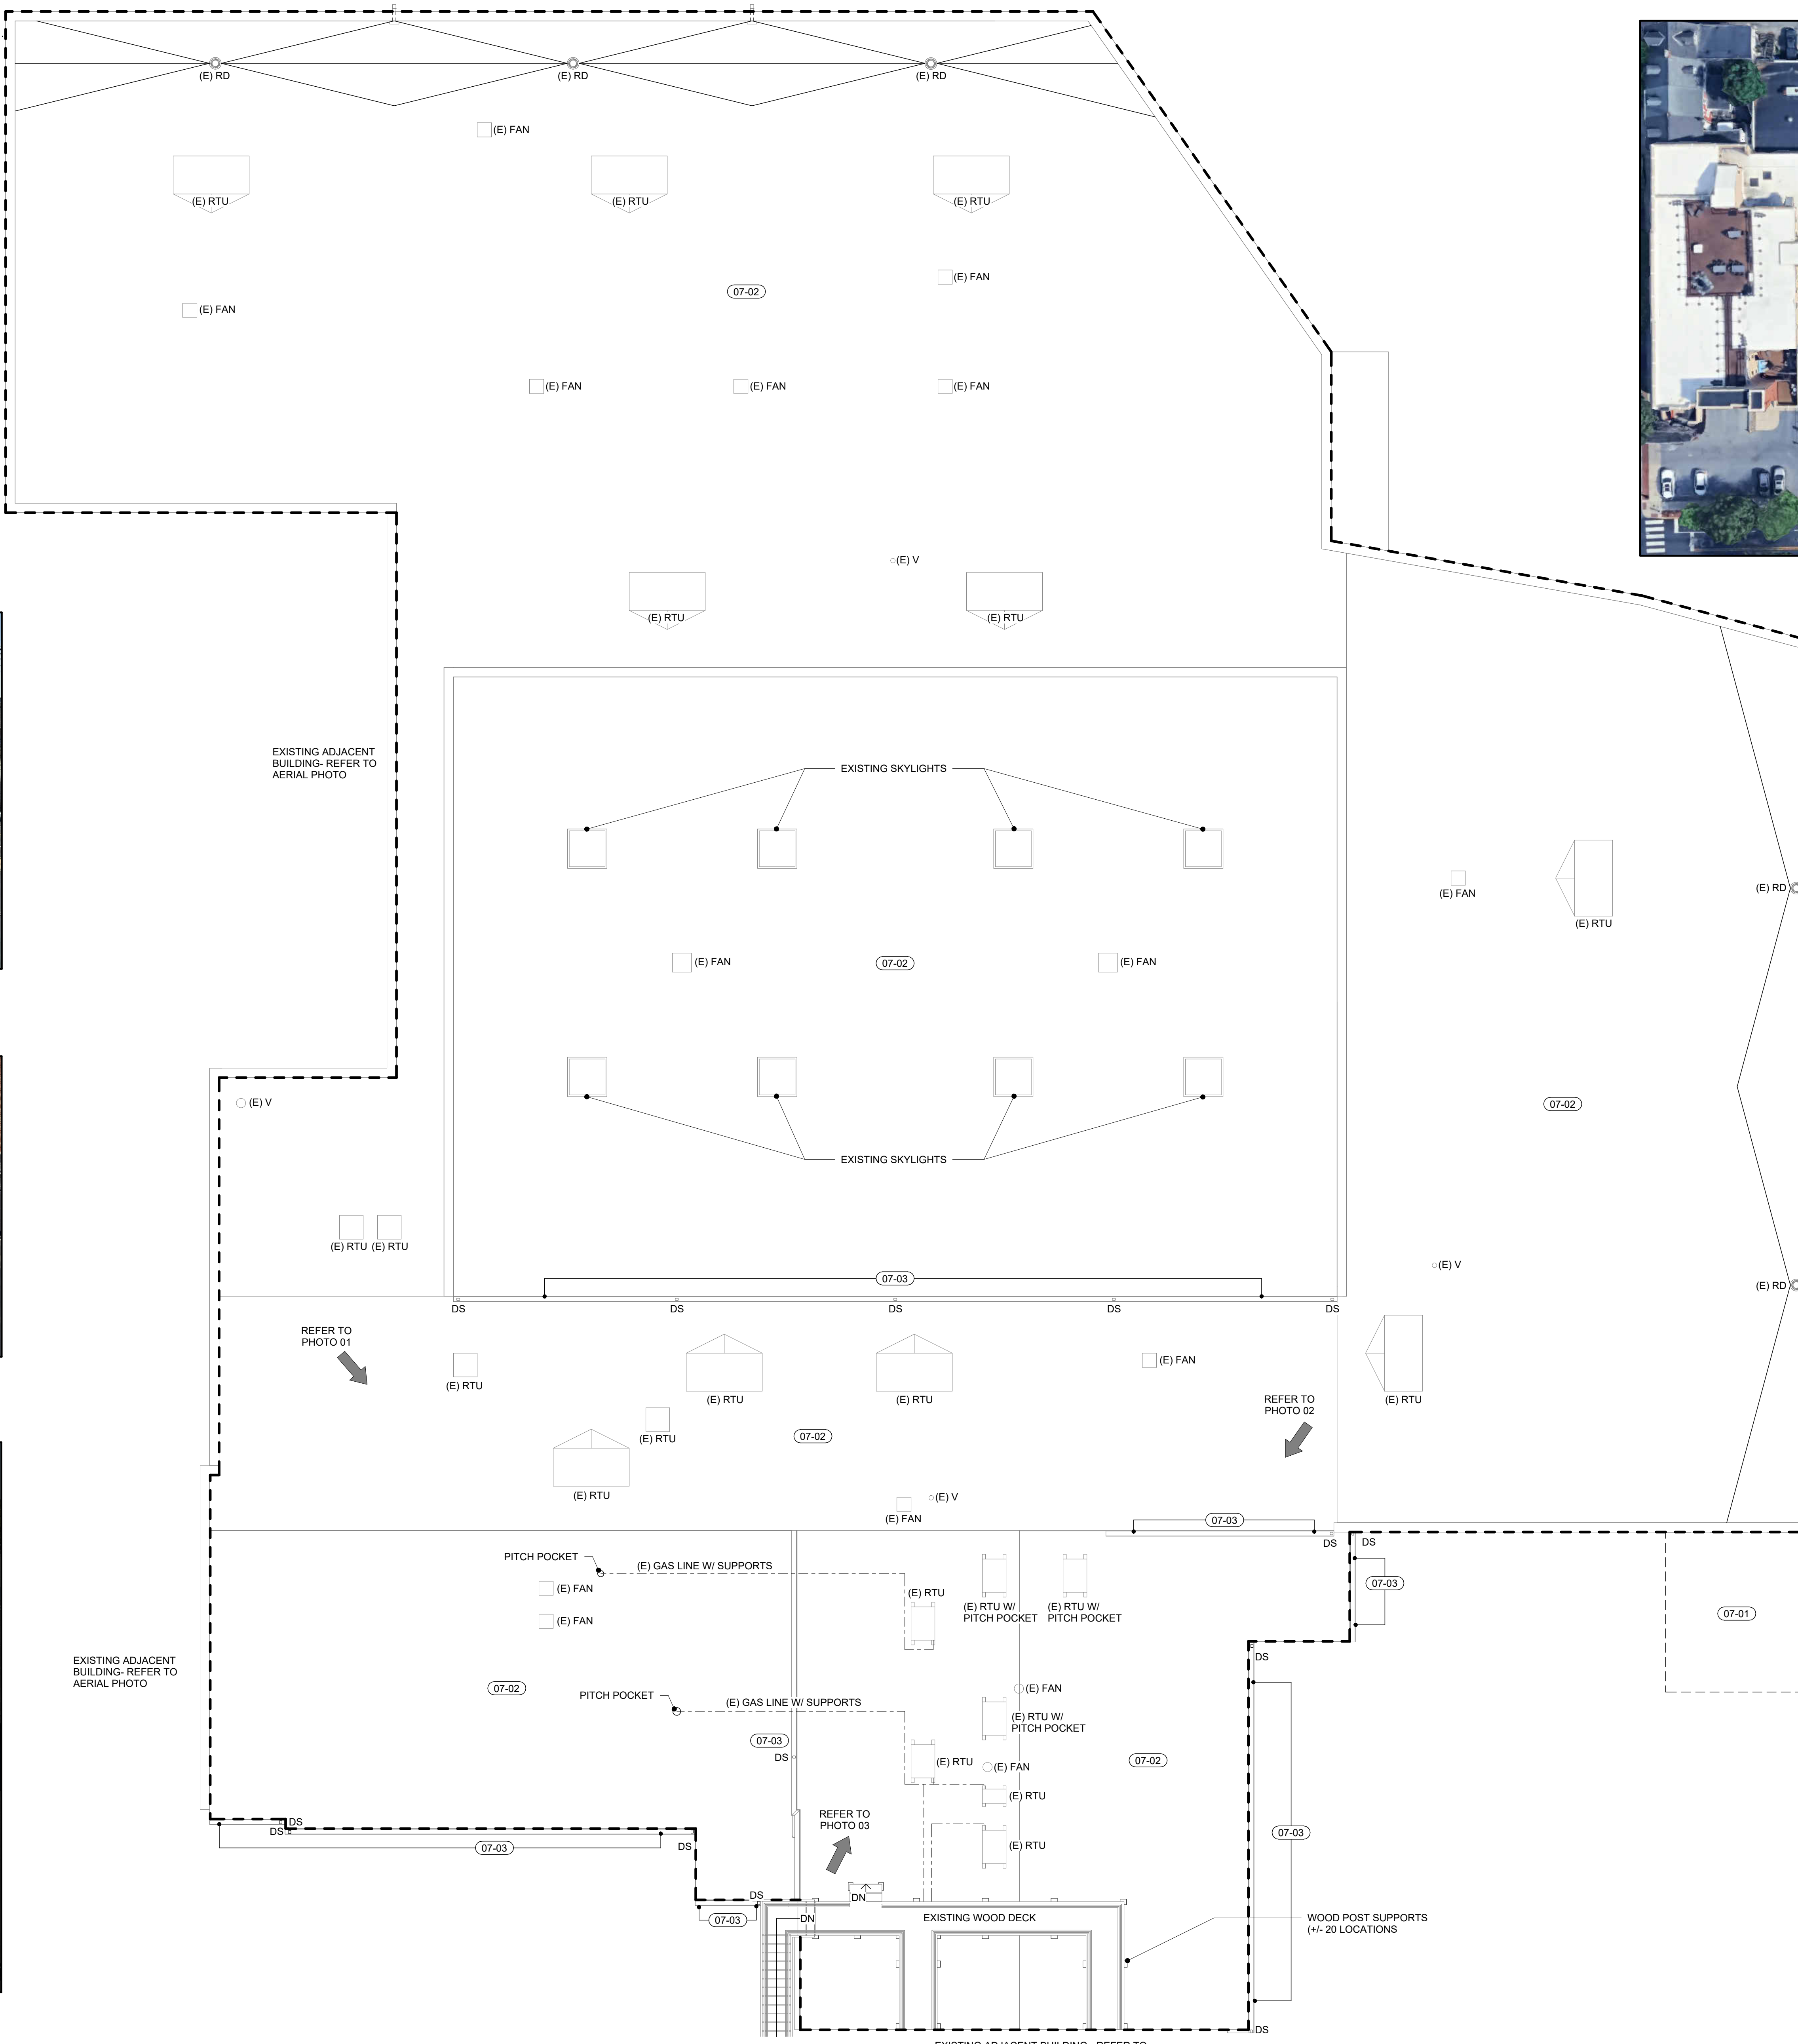

**AERIAL SITE PHOTO**

**1 ROOF DEMOLITION PLAN**  
AD1.2 1/8" = 1'-0"



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SEAL: \_\_\_\_\_  
CONSULTANT: \_\_\_\_\_

RENOVATION TO  
**JACK WALKER CLUBHOUSE**  
**BOYS & GIRLS CLUB**  
229 W LEMON ST, LANCASTER, PA 17603

ISSUE DATES	DESCRIPTION	PROJ #	DATE	ISSUE	DRAWN BY
	BID DOCUMENTS	24-80C-01	10/1/2024	01	SAB
<b>ROOF DEMOLITION PLAN</b>					
SHEET NUMBER: <b>AD1.2</b>					
<b>BID</b>					

10/1/2024 12:35:45 PM














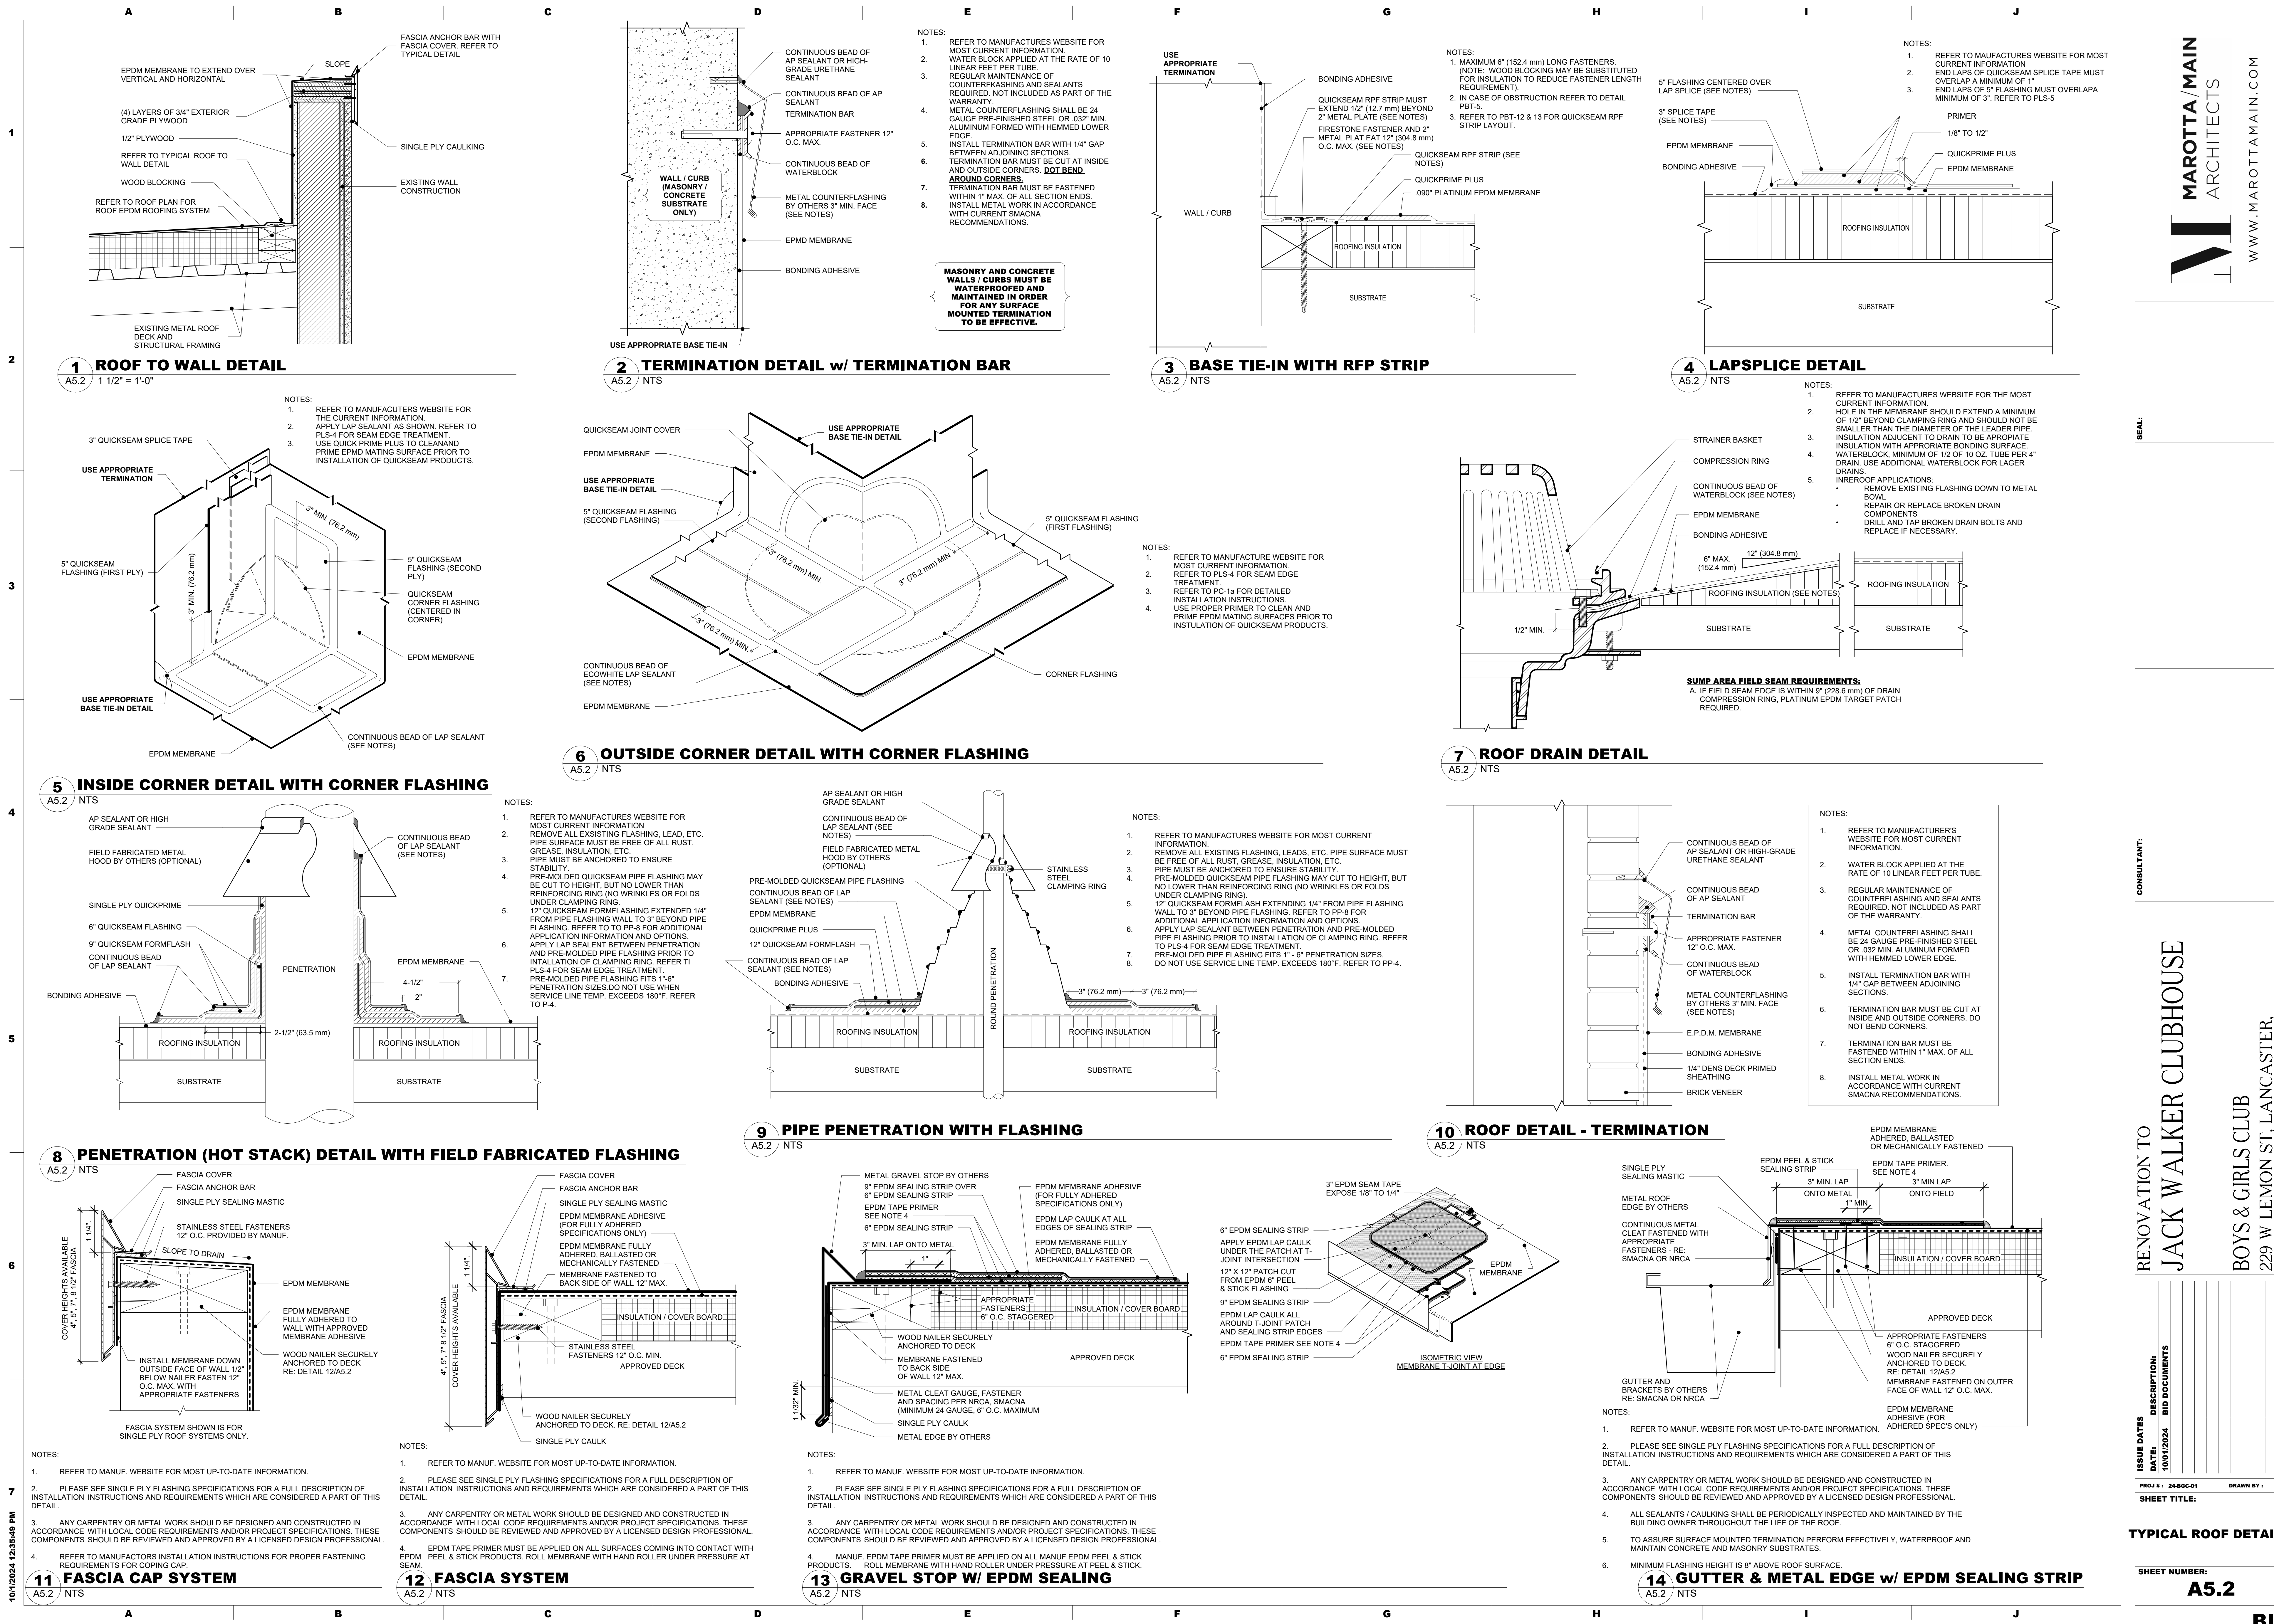




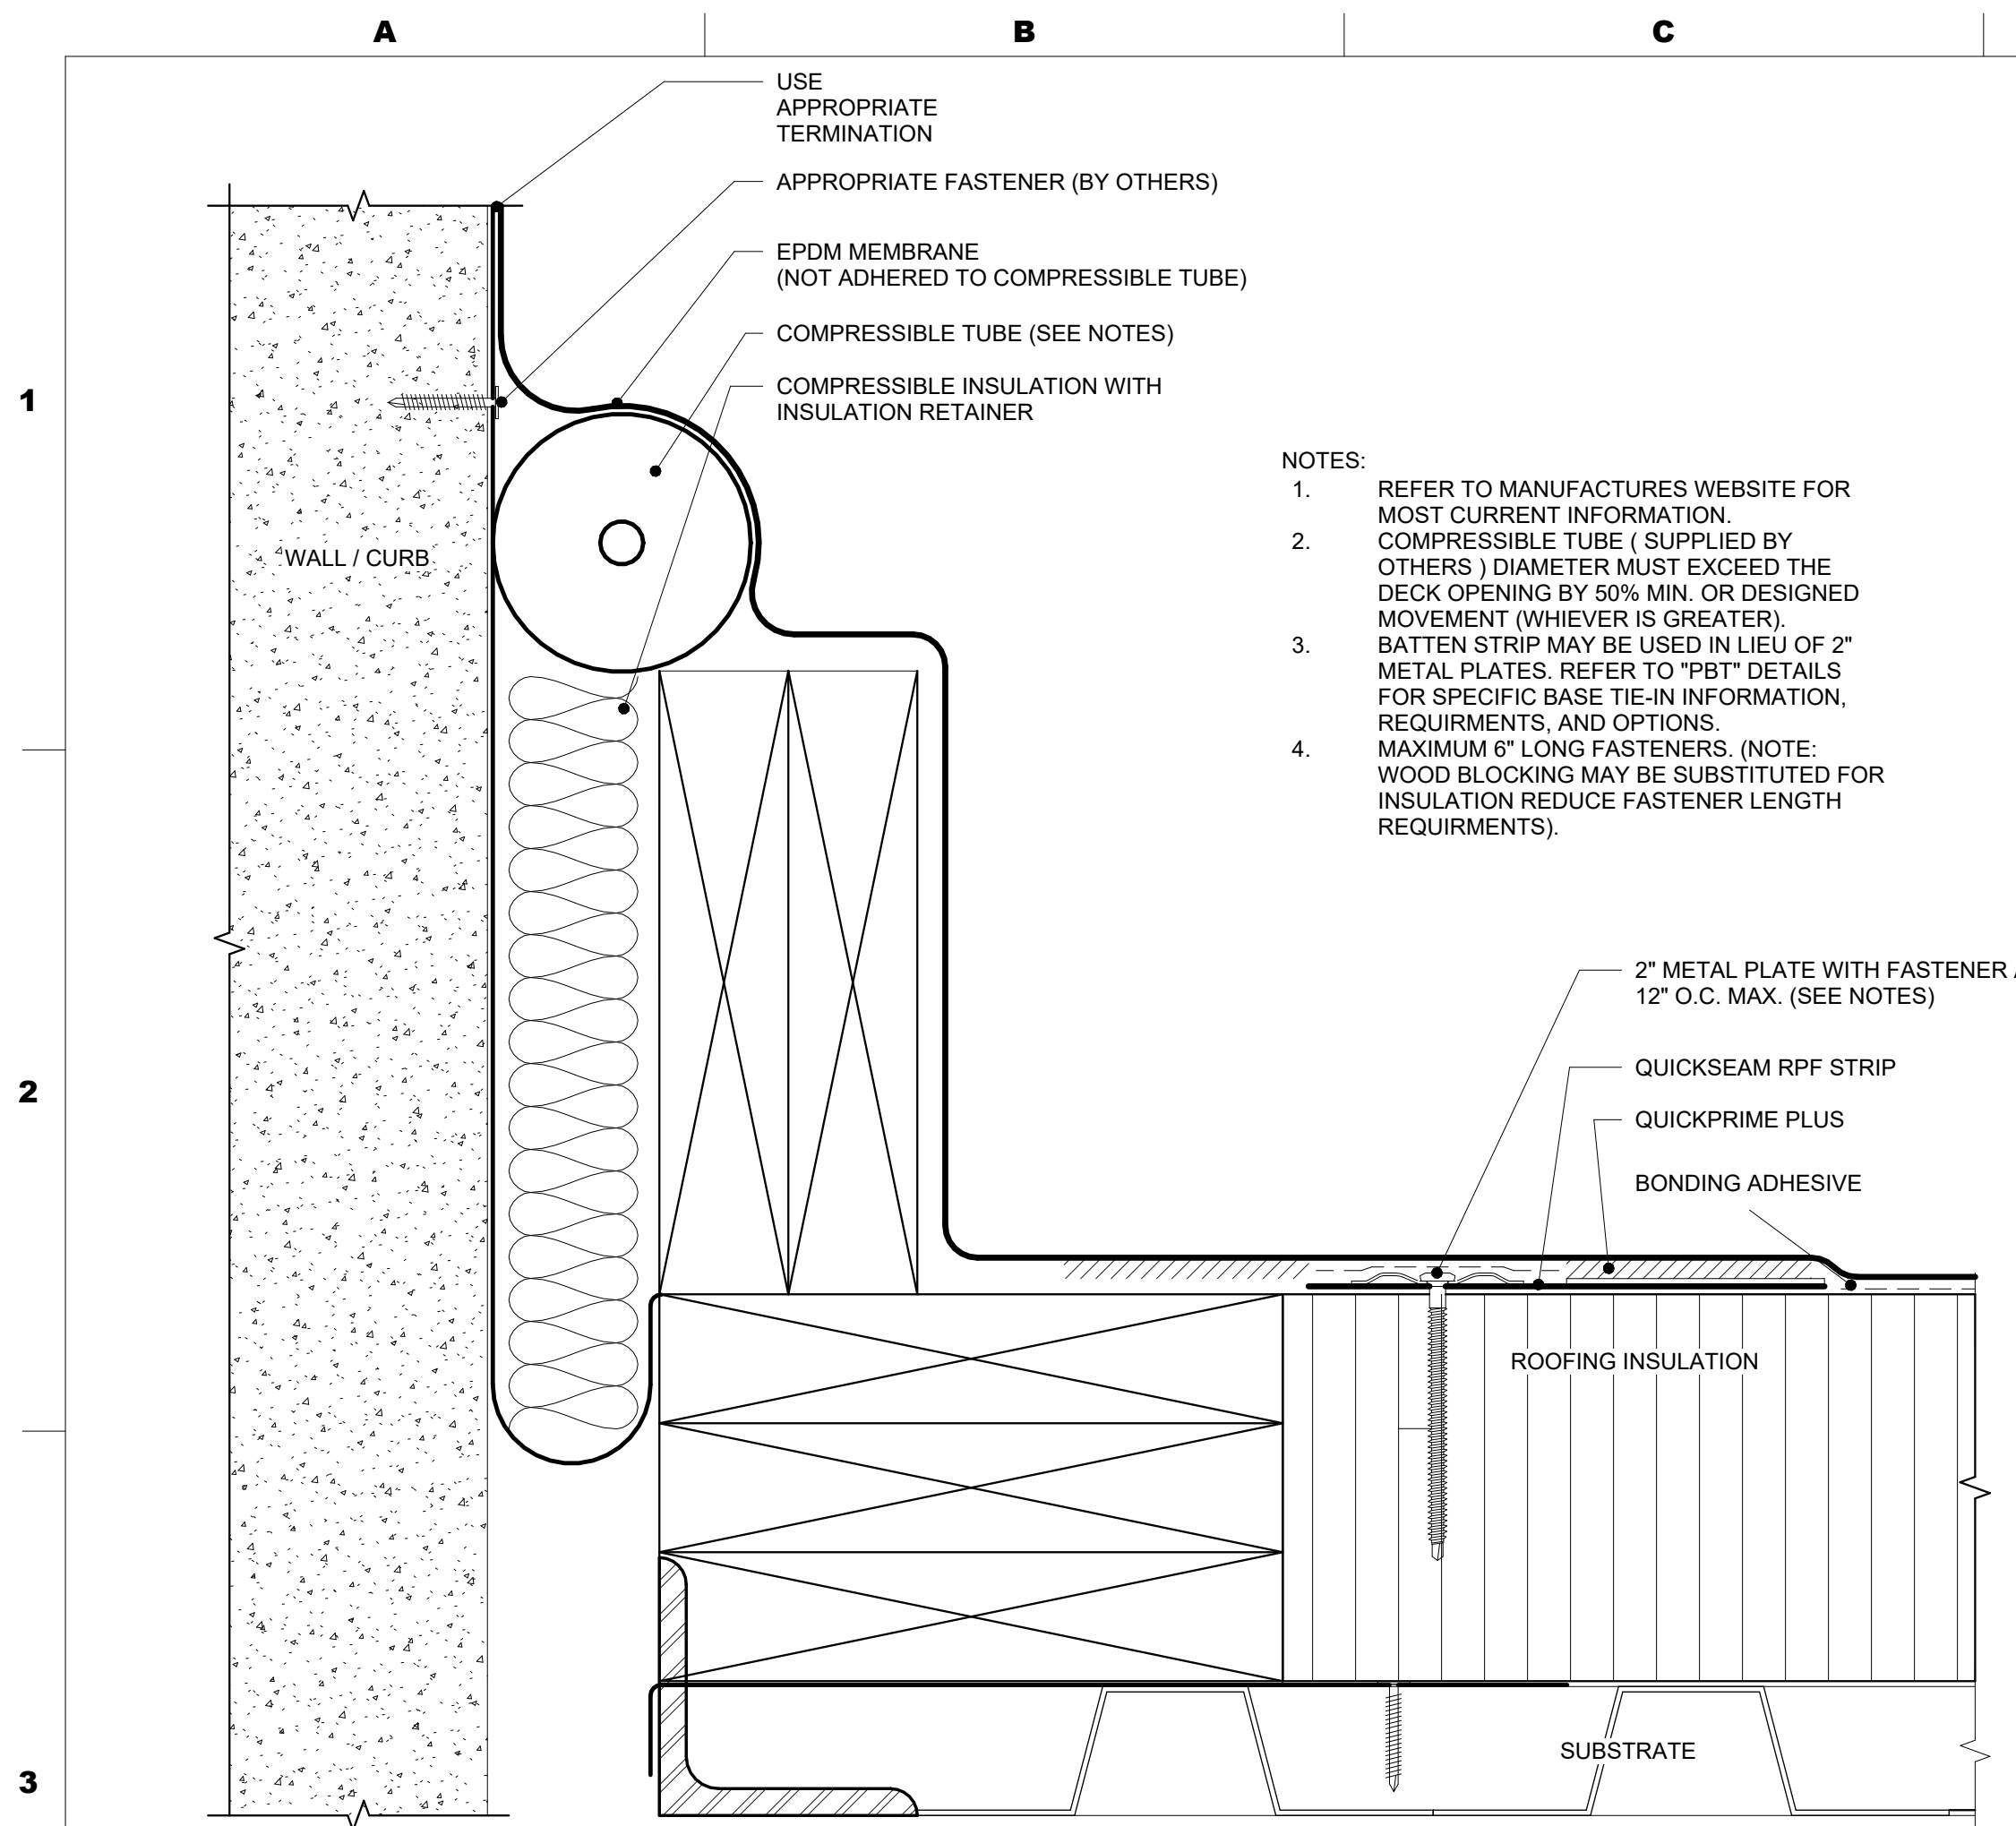


**1 EXPANSION JOINT DETAIL ROOF TO WALL**  
A5.3 NTS

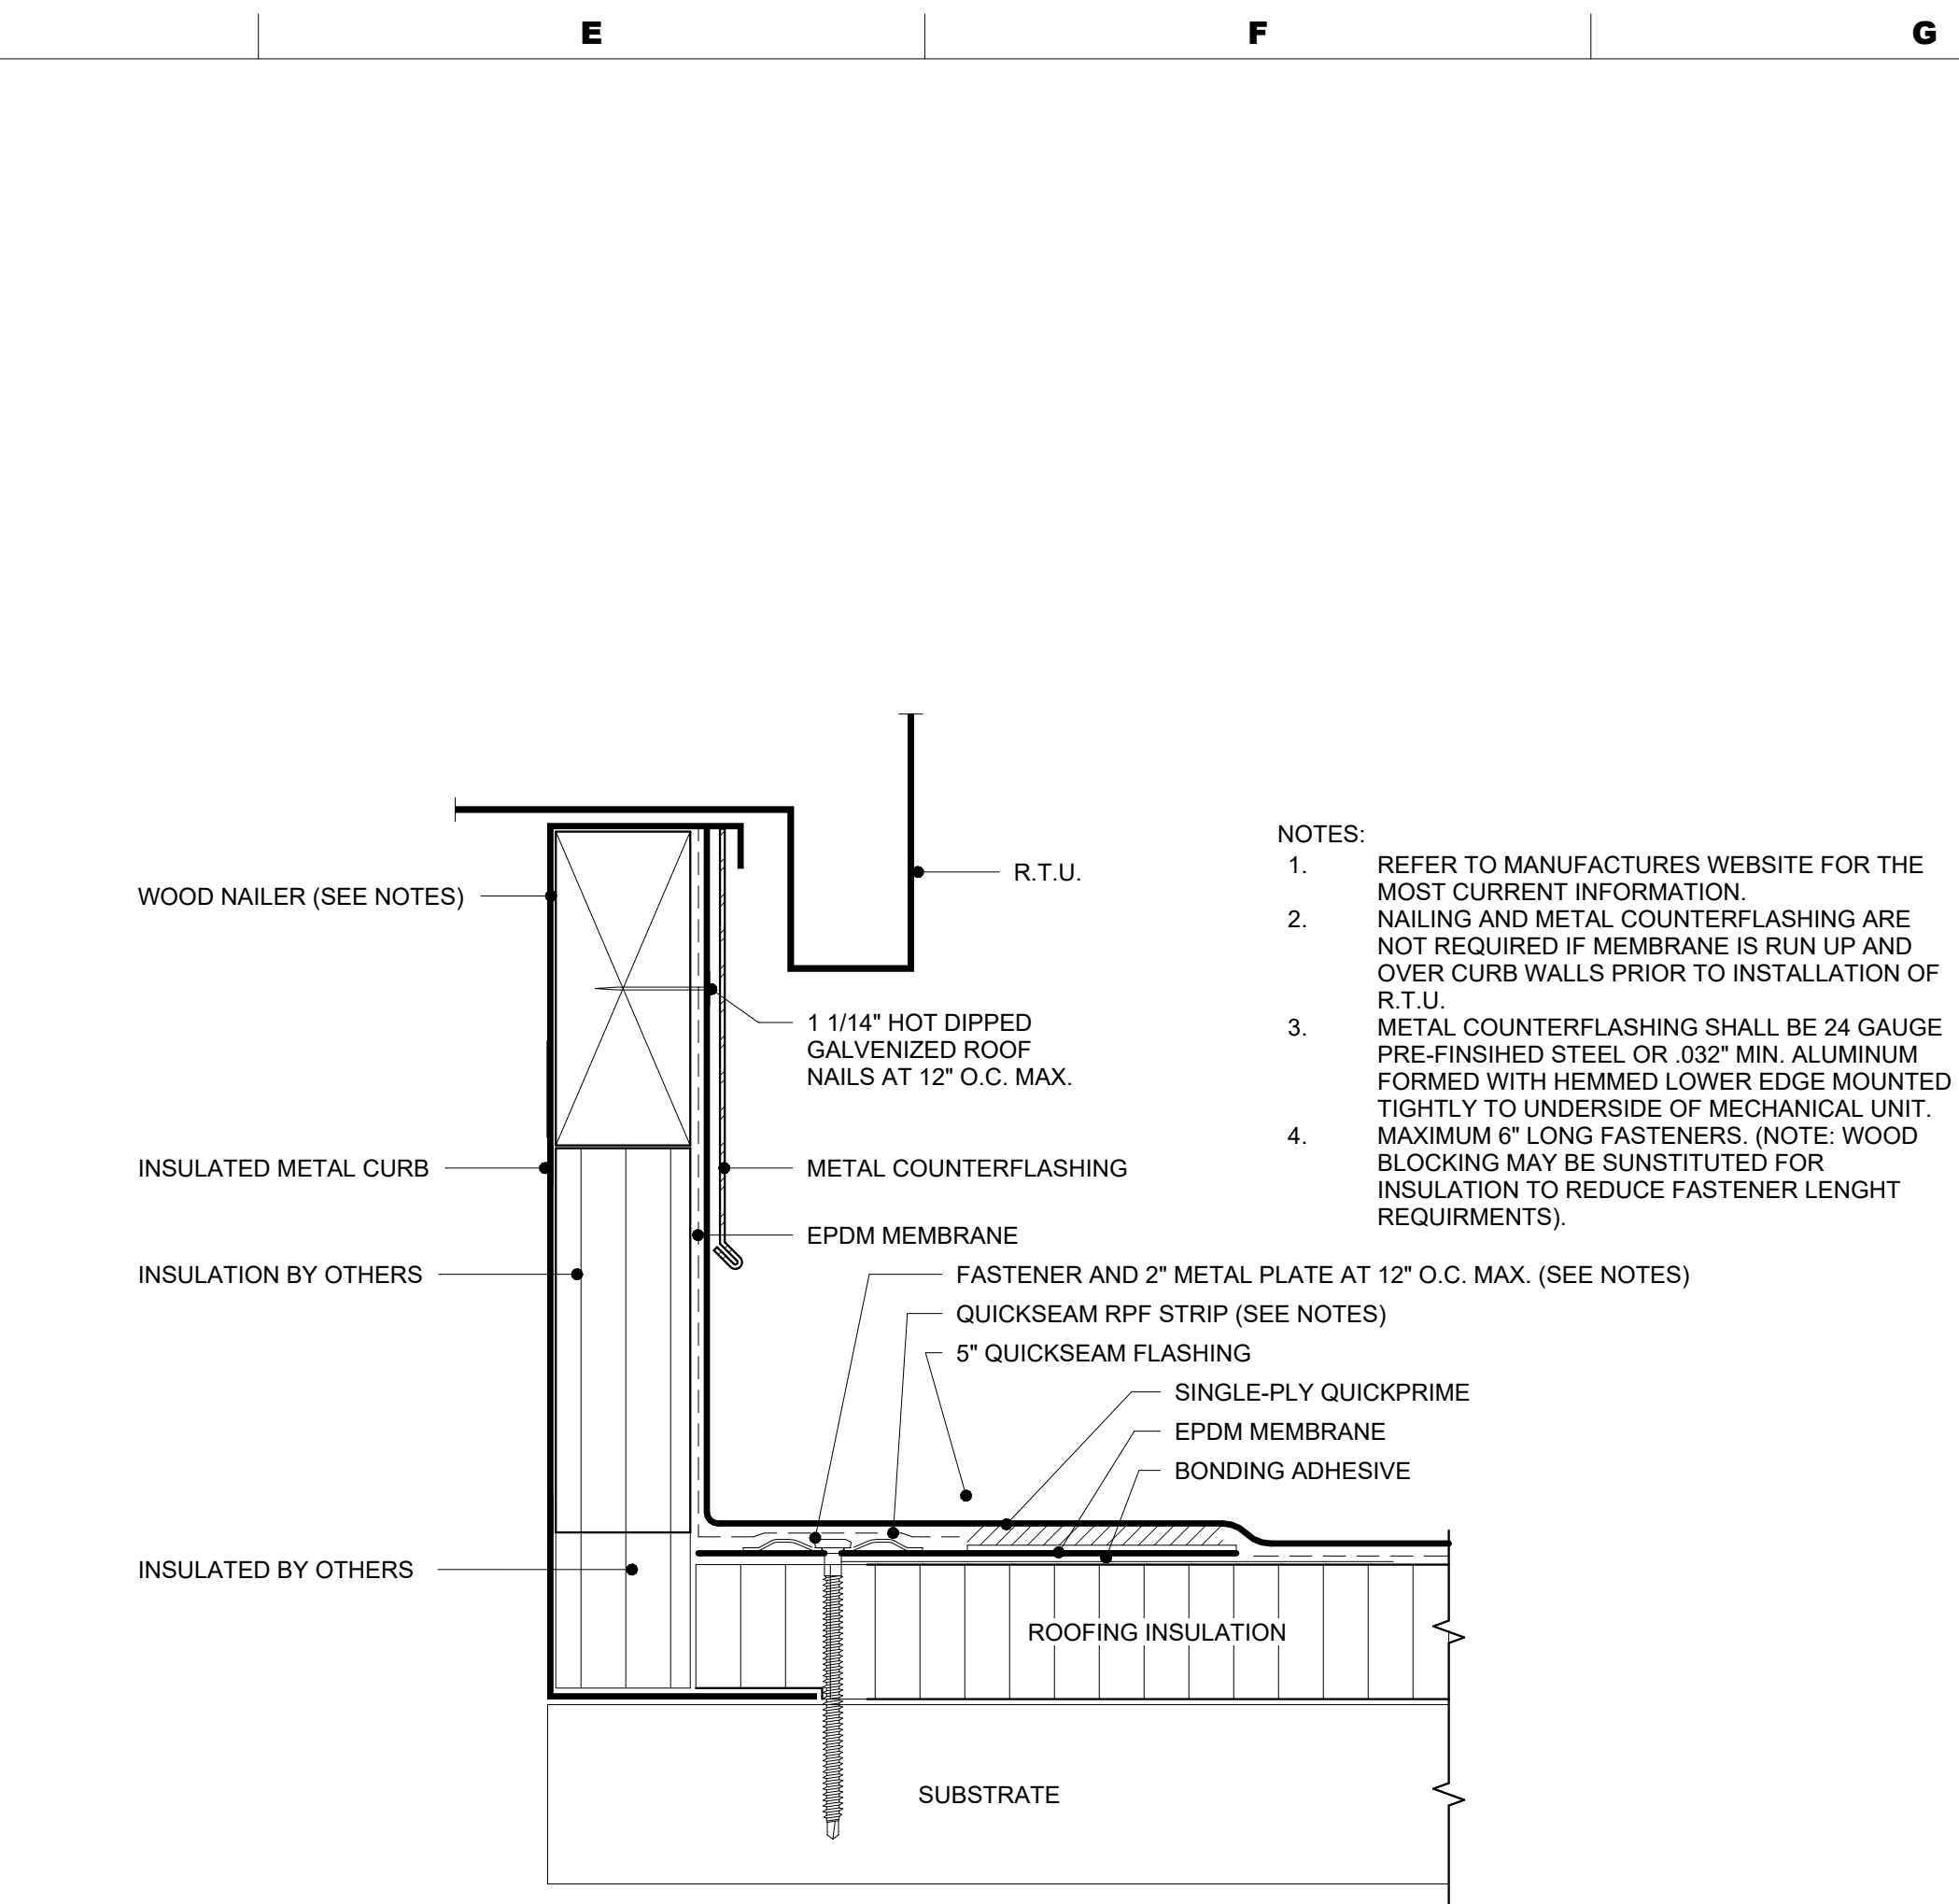


**2 CURB FLASHING DETAIL**  
A5.3 NTS

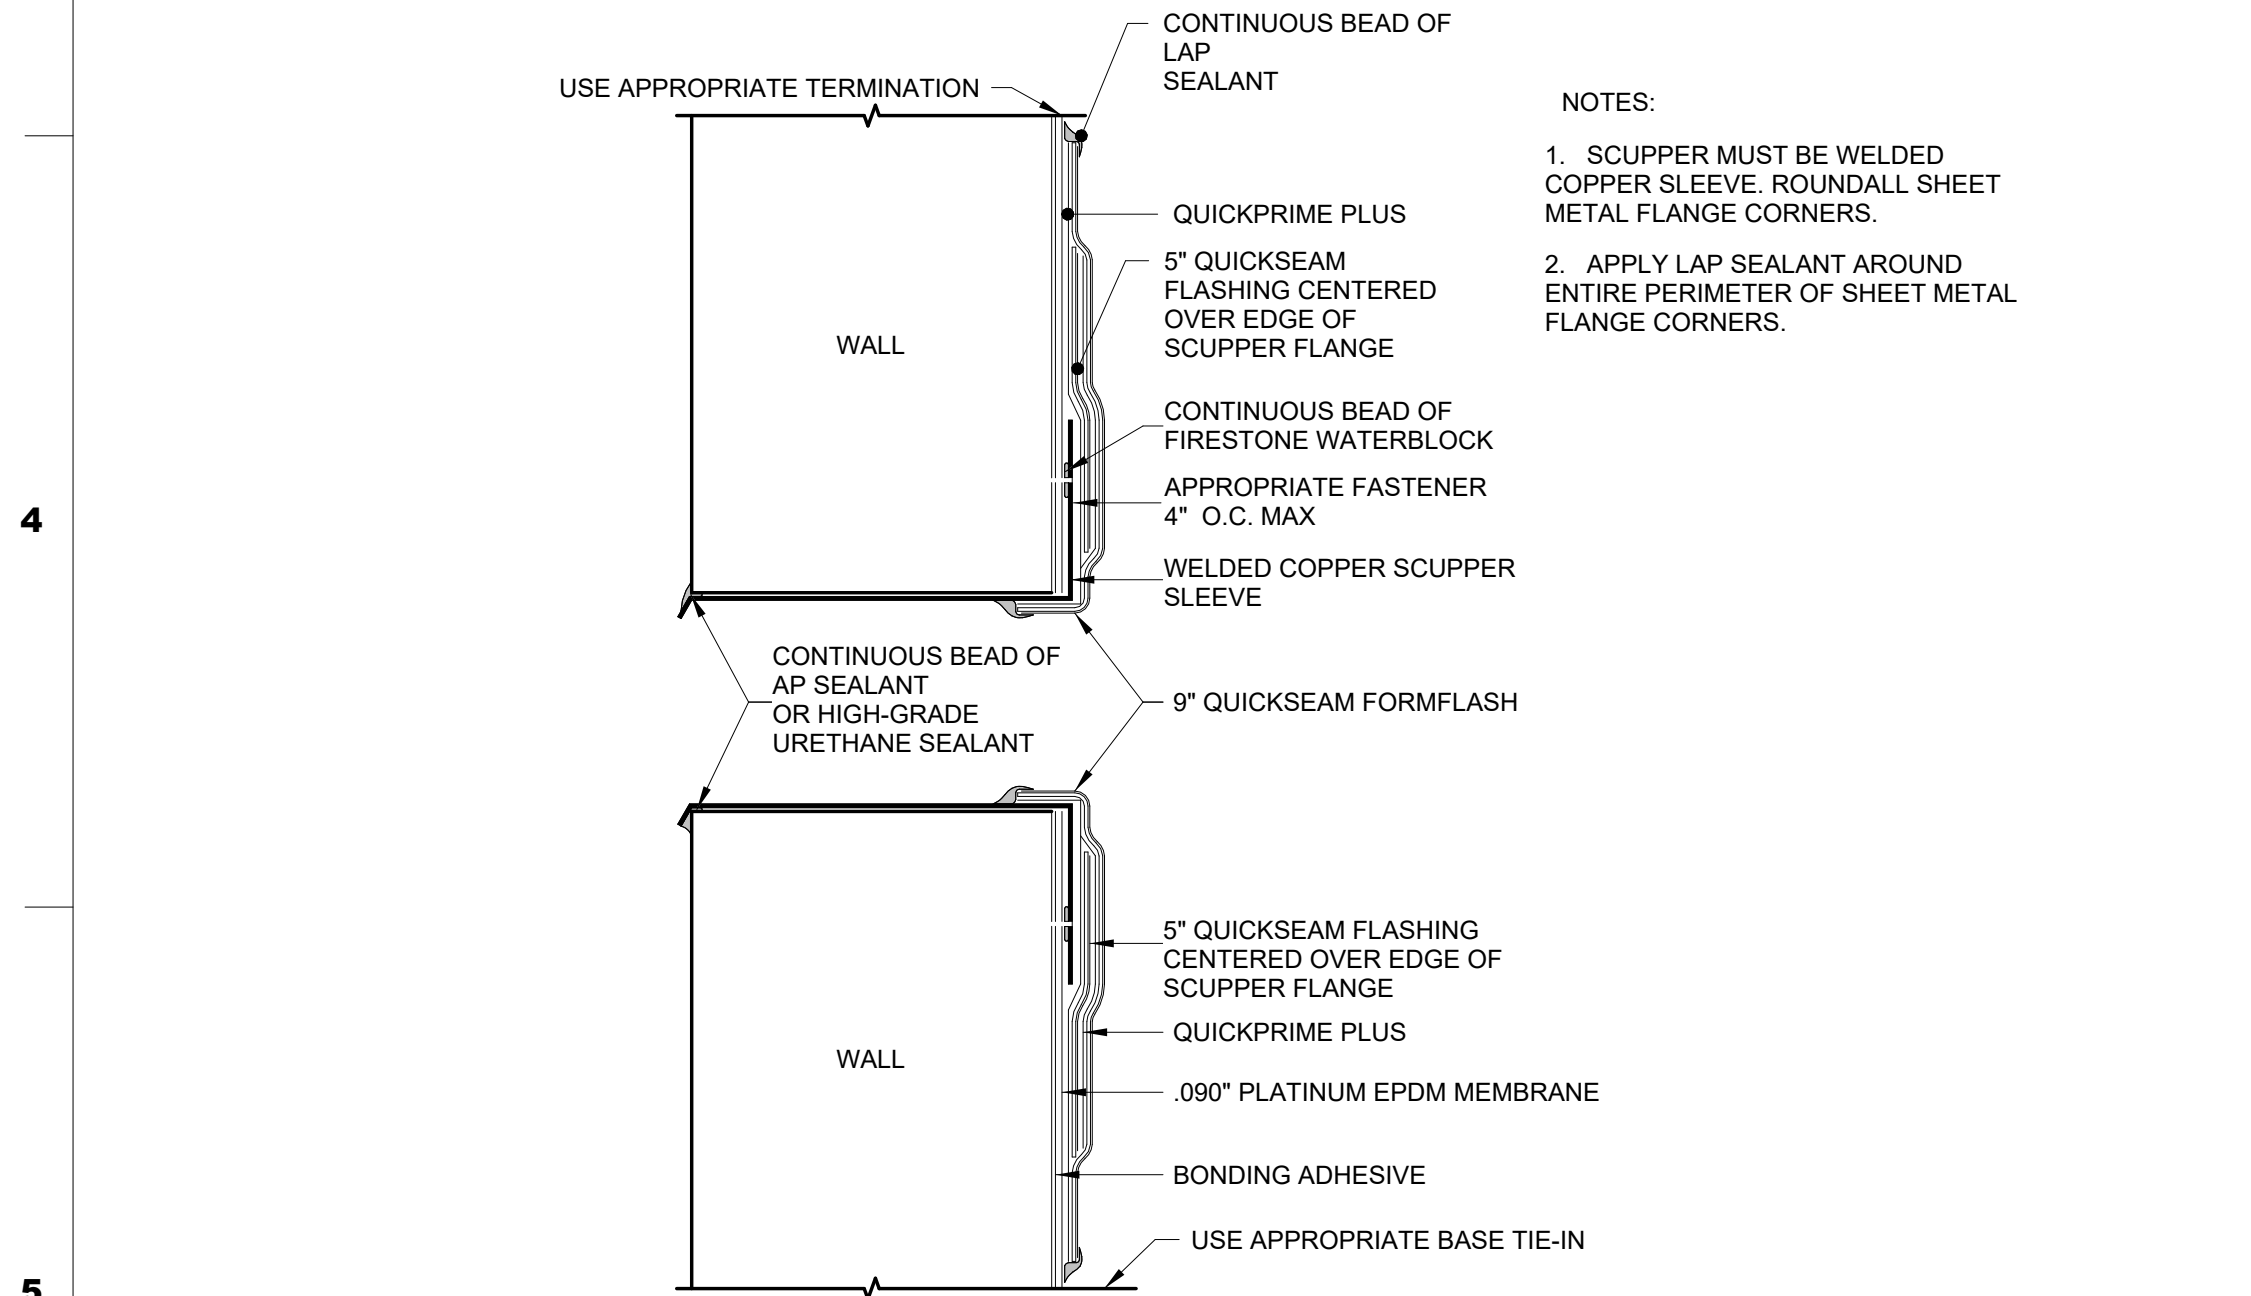


**3 OVERFLOW THRU-WALL SCUPPER (WELDED SLEEVE)**  
A5.3 NTS

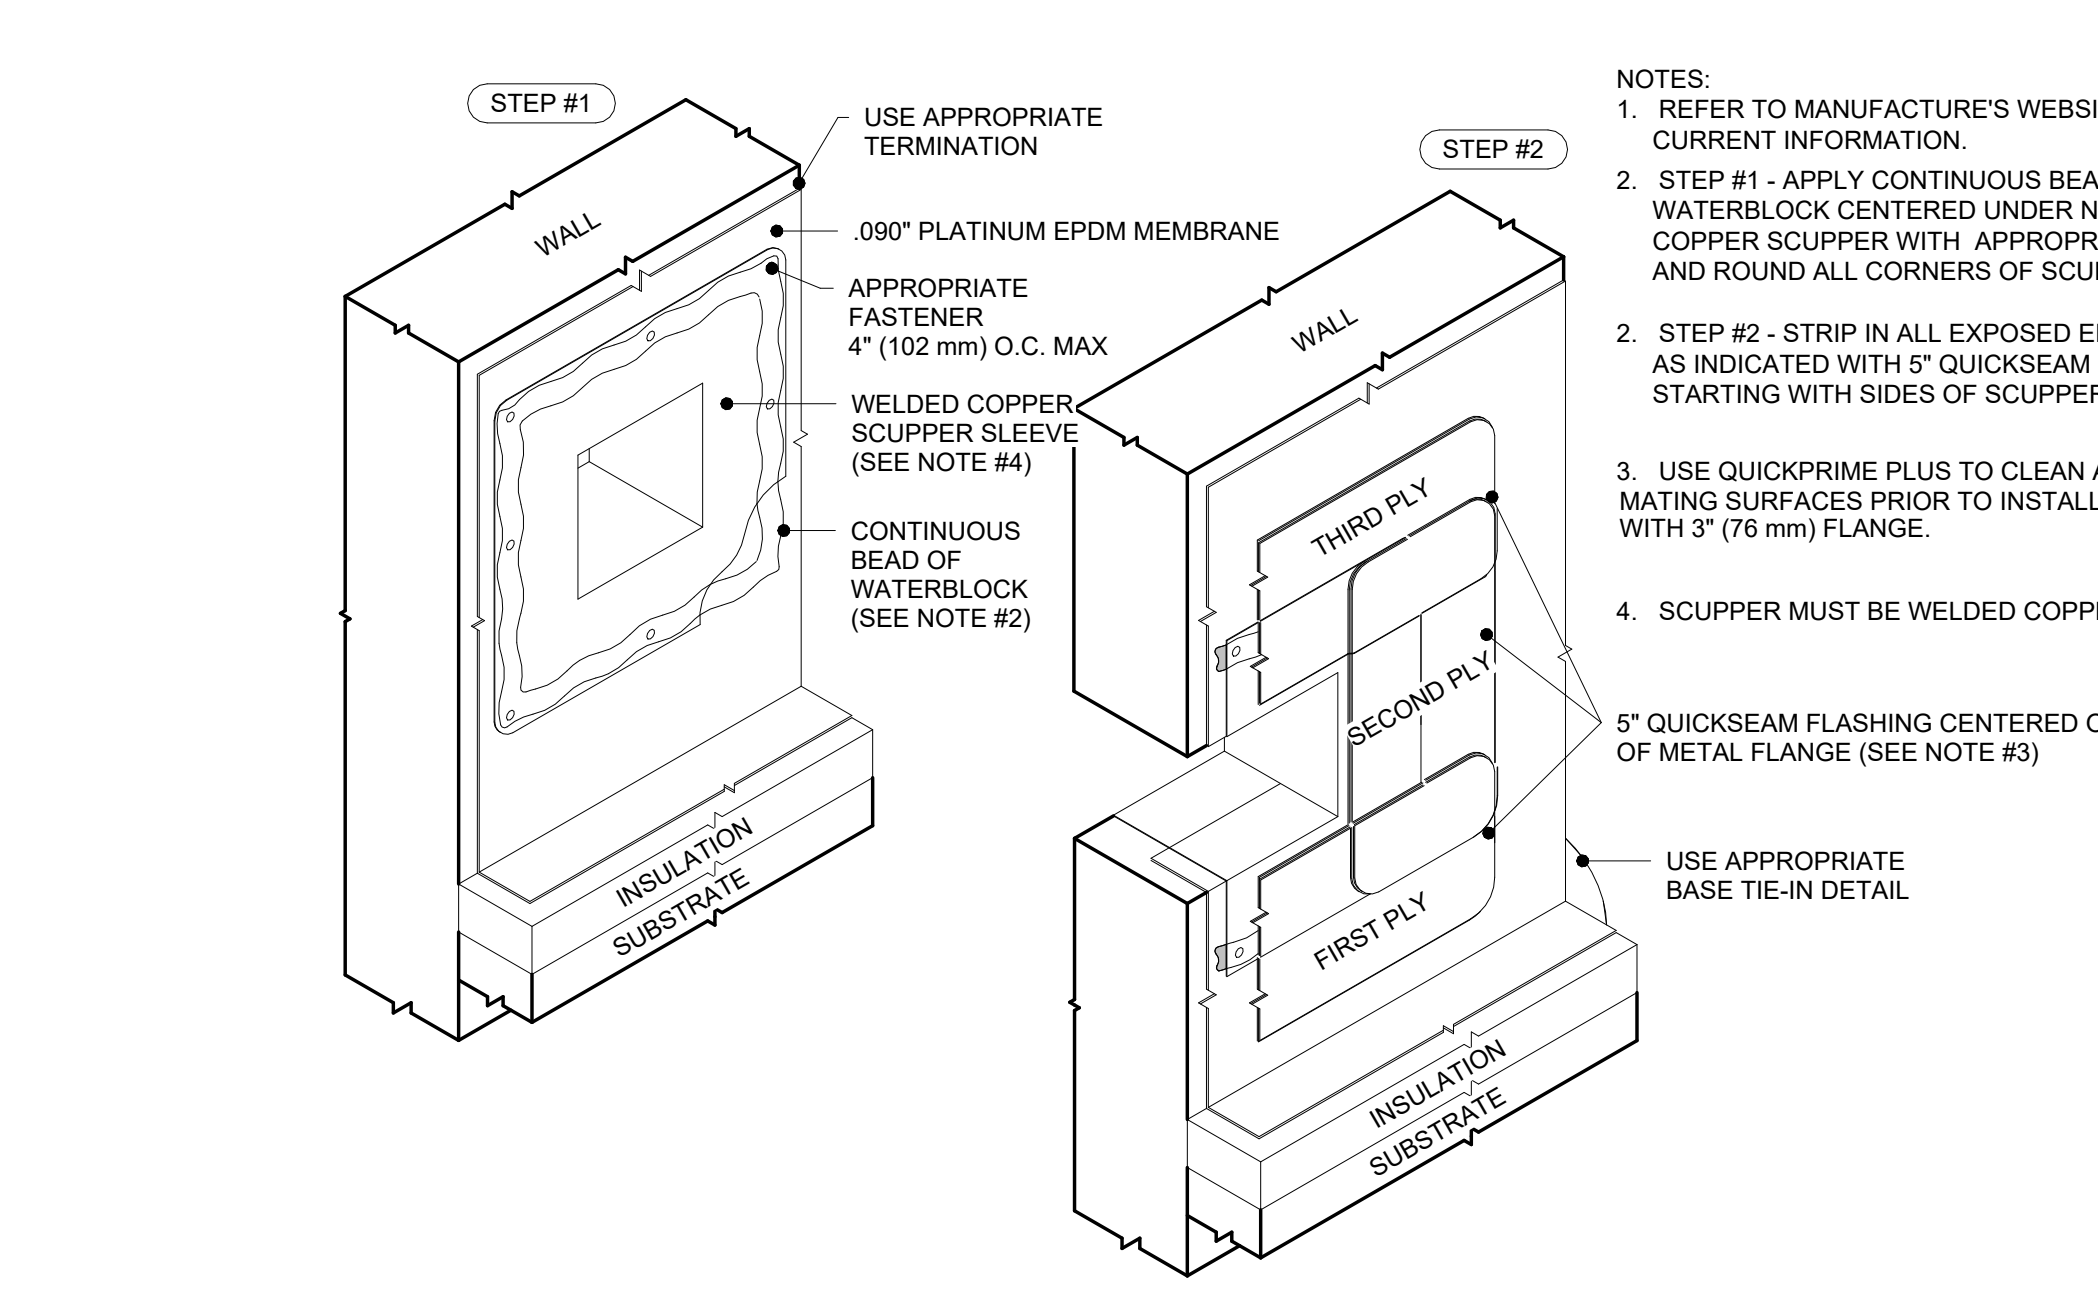

**4 OVERFLOW THRU-WALL SCUPPER (WELDED SLEEVE) INSTALLATION STEPS 1 & 2**  
A5.3 NTS

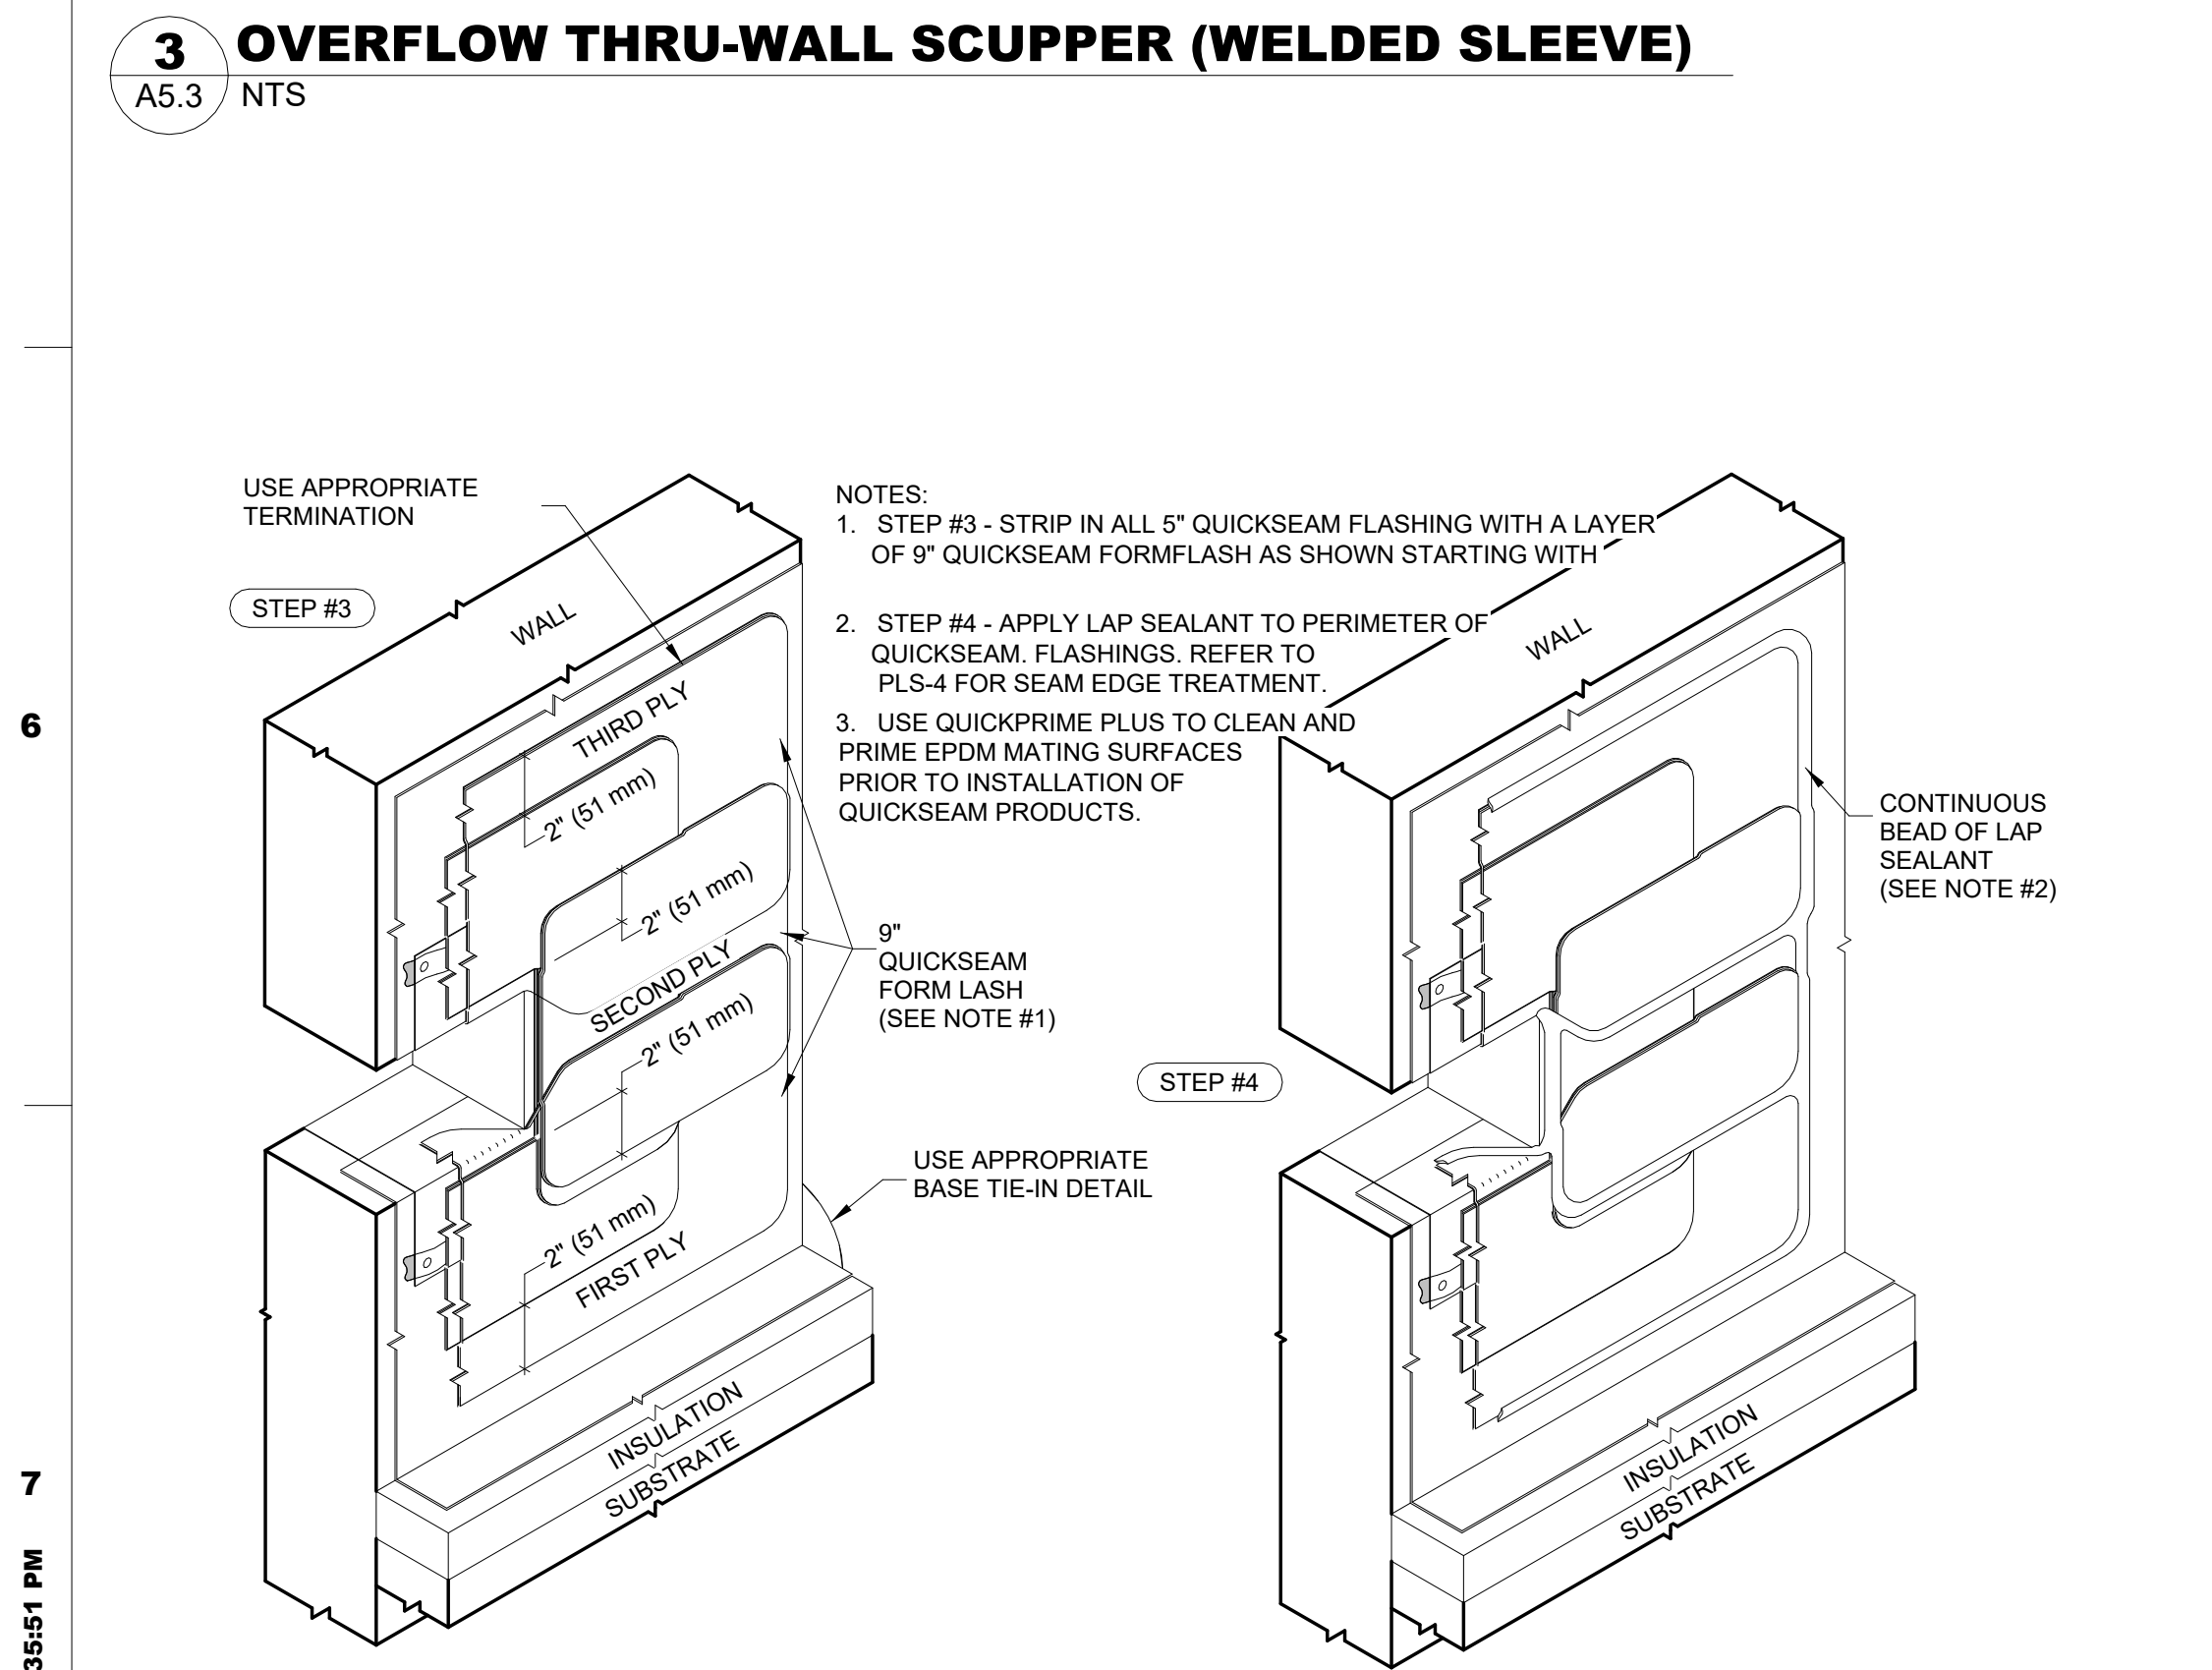

**5 OVERFLOW THRU-WALL SCUPPER (WELDED SLEEVE) INSTALLATION STEPS 3 & 4**  
A5.3 NTS

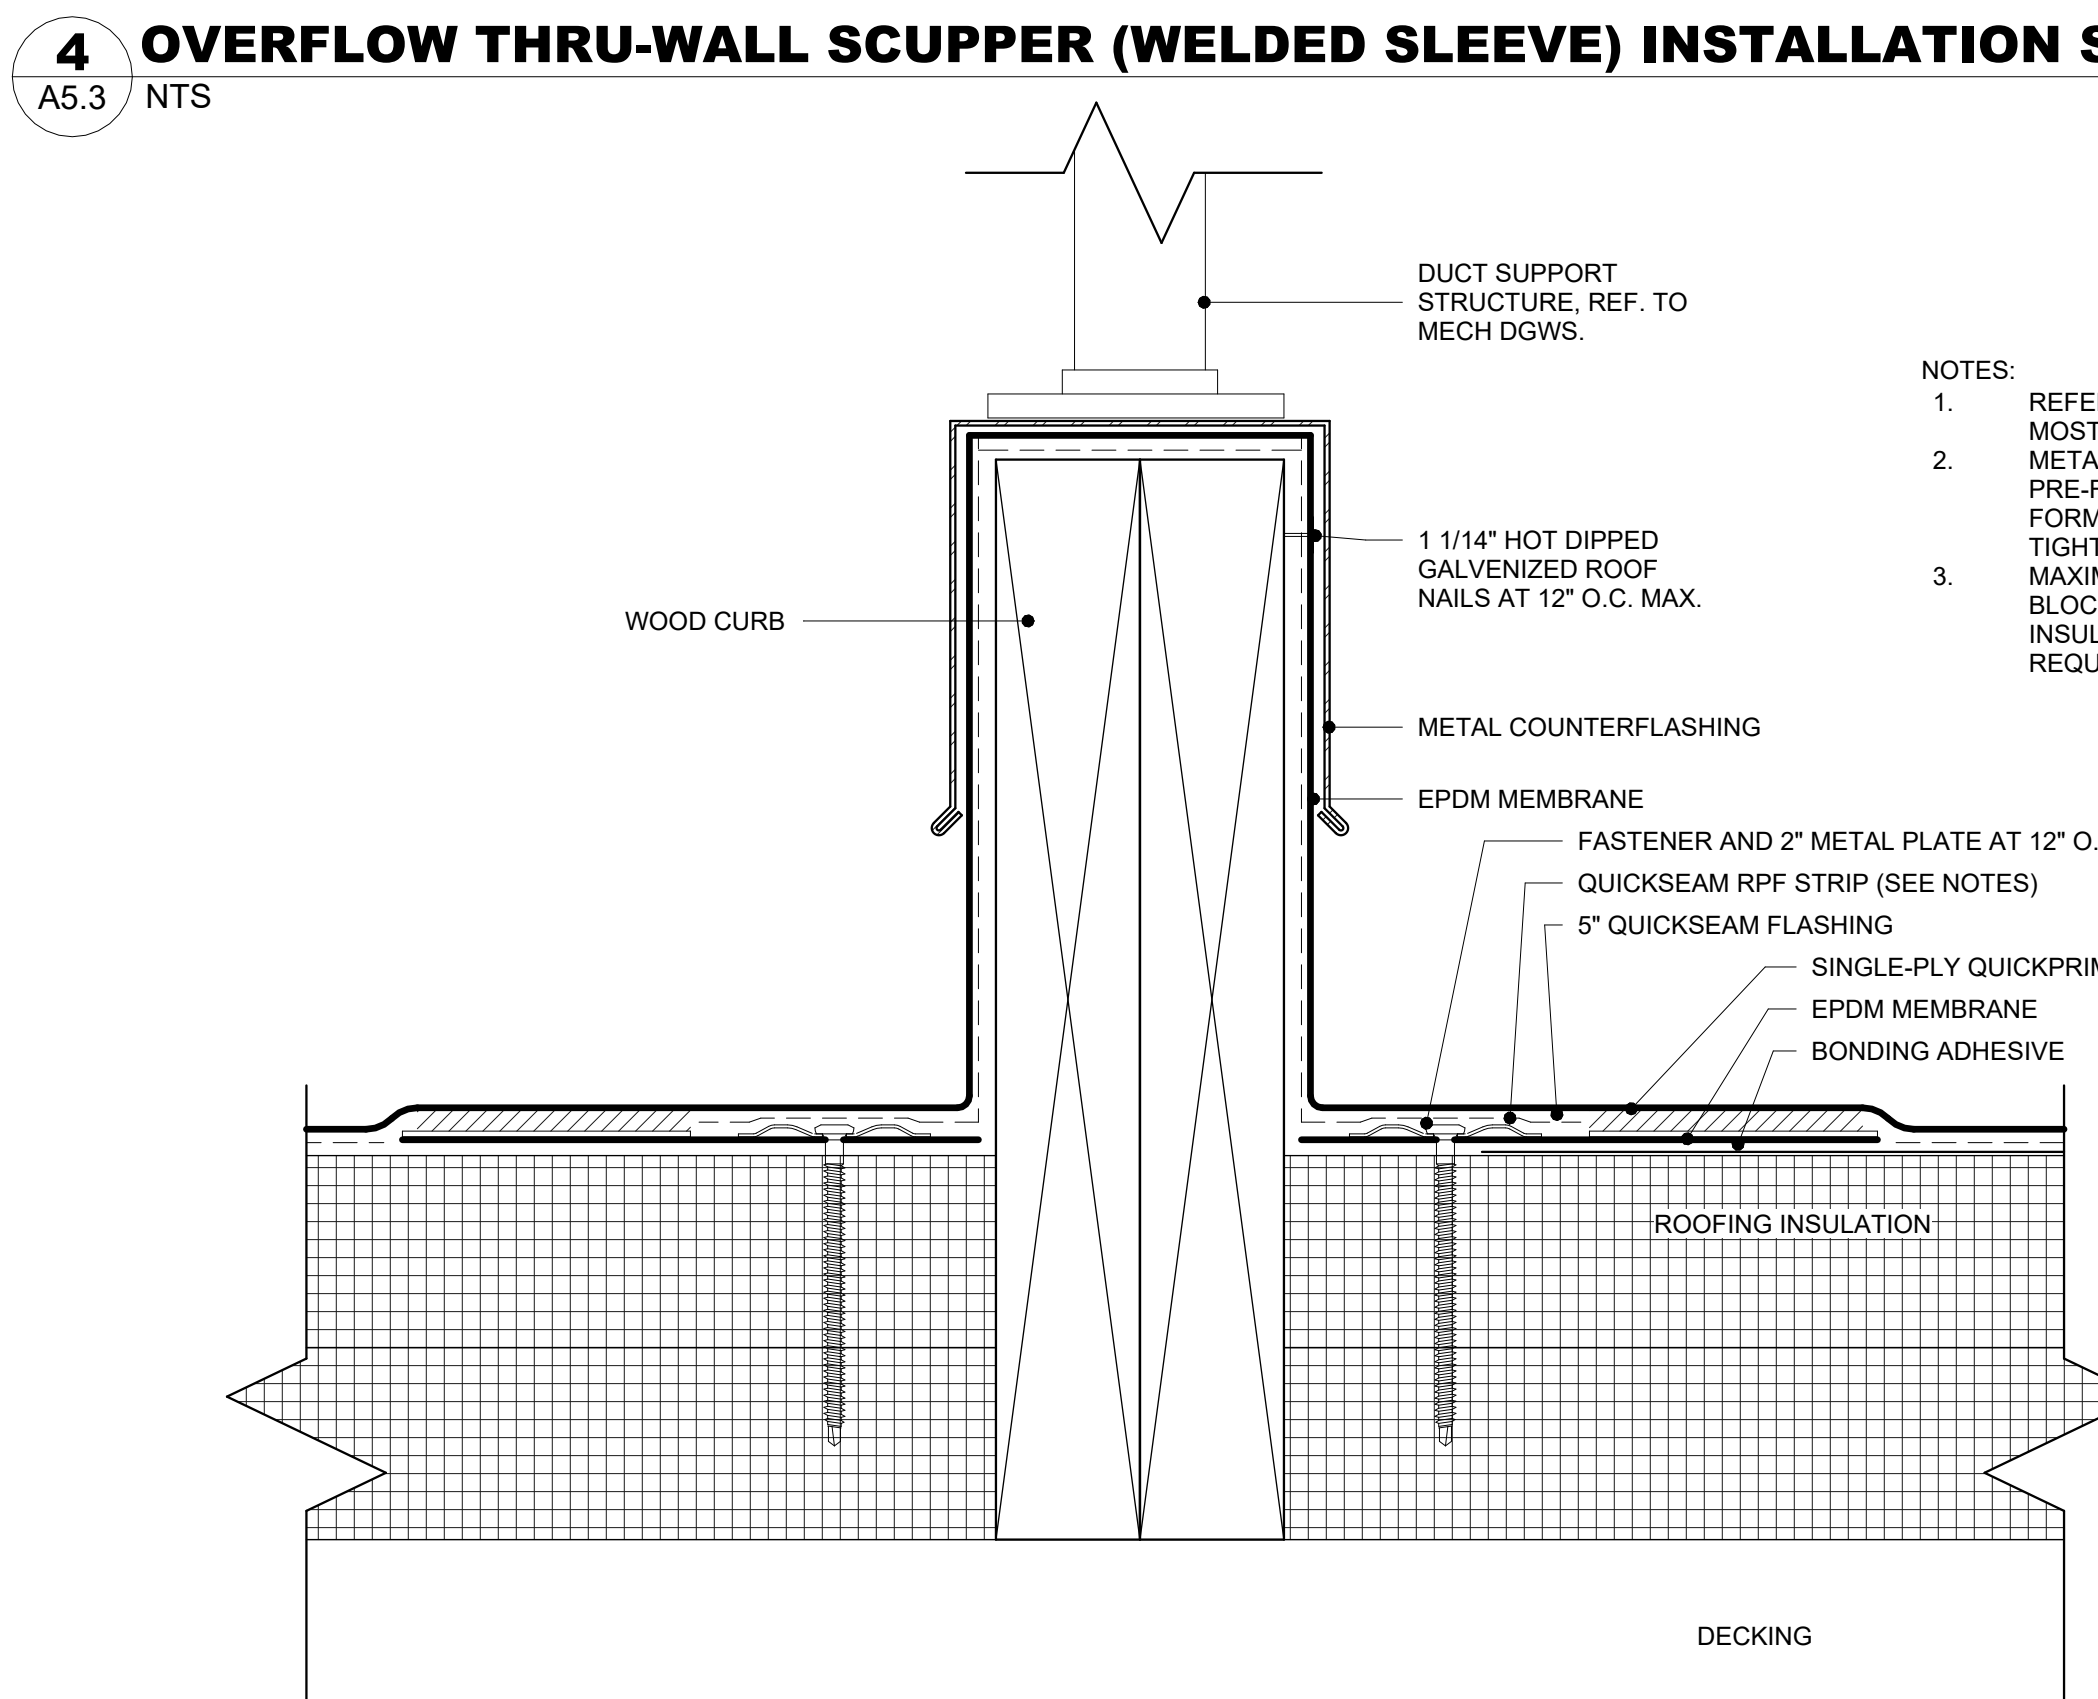

**6 DUCT SUPPORT CURB DETAIL**  
A5.3 NTS

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CONSULTANT:

RENOVATION TO  
**JACK WALKER CLUBHOUSE**  
BOYS & GIRLS CLUB  
229 W LEMON ST, LANCASTER,  
PA 17603

ISSUE DATES	DESCRIPTION
DATE: 10/01/2024	BID DOCUMENTS

PROJ #: 24-80C-01 DRAWN BY: CJK  
SHEET TITLE:


**TYPICAL ROOF DETAILS**

SHEET NUMBER:  
**A5.3**

**BID**

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**GENERAL ACOUSTICAL CEILING INSTALLATION NOTES**

1. THE CONTRACTOR SHALL FIELD CHECK THE PREMISES AND VERIFY THAT THE CEILING LAYOUT SHOWN ON THE DRAWINGS CAN BE ACCOMMODATED AND VERIFY ALL CLEARANCES AS REQUIRED FOR ALL LIGHTING FIXTURES, DUCT WORK, AND SPRINKLERS BEFORE PROCEEDING WITH ANY INSTALLATION. REPORT ANY DISCREPANCIES TO THE ARCHITECT PRIOR TO PROCEEDING.
2. REVIEW CEILING LAYOUT WITH MEP COORDINATION DRAWINGS.
3. CEILING SHALL BE TRUE, FLAT, STRAIGHT AND REGULAR, PROVIDE STABILIZER BARS AS REQUIRED TO DISTRIBUTE LOAD EQUALLY OVER TWO OR MORE RUNNERS.
4. LEVEL CEILING TO BE WITHIN 1/8" IN 12 FEET IN ANY DIRECTION. LEVEL WITH HANGER WIRE TAUT AND PLUMB, WITHOUT KINKING OR BENDING HANGER WIRES.
5. INSTALL MAX. LENGTHS OF EDGE MOLDING AT INTERSECTION OF CEILING AND VERTICAL SURFACE. MITRE ALL CORNERS.
6. COORDINATE INSTALLATION WITH ELECTRICAL, MECHANICAL AND SPRINKLER REQUIREMENTS.
7. INSTALL CEILING TILE HOLD DOWN CLIPS IN ALL VESTIBULES, AIR LOCKS AND PARTITIONS WITH CUT CEILING TILES.
8. LAY DIRECTIONAL PATTERN UNITS IN SINGLE DIRECTION.
9. ALL FIXTURE TRIM (LIGHTING, SPEAKER, HVAC GRILLS, ETC.) SHALL BE METAL AND PAINTED TO MATCH ADJACENT CEILING FINISH. PLASTIC TRIM IS NOT ACCEPTABLE UNLESS APPROVED BY THE ARCHITECT. REGULAR CEILING TILE TO BE CUT AND FITTED SNUG AGAINST PARTITIONS. DO NOT SHIM THE GRID TO ALLOW CEILING TILE TO PASS OVER TOP OF PARTITION.
11. FINAL GRID HEIGHTS AND LAY-OUT TO BE DETERMINED IN THE FIELD FOLLOWING COORDINATION.

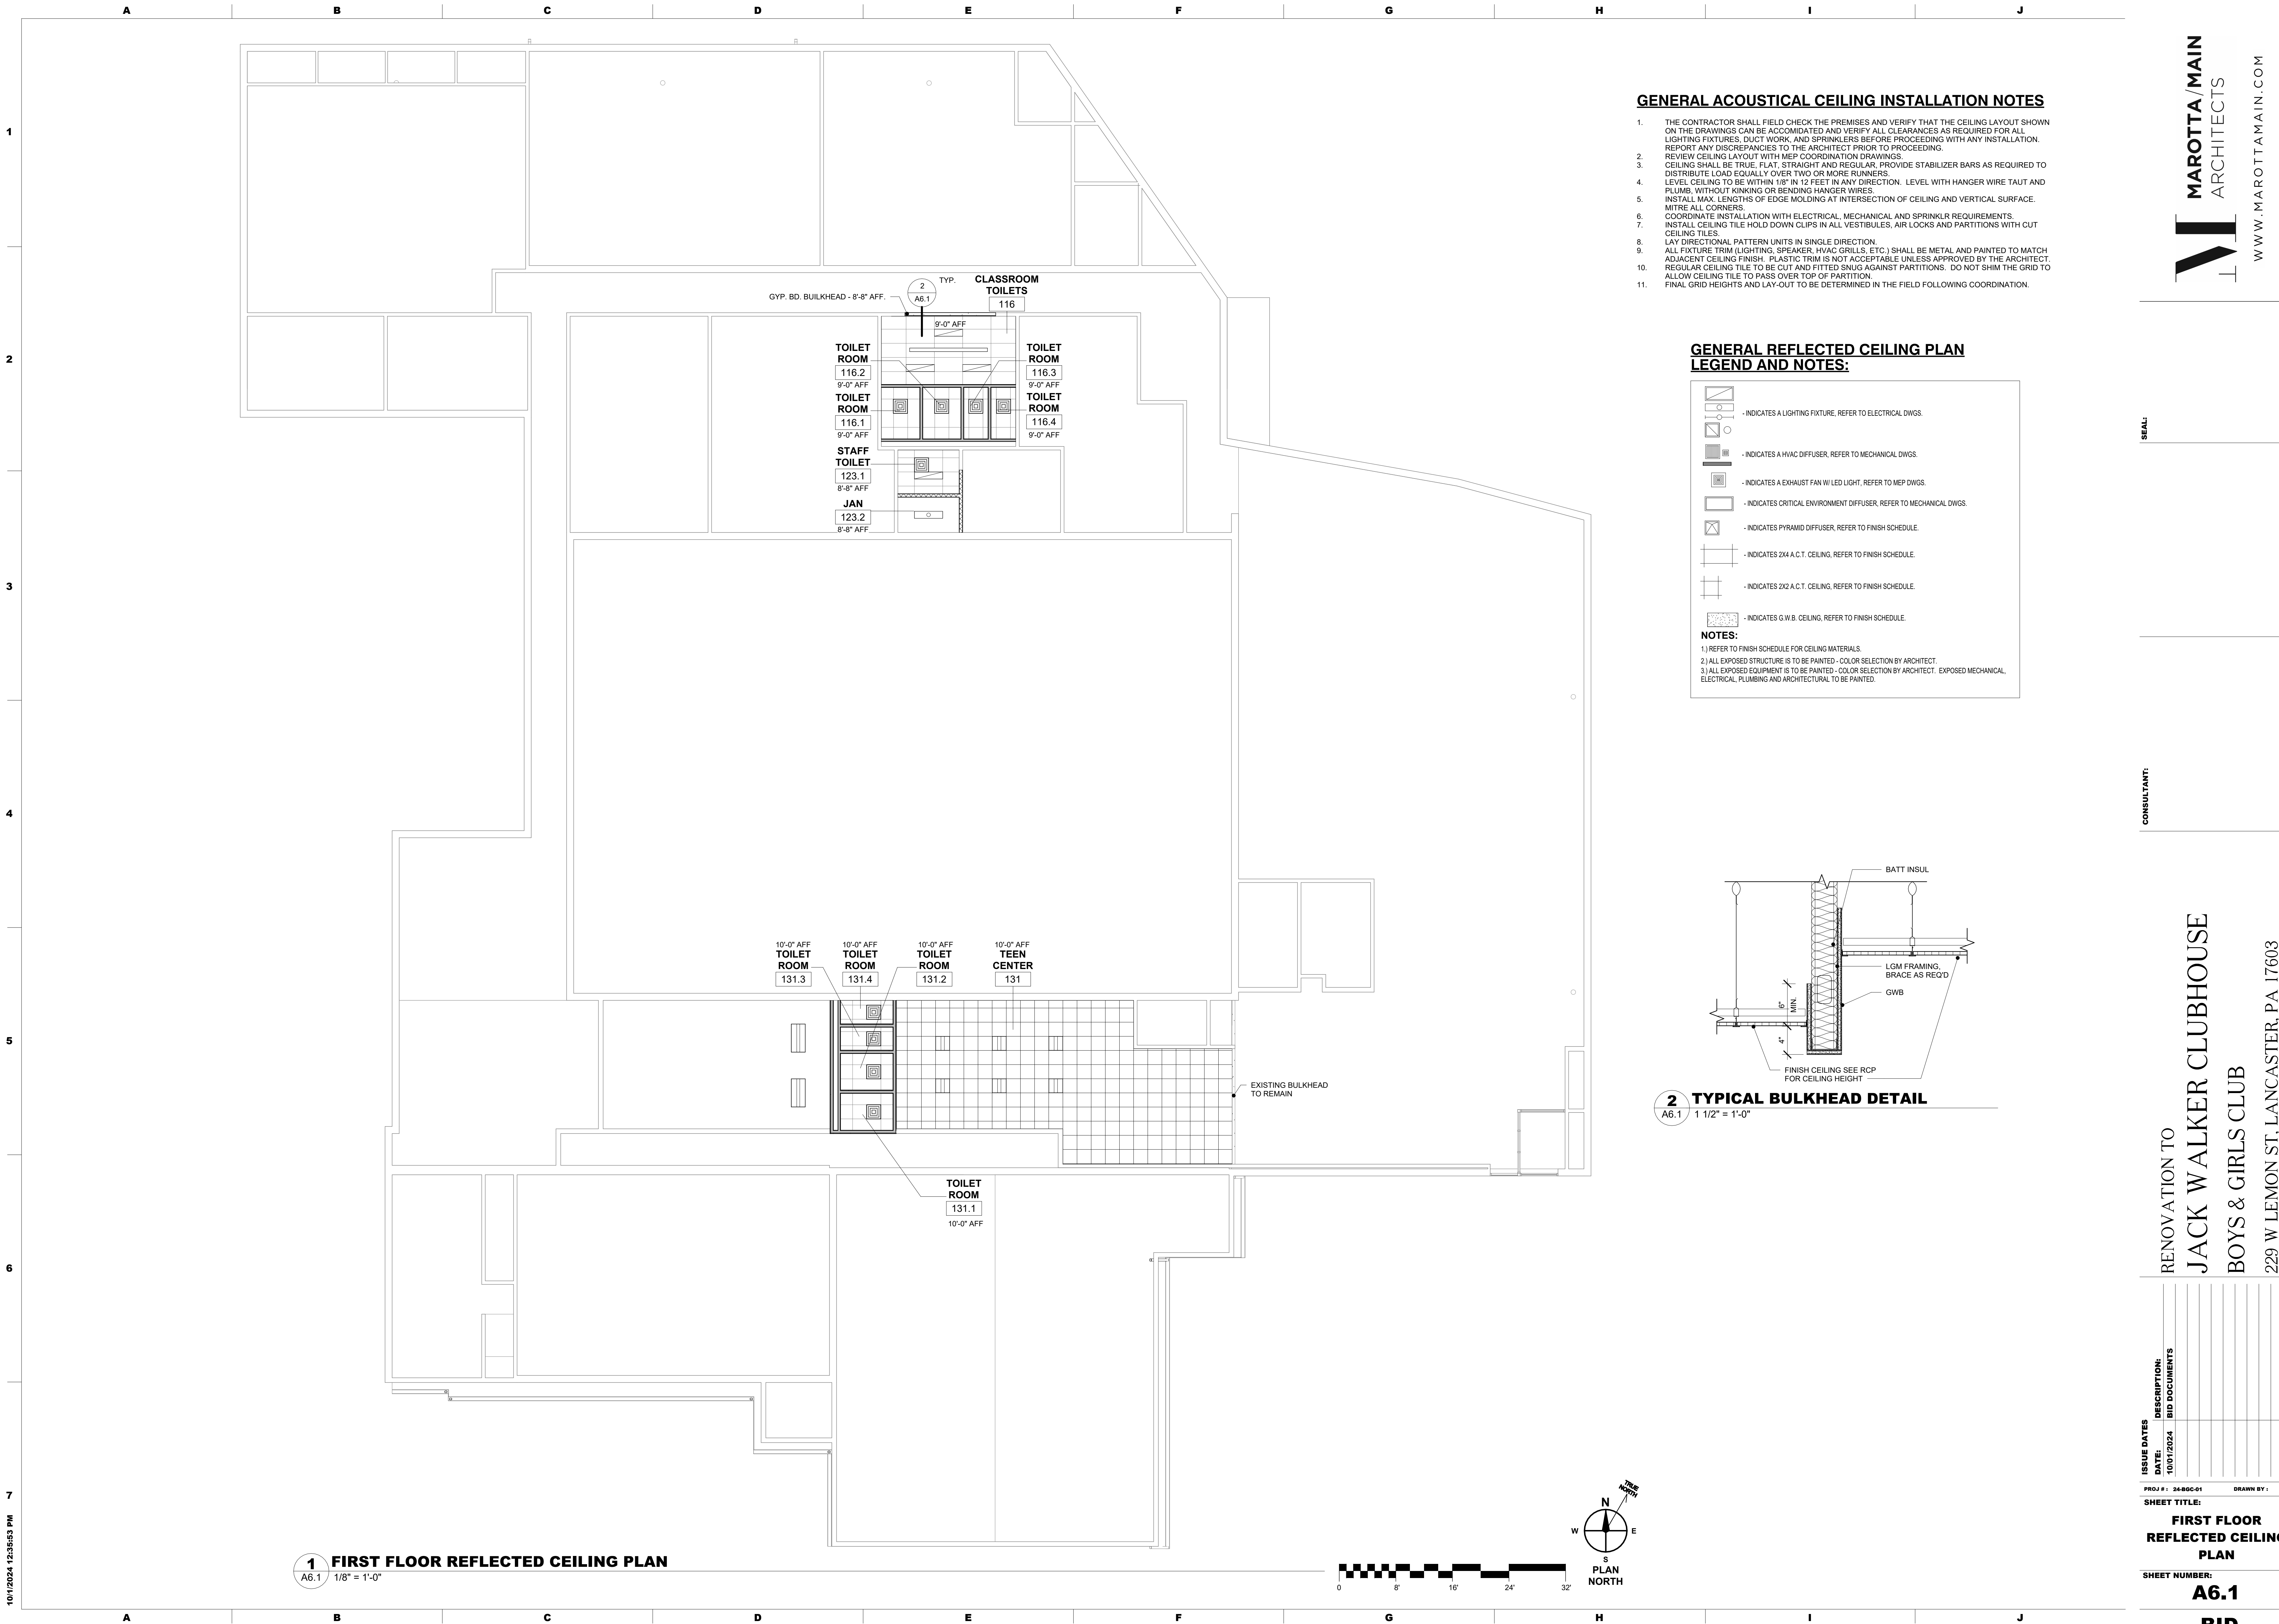**GENERAL REFLECTED CEILING PLAN LEGEND AND NOTES:**

- INDICATES A LIGHTING FIXTURE, REFER TO ELECTRICAL DWGS.
- INDICATES A HVAC DIFFUSER, REFER TO MECHANICAL DWGS.
- INDICATES A EXHAUST FAN W/ LED LIGHT, REFER TO MEP DWGS.
- INDICATES CRITICAL ENVIRONMENT DIFFUSER, REFER TO MECHANICAL DWGS.
- INDICATES PYRAMID DIFFUSER, REFER TO FINISH SCHEDULE.
- INDICATES 2X4 A.C.T. CEILING, REFER TO FINISH SCHEDULE.
- INDICATES 2X2 A.C.T. CEILING, REFER TO FINISH SCHEDULE.
- INDICATES G.W.B. CEILING, REFER TO FINISH SCHEDULE.

**NOTES:**

- 1) REFER TO FINISH SCHEDULE FOR CEILING MATERIALS.
- 2) ALL EXPOSED STRUCTURE IS TO BE PAINTED - COLOR SELECTION BY ARCHITECT.
- 3) ALL EXPOSED EQUIPMENT IS TO BE PAINTED - COLOR SELECTION BY ARCHITECT. EXPOSED MECHANICAL, ELECTRICAL, PLUMBING AND ARCHITECTURAL TO BE PAINTED.

**2 TYPICAL BULKHEAD DETAIL**  
A6.1 1 1/2" = 1'-0"

SEAL:

CONSULTANT:

RENOVATION TO  
**JACK WALKER CLUBHOUSE**  
BOYS & GIRLS CLUB  
229 W LEMON ST, LANCASTER, PA 17603

ISSUE DATES	DESCRIPTION
DATE: 10/01/2024	BID DOCUMENTS

PROJ #: 24-800-01 DRAWN BY: SAB  
SHEET TITLE:  
**FIRST FLOOR REFLECTED CEILING PLAN**  
SHEET NUMBER:

10/1/2024 12:35:53 PM







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CONSULTANT:

ISSUE DATES

DESCRIPTION:  
DATE: 10/01/2024  
BID DOCUMENTS

PROJ #1: 24-800-01

DRAWN BY: SAB


SHEET TITLE:

**RAMP AND STAIRS SECTIONS**

SHEET NUMBER:

**A7.2**

**BID**

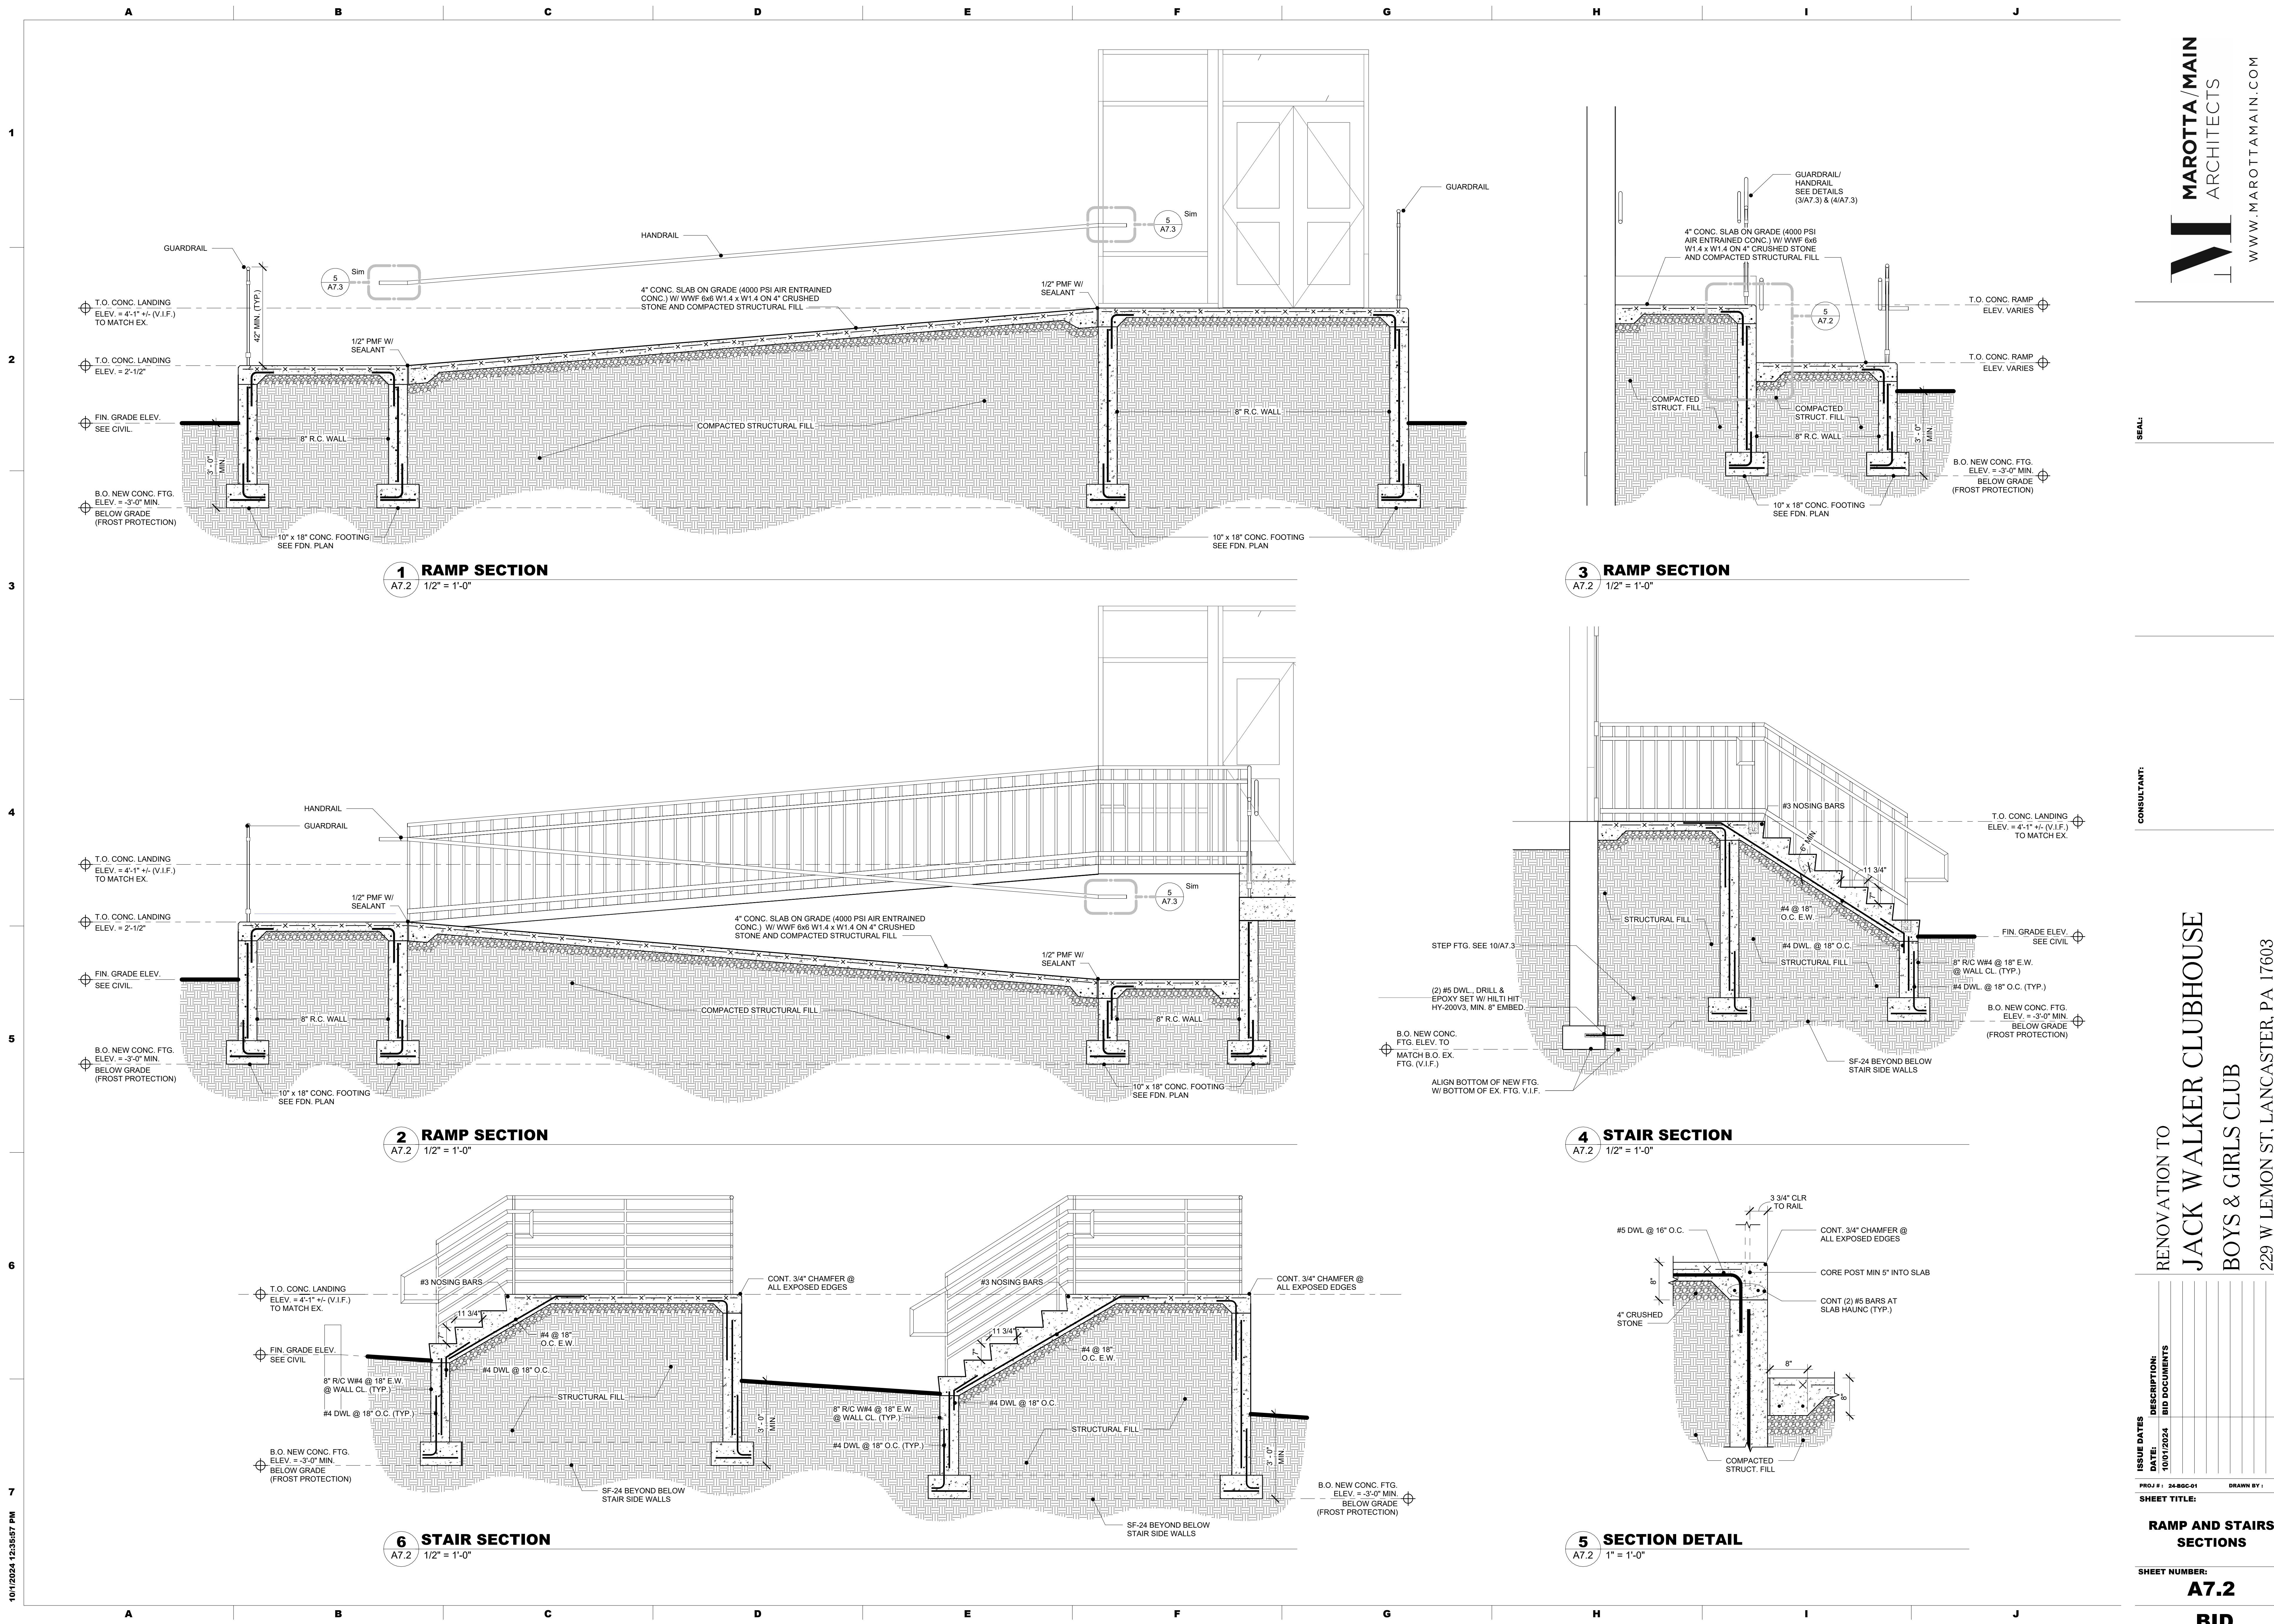

10/1/2024 12:35:57 PM







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SEAL:




CONSULTANT:

RENOVATION TO  
**JACK WALKER CLUBHOUSE**  
BOYS & GIRLS CLUB  
229 W LEMON ST, LANCASTER, PA 17603

ISSUE DATES  
DESCRIPTION:  
DATE: 10/01/2024  
DRAWN BY: SAB




PROJ #: 24-800-01  
SHEET TITLE:  
**TOILET ROOM ENLARGED PLANS & INTERIOR ELEVATIONS**  
SHEET NUMBER:

**A8.1**  
**BID**

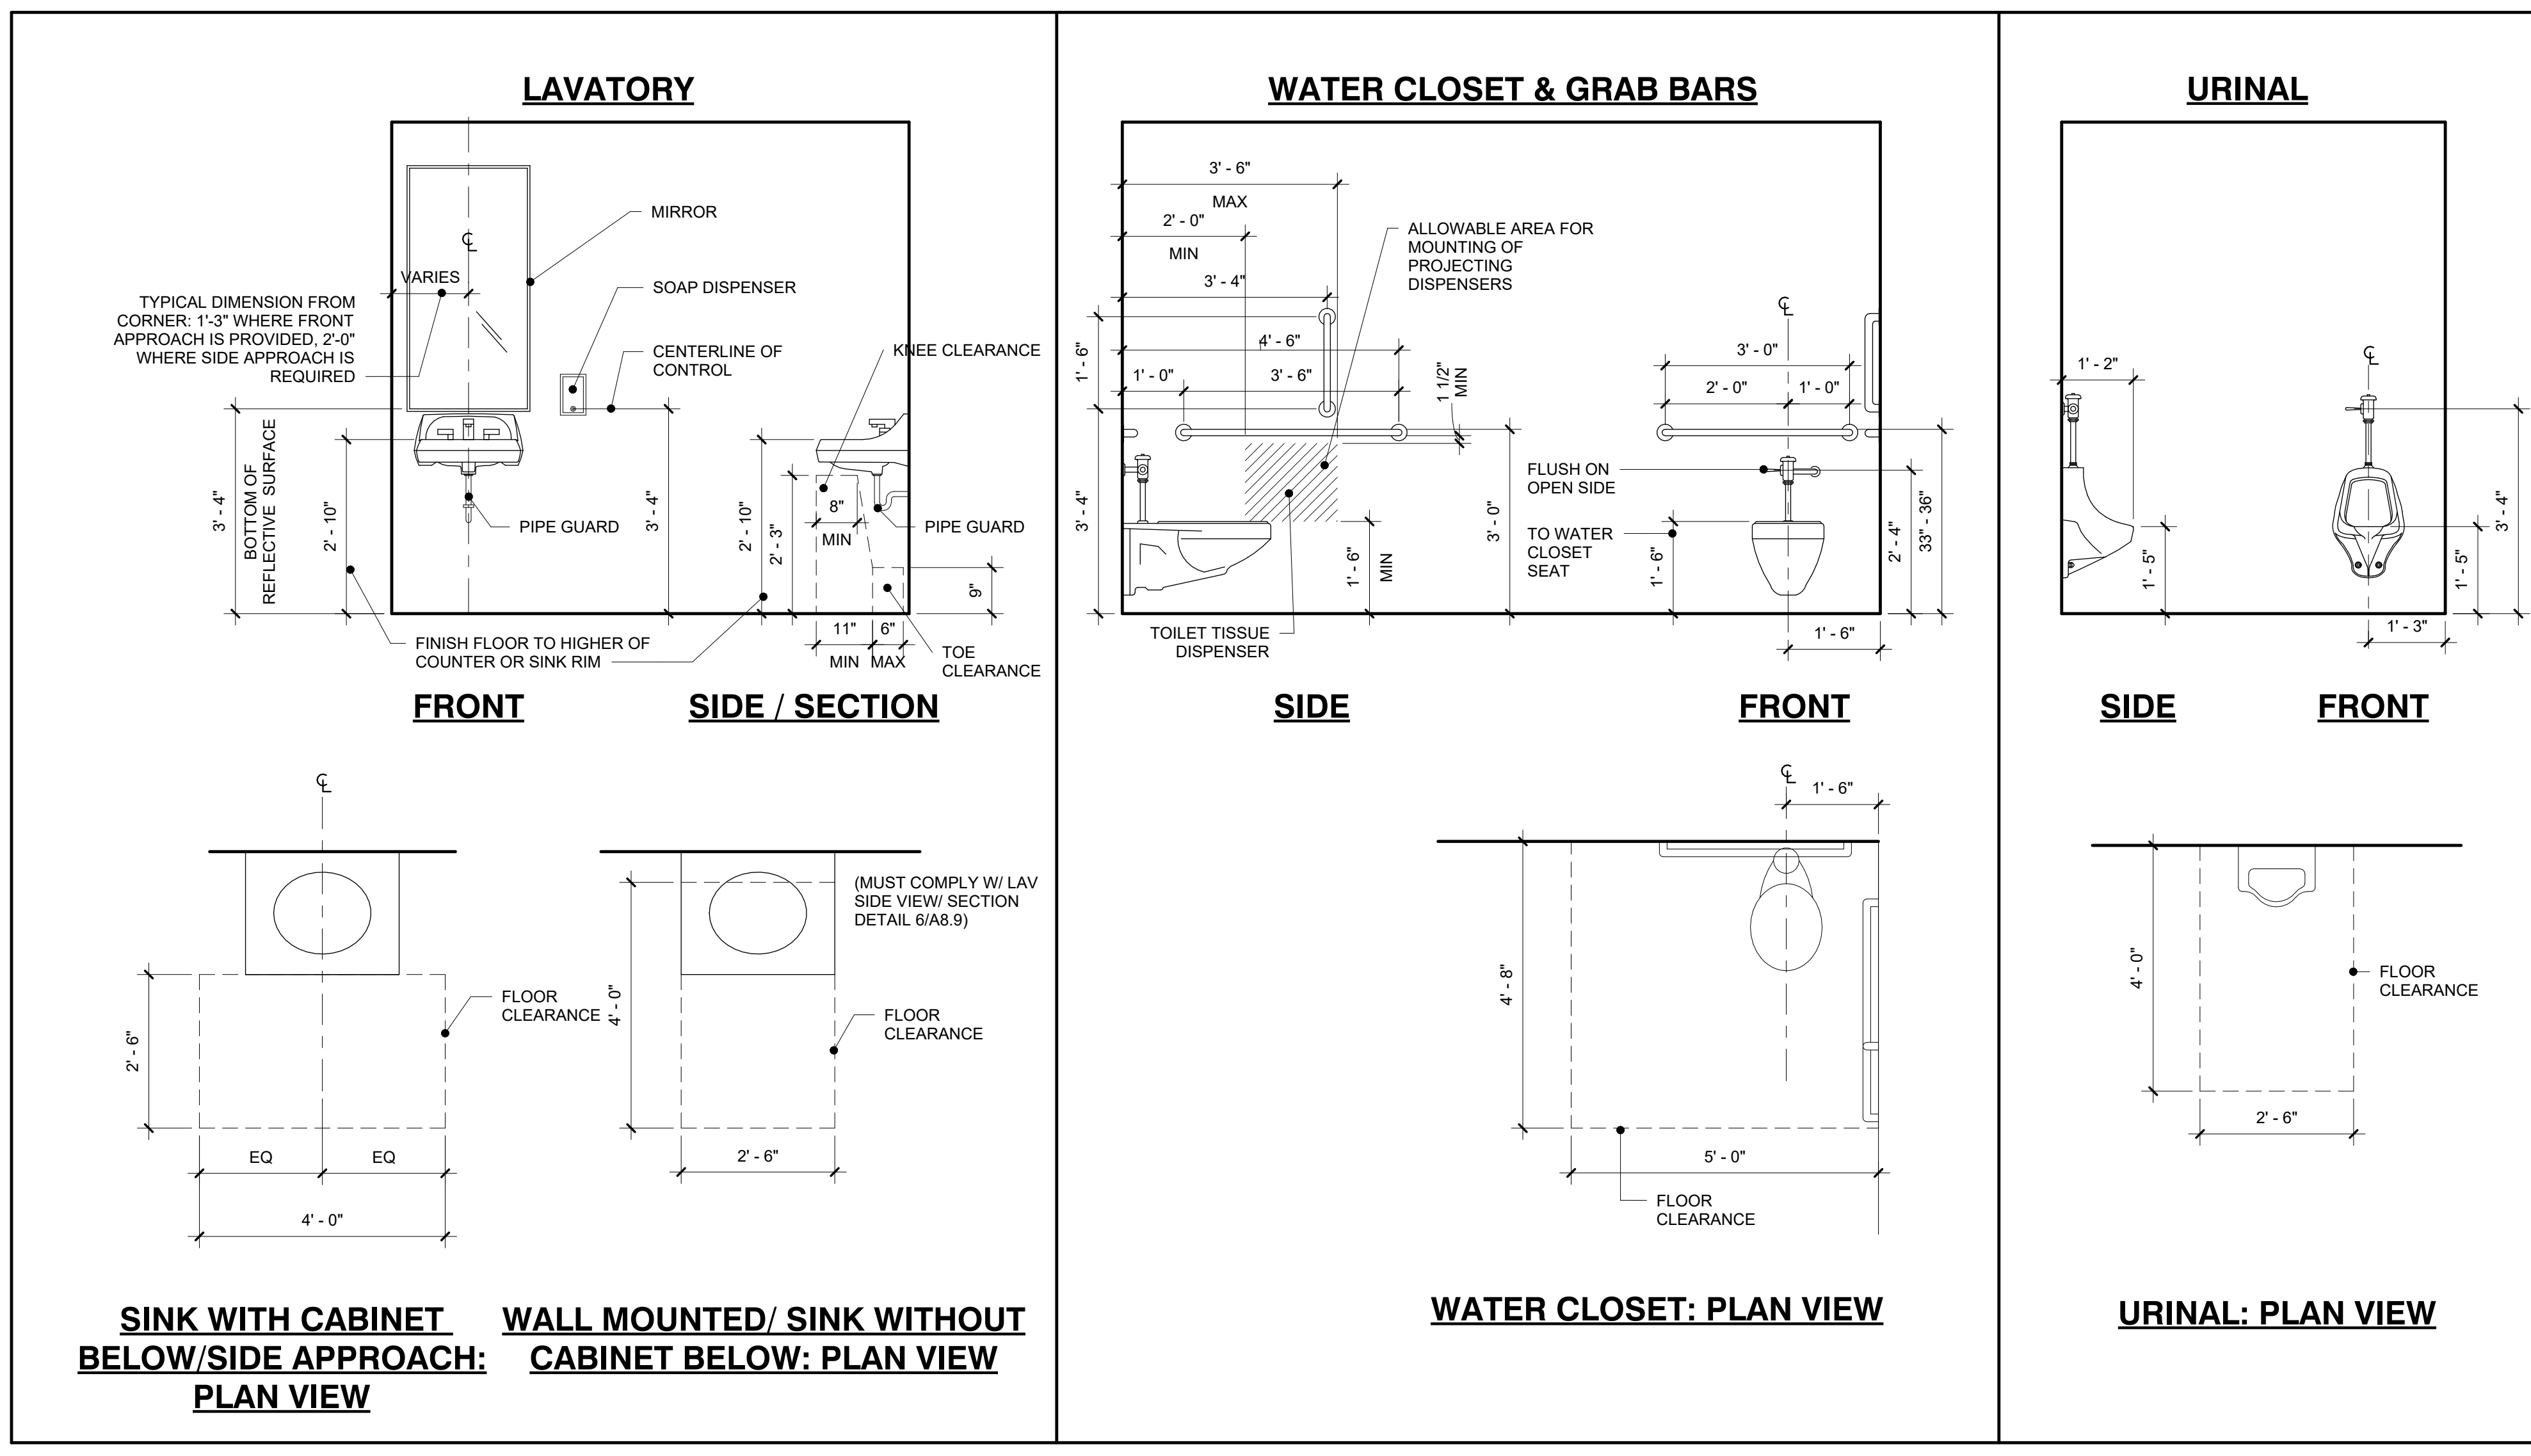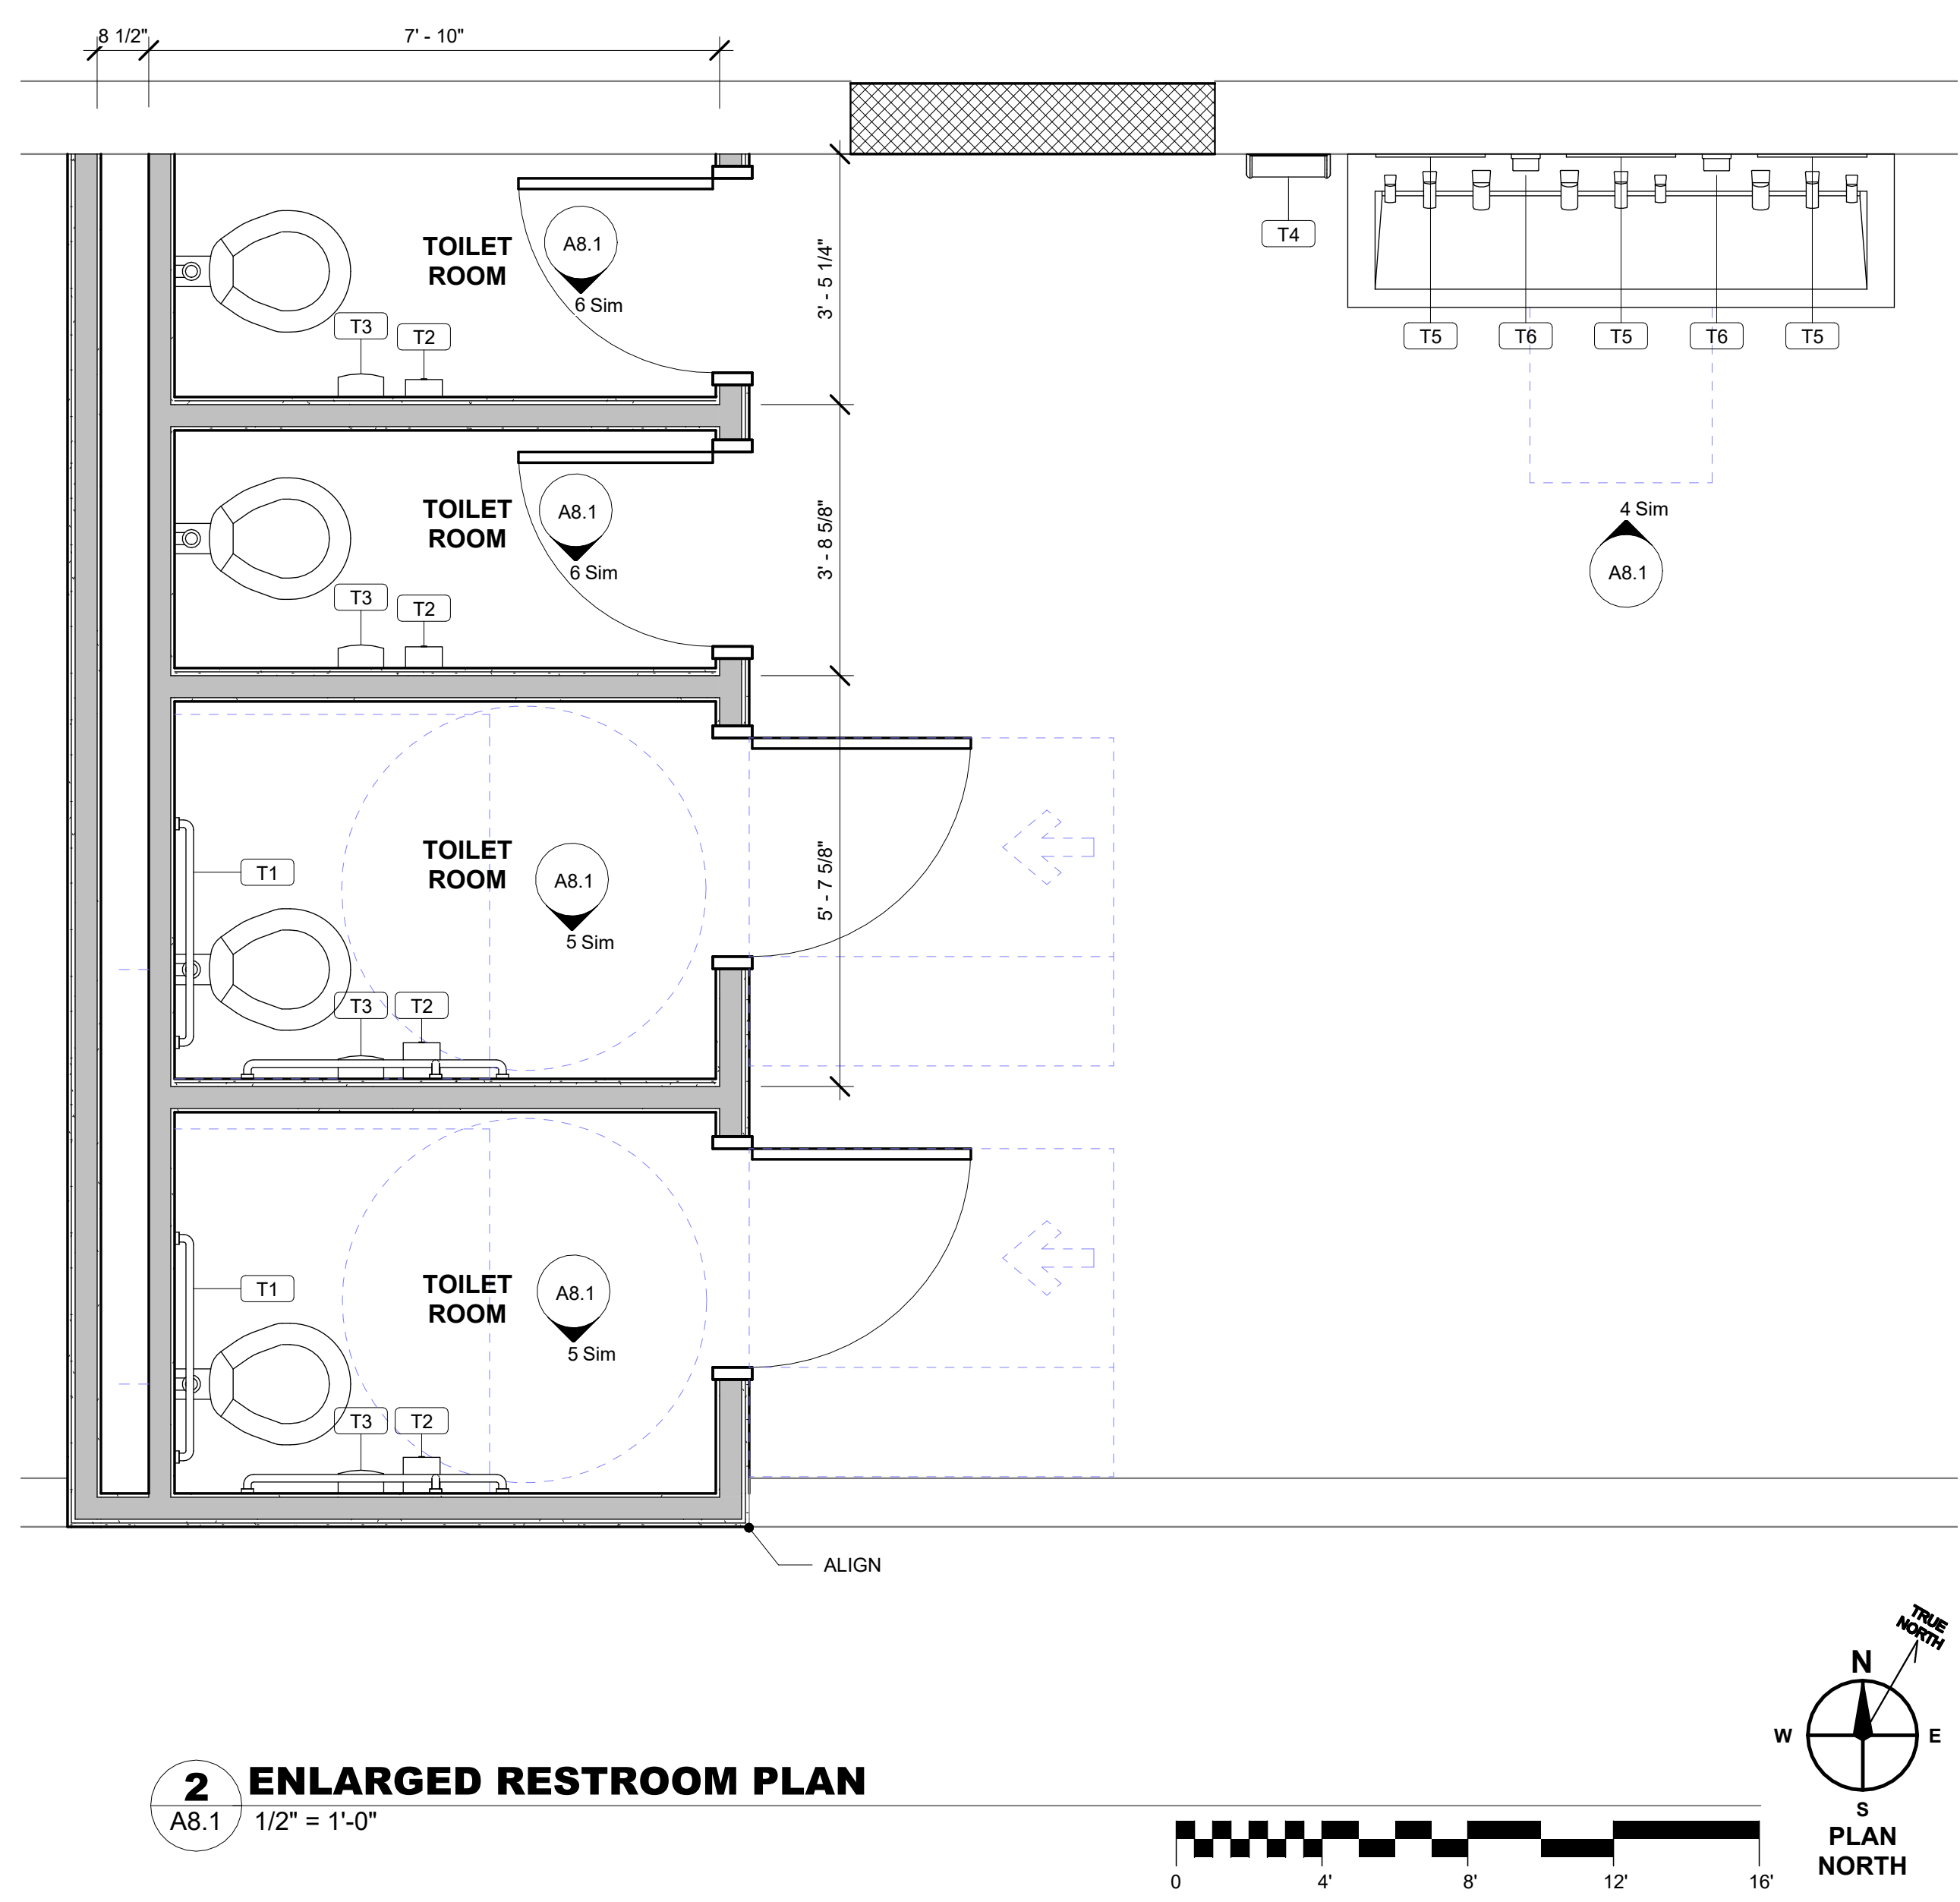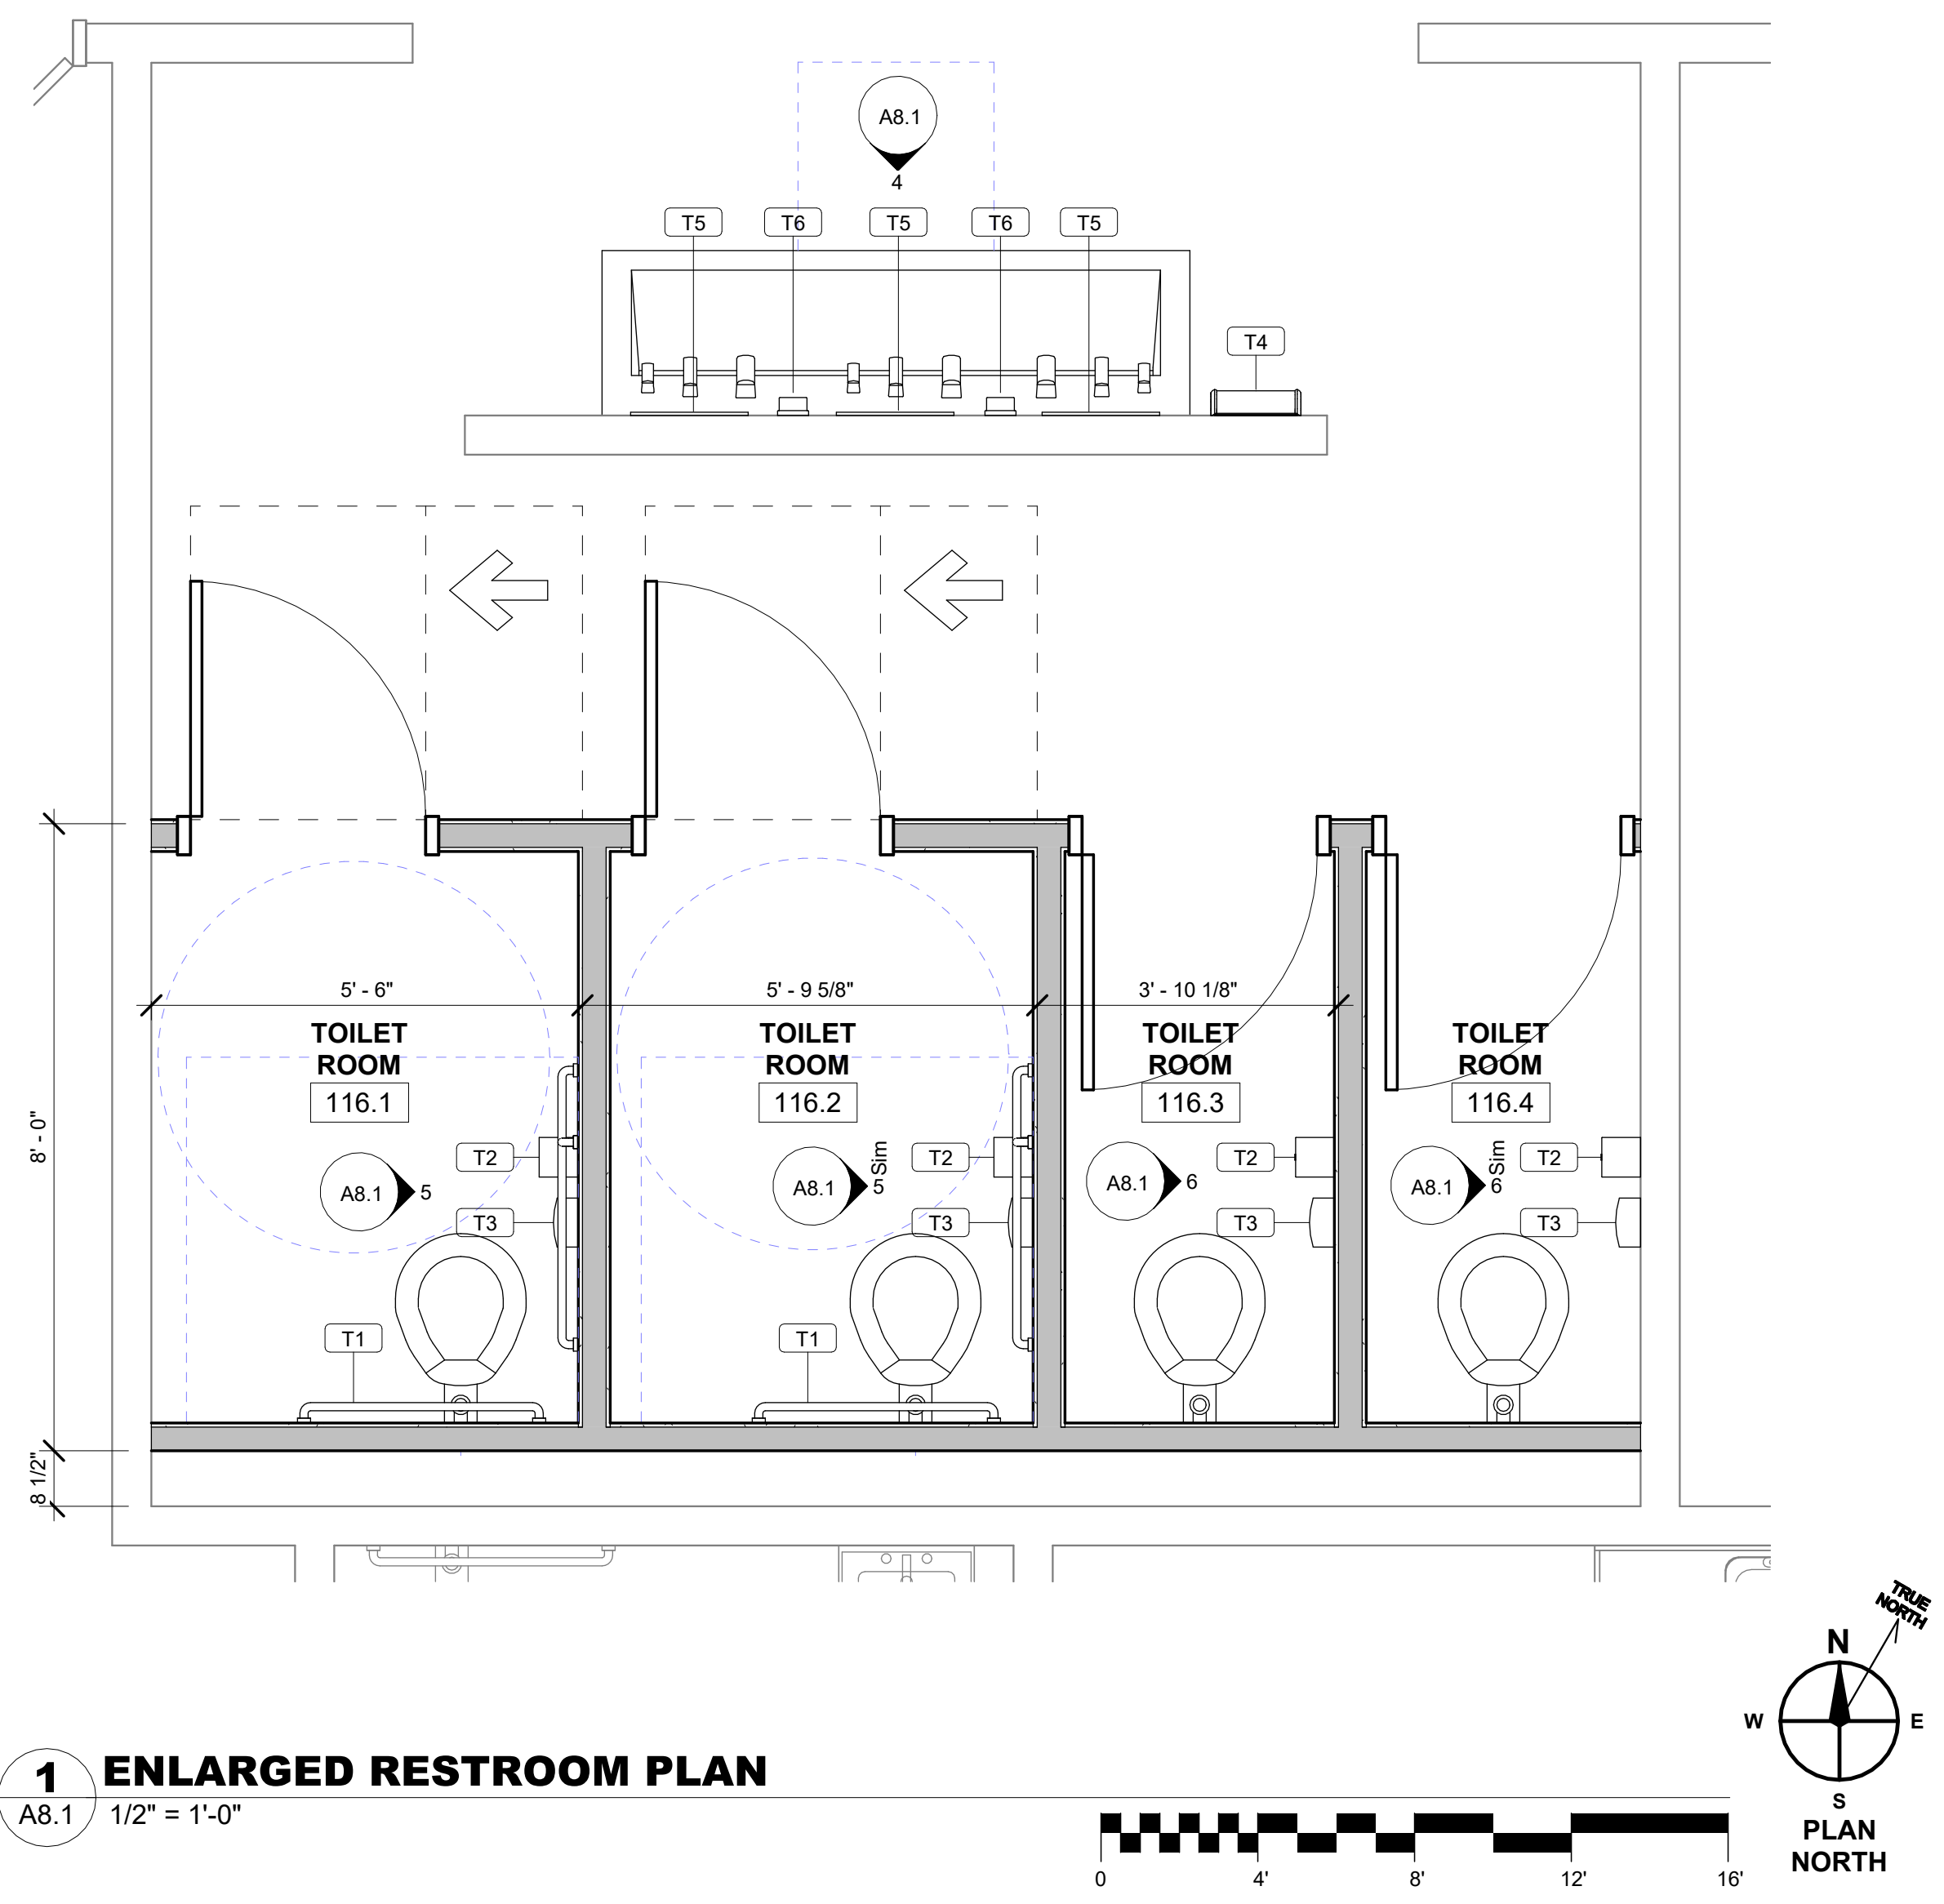

**3 ACCESSIBILITY DETAILS - ADULTS**  
A8.1 1/2" = 1'-0"

Type Mark	Description	Comments
T1	Grab Bar Set - Water Closet	
T2	Surface-Mounted Multi-Roll Toilet Tissue Dispenser	
T3	Surface-Mounted Sanitary Napkin Disposal	
T4	Automatic Surface Mounted ADA Hand Dryer	REINSTALL EXISTING
T5	Glass Mirror with Stainless Steel Angle Frame Bobrick B-290 Series	
T6	Surface Mounted Soap Dispenser, Bobrick - B2111	

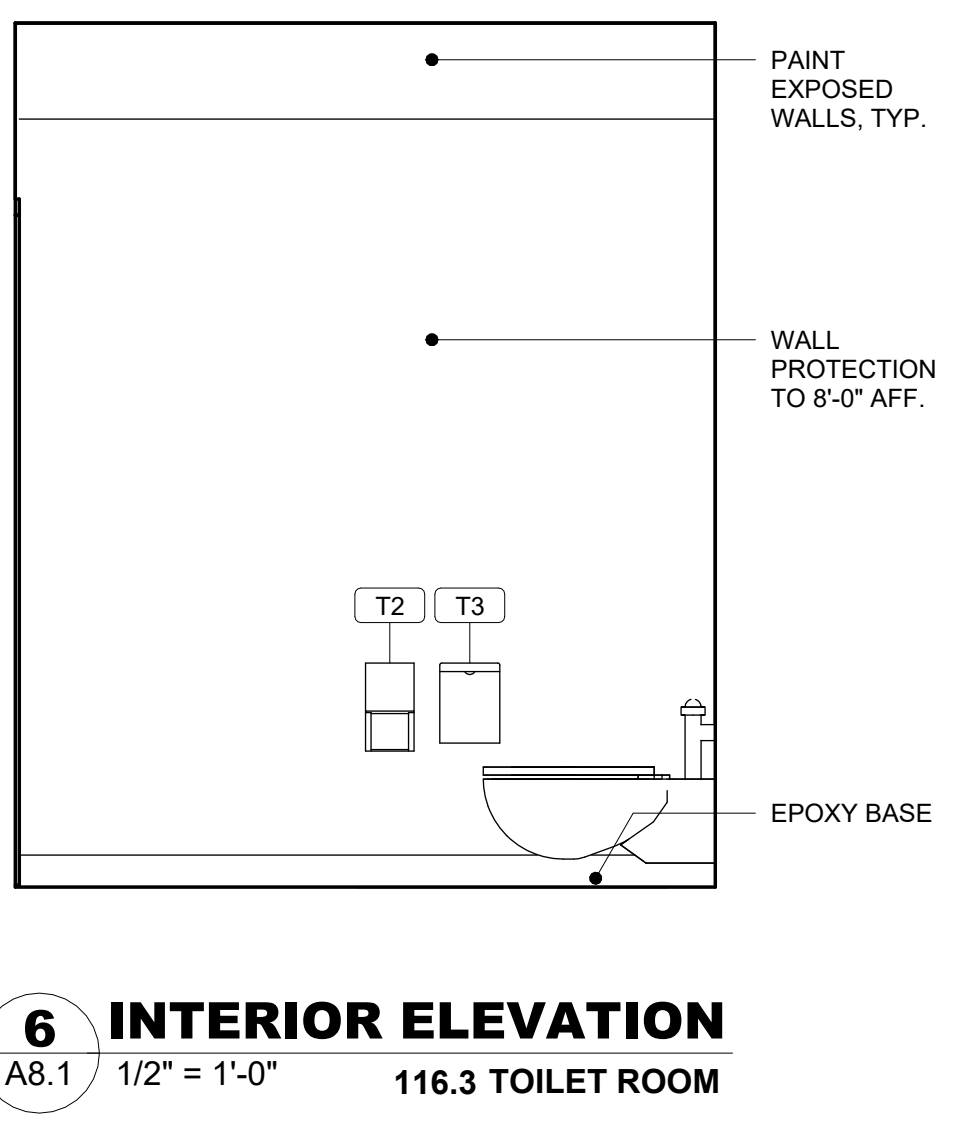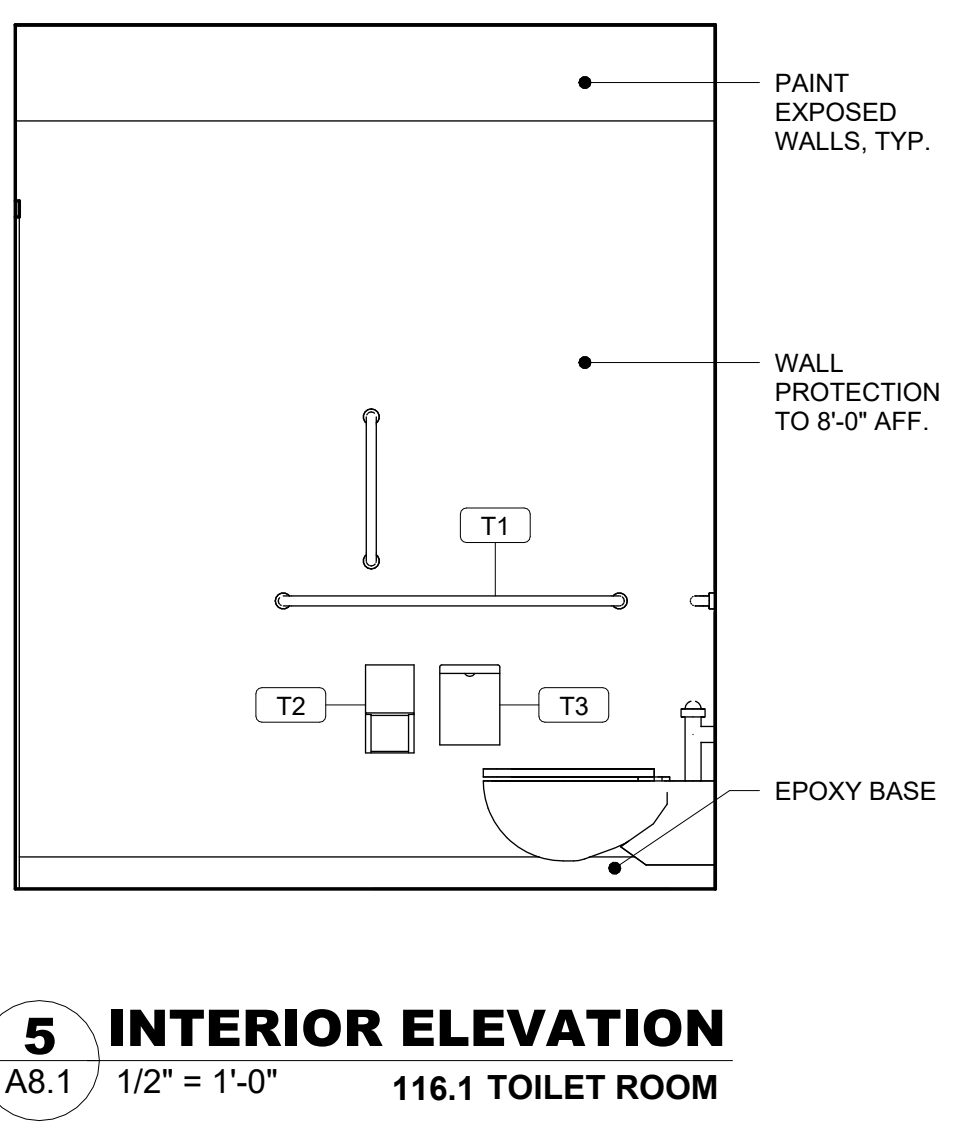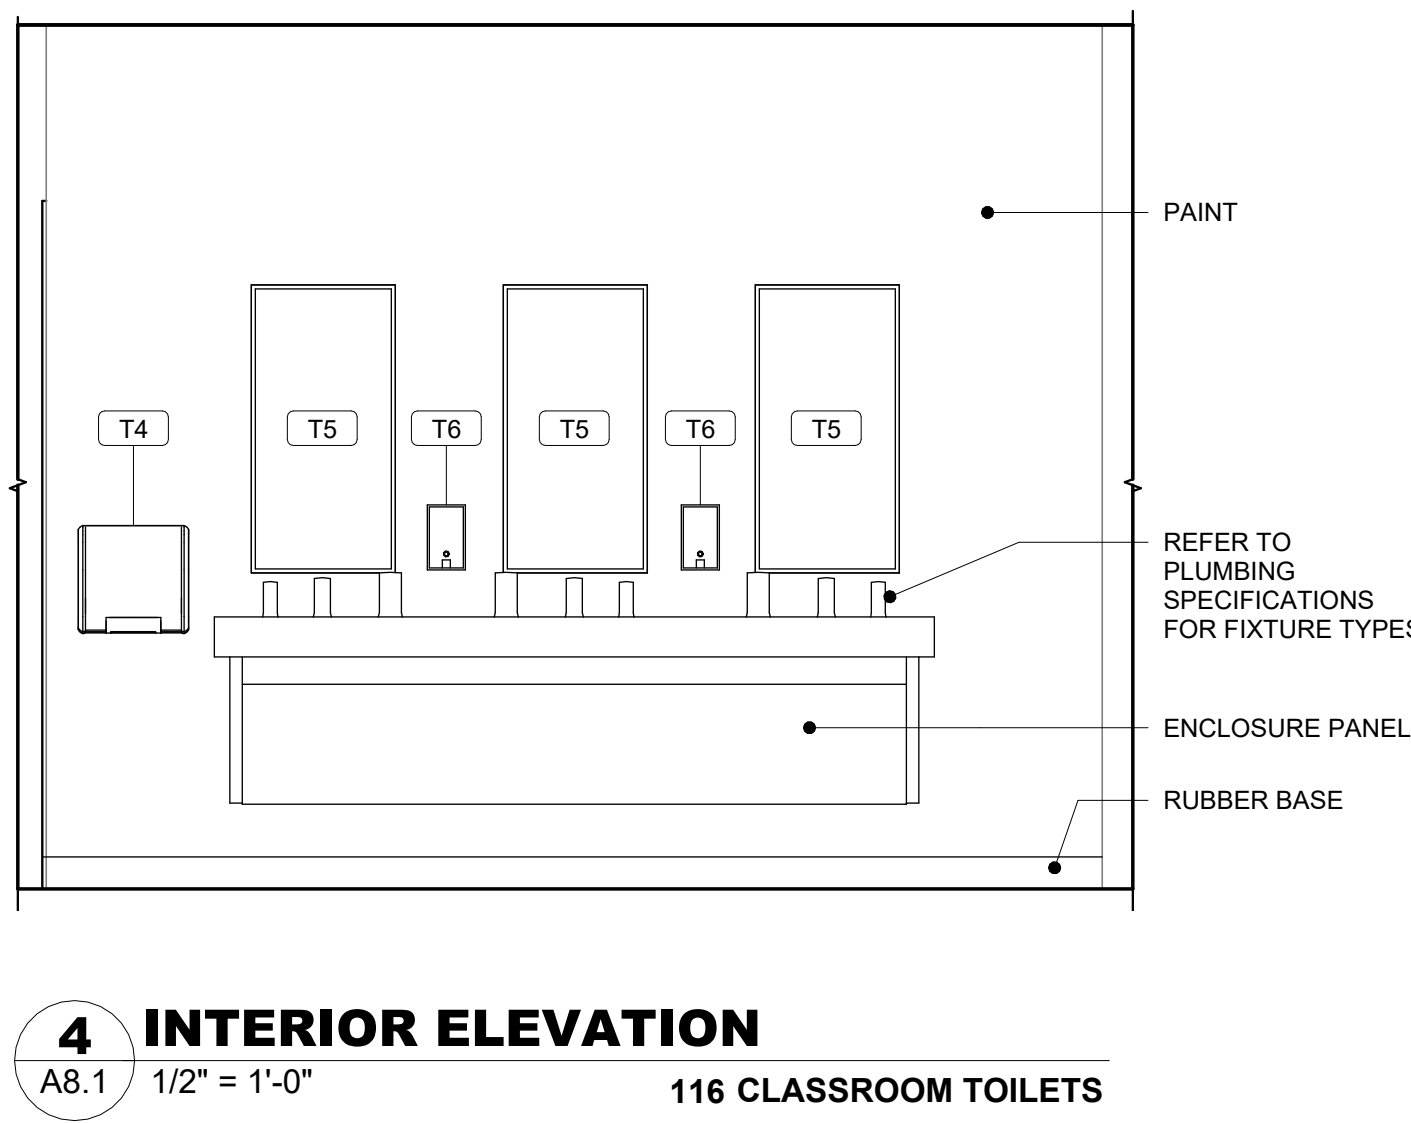

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DOOR SCHEDULE										
DOOR NUMBER	DOOR				FIRE RATING	FRAME				COMMENTS
	Width	SIZE HEIGHT	DOOR TYPE	DOOR MATERIAL		FRAME TYPE	FRAME MATERIAL	HEAD	JAMB	
Level 1										
116.1	3'-0"	7'-0"	F	HM	-	HM1	HM	1/A9.1	2/A9.1	
116.2	3'-0"	7'-0"	F	HM	-	HM1	HM	1/A9.1	2/A9.1	
116.3	3'-0"	7'-0"	F	HM	-	HM1	HM	1/A9.1	2/A9.1	
116.4	3'-0"	7'-0"	F	HM	-	HM1	HM	1/A9.1	2/A9.1	
123.1	3'-0"	7'-0"	F	HM	-	HM1	HM	1/A9.1	2/A9.1	
123.2	3'-0"	7'-0"	F	HM	-	HM1	HM	1/A9.1	2/A9.1	
131.1	3'-0"	7'-0"	F	HM	-	HM1	HM	1/A9.1	2/A9.1	
131.2	3'-0"	7'-0"	F	HM	-	HM1	HM	1/A9.1	2/A9.1	
131.3	2'-8"	7'-0"	F	HM	-	HM1	HM	1/A9.1	2/A9.1	
131.4	2'-8"	7'-0"	F	HM	-	HM1	HM	1/A9.1	2/A9.1	



WINDOW SCHEDULE - INTERIOR							
Type Mark	Operation	Type Comments	Height	Width	Sill Height	Details	Comments
W1	FIXED	HM FRAME	4'-0"	6'-0"	3'-4"	3,4,5	

**LEGEND**


GL GLASS PANEL  
M.O. MASONRY OPENING

**GENERAL DOOR AND FRAME NOTES**


- ALL DOORS LOCATED AT CORNERS IN STUD WALLS SHALL BE LOCATED 4" FROM ADJACENT PERPENDICULAR WALL TO OUTSIDE OF FRAME UNLESS DIMENSIONED OTHERWISE
- UNDERCUT DOORS AS REQUIRED TO OPERATE SMOOTHLY OVER FINISHED FLOOR. MAXIMUM UNDERCUT SHALL BE 3/4", UNLESS NOTED OTHERWISE FINISH BOTTOM OF DOORS AFTER UNDERCUTTING.

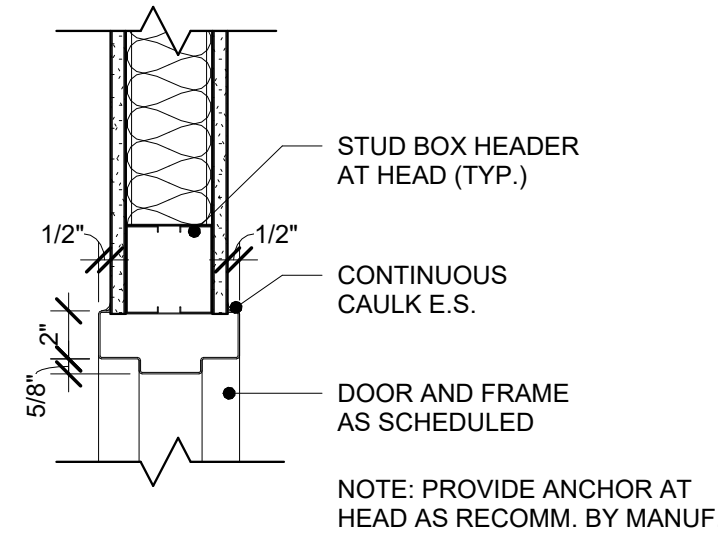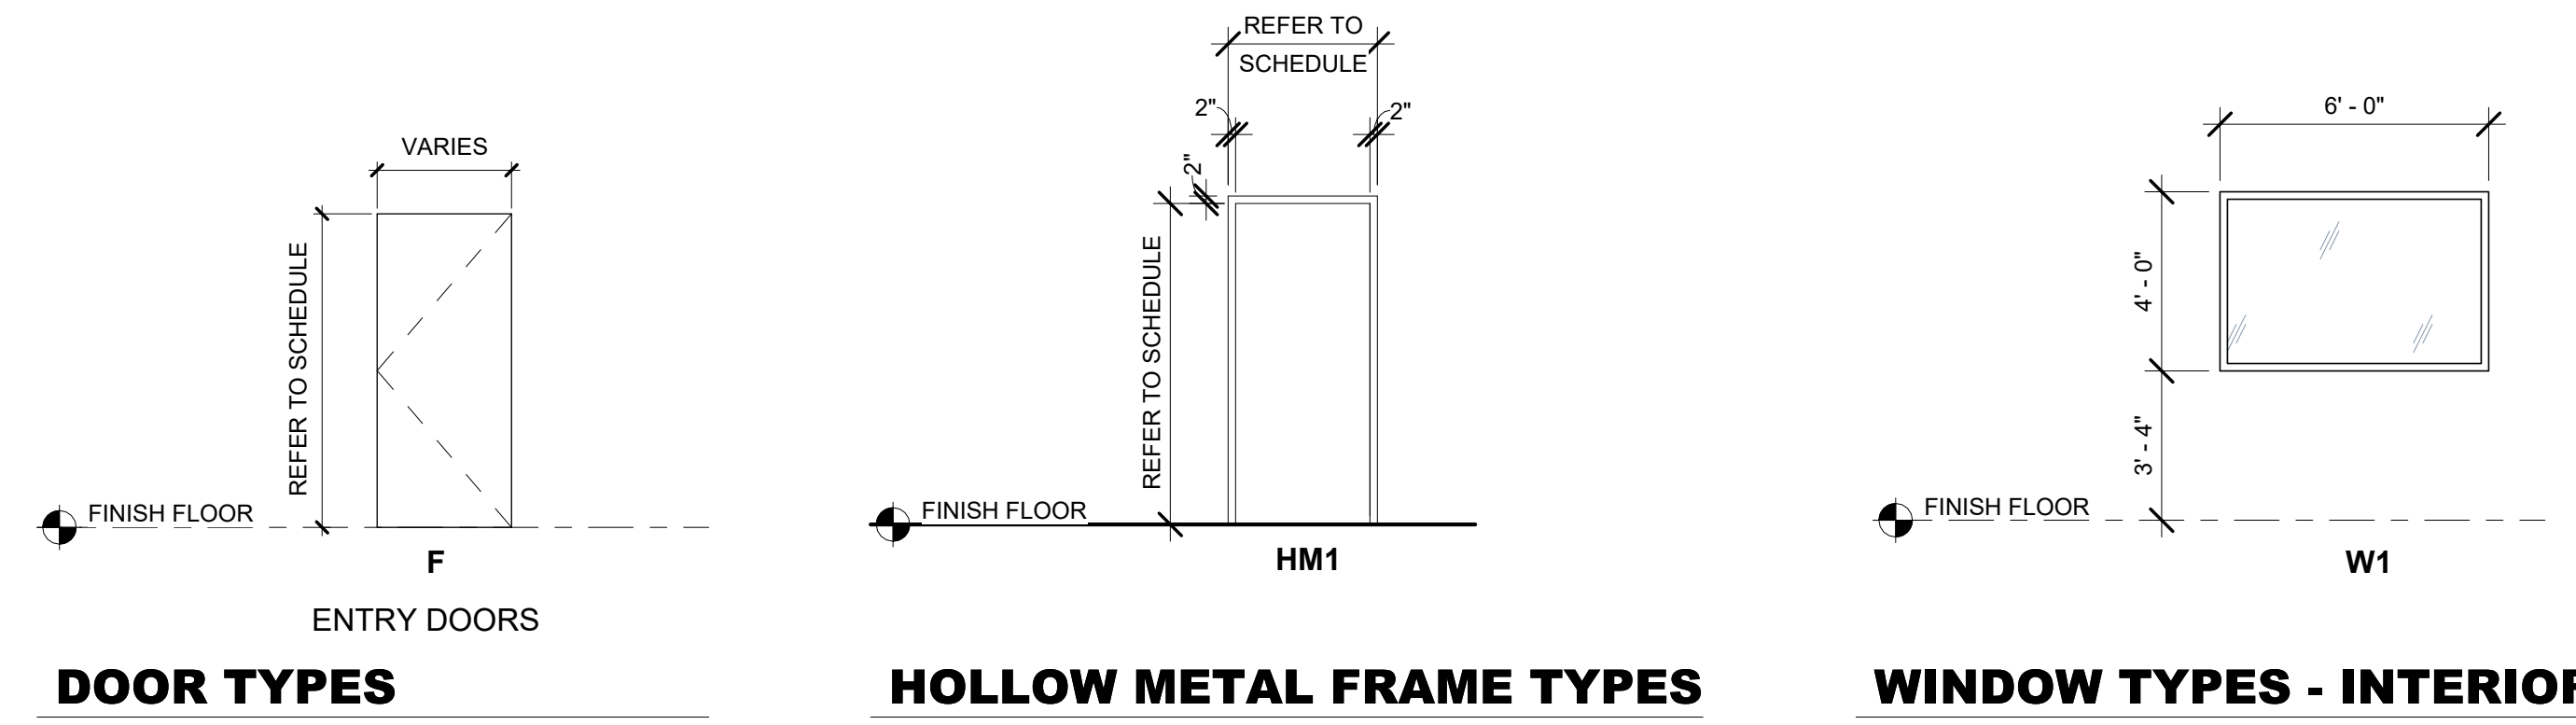


**1 HEAD DETAIL**  
A9.1 1 1/2" = 1'-0"

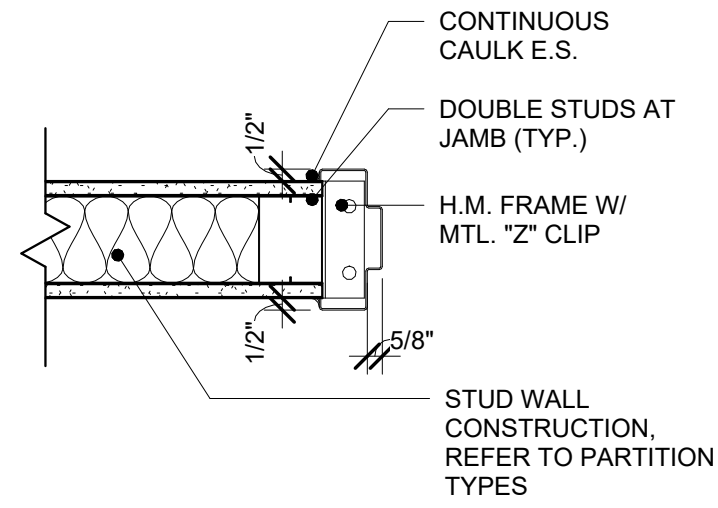


**2 JAMB DETAIL**  
A9.1 1 1/2" = 1'-0"

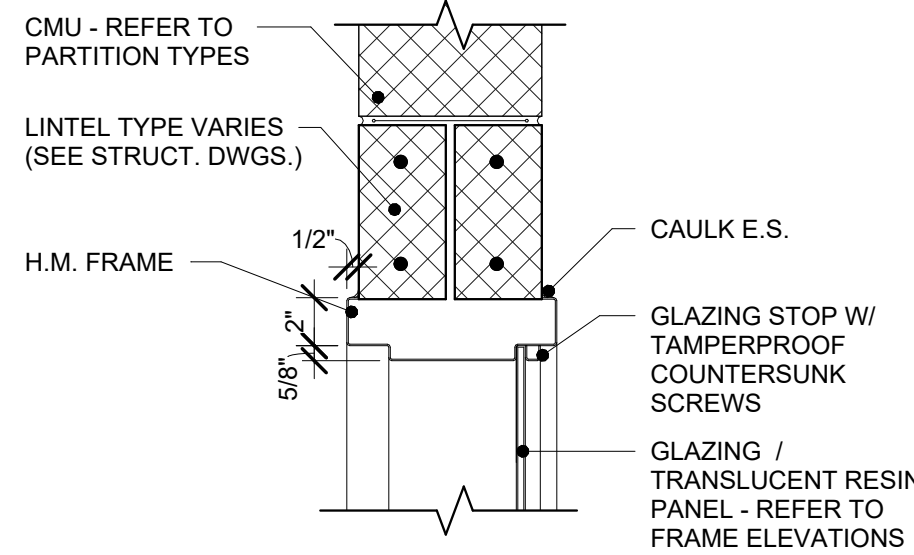

**3 INTERIOR WINDOW HEAD**  
A9.1 1 1/2" = 1'-0"

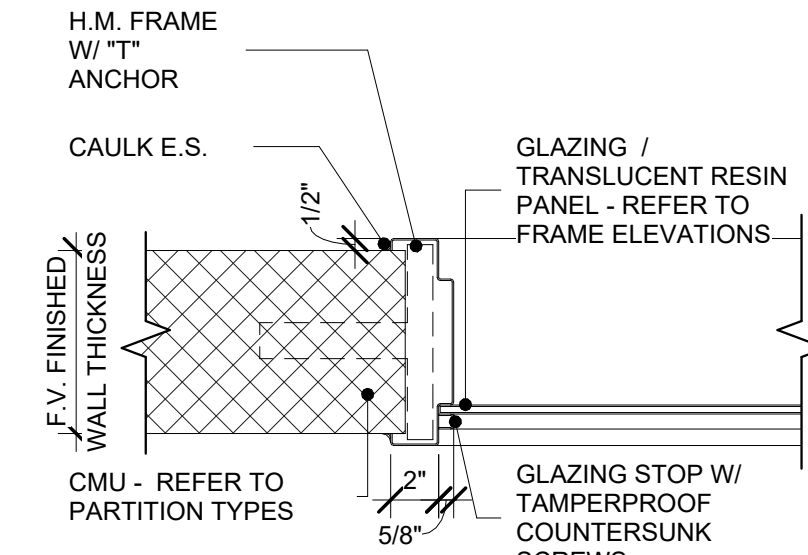

**4 INTERIOR WINDOW JAMB**  
A9.1 1 1/2" = 1'-0"

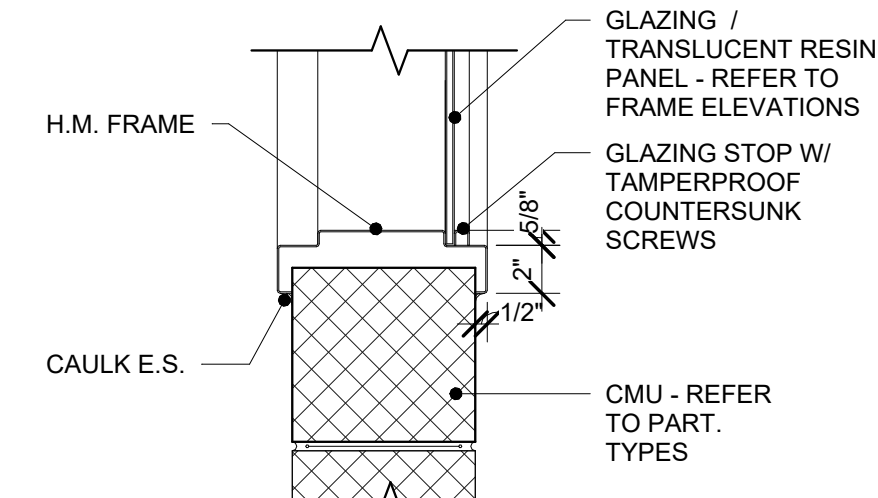

**5 INTERIOR WINDOW SILL**  
A9.1 1 1/2" = 1'-0"

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CONSULTANT: \_\_\_\_\_

RENOVATION TO  
**JACK WALKER CLUBHOUSE**  
BOYS & GIRLS CLUB  
229 W LEMON ST, LANCASTER, PA 17603

ISSUE DATES	DESCRIPTION
DATE: 10/01/2024	BID DOCUMENTS

PROJ #: 24-800-01 DRAWN BY: DRW

SHEET TITLE:  
**DOOR & WINDOW SCHEDULE, TYPES, & DETAILS**

SHEET NUMBER:  
**A9.1**  
**BID**














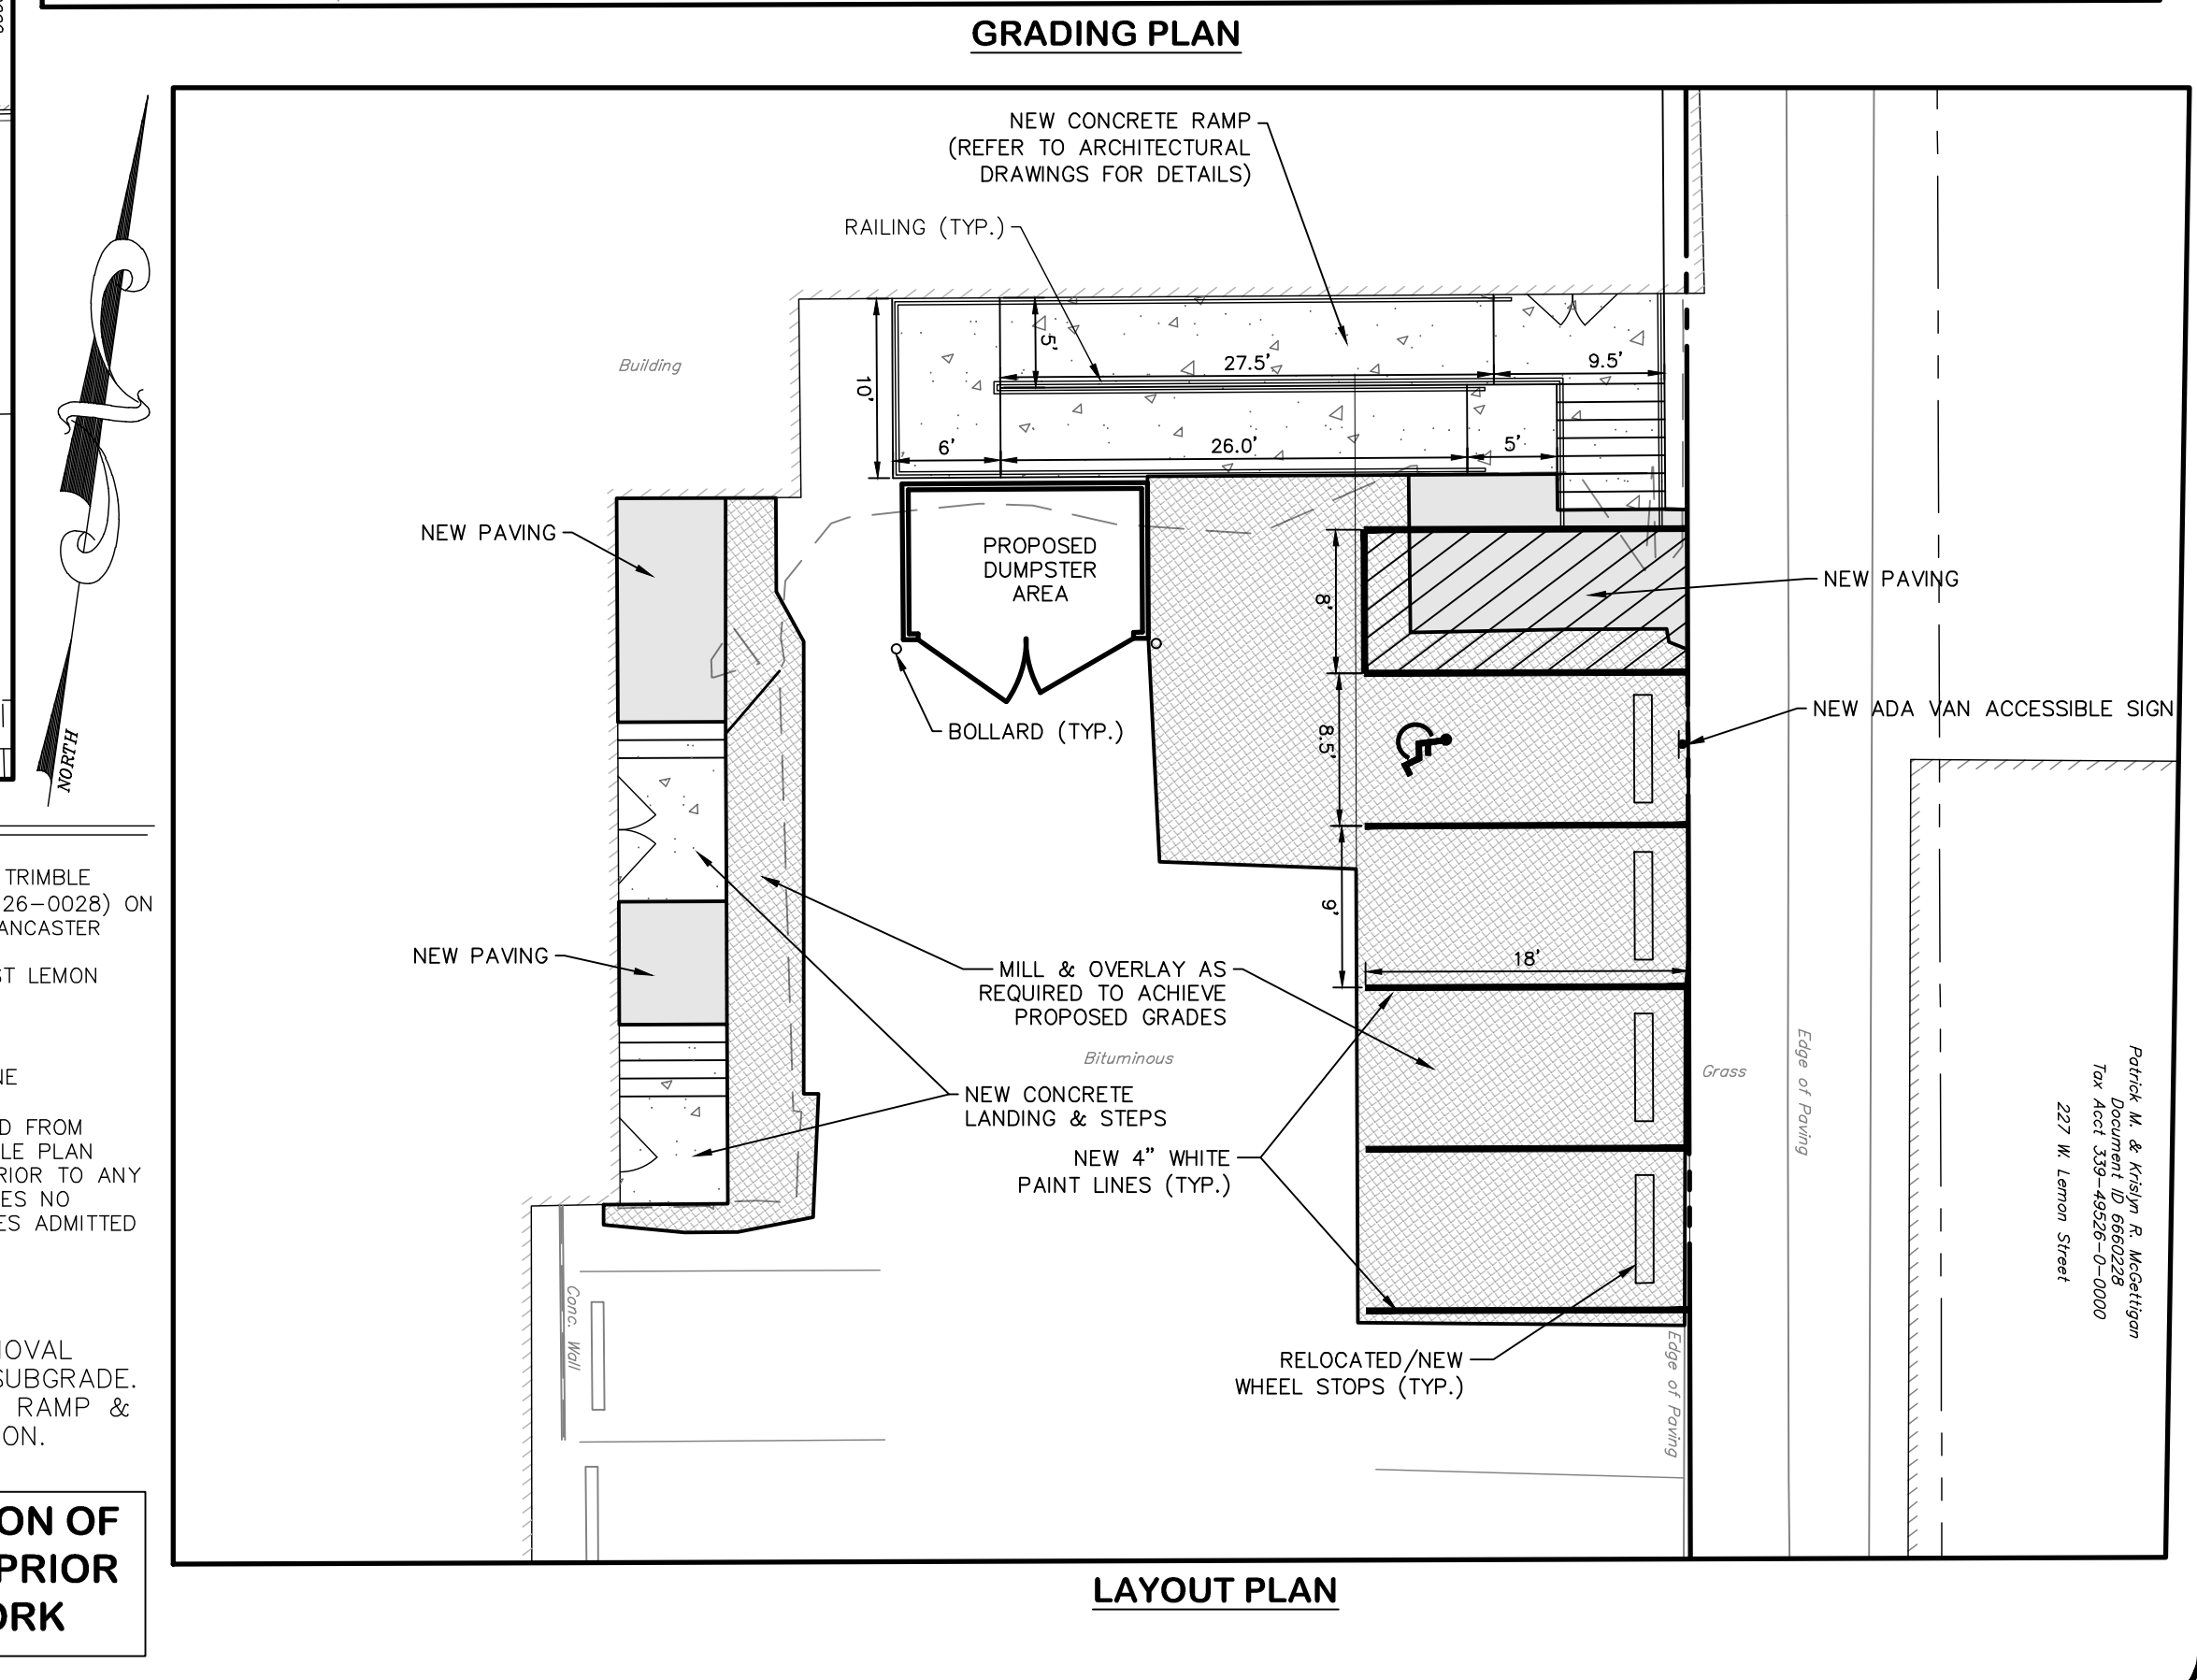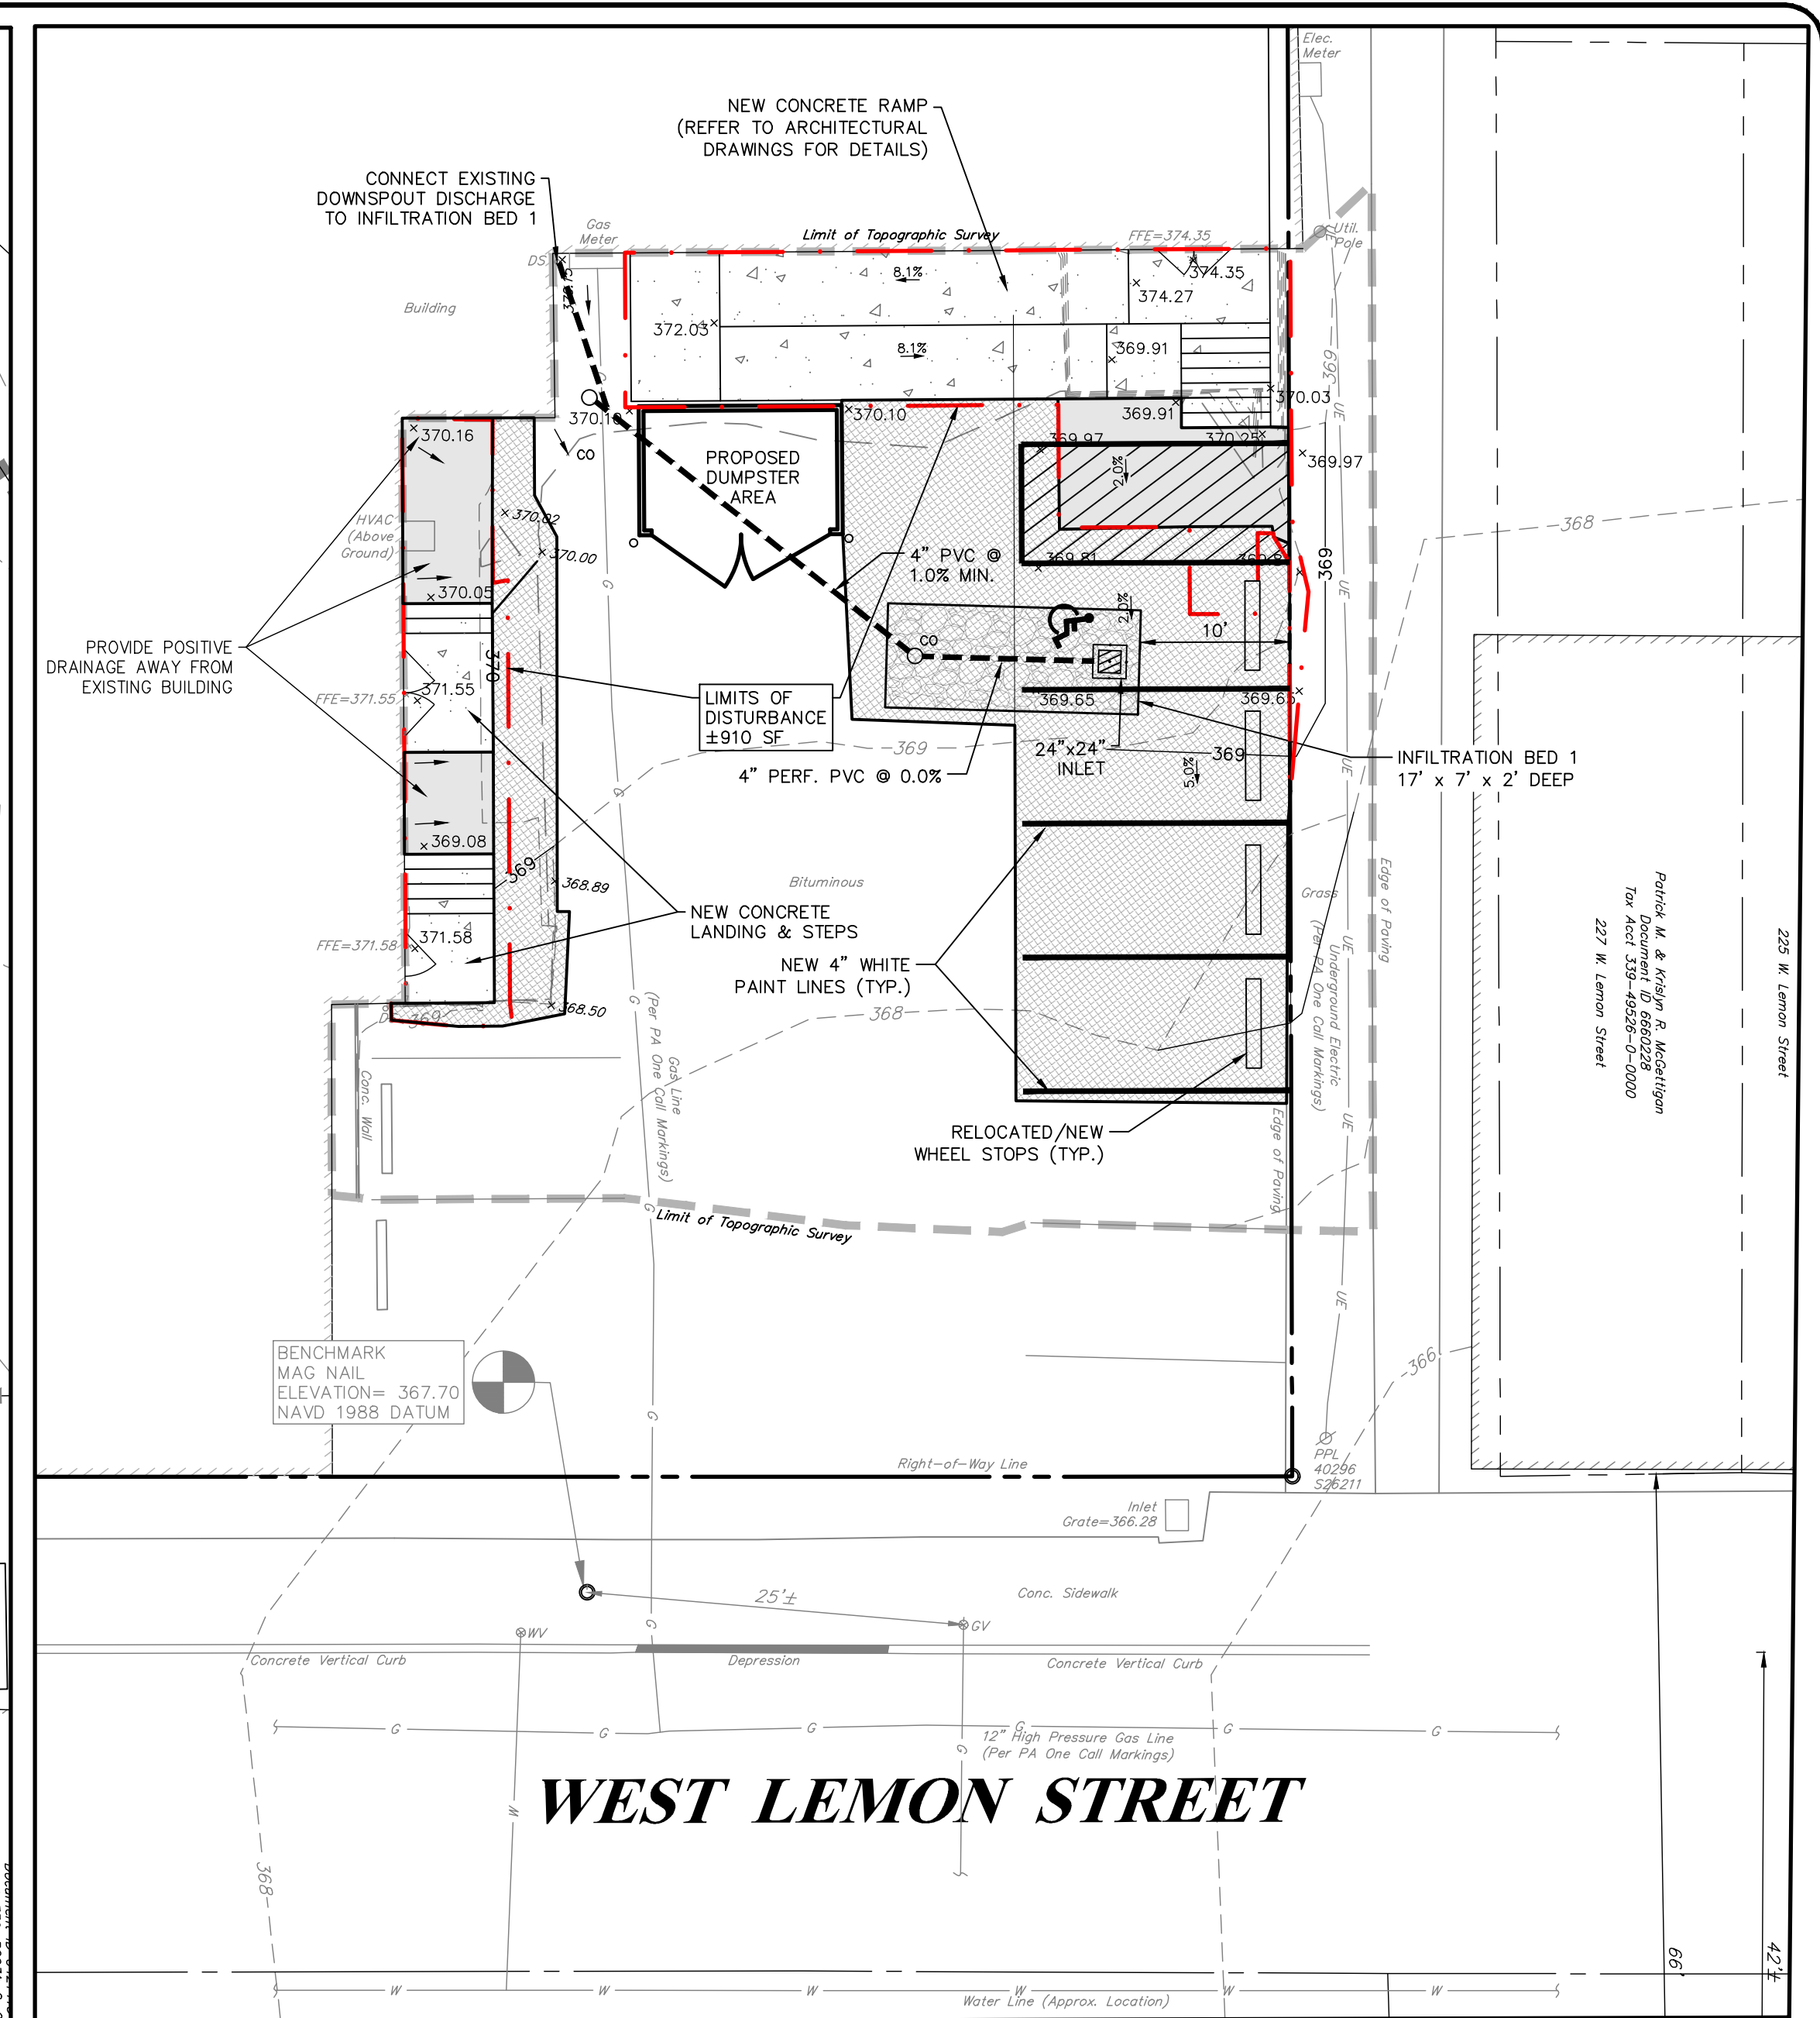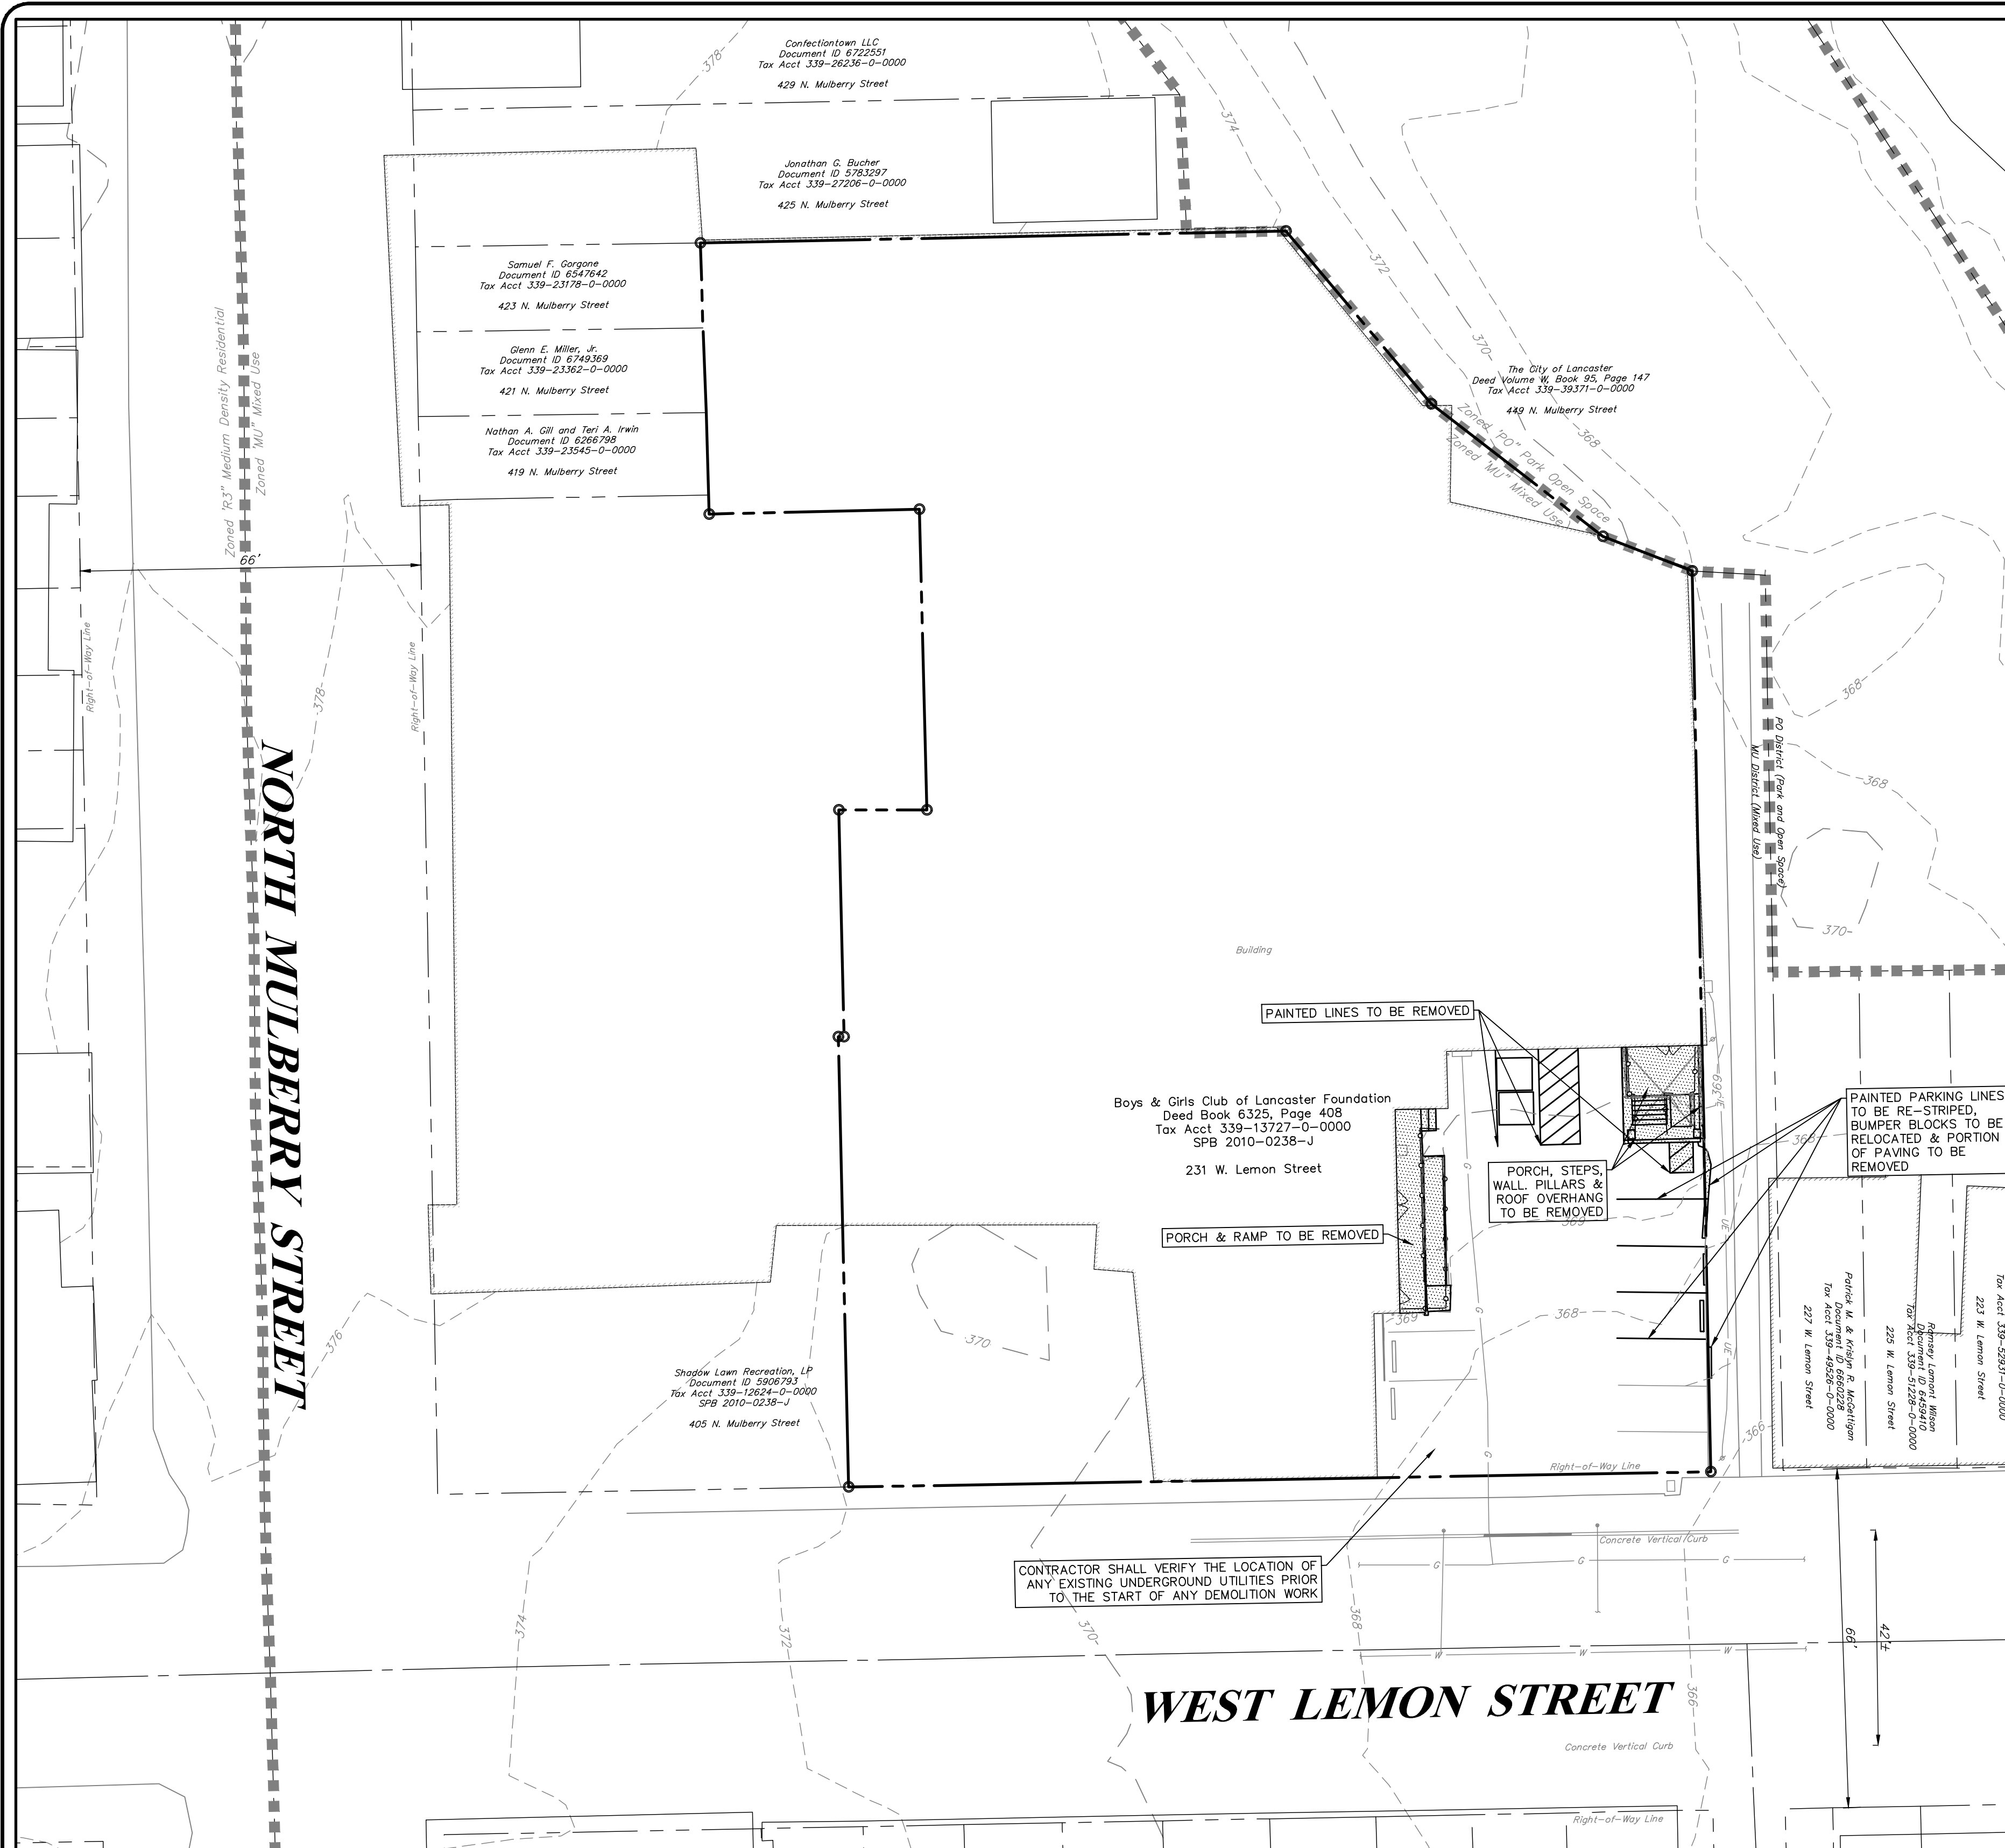

**HARBOR ENGINEERING**  
 HARBOR ENGINEERING, INC.  
 4100 W. MARKET STREET  
 WARRINGTON, PA 15090  
 PHONE (717) 666-6000  
 FAX (717) 666-6001  
 CIVIL ENGINEERING - LANDSCAPE ARCHITECTURE

**PROJECT TITLE**  
 SMALL STORMWATER MANAGEMENT PLAN FOR 231 WEST LEMON STREET

**OWNER**  
 BOYS & GIRLS CLUB OF LANCASTER FOUNDATION  
 JACK WALKER CLUB HOUSE  
 229 WEST LEMON STREET  
 LANCASTER, PA 17602  
 (717) 397-5614

**SHEET TITLE**  
 EXISTING CONDITIONS / DEMOLITION / LAYOUT & GRADING PLAN

**SCALE**  
 1" = 10'

**DRAWN BY:** BRK  
**CHECKED BY:** SPG  
**DATE:** SEPTEMBER 30, 2024  
**PROJECT NO.:** 24426-036

**SHEET:** 1 OF 2







































