
REPAIR BRICK, MORTAR AND ROOF BUILDING 1

DEPARTMENT OF VETERANS AFFAIRS PROJECT NO. 503-24-105
JAMES E. VAN ZANDT VA MEDICAL CENTER
BUILDING 1
2907 PLEASANT VALLEY BOULEVARD.
ALTOONA, PA 16602

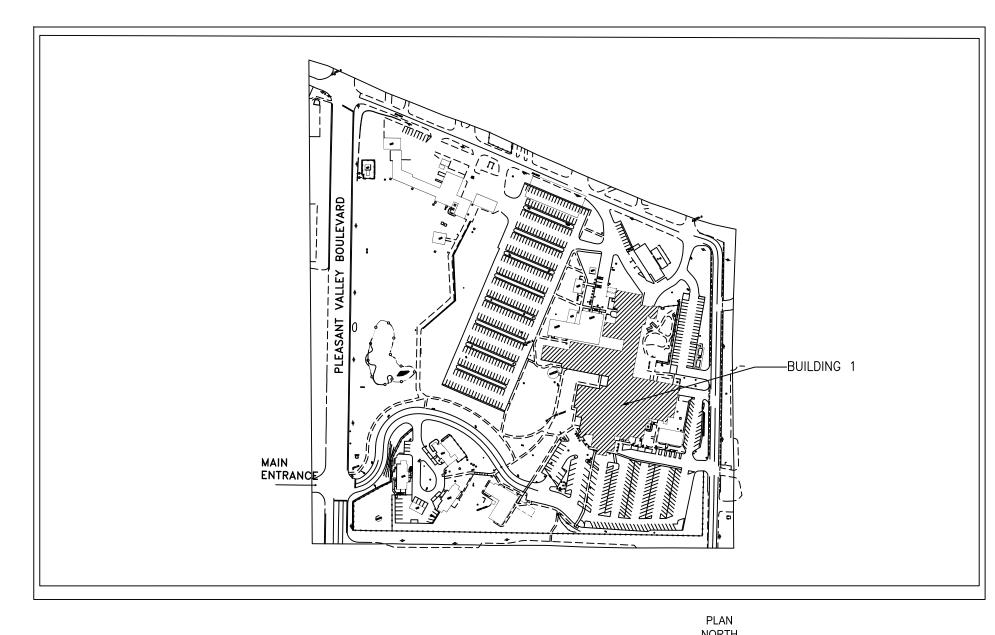

BUILDING KEY PLAN SCALE: NTS

<u>Drawing index</u>

GIOO1- COVER SHEET
AS100- OVERVIEW
AD102- ROOF DEMO PLAN
AE102- ROOF PLAN
AE203- MASONRY PLAN
AE504- CONSTRUCTION DETAILS

Project Number

Building Number

Drawing Number

GI001

503-24-105

REPAIR BRICK, MORTAR, AND


Checked

JAMES E VAN ZANDT MC

ROOF BLDG 1

	CONSULTANT	ARCHITECT/ENGINEER OF RECORD	Constr	ce of truction acilities		CONSTRUCTION DOC.
			Manag	gement	Approved: Project Director	
Revisions: Date:			VA U.S. of Vo	S. Department Veterans Affairs		

VA FORM 08 - 6231

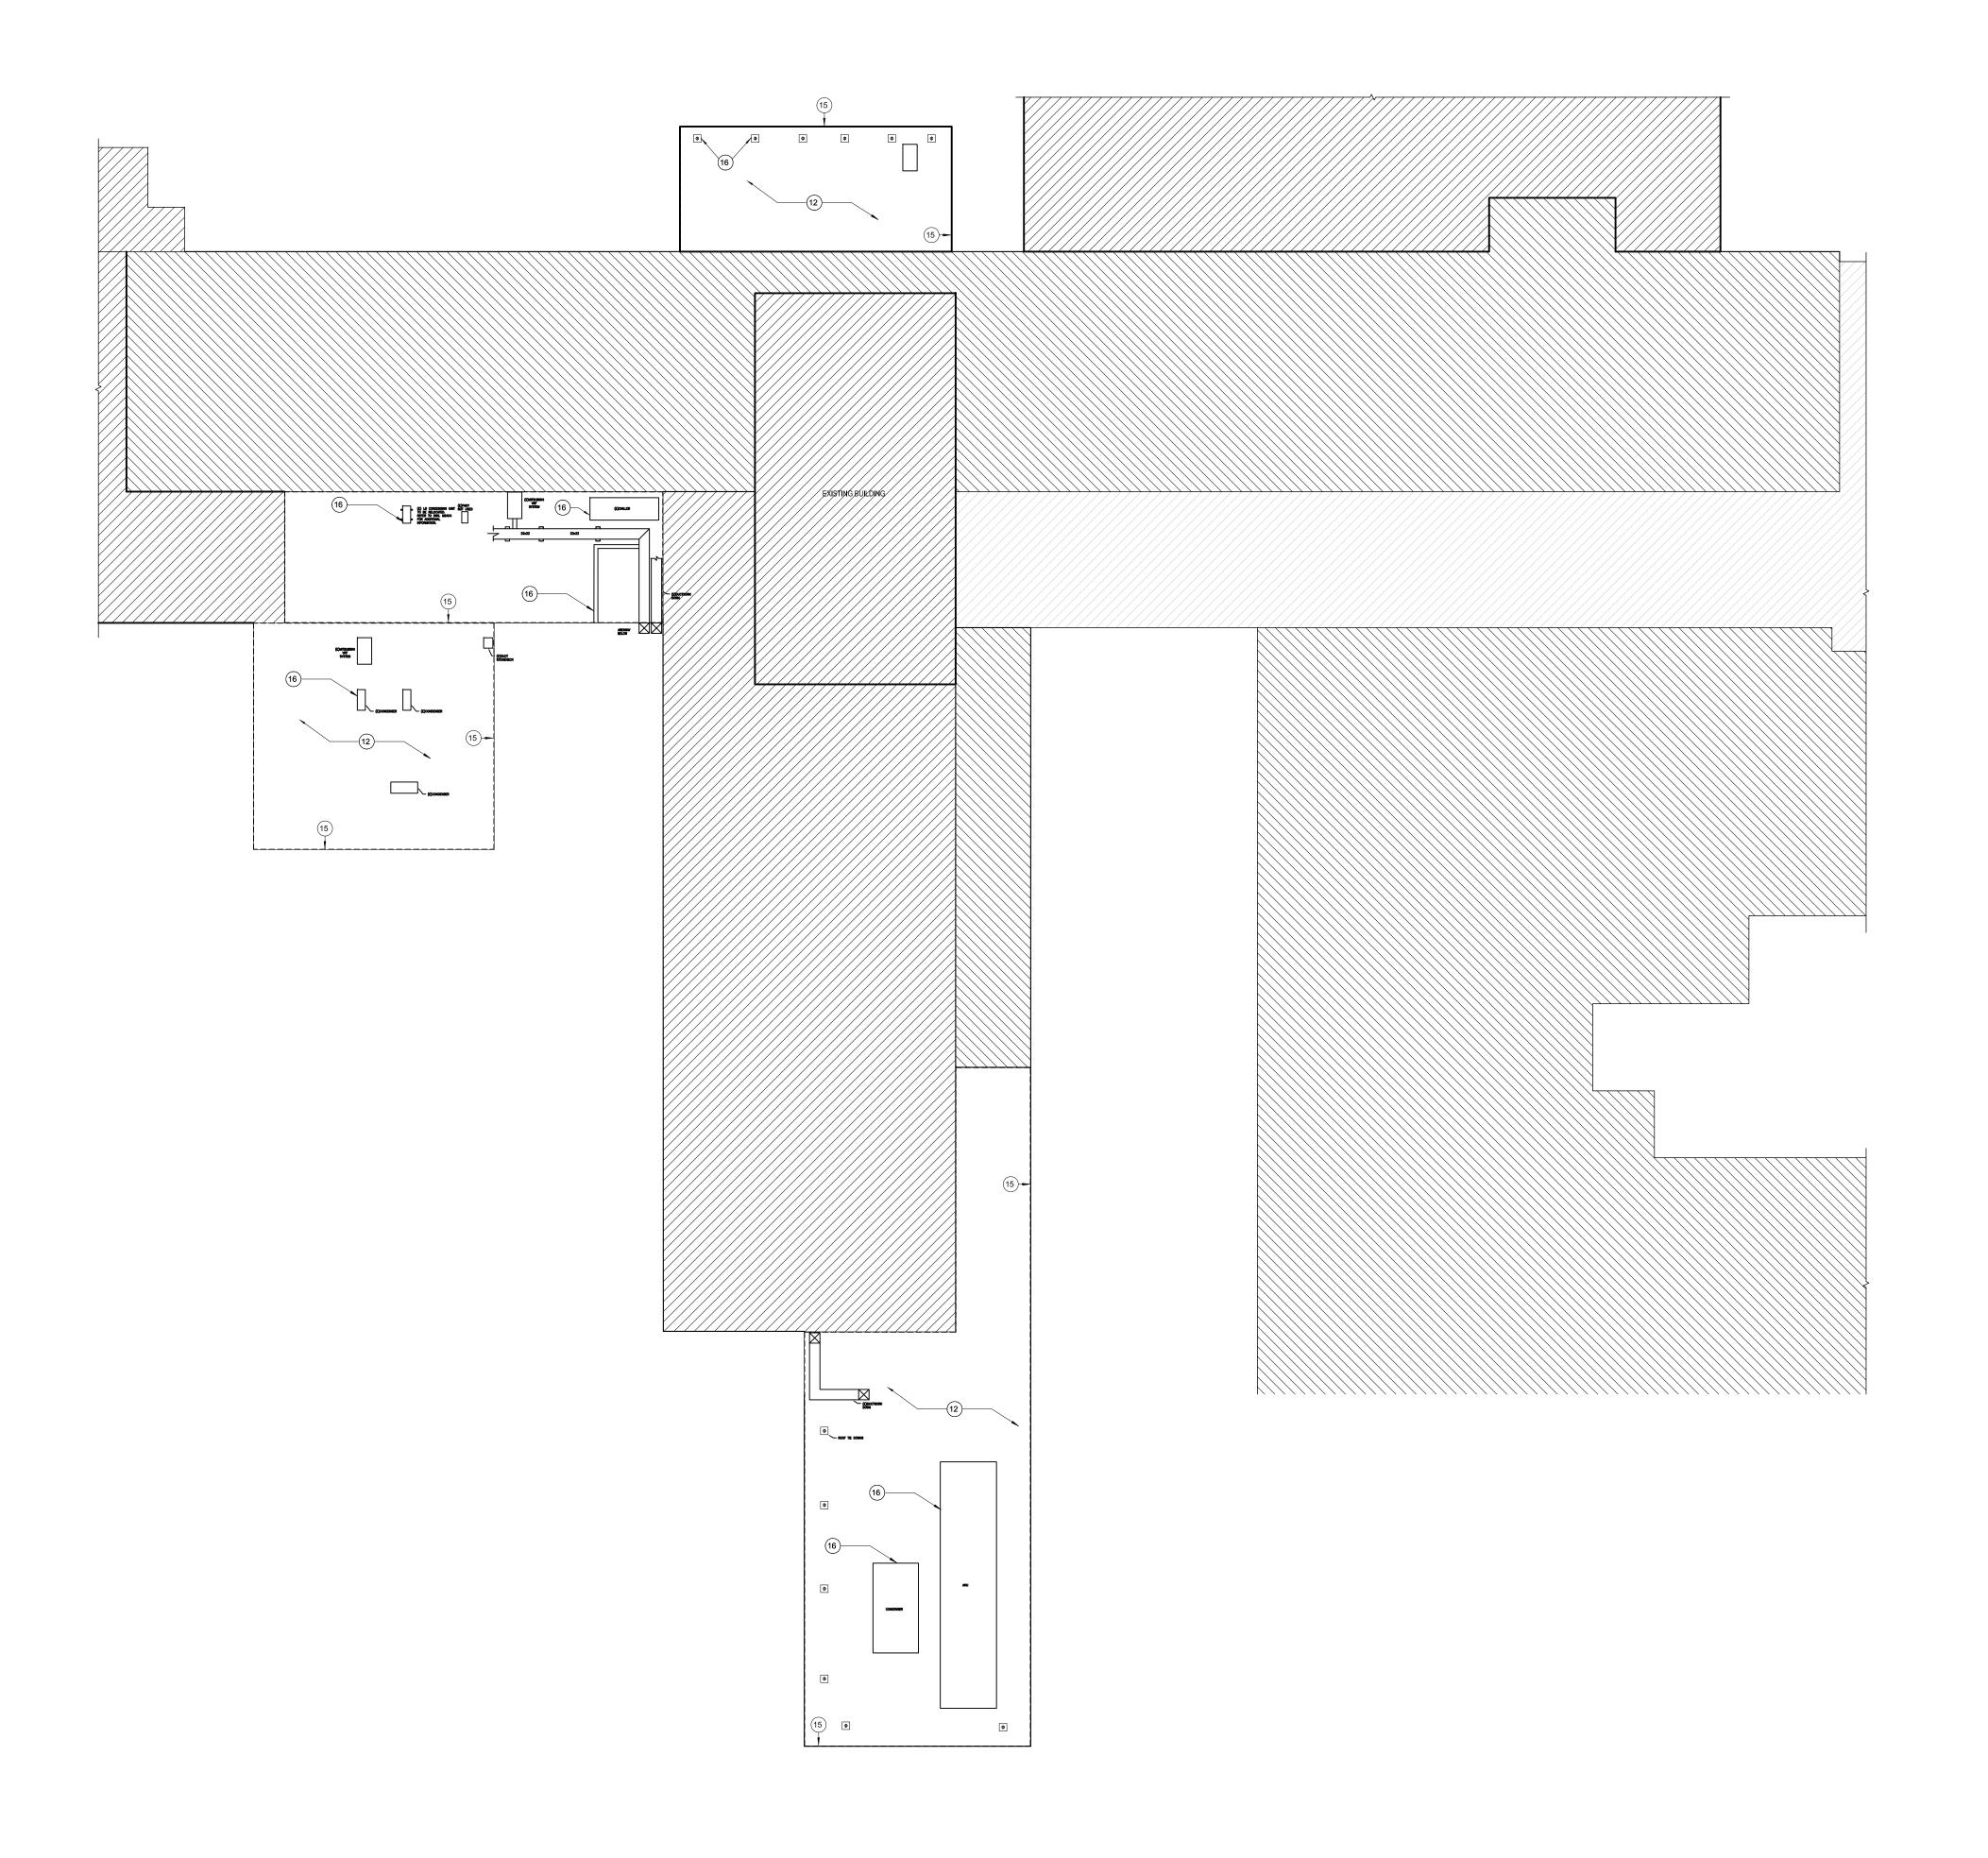

1 PARTIAL ROOF PLAN

	CONSULTANT	ARCHITECT/ENGINEER OF RECORD	STAMP	Office of Construction and Facilities Management	OVERVIEW Approved: Project Director	CONSTRUCTION DOC.	Project Title REPAIR BRIC ROOF BLDG Location JAMES E VA		ID B	Project Number 503-24-105 Building Number 01 Drawing Number
Revisions:	Date:			U.S. Department of Veterans Affair	'S		Issue Date 9/3/2024	Checked Dra		AS100
2	3	4 5		6	7	8	9		10	10

SHEET NOTES

- 1. THE CONSTRUCTOR SHALL PROVIDE PROTECTION FOR ALL THE GENERAL PUBLIC AND CONSTRUCTION WORKERS IN AND AROUND THE CONSTRUCTION SITE. ADEQUATE BARRIERS SHALL BE PROVIDED TO EXERCISE CONTROL OF SAFE EGRESS AND EGRESS OF PREMISE. FIRE EXITS SHALL AT NO TIME BE
- 2. MINOR DETAILS NOT USUALLY SHOWN OR SPECIFIED BUT NECESSARY FOR PROPER CONSTRUCTION OF ANY PART OF THE WORK SHALL BE INCLUDED AS IF THEY WERE INDICATED ON THE DRAWINGS.
- THE CONSTRUCTOR SHALL BE RESPONSIBLE FOR MAINTAINING WATERTIGHT INTEGRITY OF THE BUILDING AT ALL TIMES. ALL WATER DAMAGE SHALL BE REPAIRED AT NO ADDITIONAL COST AND TO THE SATISFACTION OF THE GOVERNMENT.
- THE CONSTRUCTION AREA SHALL BE THROUGHLY CLEANED.
- ALL WORK TO BE PERFORMED OFF SCAFFOLD SUPPLIED BY THE CONTRACTOR WITH A CERTIFIED SCAFFOLD ERECTORS LICENSE, INSURANCE AND OSHA APPROVED TRAINING. PROOF OF THESE REQUIREMENTS WILL BE REQUIRED PRIOR TO ANY WORK. CONTRACTOR IS TO VERIFY THE WEIGHT LIMITS OF THE EXISTING ROOFING WITH A STRUCTURAL ENGINEER. ENGINEER, REPORTS WILL BE REQUIRED PRIOR TO INSTALLING ANY SCAFFOLD ON ANY ROOFS. THE VA WILL SUPPLY STRUCTURAL DRAWINGS TO THE CONTRACTOR. THE CONTRACTOR IS TO FOLLOW ALL FEDERAL, STATE, LOCAL AND VA GUIDELINES AND STANDARDS.
- ALL OSHA REGULATION ARE TO BE FOLLOWED BY ALL CONTRACTING PERSONNEL. PRIME CONTRACTOR (ON SITE PERSONNEL) TO HAVE 30 HOUR OSHA SAFETY TRAINING AND A 10 HOUR OSHA SAFETY CERTIFICATE. REFER TO OTHER CONTRACT DOCUMENTS FOR DEMOLITION REQUIREMENTS
- 3. CONTRACTOR SHALL VERIFY ALL DIMENSIONS AND EXISTING CONDITIONS AT THE JOB SITE AND SHALL REPORT, ANY DISCREPANCIES TO THE GOVERNMENT PRIOR TO STARTING CONSTRUCTION. BEFORE COMMENCEMENT OF WORK, THE CONTRACTOR SHALL IMPLY HIS ACCEPTANCE OF ALL EXISTING CONDITIONS. DIMENSION SHOWN ON PLANS ARE TO THE FINISH TO FINISH UNLESS NOTED OTHER WISE.
- THE DEMOLITION PLANS ARE DERIVED FROM EXISTING BUILDING PLANS AND ARE INTENDED TO REASONABLY REPRESENT EXISTING AND CURRENT CONDITIONS. ALL DIMENSIONS AND INFORMATION IN THESE DRAWINGS ARE BASED, IN PART, ON THAT FACT. ACTUAL CONDITIONS MAY VARY FROM THAT SHOWN. NOTIFY THE ARCHITECT IMMEDIATELY FOR REVIEW SHOULD ANY DISCREPANCIES WHICH SIGNIFICANTLY AFFECT THE DEMOLITION OR NEW CONSTRUCTION WORK OCCUR.
- 10. PROTECT EXISTING CONSTRUCTION, SURFACES AND MATERIALS INDICATED TO REMAIN FROM DAMAGE OR DETERIORATION DUE TO PERFORMANCE OF WORK. PATCH AND REPAIR EXISTING MATERIALS AND SURFACES DAMAGED BY PERFORMANCE OF THE WORK.
 11. IF MATERIALS ARE ENCOUNTERED THAT MAYBE HAZARDOUS OR MAY CONTAIN
- HAZARDOUS COMPONENTS, CEASE WORK IMMEDIATELY, PREVENT FURTHER DISTURBANCE, SECURE THE AREA AND NOTIFY THE COR.

 12. DO NOT CUT STRUCTURAL COMPONENTS UNLESS INDICATED OTHERWISE.

 13. COORDINATE REMOVAL OF DEMOLISHED MATERIALS WITH COR. PREVENT
- 13. COORDINATE REMOVAL OF DEMOLISHED MATERIALS WITH COR. PREVENT DUST AND DEBRIS FROM INFILTRATING OCCUPIED AREAS. PROVIDE ENCLOSED CHUTES AND NEGATIVE AIR PRESSURE AS REQUIRED. DISPOSE OF DEMOLISHED MATERIALS IN LAWFUL MANNER, OFF SITE.
- 14. COORDINATE SCHEDULE WITH COR PRIOR TO COMMENCING DEMOLITION WORK THAT MAY INTERRUPT SERVICES. SCHEDULE WORK AND PROVIDE TEMPORARY CONNECTIONS OR NEW SERVICES AS NECESSARY TO ELIMINATE DISRUPTIONS AFFECTING THE OWNER'S OPERATIONS.

KEYNOTES

#	NOTE
12	DEMOLISH EXISTING BALLAST MEMBRANE ROOFING AND INSULATION TO CONCRETE DEC PREPARE SUBSTRATE TO RECEIVE NEW FINISH
13	DEMOLISH EXISTING SHEET METAL WALL COPING; PREPARE SUBSTRATE TO RECEIVE NEFINISH
14	DEMOLISH EXISTING WALL FLASHING; PREPARE SUBSTRATE TO RECEIVE NEW FINISH
15	SALVAGE LIGHTNING PROTECTION SYSTEM. REINSTALL AND RECONNECT FOLLWING INSTALLATION OF NEW ROOFING
16	DEMOLISH EXISTING FLASHING AT ROOF PENETRATIONS; PREPARE SUBSTRATE TO RECEIVE NEW ROOFING
LE ⁽	GEND
LE ⁽	GEND EXISTING CONSTRUCTION TO BE DEMOLISHED
LE ⁽	

EXISTING DOOR TO REMAIN

